

The Environment House, 473 Steve Biko Road, Cnr Soutpansberg and Steve Biko Road, Pretoria

BID NO: DFFE-T017 (23/24)

<u>BID DESCRIPTION:</u> THE APPOINTMENT OF CONSTRUCTION INDUSTRY DEVELOPMENT BOARD (CIDB) GRADED CONSTRACTOR FOR THE IMPLEMENTATION OF THE INFRASTRUCTURE PROJECT: MP - SWILE MAVOKWENI GAME FARM AND WILDLIFE PROJECTS.

Contractors should be informed that the briefing date and closing date the of the above-mentioned bid number DFFE-T017 (23-24) has been extended.

The new dates are as follows.

- 1) The briefing date of the 15th of August 2023 has been changed to 18th of August 2023.
- 2) The initial closing date of the 30th of August 2023 has been changed to the 07th of September 2023

The Department will not accept any late bids.

Sincerely,



INVITATION TO BID BID NUMBER: DFFE-T017 (23/24)

THE APPOINTMENT OF CONSTRUCTION INDUSTRY DEVELOPMENT BOARD (CIDB) GRADED CONSTRACTOR FOR THE IMPLEMENTATION OF THE INFRASTRUCTURE PROJECT: MP - SWILE MAVOKWENI GAME FARM AND WILDLIFE PROJECTS

ENQUIRIES:

Name : SCM Officials Office Telephone No. : 012 399 9892

E-Mail : Tenders@dffe.gov.za

NATIONAL TREASURY CENTRAL SUPPLIER DATABASE (CSD) REGISTRATION INFORMATION

Company name	Supplier registration number	Unique reference number	
			Main contractor
			Sub-contracted/ joint venture comp 1
			Sub-contracted/ joint venture comp 2

The compulsory Pre-tender site inspection meeting will be held as follows:

Site 1 Venue: MP Bushbuckridge Swile Mavokweni Project Site

(-24.786734541988878, 31.26708984375

Date: 18 August 2023

Starting time: 11h00am

CLOSING DATE OF THE BID: 07 SEPTEMBER 2023 @11:00 AM

NB: Bidders should note that enquiries will only be allowed at

least 10 days before the tender closed.

PART A INVITATION TO BID

YOU ARE HEREBY INVITED TO BID FOR REQUIREMENTS OF THE (NAME OF DEPARTMENT/ PUBLIC ENTITY)									
BID NUMBER:	DFFE-T0			CLOSING DATE:		07 September 2023			
DESCRIPTION THE APPOINTMENT OF CONSTRUCTION INDUSTRY DEVELOPMENT BOARD (CIDB) GRADED CONSTRACTOR FOR THE IMPLEMENTATION OF THE INFRASTRUCTURE PROJECT: MP - SWILE MAVOKWENI GAME FARM AND WILDLIFE PROJECTS									
BID RESPONSE DOCUMENTS MAY BE DEPOSITED IN THE BID BOX SITUATED AT (STREET ADDRESS)									
Department of Fo	orestry Fi	sheries an	d The E	Environment.		,	,		
473 Steve Biko R	Road; Cnr	Soutpansl	oerg an	d Steve Biko Road, Ar	cadia	Pretoria /Tshwane			
BIDDING PROCE	DURE EN	QUIRIES I	MAY BE	DIRECTED TO	TEC	HNICAL ENQUIRIE	S MAY BE DIREC	TED TO:	
CONTACT PERS	ON	Enquiries	: Tende	rs@dffe.gov.za	CON	ITACT PERSON	SCM Practiti	oners	
TELEPHONE NU	MBER	012 399 9	9892		TEL	EPHONE NUMBER	012 399 9892		
FACSIMILE NUM	BER	N/A			FAC	SIMILE NUMBER			
E-MAIL ADDRES		Tenders@	odffe.ac	DV.78		AIL ADDRESS	Tenders@dffe.d	10V.78	
SUPPLIER INFO			J						
NAME OF BIDDE	:R								
POSTAL ADDRES	SS								
STREET ADDRES	SS								
TELEPHONE NU	MBER	CODE			1	NUMBER			
CELLPHONE NU	MBER								
FACSIMILE NUM	BER	CODE			1	NUMBER			
E-MAIL ADDRESS VAT REGIST NUMBER	S RATION								
SUPPLIER COMF	PLIANCE	TAX				CENTRAL			
STATUS		COMPLIA SYSTEM			OR	SUPPLIER DATABASE No:	MAAA		
B-BBEE STATUS	LEVEL			PLICABLE BOX	B-BE	BEE STATUS		K APPLICAB	LE BOX]
VERIFICATION				•	LEV	EL SWORN	•		•
CERTIFICATE			V		AFF	IDAVIT		V.	□ N.
(4 D DDEE 07)	A T. (O) . E		Yes	□ No	14/05	ON AFFIDANT /F		Yes	□ No
				TION CERTIFICATE/ SEE POINTS FOR B-BB		RN AFFIDAVII (FC	OR ENIES & QSI	ES) MUST E	E SUBMITTED IN
ARE YOU THE A									
REPRESENTATIV			□Ye	s 🔲 No		: You a foreign e Plier for the g o		□Yes	□No
AFRICA FOR THE				/SERVICES /WORKS OFFERED?					
/SERVICES /WORKS OFFERED?		[IF YE	ES ENCLOSE PROOF]			[IF YES, AN	NSWER PART B:3]		
QUESTIONNAIRE TO BIDDING FOREIGN SUPPLIERS									
IS THE ENTITY A RESIDENT OF THE REPUBLIC OF SOUTH AFRICA (RSA)? ☐ YES ☐ NO									
DOES THE ENTITY HAVE A BRANCH IN THE RSA?			ES NO						
DOES THE ENTITY HAVE A PERMANENT ESTABLISHMENT IN THE RSA?		?			ES NO				
DOES THE ENTI	TY HAVE	ANY SOUR	CE OF	INCOME IN THE RSA?				□ Y	ES NO
IF THE ANSWER	IS THE ENTITY LIABLE IN THE RSA FOR ANY FORM OF TAXATION? IF THE ANSWER IS "NO" TO ALL OF THE ABOVE, THEN IT IS NOT A REQUIREMENT TO REGISTER FOR A TAX COMPLIANCE STATUS SYSTEM PIN CODE FROM THE SOLITH AFRICAN REVENUE SERVICE (SARS) AND IS NOT REGISTER AS DEP 2.3 RELIGIOUS.								

PART B TERMS AND CONDITIONS FOR BIDDING

1. BID SUBMISSION:

- 1.1. BIDS MUST BE DELIVERED BY THE STIPULATED TIME TO THE CORRECT ADDRESS. LATE BIDS WILL NOT BE ACCEPTED FOR CONSIDERATION.
- 1.2. ALL BIDS MUST BE SUBMITTED ON THE OFFICIAL FORMS PROVIDED—(NOT TO BE RE-TYPED) OR IN THE MANNER PRESCRIBED IN THE BID DOCUMENT.
- 1.3. THIS BID IS SUBJECT TO THE PREFERENTIAL PROCUREMENT POLICY FRAMEWORK ACT, 2000 AND THE PREFERENTIAL PROCUREMENT REGULATIONS, 2017, THE GENERAL CONDITIONS OF CONTRACT (GCC) AND, IF APPLICABLE, ANY OTHER SPECIAL CONDITIONS OF CONTRACT.
- 1.4. THE SUCCESSFUL BIDDER WILL BE REQUIRED TO FILL IN AND SIGN A WRITTEN CONTRACT FORM (SBD7).

2. TAX COMPLIANCE REQUIREMENTS

- 2.1 BIDDERS MUST ENSURE COMPLIANCE WITH THEIR TAX OBLIGATIONS.
- 2.2 BIDDERS ARE REQUIRED TO SUBMIT THEIR UNIQUE PERSONAL IDENTIFICATION NUMBER (PIN) ISSUED BY SARS TO ENABLE THE ORGAN OF STATE TO VERIFY THE TAXPAYER'S PROFILE AND TAX STATUS.
- 2.3 APPLICATION FOR TAX COMPLIANCE STATUS (TCS) PIN MAY BE MADE VIA E-FILING THROUGH THE SARS WEBSITE WWW.SARS.GOV.ZA.
- 2.4 BIDDERS MAY ALSO SUBMIT A PRINTED TCS CERTIFICATE TOGETHER WITH THE BID.
- 2.5 IN BIDS WHERE CONSORTIA / JOINT VENTURES / SUB-CONTRACTORS ARE INVOLVED, EACH PARTY MUST SUBMIT A SEPARATE TCS CERTIFICATE / PIN / CSD NUMBER.
- 2.6 WHERE NO TCS IS AVAILABLE BUT THE BIDDER IS REGISTERED ON THE CENTRAL SUPPLIER DATABASE (CSD), A CSD NUMBER MUST BE PROVIDED.
- 2.7 NO BIDS WILL BE CONSIDERED FROM PERSONS IN THE SERVICE OF THE STATE, COMPANIES WITH DIRECTORS WHO ARE PERSONS IN THE SERVICE OF THE STATE, OR CLOSE CORPORATIONS WITH MEMBERS PERSONS IN THE SERVICE OF THE STATE."

NB: FAILURE TO PROVIDE / OR COMPLY WITH ANY OF THE ABOVE PA	ARTICULARS MAY RENDER THE BID INVALID.
SIGNATURE OF BIDDER:	
CAPACITY UNDER WHICH THIS BID IS SIGNED: (Proof of authority must be submitted e.g. company resolution)	
DATE:	



PROJECT NAME: MP SWILE MAVOKWENI GAME FARM AND WILDLIFE PROJECT

DEPARTMENT OF FORESTRY, FISHERIES AND THE ENVIRONMENT

VOLUME 1 – TENDERING PROCEDURESVOLUME 2 – RETURNABLE DOCUMENTS
VOLUME 3 – THE CONTRACT

ISSUED BY:

TENDER DOCUMENT

August 2023

PREPARED BY:

DEPARTMENT OF FORESTRY FISHERIES AND THE ENVIRONMENT
PRIVATE BAG X447
ENVIRONMENTAL HOUSE
PRETORIA
0001

PATSON AND PARTNERS
P.O.BOX 2283
NELSPRUIT
MPUMALANGA PROVINCE
1200

NAME OF THE TENDERER:

TABLE OF CONTENTS

VOLUME 1 TENDERING PROCEDURES

- T1.1 Notice and Invitation to Tender SBD 1 Invitation to Tender
- T1.2 Tender Data
- T1.2.1 Standard Conditions of Tender

VOLUME 2 RETURNABLE DOCUMENTS

- T2.1. List of Returnable Documents
- C1.1 Form of Offer and Acceptance
- T2.2 Returnable Documents required for tender evaluation purposes.
 - 1. SBD 4 Bidder's Disclosure
 - 2. Resolution of Board of Directors
 - 3. Resolution of Board of Directors to enter into Consortia or Joint Ventures
 - 4. Special Resolution of Consortia or Joint Ventures
 - 5. Pre-Qualification Criteria
 - 6. Functionality Evaluation Criteria
 - 7. Pre-tender Site Inspection Meeting Certificate
 - 8. Schedule of Tenderer's Current and Completed Projects
 - 9. SBD 6.1 Preference Points Claim Form in Terms of the Preferential Procurement Regulations 2022
 - 10. Affidavit

T2.2.1 Returnable Documents that will be incorporated into the contract.

- 11. Record of Addenda to tender documents
- 12. Credentials of electrical Contractor
- 13. Credentials of plumbing Contractor
- 14. Schedule for Imported Materials and Equipment

T2.2.2 Recommended returnable Documents: Other documents that will be incorporated into the Contract (special condition)

- 15. SBD 6.2 Declaration Certificate for Local Production and Content for Designated Sectors (Annexure C, D, E: Local & Imported Content Declarations).
- T2.2.3 Additional Information that might be required for tender evaluation `purpose.

VOLUME 3 THE CONTRACT PART A

- Part C1 Agreement and Contract
 - C1.2 Contract Data
 - C1.3 Form of Construction Guarantee
 - C1.4 Health and Safety Agreement
- Part C2. Pricing Data
 - C2.1 Bills of Quantities
 - C2.2 Final Summary
- Part C3. SPECIFICATIONS PART B
 - C3.1 Occupational Health & Safety Specification (Appendix A)
 - C3.2 EPWP Corporate Branding Guidelines (Appendix B)

Part	C4.	Site Information (Appendix C)
	C4.1	Other Technical Specifications that are required.
	C4.2	Site Layout
	C4.3	Electrical Layouts
	C4.4	Electrical Specifications
	C4.5	Labour sheet sample documents
	C4.6	Tender Drawings / Designs

VOLUME 1: TENDERING PROCEDURES

T1.1 NOTICE AND INVITATION OF TENDER

Project Name:	MP SWILE MAVOKWENI GAME FARM AND WILDLIFE PROJECT
Reference no.:	EPIP-A170102698

Advertisement Date:	04 August 2023	Validity:	120 days
Closing Date:	07 September 2023	Closing time:	11:h00am

The Department of Forestry, Fisheries, and the Environment (DFFE), invites CIDB registered Contractors.

It is estimated that tenderers should have a CIDB contractor grading designation 5 GB or higher.

"Delete or select tender value range select class of construction works" where only one class of construction works is applicable".

Works Description: The project comprises the following main deliverables:

- a) Construction of a New Accommodation facility,
- b) Construction of a New Administration facility,
- c) Construction of a New Guard house,
- d) Construction of New Water/Electrical Services and External works
- e) Construction of new boundary fence

The description of the Works is not necessarily complete and shall not limit the work to be carried out by the Contractor under this Contract.

Only bidders who are responsive to the following responsiveness criteria are eligible to submit tenders. Failure to comply with the criteria stated hereunder, may result in the tender offer being disqualified from further consideration:

\boxtimes	Only those tenderers who satisfy the eligibility criteria stated in the Tender Data may submit tenders, and of
	proof of registration with Construction Industry Development Board is required.
\boxtimes	Proof of valid registration with CIDB.
\boxtimes	Invitation to bid (SBD 1).
\boxtimes	Tender offer must be properly received on the tender closing date and time specified on the invitation, fully
	completed, and signed in black ink. Use of correction fluid is prohibited; only black ink can be used in the
	document (All as per Standard Conditions of Tender).
\boxtimes	Submission of the Form of Offer and Acceptance.
×	Submission of the Bidder's Disclosure (SBD 4).
\boxtimes	Submission of applicable Resolution by the legal entity, or consortium / joint venture, authorizing a dedicated
	person(s) to sign documents on behalf of the firm / consortium / joint venture.
\boxtimes	The tenderer will be required to submit a fully priced Bills of Quantities / Lump Sum Document (complete
	document inclusive of all parts) together with the tender document.
\boxtimes	Submission of Site Inspection Meeting Certificate as proof of attendance of compulsory site inspection
	meeting (To provide the contractors with a clear understanding of the scope of works).
\boxtimes	Registration on National Treasury's Central Supplier Database (CSD) and Tax Pin from SARS.
\boxtimes	B-BBEE level of contribution certificate or affidavit if B-BBEE points are claimed for Construction Sector.
\boxtimes	B-BBEE level of contribution certificate or affidavit for intended subcontractors.
\boxtimes	A consolidated B-BBEE level of contribution certificate in the case of Joint Ventures.
\boxtimes	For service providers to claim for preference points the following must be adhered to:
	A. Submit a complete and signed SBD 6.1,
	B. Bidders are requested to submit a valid B-BBEE Status Level Verification Certificate issued by SANAS
	Accredited Verification Agency; or B-BBEE Certificate issued by CIPC, or Sworn Affidavit
	commissioned by Commissioner of Oaths or A Consolidated Joint Venture B-BBEE Certificate clearly
	outlining the % ownership by black people, women and people with disabilities.
	C. Verification Certificate means a B-BBEE Certificate issued in compliance with the B-BBEE Codes of
	Good Practice or Sector Codes issued in terms of Section 9 1 of the Broad Based Black Economic
	Empowerment Act 53 of 2003 as amended by Act 46 of 2013.
	D. Unincorporated Joint Ventures are required to submit a consolidated verification certificate
\boxtimes	Submission of the schedule of Tender's Past and Current Projects
\boxtimes	Corrections made in the document should be initialed by the authorized person (as stated in the Standard

	Condition of Tender attached in this tender document).	
\boxtimes	Certified copies of the Founding Statement – CK1	
\boxtimes	Valid COIDA or FMA certificate issued by the Department of Labour	
\boxtimes	Completion of Form Q for completed projects	
\boxtimes	CV's and copies of qualifications and Registrations for Project Staff as per Form R	
\boxtimes	Bank Letter confirming financial capacity	
\boxtimes	Completed and signed Consent Form	

NB: DFFE RESERVES THE RIGHT TO PERFORM DUE DILIGENCE AND VERIFICATION ON ALL SUBMITTED DOCUMENTS AND INFORMATION BY BIDDERS

Bidder must comply with the Mandatory Requirements criteria for the Preferential Procurement listed below:

MANDATORY REQUIREMENTS

Does mandatory requirement apply for this bid?

YES

The following mandatory requirement will apply and all bids that do not meet mandatory requirement will be disqualified, and not be evaluated further.

The compulsory Pre-tender Site Inspection Meeting will be held as follows:

Site 1 - Venue: MP Bushbuckridge Swile Mavokweni Project Site

(-24.786734541988878, 31.26708984375

Date: 18 August 2023 Starting time: 11:H00am

ITEM NO.	MANDATORY REQUIREMENTS
1.	Main contractor must have a CIDB contractor grading designation of 5GB or higher. Attach proof
2.	Attendance of a Compulsory Pre-tender Site Inspection Meeting

It is recommended for the Bidder to consider the Local Content as a Special Condition for Procurement Preferential below:

SPECIAL CONDITION

ITEM NO.	SPECIAL CONDITION
1.	Compliance to Local Production and Content requirements as per SBD 6.2 and Annexure C, D & E

Functional Evaluation Criterion Summary

The maximum points allocation per criterion is summarised in the following table:

Minimum functionality score to qualify for further evaluation:	70 Points	
--	-----------	--

Functionality criteria:	Weighting factor:
RELEVANT WORK EXPERIENCE ON PREVIOUS COMPLETED PROJECTS OF A SIMILAR	20
NATURE, SCOPE /OR COMPLEXITY AND VALUE	30
REFERENCES FROM CLIENTS/CONSULTANTS FOR COMPLETED PROJECTS OF SIMILAR IN	00
NATURE, SCOPE, AND VALUE	20
FINANCIAL CAPACITY	10
COMPETENCY OF THE SITE AGENT	20
COMPETENCY OF THE GENERAL FOREMAN	10
COMPETENCY OF THE HEALTH SAFETY OFFICER	10
TOTAL FUNCTIONALITY SCORE	100 Points

Bidders are requested to provide evidence of complying with these Functional Criteria by completing the relevant forms in the bid document (Forms) as well supplying completion certificates for completed projects as proof. Failure to supply completion certificates as required will mean that the project will not be contributing towards experience of the company and bidders will lose points on this criterion, under completed projects.

FUNCTIONALITY EVALUATION MATRIX

Bidder's **Company Experience**, **Current Resources and Current Expertise** will be evaluated as per the matrix below.

The following values / indicators will be applicable when evaluating functionality:

Proje	ct Name: MP - SWILE MAVOKWEN	I GAME FARM AND W	ILDLIFE	
No	Criteria	Evaluation Indicator	s	Applicable Value
1	RELEVANT CONSTRUCTION WO			30
	Provide a descriptive list of all completed projects of similar nature, scope and value to this		ruction project at R1 500 000 o	
	tender for the past 10 years. Attach Final Completion Certificate indicating: Name of	•	truction projects at R1 500 00 of this project with duly signe	
	Client, Contact number, Contractual commencement date and completion date.	each or higher value completion certificate		d (3)
	In addition, please ensure that the completed project listed, will also		truction projects at R1 500 00 of this project with duly signe	
	be included in the "Schedule of Tenderer's Current and Completed projects" form, that is attached as a returning document in this bid.	000 each or higher va completion certificate		d
	Portfolio of projects: Please provide services rendered for the projects I	•	port, i.e., project description; pro	ject value and
	Name of project	Client	Short Description of project	Value of Project
1	/			
2				
3				
4				
5				
6				
7				
9				
<u> </u>				

10						
No	Criteria	Evaluation Indicators				licable alue
2.		REFERENCE LETTERS FROM THE BIDDER'S CLIENTS FOR THE COMPLETED PROJECTS OF SIMILAR IN NATURE, SCOPE, AND VALUE			20	
	Please provide signed reference	1 x Positive reference	letter fr	om the client for the	ne	(1)
	letters from clients confirming your	completed construction	projects			
	company's involvement in the	2 x Positive reference			ne	(2)
	projects listed in item 1 above,	completed construction	<u> </u>			
	and additional projects of similar	3 x Positive reference			ne	(3)
	nature. Attach positive reference	completed construction				/ A
	letters indicating: Name of client, contact number, Contract sum,	4 x Positive reference		/	ne	(4)
	Contract number, Contract sum,	completed construction			:	(E)
	and completion date and the role	5 or more positive refer the completed construction			or	(5)
	played by the bidder in the project.	the completed constitut	ction proje	5 015.		
	project by the states in the project.					
	NB: Positive reference letter(s)					
	indicated corresponding with					
	the Final Completion					
	Certificate(s) provided above					
	will be utilized to verify and					
	evaluate the value in criteria 1					
				Value of Project a		attached
	Name of Company			measured for fina	I YES	NO
				account		
1						
2						
3						
4						
5						
6						
7						

No	Criteria	Evaluation Indicators		Applicable
140				Value
3.	FINANCIAL CAPACITY			10
	Provide valid Bank rating letter on	Credit rating/code of E		(1)
	the bank's letterhead from the	Credit rating/code of D		(2)
	bidder's Banking Institution	Credit rating/code of C		(3)
	stating A, B, C, D and E bank code	Credit rating/code of B		(4)
	/rating, not older than 6 months from closing of the bid.	Credit Rating/code of A		(5)
No	Name of Bank	Contact Person	Contact Number	Date of letter
1				
2				
3				
4				
5		/		
6		/		
No	Criteria	Evaluation Indicators		Applicable
	COMPETENCE OF SITE AGENT	/		Value 20
4.	Competence of Site Agent CV and	Built Environment Qualification	coupled with 4 years	20
	copies of relevant Built	relevant construction experien	. – ,	(1)
	Environment qualifications	relevant qualification(s)	ce, Cv included with	(1)
	coupled with relevant construction	Built Environment Qualification	counled with 5 years	
	experience to be submitted where	relevant construction experien		(2)
	the average number of years'	relevant qualification(s)	oo, ov moidada with	(-)
	experience will be considered	Built Environment Qualification	coupled with 6 years	
	when awarding the points.	relevant construction experien	. – ,	(3)
	and an angular parties	relevant qualification(s)	oo, or moladod mar	(0)
		Built Environment Qualification	coupled with 7 years	
		relevant construction experien	. – .	(4)
		relevant qualification(s)		
		Built Environment Qualification coupled with 8 years or		
		more relevant construction exp	· —•	(5)
		with relevant qualification(s)		, ,
	1			1

No	Criteria	Evaluation Indicators	Evaluation Indicators		uation cators
5.	COMPETENCE OF THE GENERA	L FOREMAN			10
	Competence of the General	4 years relevant construction ex	perience, CV included		
	Foreman, CV and copies of	with relevant qualification(s)	with relevant qualification(s)		(1)
	relevant construction	5 years relevant construction ex	perience, CV included		
	qualifications coupled with	with relevant qualification(s)		(2)	
	relevant construction experience	6 years relevant construction ex	perience, CV included		(0)
	to be submitted where the average number of years'	with relevant qualification(s)	norionae CV included		(3)
	experience of the key personnel	<u>7</u> years relevant construction ex with relevant qualification(s)	perience, CV included		(4)
	will be considered when awarding	8 years or more relevant constr	uction experience CV		וייו
	the points.	included with relevant qualificati			(5)
		·			s and
	Name of the Key Berson	Name of the Qualification(s)	Portfolio/Position	Qualif	ications
No	Name of the Key Person	Name of the Qualification(s)	Portfolio/Position	atta	ched
				YES	NO
1		/			
2					
No	Criteria	Evaluation Indicators			licable
6.	COMPETENCE OF THE OCCUPA	TIONAL HEALTH AND SAFETY	(OHS) OFFICED		alue 10
0.	Competence of OHS Officer. CV		` ,		10
	and copies of relevant	construction industry, CV inc			(1)
	Occupational Health and Safety	qualification(s)		·	. ,
	qualification(s)	<u>5</u> years relevant OHS ex	perience within the		
	(SAMTRAC/NOSA/ Formal	construction industry, CV inc	cluded with relevant		(2)
	Tertiary Qualification) coupled	qualification(s)			
	with relevant OHS experience	6 years relevant OHS ex	perience within the		
	within the construction industry	construction industry, CV in	cluded with relevant		(3)
	where the average number of	qualification(s)	912 0		
	years' experience will be considered when awarding the	7 years relevant OHS ex			(A)
	points.	construction industry, CV inc qualification(s)	ciuaea with relevant		(4)
	pointo.	8 years or more, relevant OHS	experience within the		
		construction industry, CV inc			
		qualification(s)		·	• •

No	Name of the Key Person	Name of the Qualification(s)	Portfolio/Position	Qualifi	and cations ched NO
1					
2					
3					
4					
5			/		
TOTAL FUNCTIONALITY SCORE			10	00	
MINIMUM QUALIFYING SCORE FOR FUNCTIONALITY			7	0	

(Weighting will be multiplied by the scores allocated during the evaluation process to arrive at the total functionality points)

Preference Point and Price Calculation

The following preference point system will be followed to advance the categories of persons:

- a) For contracts with a Rand value up to R50 000 000, a maximum of 20 points may be allocated for specific goals as contemplated above, provided that the lowest acceptable tender scores 80 points for price.
 - i. The applicable formula to be used is Ps=80[1-(Pt-Pmin)/Pmin]. Provided:
 - Ps = Points scored for price of tender under consideration;
 - Pt = Price of tender under consideration: and
 - Pmin = Price of the lowest applicable tender.
 - ii. A total of 20 points may be awarded to a tenderer as follows:
 - 20 points: if the Bidder has more than 50% (fifty percent) by Black people, Women, or people with disabilities
 - 0 Points: for 50% and below ownership by stipulated categories of persons
- b) A contract may be awarded to a tenderer that did not score the highest points only in accordance with section 2(1)(f) of the PPPFA.
- c) Bid will be awarded to a bidder with the highest points on price and Preference Points on condition that they have met all phases of the evaluation criteria and complied with the tender requirements set out in the tender document.
- d) The DFFE reserves the right to negotiate prices that are not deemed market related and not to award the tender to the bidder with the lowest price.
- e) Preference point system applicable for this bid is: 80/20

f) A total of **20** points will be allocated for either of the specific goals.

SPECIFIC GOALS	80/20
>50% ownership by Black people, Or	20
>50% ownership by Women, Or	20
>50% ownership by people with Disability	20

For bidders to claim preference points, the following must be adhered to:

- F.1) Submit a complete and signed SBD 6.1,
- F.2) Bidders are requested to submit a valid B-BBEE Status Level Verification Certificate issued by SANAS, or Accredited Verification Agency; or B-BBEE Certificate issued by CIPC, or Sworn Affidavit commissioned by Commissioner of Oaths together with their bids. <u>Issued in terms of the amended</u>

 Construction Sector Code
- F.3) If the application is made by a Joint Venture or Partnership, the accreditation credentials in name of joined entities should be submitted. Members in the joint venture must meet the requirement of the proposal. **Issued in terms of the amended Construction Sector Code**
- F.4) Submit a CSD report.

Collection of tender documents

☑ Bid documents are available for free download on e-Tender portal www.etenders.gov.za and cidb i-tender.

Deposit / return of tender documents

Telegraphic, telephonic, telex, facsimile, electronic and / or late tenders will not be accepted.

Requirements for sealing, addressing, delivery, opening and assessment of tenders are stated in the Tender Data.

All tenders must be completed in black ink and submitted on the official forms (forms not to be re-typed).

Tender documents may be posted to:		Deposited in the tender box at:
The Director-General		
Department of Forestry, Fisheries, and the Environment		Environmental House
Private Bag X 447		Ground Floor of the Department of Forestry,
Pretoria		Fisheries and Environment
0001		473 Steve Biko Road
	OR	Arcadia,
Attention:		Pretoria
Procurement section: Tel: 012-399 9073		0083
POSTED TENDERS MUST BE RECEIVED PRIOR		
CLOSING DATE: 07 September 2023 AND TIME:		Ground floor (At the Reception)
11:00AM		/
BY THE DEPARTMENT		

T1.2 TENDER DATA

Clause number	Tender Data
	The conditions of tender are the Standard Conditions of Tender (as published / amended by CIDB contained
	in Annex C of the CIDB Standard for Uniformity in Engineering and Construction Works Contracts (August
	2019) as published in Government Gazette No 42622, Board Notice 423 of 2019 of 08 August 2019. (See www.cidb.org.za).
	The standard conditions of tender for procurements make several references to the tender data for details that
	apply specifically to this tender. The tender data shall have precedence in the interpretation of any ambiguity
	or inconsistency between it and the standard conditions of tender.
	Each item of tender data given below is cross-referenced to the clause in the standard conditions of tender to
	which it mainly applies.
C.1.1	The employer is the Department of Forestry , Fisheries , and the Environment
C.1.2	For this contract, the three-volume approach is adopted:
	This procurement document has been formatted and compiled under the headings as contained in the
	CIDB's "Standard for Uniformity in Construction Procurement."
	Volume 1: Tendering procedures
	T1.1 - Notice and invitation to tender
	T1.2 - Tender data
	Volume 2: Returnable documents

	TO 1. List of volume able decomposite
	T2.1 - List of returnable documents
	C1.1 - Form of offer and acceptance
	T2.2 - Returnable schedules
	Volume 3: Contract
	Part C1 - Agreements and Contract data
	C1.1 – Form of offer and acceptance
	C1.2 – Contract data
	C1.3 – Construction form of guarantee
	Part C2 - Pricing Data
	C2.1 – Pricing Assumptions
	C2.2 – Bills of Quantities / Lump sum document
	Part C3 - Scope of Works
	C3.1 – Description of the works
	C3.2 – Construction
	Part C4 - Site Information
C.1.4	The Employer's agent for the purpose of this tender is deemed to be the authorised and designated
	representative of the Employer:
	Name: (SCM Representative)
	Address: DFFE Head Office Reception
	473 Steve Biko Road, Arcadia, 0083.
	E-mail: : Tenders@dffe.gov.za
C.1.5	Cancellation and Re-Invitation of Tenders
C.1.5.1	An employer may, prior to the award of the tender, cancel a tender if-
	a) due to changed circumstances, there is no longer a need for the engineering and construction works
	specified in the invitation.
	b) funds are no longer available to cover the total envisaged expenditure; or
	c) no acceptable tenders are received.
	d) there is a material irregularity in the tender process.
C.1.5.2	The decision to cancel a tender invitation must be published in the same manner in which the original tender
	invitation was advertised
C.1.5.3	An employer may only with the prior approval of the relevant treasury cancel a tender invitation for the second
	time.
C.1.6	Procurement procedures
C.1.6.1	Unless otherwise stated in the tender data, a contract will, subject to C.3 be concluded with the tenderer who
	in terms of C.3 is the highest ranked or the tenderer scoring the highest number of tender evaluation points, as
	relevant, based on the tender submissions that are received at the closing time for tenders.

C.1.6.2	Competitive negotiation procedure
C.1.6.2.1	Where the tender data require that the competitive negotiation procedure is to be followed, tenderers shall submit tender offers in response to the proposed contract in the first round of submissions. Notwithstanding the requirements of C.3 the employer shall announce only the names of the tenderers who make a submission. The requirements of C.8 relating to the material deviations or qualifications which affect the competitive position of tenderers shall not apply.
C.1.6.2.2	All responsive tenderers or at least a minimum of not less than three responsive tenderers that are highest ranked in terms of the evaluation criteria stated in the tender data shall be invited to enter into competitive negotiations based on the principle of equal treatment, keeping confidential the proposed solutions and associated information. Notwithstanding the provisions of C.2 the employer may request that tenders be clarified, specified and fine-tuned in order to improve a tenderer's competitive position provided that such clarification, specification, fine-tuning or additional information does not alter any fundamental aspects of the offers or impose substantial new requirements which restrict or distort competition or have a discriminatory effect.
C.1.6.2.3	At the conclusion of each round of negotiations, tenderers shall be invited by the employer to revise their tender offer based on the same evaluation criteria, with or without adjusted weightings. Tenderers shall be advised when they are to submit their best and final offer.
C.1.6.2.4	The contract shall be awarded in accordance with the provisions of C.3 after tenderers have been requested to submit their best and final offer.
C.2	Tenderer's obligations
C.2.1	Eligibility Only those tenderers who satisfy the following criteria are eligible to submit tenders: a) CIDB registration Registered with the CIDB, at close of tender, in a contractor grading designation equal to or higher than a contractor grading designation determined in accordance with the sum tendered, or a value determined in accordance with Regulation 25(1B) or 25(7A) of the Construction Industry Development Regulations, as per amended notice no. 357 of 2019, for a 5GB or higher class of construction work. Tenderers whose CIDB registration expires within the tender validity period, need to demonstrate that there is a reasonable chance of being registered in the appropriate grading designation during the tender evaluation period, by submitting a copy of their timely application for CIDB registration, with their tender submission. Tenders received from such tenderers who are not capable of being registered in the required contractor designation, within 10 working days after either expiry of their registration or after being requested to provide proof of registration, will be considered non-responsive. Note that in terms of the Construction Industry Development Board Act, 2000 (Act No. 38 of 2000) a registered contractor must apply for renewal of registration three months before the existing registration expires.

Tenderers registered as potentially emerging enterprises but with a CIDB contractor grading designation lower than a contractor grading designation determined in accordance with the sum tendered, or a value determined in accordance with Regulation 25(1B) or 25(7A) of the Construction Industry Development Regulations, as per amended notice no. 357 of 2019, are not eligible to have their tenders evaluated.

Joint Ventures are eligible to submit tenders provided that:

- a) every member of the joint venture is registered with the CIDB;
- b) the lead partner has a contractor grading designation of not lower than one level below the required grading designation in the class of construction works under consideration and possesses the required recognition status, and
- c) the combined contractor grading designation calculated in accordance with the Construction Industry Development Regulations is equal to or higher than a contractor grading designation determined in accordance with the sum tendered for a 5GB or higher class of construction work or a value determined in accordance with Regulation 25(1B) or 25(7A) of the Construction Industry Development Regulations, as per amended notice no. 357 of 2019.

C.2.1.1 Only those bidders who satisfy the following eligibility criteria are eligible to submit bids:

- (a) Availability of resources
- (b) Availability of skills to manage and perform the contract including staff which satisfies EPWP requirements (see further requirements under C.3)
- (c) Previous experience on contracts of a similar value and nature
- (d) A letter on the companies' letterhead stating that the contractor has sufficient capacity to execute the project

C.2.2 **Eligibility**

b) Risk to Employer

Provisions applicable to Evaluation Method 1 and 2:

Tender offers will be evaluated by an Evaluation Committee based on the technical and commercial risk criteria listed hereunder. Each criterion carries the same weight / importance and will be evaluated individually based on reports presented to the Evaluation Committee by the Project Manager / Professional Team appointed on the project.

For the evaluation reports to be prepared by the Professional Team, the Tenderer is obliged to provide comprehensive information on the form for the (Schedule of current and completed projects). Failure to complete the said form will cause the tender to be declared non-responsive and removed from any further consideration. The Employer reserves the right to request additional information over, and above that which is provided by the Tenderer on said form. The information must be provided by the Tenderer within the stipulated time as determined by the Project Manager, failing which the tender offer will *mutatis mutandis* be declared non-responsive.

Technical risks: a) Criterion 1: Quality of current and previous work Quality of current and previous work performed by the Tenderer in the class of construction work stated above as per the evaluation report prepared by the Professional Team, based on its research and inspection of a representative sample of the Tenderer's current and previous work as well as, if necessary, of any additional work executed by the Tenderer, not reflected on form for the (Schedule of current and completed projects). b) Criterion 2: Contractual commitment Adherence to contractual commitments, demonstrated by the Tenderer in the performance on current and previous work, evaluated in terms of: 1) the level of progress on current projects in relation to the project Programme or, if such is not available/applicable, to the contractual construction period in general. 2) the degree to which previous projects have been completed within the contractual completion periods and/or extensions thereto: and 3) general contract administration, e.g., compliance with contractual aspects such as laws and regulations, insurances, security, written contract instructions, subcontractors, time delay claims, etc. as can generally be expected in standard/normal conditions of contract. c) Criterion 3: Commercial risks The level to which agreement with the Tenderer is reached in respect of the adjustment of rates which are imbalanced or unreasonable and to eliminate errors or discrepancies, without changing the tendered total amount / final offer, over and above the correction of arithmetical errors as provided for in C.2 and C.3 C.2.2.1 The tenderer must be notified of all arithmetic errors, omissions and/or rate imbalances that are identified in the tender offer and request the tenderer to, within a stipulated time, accept the total of the rates / prices as corrected by the Department professional team without changing the tender amount / final offer. C.2.2.2 **Cost of Tender** The cost of the tender documents charged by the employer shall be limited to the actual cost incurred by the employer for printing the documents. The Employer will not compensate the tenderer for any costs incurred in attending the meetings or making any submissions in the office of the Employer. C.2.3 **Check documents** Check the tender documents on receipt for completeness and notify the employer of any discrepancy or omission. C.2.4 Confidentiality and copyright of documents Treat as confidential all matters arising in connection with the tender. Use and copy the documents issued by the employer only for the purpose of preparing and submitting a tender offer in response to the invitation. C.2.6 Acknowledge addenda

	Acknowledge receipt of addenda to the tender documents, which the employer may issue, and if necessary,
	apply for an extension to the closing time stated in the tender data, in order to take the addenda into account.
C.2.7	Seek clarification
	Request clarification of the tender documents, if necessary, by notifying the employer at least five (5) working
	days before the closing time stated in the tender data.
C.2.8	Insurance
	Be aware that the extent of insurance to be provided by the employer (if any) might not be for the full cover
	required in terms of the conditions of contract identified in the contract data. The tenderer is advised to seek
	qualified advice regarding insurance.
C.2.9	Pricing the tender offer
C.2.9.3	This contract shall not be subject to Contract Price Adjustments, foreign fluctuations, etc and all rates and
	prices shall remain fixed, final and binding for the full duration of this contract.
C.2.11	Alterations to documents
	Do not make any alterations or additions to the tender documents, except to comply with instructions issued
	by the employer, or necessary to correct errors made by the tenderer. All signatories to the tender offer shall
	initial all such alterations (refer to the standard condition of Tender).
C.2.12	Alternative tender offers
1	
	No alternative tender offers will be considered
C.2.13	No alternative tender offers will be considered Submitting a tender offer
C.2.13 C.2.13.1	/
	Submitting a tender offer
	Submitting a tender offer Submit one tender offer only as a single tendering entity to provide the whole of the works identified in the
C.2.13.1	Submitting a tender offer Submit one tender offer only as a single tendering entity to provide the whole of the works identified in the contract data and described in the scope of works, unless stated otherwise in the tender data.
C.2.13.1	Submitting a tender offer Submit one tender offer only as a single tendering entity to provide the whole of the works identified in the contract data and described in the scope of works, unless stated otherwise in the tender data. Return all returnable documents to the employer after completing them in their entirety, either electronically (if
C.2.13.1 C.2.13.2	Submitting a tender offer Submit one tender offer only as a single tendering entity to provide the whole of the works identified in the contract data and described in the scope of works, unless stated otherwise in the tender data. Return all returnable documents to the employer after completing them in their entirety, either electronically (if they were issued in electronic format) or by writing legibly in non-erasable ink.
C.2.13.1 C.2.13.2	Submitting a tender offer Submit one tender offer only as a single tendering entity to provide the whole of the works identified in the contract data and described in the scope of works, unless stated otherwise in the tender data. Return all returnable documents to the employer after completing them in their entirety, either electronically (if they were issued in electronic format) or by writing legibly in non-erasable ink. Submit the parts of the tender offer communicated on paper as an original plus the number of copies stated in
C.2.13.1 C.2.13.2	Submitting a tender offer Submit one tender offer only as a single tendering entity to provide the whole of the works identified in the contract data and described in the scope of works, unless stated otherwise in the tender data. Return all returnable documents to the employer after completing them in their entirety, either electronically (if they were issued in electronic format) or by writing legibly in non-erasable ink. Submit the parts of the tender offer communicated on paper as an original plus the number of copies stated in the tender data, with an English translation of any documentation in a language other than English, and the
C.2.13.1 C.2.13.2 C.2.13.3	Submitting a tender offer Submit one tender offer only as a single tendering entity to provide the whole of the works identified in the contract data and described in the scope of works, unless stated otherwise in the tender data. Return all returnable documents to the employer after completing them in their entirety, either electronically (if they were issued in electronic format) or by writing legibly in non-erasable ink. Submit the parts of the tender offer communicated on paper as an original plus the number of copies stated in the tender data, with an English translation of any documentation in a language other than English, and the parts communicated electronically in the same format as they were issued by the employer.
C.2.13.1 C.2.13.2 C.2.13.3	Submitting a tender offer Submit one tender offer only as a single tendering entity to provide the whole of the works identified in the contract data and described in the scope of works, unless stated otherwise in the tender data. Return all returnable documents to the employer after completing them in their entirety, either electronically (if they were issued in electronic format) or by writing legibly in non-erasable ink. Submit the parts of the tender offer communicated on paper as an original plus the number of copies stated in the tender data, with an English translation of any documentation in a language other than English, and the parts communicated electronically in the same format as they were issued by the employer. Sign the original and all copies of the tender offer where required in terms of the tender data. The employer
C.2.13.1 C.2.13.2 C.2.13.3	Submitting a tender offer Submit one tender offer only as a single tendering entity to provide the whole of the works identified in the contract data and described in the scope of works, unless stated otherwise in the tender data. Return all returnable documents to the employer after completing them in their entirety, either electronically (if they were issued in electronic format) or by writing legibly in non-erasable ink. Submit the parts of the tender offer communicated on paper as an original plus the number of copies stated in the tender data, with an English translation of any documentation in a language other than English, and the parts communicated electronically in the same format as they were issued by the employer. Sign the original and all copies of the tender offer where required in terms of the tender data. The employer will hold all authorized signatories liable on behalf of the tenderer. Signatories for tenderers proposing to
C.2.13.1 C.2.13.2 C.2.13.3	Submitting a tender offer Submitting a tender offer only as a single tendering entity to provide the whole of the works identified in the contract data and described in the scope of works, unless stated otherwise in the tender data. Return all returnable documents to the employer after completing them in their entirety, either electronically (if they were issued in electronic format) or by writing legibly in non-erasable ink. Submit the parts of the tender offer communicated on paper as an original plus the number of copies stated in the tender data, with an English translation of any documentation in a language other than English, and the parts communicated electronically in the same format as they were issued by the employer. Sign the original and all copies of the tender offer where required in terms of the tender data. The employer will hold all authorized signatories liable on behalf of the tenderer. Signatories for tenderers proposing to contract as joint ventures shall state which of the signatories is the lead partner whom the employer shall hold
C.2.13.1 C.2.13.2 C.2.13.3	Submitting a tender offer Submit one tender offer only as a single tendering entity to provide the whole of the works identified in the contract data and described in the scope of works, unless stated otherwise in the tender data. Return all returnable documents to the employer after completing them in their entirety, either electronically (if they were issued in electronic format) or by writing legibly in non-erasable ink. Submit the parts of the tender offer communicated on paper as an original plus the number of copies stated in the tender data, with an English translation of any documentation in a language other than English, and the parts communicated electronically in the same format as they were issued by the employer. Sign the original and all copies of the tender offer where required in terms of the tender data. The employer will hold all authorized signatories liable on behalf of the tenderer. Signatories for tenderers proposing to contract as joint ventures shall state which of the signatories is the lead partner whom the employer shall hold liable for the purpose of the tender offer.

C.2.13.6	Bidders are requested to deliver the submission in one envelope. The Employer's address for delivery of tender			
	offers and identification details to be shown on the tender offer package is:			
	Title to appear on envelope one (1):			
	1. CONTRACT NO.:DFFE T017(23-24) (TECHNICAL PROPOSALS)			
	The appointment of a contractor for the construction of the MP - SWILE MAVOKWENI GAME FARM			
	AND WILDLIFE, on behalf of the Department of Forestry, Fisheries, and the Environment.			
	This envelope must contain the returnable SCM Documentations, Relevant Annexures and Appendixes. This			
	envelope must contain printed copies of all the pages in this document, duly completed and signed, inclusive			
	of the pricing schedules (bill of quantities), which must be submitted in one envelope as detailed below.			
	For identification purposes, bidders are requested to ensure that the envelopes containing the company's bids			
	are clearly marked and are easily identifiable by the company's logo or name.			
	Location of tender box: Ground Floor of the Department of Forestry, Fisheries and Environment			
	Physical address: Location of tender box: DFFE Head Office Reception			
	Physical address: 473 Steve Biko Road, Arcadia, 0083			
	Identification details: TENDER BOX			
C.2.13.7	Seal the original tender offer in an outer package that states on the outside only the employer's address and			
	identification details as stated in the tender data.			
C.2.13.8	Accept that the employer will not assume any responsibility for the misplacement or premature opening of the			
	tender offer if the outer package is not sealed and marked as stated.			
C.2.13.9	Accept that tender offers submitted by facsimile or e-mail will be rejected by the employer.			
C.2.14	Information and data to be completed in all respects			
	Accept that tender offers, which do not provide all the data or information requested completely and, in the			
	form, required, may be regarded by the employer as non-responsive.			
C.2.15	Closing time			
	The closing time for submission of tender offers is 11h00am			
	The Department of Forestry, Fisheries and the Environment is not obliged to accept the lowest or any			
	tender and reserves the right to accept any tender in whole or in part.			
C.2.16	The tender offer validity period is 120 days from the closing date.			
C.2.17	Clarification of tender offer after submission			
	Provide clarification of a tender offer in response to a request to do so from the employer during the evaluation			
	of tender offers. This may include providing a breakdown of rates or prices and correction of arithmetical errors			
	by the adjustment of certain rates or item prices (or both). No change in the competitive position of tenderers			
	or substance of the tender offer is sought, offered, or permitted.			
C.2.18.2	The Tenderer shall, when requested by the Employer to do so, submit the names of all management and			
	supervisory staff that will be employed to supervise the labour-intensive portion of the works together with			
	satisfactory evidence that such staff members satisfy the eligibility requirements.			

C.2.19	19 Inspections, tests, and analysis		
	Provide access during working hours to premises for inspections, tests and analysis as provided for in the		
	tender data.		
C.2.20	Submit securities, bonds, and policies		
	If requested, submit for the employer's acceptance before formation of the contract, all securities, bonds,		
	guarantees, policies, and certificates of insurance required in terms of the conditions of contract ide		
	the contract data.		
	Provide access during working hours to premises for inspections, tests and analysis as provided for in the		
	tender data.		
C.2.23	The Tenderer is required to submit his/her tender with all documents and schedules listed under T2.1 and T2.2.		
C.2.24	Canvassing and obtaining of additional information by tenderers		
	The Tenderer shall not make any attempt either directly or indirectly to canvass any of the Employer's officials		
	or the Employer's agent in respect of his tender, after the opening of the tenders but prior to the Employer		
	arriving at a decision thereon.		
	The Tenderer shall not make any attempt to obtain particulars of any relevant information, other than that		
	disclosed at the opening of tenders.		
C.2.25	Prohibitions on awards to persons in service of the state		
	The Employer is prohibited to award a tender to a person -		
	a) who is in the service of the state; or		
	b) if that person is not a natural person, of which any director, manager, principal shareholder or		
	stakeholder is a person in the service of the state; or		
	c) a person who is an advisor or consultant contracted with the Department.		
	In the service of the state means to be -		
	a) a member of:-		
	any municipal council;		
	any provincial legislature; or		
	the National Assembly or the National Council of Provinces;		
	b) a member of the board of directors of any municipal entity;		
	c) an official of any municipality or municipal entity;		
	d) an employee of any national or provincial department;		
	e) provincial public entity or constitutional institution within the meaning of the Public		
	Finance Management Act, 1999 (Act No.1 of 1999);		
	f) a member of the accounting authority of any national or provincial public entity; or		
	g) An employee of Parliament or a provincial legislature.		
	In order to give effect to the above, the questionnaire for the declaration of interests in the tender of persons in		
	service of state in part T2 of this procurement document must be completed.		

C.3	The employer's undertakings		
C.3.1	Respond to requests from the tenderer The Employer will respond to requests for clarification received up to five (5) working days before the tender closing time.		
C.3.2	Issue Addenda Addenda will be issued until five (5) working days before the tender closing time.		
C.3.5	The time and location for opening of the tender offers are: 30 August 2023 at 11h00 am at the Department of Forestry , Fisheries and the Environment : Head Office Reception Physical address: 473 Steve Biko Road, Arcadia, 0083		
C.3.9	Arithmetical errors, omissions, and discrepancies		
C.3.9.1	Check the highest ranked tenders or tenderers with the highest number of tender evaluation points after the evaluation of tender offers in accordance with C.3 for: a) the gross misplacement of the decimal point in any unit rate; b) omissions made in completing the pricing schedule or bills of quantities; or c) arithmetic errors in: i) line-item totals resulting from the product of a unit rate and a quantity in bills of quantities or schedules of prices; or the summation of the prices.		
C.3.9.2	The arithmetical errors shall be corrected in the following manner: a) Where there is a discrepancy between the amounts in words and amounts in figures, the amount in words shall govern. b) If bills of quantities or pricing schedules apply and there is an error in the line item total resulting from the product of the unit rate and the quantity, the line item total shall govern and the rate shall be corrected. Where there is an obviously gross misplacement of the decimal point in the unit rate, the line item total as quoted shall govern, and the unit rate shall be corrected. c) Where there is an error in the total of the prices either as a result of other Corrections required by this checking process or in the tenderer's addition of prices, the total of the prices shall govern and the tenderer will be asked to revise selected item prices (and their rates if bills of quantities apply) to achieve the tendered total of the prices. The Tender Offer will be rejected if the tenderer does not correct or accept the Correction of the arithmetical error in the manner described above.		
C.3.11	Functionality, Price and Preference The purpose of the evaluation is to ensure and promote compliance with the Constitution, specifically Section 217, which provides that when organs of state contract for goods or services, they must do so in accordance with a system which is fair, equitable, transparent, competitive and cost-effective. The evaluation of bids will be undertaken in 4 stages.		
C.3.12	Stage 1: Initial screening (pre-compliance) on Supply Chain Management returnable requirements		

During this phase bid documents will be reviewed to determine the compliance with Standard Bidding Documents (SBD), SCM returnable, tax matters and contractor had registered on Central Data Base (CSD). All returnable documents must be submitted with the bid documents at the closing date and time of the bid. Bids which do not satisfy the compliance criteria will be disqualified and will not be evaluated further on prequalification criteria.

The bid proposal will be screened for compliance with administrative requirements as indicated below and bidders must circle the correct answer

Item No.	Administrative Requirements	Check/Compliance
1	Master Bid Document	provided and bound
2	Electronic copy (USB/DISK)	Provided and similar to Master Bid Document
3	SCM - SBD 1 - Invitation to Bid	Completed and signed
4	SCM - SBD 4 - Bidder's Disclosure	Completed and signed
5	SCM - SBD 6.1 - Preference Points Claim Form in terms of the Preferential Procurement Regulations 2022	Completed and signed
6	In case of bids where Consortia / Joint Ventures, Consortia/Joint Venture agreement signed by both parties must be submitted with bid proposal	JV agreement completed and signed, if applicable

Stage 2: Mandatory Requirements

The following mandatory requirements will apply and all bids that do not meet mandatory requirements will be disqualified and will not be evaluated further on functionality criteria.

Criteria	Yes/No
Main contractor must have a CIDB contractor grading designation of 5 GB or higher	Yes
A contractor must attend a compulsory Pre-tender Site Inspection Meeting on the date and time published on the tender document	Yes

Stage 3: Functional Evaluation

The Functional Evaluation will be carried out to assess the Bidder's suitability to undertake the project, the Bidder's Company Experience, Current Resource, Current Expertise and project cost will be evaluated.

Bidders who fail to obtain a minimum 70 Points for functionality under **Stage 3** will not be considered further. DFFE shall not be held responsible for incorrect judgement misled by unclear written letters/words on the forms below, to be completed by the Bidder(s). **DO NOT COMPLETE THE FORMS BY WRITING "SEE ATTACHED"**, Bidder(s) who refer to attachment **WILL BE SCORED ZERO**. Attachment shall strictly be made where specified and at the correct location, any attachment other than what has been requested by DFFE, shall be completely ignored, and scored zero, where points allocation is required.

When completing Forms, Bidder(s) may make copies of the original Forms, should the provided forms be inadequate for their completion of the information required. Forms must be hand completed in black ink, no

computer regenerated forms will be accepted. Forms must be completed in full, forms not completed in full shall be rejected by scoring zero.

Stage 4: Price and Preference Points

Price and Preference Points Calculation

The following preference point system will be followed to advance the categories of persons:

a) For contracts with a Rand value up to R50 000 000, a maximum of 20 points may be allocated for specific goals as contemplated above, provided that the lowest acceptable tender scores 80 points for price.

The applicable formula to be used is Ps=80[1-(Pt-Pmin)/Pmin]. Provided:

Ps = Points scored for price of tender under consideration.

Pt = Price of tender under consideration; and

Pmin = Price of the lowest applicable tender.

A total of 20 points may be awarded to a tenderer as follows:

20 points: if the Bidder has more than 50% (fifty percent) by Black people, Women, or people with disabilities

0 Points: for 50% and below ownership by stipulated categories of persons

- b) A contract may be awarded to a tenderer that did not score the highest points only in accordance with section 2(1)(f) of the PPPFA.
- c) Bid will be awarded to a bidder with the highest points on price and Preference Points on condition that they have met all phases of the evaluation criteria and complied with the tender requirements set out in the tender document.
- d) The DFFE reserves the right to negotiate prices that are not deemed market related and not to award the tender to the bidder with the lowest price.
- e) Preference point system applicable for this bid is: 80/20
- f) A total of **20** points will be allocated for either of the specific goals

SPECIFIC GOALS	80/20
>50% ownership by Black people, Or	20
>50% ownership by Women, Or	20
>50% ownership by people with Disability	20

For service providers to claim for preference points the following must be adhered to:

- a) Submit a complete and signed SBD 6.1,
- b) Bidders are requested to submit a valid B-BBEE Status Level Verification Certificate issued by SANAS Accredited Verification Agency; or B-BBEE Certificate issued by CIPC, or Sworn Affidavit commissioned by Commissioner of Oaths or A Consolidated Joint Venture B-BBEE Certificate clearly

		outlining the % ownership by black people, women and people with disabilities. Issued in terms of
		the amended Construction Sector Code.
	c)	Verification Certificate means a B-BBEE Certificate issued in compliance with the B-BBEE Codes of
		Good Practice or Sector Codes issued in terms of Section 9 1 of the Broad Based Black Economic
		Empowerment Act 53 of 2003 as amended by Act 46 of 2013. Issued in terms of the amended
		Construction Sector Code.
	d)	Unincorporated Joint Ventures are required to submit a consolidated verification certificate
C.3.13.1	Tend	er offers will only be accepted on condition that:
	a)	the tenderer is registered with the Construction Industry Development Board in an appropriate
	I-V	contractor grading designation;
	(b)	the bidder or any of its directors is not listed in the Register of Bid Defaulters in terms of the Prevention
		and Combating of Corrupt Activities Act of 2004 as a person prohibited from doing business with the
	,	public sector;
	c)	the bidder has not:
		i. abused the Employer's Supply Chain Management System; or
		ii. failed to perform on any previous contract and has been given a written notice to this effect.
	d)	Has completed the Returnables SBD4, 6.1, forms and there are no conflicts of interest which may
		impact on the tenderer's ability to perform the contract in the best interests of the employer or potentially
		compromise the tender process
		Has submitted the documentation listed in T2.21 and T2.22
C.3.18	The r	number of paper copies of the signed contract to be provided by the employer is ONE.

FORM A: SCHEDULE OF BIDDER'S EXPERIENCE IN CONSTRUCTION PROJECTS

DFFE shall not be held responsible for incorrect judgement misled by unclear written letters/words on the forms below, to be completed by the Bidder(s). **DO NOT COMPLETE THE FORMS BY WRITING "SEE ATTACHED"**, Bidder(s) who refer to attachment will be scored zero. Attachment shall strictly be made where specified and at the correct location, any attachment other than what has been requested by DFFE, shall be completely ignored, and scored zero, where points allocation is required.

When completing Forms, Bidder(s) may make copies of the original Forms, should the provided forms be inadequate for their completion of the information required. Forms must be hand completed in black ink; no computer regenerated forms will be accepted. Forms must be completed in full, forms not completed in full shall be rejected by scoring zero.

- i) In order to qualify for maximum points, the bidder's Contractor must have completed construction of *more than* five (5) in related projects with a minimum value of R1 500 000, excluding VAT over the last 10 years.
- ii) Main contractor must have a CIDB contractor grading designation of **5GB** or higher.

FORM A: COMPLETED PROJECTS

Name of the Bidder		
NUMBER OF YEARS' EXPERIENCE IN THE BUILT ENVIRONMENT OR CONSTRUCTION		
PROJECT No.	1	2
Project Name		
Nature of Project		
Client (Responsible for supervision)		
Client Contact person		
Clients Contact Person (Name, Tel/ Cell no and Fax no)		
Clients Contact Person (email address)		
Consulting Engineer (Name, Tel/ Cell no	/	
and Fax no)		
Appointment Value (at least R1 500 000)		
Project Location (Province)		
Project Duration(months)		
Project Commencement Date (months/year)		
Is the Project Completed (Yes / No)		
Completion certificate attached (Yes or No)		
Estimated Completion Date (If not yet		
Completed)		
Completion Date (If Completed)		
(months/year)		
Main Contractor (Yes / No)		

PROJECT No.	3	4
Project Name		
Nature of Project		
Client (Responsible for supervision)		
Client Contact person		
Clients Contact Person (Name, Tel/ Cell no		
and Fax no)		
Clients Contact Person (email address)		/
Consulting Engineer (Name, Tel/ Cell no		/
and Fax no)		
Appointment Value (at least R1 5000 000)		
Project Location (Province)	/	
Project Duration(months)		
Project Commencement Date (months/year)	/	
Is the Project Completed (Yes / No)		
Completion certificate attached (Yes or No)	/	
Estimated Completion Date (If not yet		
Completed)		
Completion Date (If Completed)		
(months/year)		
Main Contractor (Yes / No)		

PROJECT No.	5	6
Project Name		
Nature of Project		
Client (Responsible for supervision)		
Client Contact person		
Clients Contact Person (Name, Tel/ Cell no		
and Fax no)		
Clients Contact Person (email address)		/
Consulting Engineer (name, Tel no and fax		
no)		
Appointment Value (at least R1 500 000)		, /
Project Location (Province)	/	
Project Duration(months)	/	
Project Commencement Date (months/year)	/	
Is the Project Completed (Yes/No)		
Completion certificate attached (Yes or No)	/	
Estimated Completion Date (If not yet		
Completed)		
Completion Date (If Completed)		
(months/year)		
Main Contractor (Yes/No)		

PROJECT No.	7	8
Project Name		
Nature of Project		
Client (Responsible for supervision)		
Client Contact person		
Clients Contact Person (Name, Tel/ Cell no		
and Fax no)		
Clients Contact Person (email address)		/
Consulting Engineer (Name, Tel/ Cell no		/
and Fax no)		
Appointment Value (at least R1 500 000)		, /
Project Location (Province)	/	
Project Duration(months)		
Project Commencement Date (months/year)	/	
Is the Project Completed (Yes / No)		
Completion certificate attached (Yes or No)	/	
Estimated Completion Date (If not yet		
Completed)		
Completion Date (If Completed)		
(months/year)		
Main Contractor (Yes / No)		

PROJECT No.	9	10
Project Name		
Nature of Project		
Client (Responsible for supervision)		
Client Contact person		
Clients Contact Person (Name, Tel/ Cell no		
and Fax no)		
Clients Contact Person (email address)		/
Consulting Engineer (Name, Tel/ Cell no		/
and Fax no)		
Appointment Value (at least R1 500 000)		
Project Location (Province)	/	
Project Duration(months)	/	
Project Commencement Date (months/year)		
Is the Project Completed (Yes / No)		
Completion certificate attached (Yes or No)	/	
Estimated Completion Date (If not yet		
Completed)		
Completion Date (If completed) (months/year)		
Main Contractor (Yes / No)		

FORM B: EXPERIENCE OF NOMINATED PERSONNEL

Bidders must have experienced staff, who have previously worked on similar projects. The information will be verified with

the references provided. Any information found to be untruthful will lead to the immediate disqualification of the Service

Provider. The bidder must have in its proposal a: -

i) Site Agent with more than 10 years' experience in design and construction management.

ii) General Foreman with more 5 years' experience in contracts management of construction, in order to score

maximum points.

iii) OHS Officer with more than 5 years' experience in site safety management of construction projects.

Bidders are required to complete the forms attached as evidence and also submit detailed CVs as well as the qualifications

and professional registrations of the above-mentioned personnel.

NB:

ONE INDIVIDUAL MAY NOT BE NOMINATED FOR MORE THAN ONE ROLE OR POSITION FOR THIS BID. IF AN

INDIVIDUAL IS NOMINATED FOR MORE THAN ONE ROLE THEN THE POINTS WILL ONLY BE ALLOCATED FOR

ONE OF THE ROLES AND THE BIDDER WILL SCORE ZERO ON ANY OTHER ROLE.

It is mandatory to complete all fields in Form B for each project listed as this information will be deemed to be material to

the award of the Contract. Failure to complete all fields for the project listed may lead to the bidder losing points during

functional evaluation under the categories. Should the bidder choose to present the required information in the

attachments, then the bidder must COMPLETE FORM (B) FIRST and then make a clear reference to such attachments

so that they may be considered; and such attachments must provide the same information requested for in Form B.

FORMS TO BE COMPLETED BY THE BIDDERS

Form B (I) General Foreman

Form B (II) Site Agent

Form B (III) OHS Agent

Page **34** of **51**

FORM B (i) GENERAL FOREMAN

General Foreman in the Company

Post	Name	Qualifications (Degree/Diploma in the Built Environment	Experience in years
General			
Foreman			

Bidders are required to submit as atta	chments after this page, e.g. qualifications.	
Signature	Date	
Name	Capacity	
Bidder		

General Foreman

The Bidder must note that repeating the same year under different project will still be considered as one year's experience.

General Foreman				
Name and Surname				
Experience in years' expe	erience as General Foreman			
EXPERIENCE AS GENEI	RAL FOREMAN			
YEAR of Experience as	General Foreman		Year 1 () (e.g.2019 etc.)	Year 2 () (e.g.2018).
Project Name				/
Nature of Project				
Client (Responsible for su	pervision)			
Client Contact person				
Clients Contact Person (n	name, Tel/Cell no and fax no)			
Clients Contact Person (e	email address)			
Consulting Engineer (nam	ne, Tel no and fax no)			
Appointment Value				
Project Location (Province	e)			
Project Duration(months)				
Project Commencement D	Date (months/year)			
Is the Project Completed ((Yes/No)			
Estimated Completion Da	te (If not yet Completed)			
Completion Date (If Comp	pleted)			
(months/year)				
Roles/Responsibilities p	performed by the Bidder on the project:	t:		
,				

EXPERIENCE AS GENERAL FOREMAN		
YEAR of Experience as General Foreman	Year 3 ()	Year 4 ()
TEXTURE EXPONENCE OF CONTROL FOR CONTROL	(e.g.2019 etc.)	(e.g.2018).
Project Name		
Nature of Project		
Client (Responsible for supervision)		
Client Contact person		
Clients Contact Person (name, Tel/Cell no and fax no)		
Clients Contact Person (email address)		
Consulting Engineer (name, Tel no and fax no)		
Appointment Value		/
Project Location (Province)	/	
Project Duration(months)		
Project Commencement Date (months/year)	/	
Is the Project Completed (Yes/No)		
Estimated Completion Date (If not yet Completed)		
Completion Date (If Completed)	/	
(months/year)		
Roles/Responsibilities performed by the Bidder on the project:		

EXPERIENCE AS GENERAL FOREMAN		
YEAR of Experience as General Foreman	Year 5 ()	Year 6 ()
TEARCH Experience do General Forentali	(e.g.2019 etc.)	(e.g.2018).
Project Name		
Nature of Project		
Client (Responsible for supervision)		
Client Contact person		
Clients Contact Person (name, Tel/Cell no and fax no)		
Clients Contact Person (email address)		
Consulting Engineer (name, Tel no and fax no)		
Appointment Value		
Project Location (Province)	/	
Project Duration(months)		
Project Commencement Date (months/year)	/	
Is the Project Completed (Yes/No)	/	
Estimated Completion Date (If not yet Completed)		
Completion Date (If Completed)	/	
(months/year)		
Roles/Responsibilities performed by the Bidder on the project:		

EXPERIENCE AS GENERAL FOREMAN		
YEAR of Experience as General Foreman	Year 7 ()	Year 8 ()
TEAR of Experience as General Forenian	(e.g.2019 etc.)	(e.g.2018).
Project Name		
Nature of Project		
Client (Responsible for supervision)		
Client Contact person		
Clients Contact Person (name, Tel/Cell no and fax no)		
Clients Contact Person (email address)		
Consulting Engineer (name, Tel no and fax no)		
Appointment Value		/
Project Location (Province)	/	
Project Duration(months)		
Project Commencement Date (months/year)	/	
Is the Project Completed (Yes/No)	/	
Estimated Completion Date (If not yet Completed)		
Completion Date (If Completed)	/	
(months/year)		
Roles/Responsibilities performed by the Bidder on the project:		

EXPERIENCE AS GENERAL FOREMAN		
YEAR of Experience as General Foreman	Year 9 ()	Year 10 ()
TEAR OF Experience as Seneral Forenian	(e.g.2019 etc.)	(e.g.2018).
Project Name		
Nature of Project		
Client (Responsible for supervision)		
Client Contact person		
Clients Contact Person (name, Tel/Cell no and fax no)		
Clients Contact Person (email address)		
Consulting Engineer (name, Tel no and fax no)		
Appointment Value		
Project Location (Province)		
Project Duration(months)		
Project Commencement Date (months/year)	/	
Is the Project Completed (Yes/No)		
Estimated Completion Date (If not yet Completed)		
Completion Date (If Completed)	/	
(months/year)		
Roles/Responsibilities performed by the Bidder on the project:		
/		
Signature	Date	
7		
Name	Capacity	
Bidder		

FORM B (ii) SITE AGENT

Post	Name	Experience in years
Site Agent		

Bidders are required relevant.	to submit as attachments after this pag	e, the CV and any other inform	nation they may consider
Signature _		Date	/
Name _		Capacity	
Bidder _			

Site Agent

The Bidder must note that repeating the same year under different project will still be considered as one year's experience.

SITE AGENT				
Name and Surname				
Experience in years' experience	Experience in years' experience			
EXPERIENCE AS SITE AGEI	NT			
YEAR of Experience as Site	Agent	Yea	r 1 ()	Year 2 ()
		(e.g.	.2019 etc.)	(e.g.2018).
Project Name				
Nature of Project				/
Client (Responsible for superv	rision)		4	
Client Contact person				
Clients Contact Person (name	e, Tel/Cell no and fax no)			
Clients Contact Person (email	address)			
Consulting Engineer (name, T	el no and fax no)		/	
Appointment Value				
Project Location (Province)		7		
Project Duration(months)				
Project Commencement Date	(months/year)			
Is the Project Completed (Yes	/No)			
Estimated Completion Date (If	f not yet Completed)			
Completion Date (If Complete	d)			
(months/year)				
Roles/Responsibilities perfo	rmed by the Bidder on the project:			

EXPERIENCE AS SITE AGENT		
YEAR of Experience as Site Agent	Year 3 ()	Year 4 ()
TEAR OF Experience as Site Agent	(e.g.2017 etc.)	(e.g.2016).
Project Name		
Nature of Project		
Client (Responsible for supervision)		
Client Contact person		
Clients Contact Person (name, Tel/Cell no and fax no)		
Clients Contact Person (email address)		
Consulting Engineer (name, Tel no and fax no)		
Appointment Value		/
Project Location (Province)	/	
Project Duration(months)	/	
Project Commencement Date (months/year)	/	
Is the Project Completed (Yes/No)		
Estimated Completion Date (If not yet Completed)		
Completion Date (If Completed)	/	
(months/year)		
Roles/Responsibilities performed by the Bidder on the project:		

EXPERIENCE AS SITE AGENT			
YEAR of Experience as Site Agent	Year 5 ()	Year 6 ()	
TEAR OF Experience as one Agent	(e.g.2015 etc.)	(e.g.2014).	
Project Name			
Nature of Project			
Client (Responsible for supervision)			
Client Contact person			
Clients Contact Person (name, Tel/Cell no and fax no)			
Clients Contact Person (email address)			
Consulting Engineer (name, Tel no and fax no)			
Appointment Value		/	
Project Location (Province)	/		
Project Duration(months)			
Project Commencement Date (months/year)	/		
Is the Project Completed (Yes/No)			
Estimated Completion Date (If not yet Completed)			
Completion Date (If Completed)			
(months/year)			
Roles/Responsibilities performed by the Bidder on the project:			

EXPERIENCE AS SITE AGENT			
YEAR of Experience as Site Agent	Year 7 ()	Year 8 ()	
TEAN OF Experience as site Agent	(e.g.2013 etc.)	(e.g.2012).	
Project Name			
Nature of Project			
Client (Responsible for supervision)			
Client Contact person			
Clients Contact Person (name, Tel/Cell no and fax no)			
Clients Contact Person (email address)			
Consulting Engineer (name, Tel no and fax no)			
Appointment Value			
Project Location (Province)	/		
Project Duration(months)			
Project Commencement Date (months/year)	/		
Is the Project Completed (Yes/No)			
Estimated Completion Date (If not yet Completed)			
Completion Date (If Completed)			
(months/year)			
Roles/Responsibilities performed by the Bidder on the project:			

EXPERIENCE AS SITE AGENT			
YEAR of Experience as Site Agent	Year 9 ()	Year 10 ()	
TEAR OF Experience as one Agent	(e.g.2013 etc.)	(e.g.2012).	
Project Name			
Nature of Project			
Client (Responsible for supervision)			
Client Contact person			
Clients Contact Person (name, Tel/Cell no and fax no)			
Clients Contact Person (email address)			
Consulting Engineer (name, Tel no and fax no)			
Appointment Value			
Project Location (Province)	A	/	
Project Duration(months)	/		
Project Commencement Date (months/year)	/		
Is the Project Completed (Yes/No)	/		
Estimated Completion Date (If not yet Completed)			
Completion Date (If Completed)			
(months/year)			
Roles/Responsibilities performed by the Bidder on the project:			
•			
Signature	Date		
Name Capacity			
Bidder			

FORM B (IIi) OHS Officer

Post	Name	Qualifications in Safety Management	Experience in years
OHS Officer			

Bidders are required to subm	t as attachments after this page, e.g. the qualifications.
Signature	Date
Name	Capacity
Bidder	

OHS Agent/ Safety Officer

SAFETY OFFICER		
Name and Surname		
Experience in years' experience as Safety Officer		
EXPERIENCE AS SAFETY OFFICER IN SITE MANAGEMENT O	F CONSTRUCTION PROJ	ECTS.
YEAR of Experience as OHS Agent	Year 1 () (e.g.2019 etc.)	Year 2 () (e.g.2018).
Project Name		
Nature of Project		
Client (Responsible for supervision)		
Client Contact person		/
Clients Contact Person (name, Tel/Cell no and fax no)	/	
Clients Contact Person (email address)		
Consulting Engineer (name, Tel no and fax no)	/	
Appointment Value	/	
Project Location (Province)		
Project Duration(months)		
Project Commencement Date (months/year)		
Is the Project Completed (Yes/No)		
Estimated Completion Date (If not yet Completed)		
Completion Date (If Completed)		
(months/year)		
Roles/Responsibilities performed by the Bidder on the project:		

EXPERIENCE AS SAFETY OFFICER IN SITE MANAGEMENT OF CONSTRUCTION PROJECTS.		
YEAR of Experience as OHS Agent	Year 3 ()	Year 4 ()
TEAR OF Experience as Ono Agent	(e.g.2017 etc.)	(e.g.2016).
Project Name		
Nature of Project		
Client (Responsible for supervision)		
Client Contact person		
Clients Contact Person (name, Tel/Cell no and fax no)		
Clients Contact Person (email address)		
Consulting Engineer (name, Tel no and fax no)		
Appointment Value		/
Project Location (Province)	/	/
Project Duration(months)	/	
Project Commencement Date (months/year)	/	
Is the Project Completed (Yes/No)	/	
Estimated Completion Date (If not yet Completed)		
Completion Date (If Completed)		
(months/year)		
Roles/Responsibilities performed by the Bidder on the project:		

EXPERIENCE AS SAFETY OFFICER IN SITE MANAGEMENT OF CONSTRUCTION PROJECTS.			
YEAR of Experience as OHS Agent	Year 5 ()	Year 6 ()	
TEAR OF Experience as Offic Agent	(e.g.2015 etc.)	(e.g.2014).	
Project Name			
Nature of Project			
Client (Responsible for supervision)			
Client Contact person			
Clients Contact Person (name, Tel/Cell no and fax no)			
Clients Contact Person (email address)			
Consulting Engineer (name, Tel no and fax no)			
Appointment Value			
Project Location (Province)	/		
Project Duration(months)			
Project Commencement Date (months/year)	/		
Is the Project Completed (Yes/No)	/		
Estimated Completion Date (If not yet Completed)			
Completion Date (If Completed)	/		
(months/year)			
Roles/Responsibilities performed by the Bidder on the project:			
/			
Signature	Date		
		_	
Name	Capacity		
Bidder			

ANNEXURE - C

STANDARD CONDITION OF TENDER

T2.1. LIST OF RETURNABLE DOCUMENTS

Checklist for the Returnable Documents Required for Tender Evaluation Purposes (as stipulated in the table of content above)

T2.2 Returnable Documents required for tender evaluation purposes.

Note: Failure to submit the applicable documents will result in the tender offer being disqualified from further consideration.

Tender document name	Reference	Returnable document
Form of Offer and Acceptance		⊠Yes □No
Bills of Quantities/Lump Sum Document and Final Summary (in Volume – 3 (C2.1)		⊠Yes □No
Bidders Disclosure	SBD 4	⊠Yes □No
Resolution of Board of Directors		⊠Yes □No
Resolution of Board of Directors to enter into Consortia or Joint Ventures Special Resolution of Consortia or Joint Ventures (<i>if applicable</i>)		⊠Yes □No
Special Resolution of Consortia or Joint Ventures (if applicable)		⊠Yes □No
Functionality Evaluation Criteria		⊠Yes □No
Pre-tender Site Inspection Meeting Certificate		⊠Yes □No
Schedule of Tenderer's Current and Completed Projects		⊠Yes □No
Preference Points Claim Form in terms of the Preferential Procurement Regulations 2022	SBD 6.1	⊠Yes □No
Affidavit		⊠Yes □No

T2.2.1 Returnable documents that will be incorporated into the contract.

<u>Note</u>: Failure to submit the applicable documents may result in the Tenderer having to submit same upon request within a stipulated time, and if not complied with, may result in the tender offer being disqualified from further consideration. [See also the Standard Conditions of Tender]

Tender document name	Reference	Returnable document
Record of Addenda to tender documents) (if applicable)		⊠Yes □No
Credentials of Mechanical / Security Work material and equipment schedules (if applicable)		⊠Yes □No
Credentials of plumbing Contractor		⊠Yes □No
Credentials of Electrical Contractor (s)		⊠Yes □No
Schedule for Imported Materials and Equipment		⊠Yes □No

T2.2.2 Recommended returnable Documents: Other documents that will be incorporated into the Contract (special condition)

Tender document name	Reference	Returnable document
Declaration Certificate for Local Production and Content for Designated Sectors (Annexure C, D, E: Local & Imported Content Declarations).	SBD 6.2	⊠Yes □No

T2.2.3 Additional Information that might be required for tender evaluation `purpose.

Leg	al Status of Tendering Entity:	Documentation to be submitted with the tender, or
If th	e Tendering Entity is: ZX	which may be required during the tender evaluation:
a.	A close corporation, incorporated prior to 1 May 2011 under the Close Corporations Act, 1984 (Act 69 of 1984, as amended)	Copies of the Founding Statement – CK1
b.	A profit company duly registered as a private company. [including a profit company that meets the criteria for a private company, whose Memorandum of Incorporation states that the company is a personal liability company in terms of Section 8(2)(c) of the Companies Act, 2008 (Act 71 of 2008, as amended)].	 i. Certificate of Incorporation – CM1. ii. Shareholding Certificates of all Shareholders of the company, plus a signed statement of the company's Auditor, certifying each Shareholder's ownership / shareholding percentage relative to the total; and/or iii. Memorandum of Incorporation in the case of a personal liability company.
C.	A profit company duly registered as a private company in which any, or all, shares are held by one or more other close corporation(s) or company(ies) duly registered as profit or non-profit company(ies).	Copies of documents referred to in a. and/or b. above in respect of all such close corporation(s) and/or company(ies).
d.	A profit company duly registered as a public company.	Copy of Certificate of Incorporation – CM1, and a signed statement of the company's Secretary or Auditor confirming that the company is a public company.
e.	A non-profit company, incorporated in terms of Section 10 and Schedule 1 of the Companies Act, 2008 (Act 71 of 2008, as amended).	i the Founding Statement – CK1; and ii the Memorandum of Incorporation setting out the object of the company, indicating the public benefit, cultural or social activity, or communal or group interest.
f.	A natural person, sole proprietor or a Partnership	Copy(ies) of the Identity Document(s) of:

Legal Status of Tendering Entity:	Documentation to be submitted with the tender, or
If the Tendering Entity is: ZX	which may be required during the tender evaluation:
	i. such natural person/ sole proprietor, or each of the
	Partners to the Partnership.
g. A Trust	Deed of Trust duly indicating names of the Trustee(s) and
	Beneficiary (ies) as well as the purpose of the Trust and
	the mandate of the Trustees.

Additional returnable documents required for tender evaluation purposes.

Note: Failure to submit the applicable documents may result in the Tenderer having to submit same upon request within a stipulated time and if not complied with, will result in the tender offer being disqualified from further consideration. [See also the Standard Conditions of Tender]

Tender document name	Reference	Returnable document
Any additional information required to complete a risk assessment		⊠Yes □No

Signed by the Tenderer/Bidder

Name of representative	Signature	Date

C1.1 FORM OF OFFER AND ACCEPTANCE

STAMP

OFFER

The Employer, identified in the Acceptance signature block, has solicited offers

to enter into a contract in respect of the following works:

MP - SWILE MAVOKWENI GAME FARM AND WILDLIFE

The Tenderer, identified in the Offer signature block below, has examined the documents listed in the Tender Data and addenda thereto as listed in the returnable schedules, and by submitting this Offer has accepted the Conditions of Tender.

By the representative of the Tenderer, deemed to be duly authorised, signing this part of this Form of Offer and Acceptance, the Tenderer offers to perform all of the obligations and liabilities of the Contractor under the Contract including compliance with all its terms and conditions according to their true intent and meaning for an amount to be determined in accordance with the Conditions of Contract identified in the Contract Data.

THE OFFERED TOTAL OF THE PRICES INCLUSIVE OF VALUE ADDED TAX IS:

	T	
Rand (in words):		
rtana (iii woras).		
Dand (in figures):	D	
Rand (in figures):	N .	
The award of the tender	may be subjected to further price negotiation with the preferred tenderer(s). The negotiated and	
The award of the tender	may be subjected to further price negotiation with the preferred tenderer(s). The negotiated and	
agreed price will be considered for acceptance as a firm and final offer.		
agreed price in second	nuoroa for acceptance de a mini ana miar chon	

This Offer may be accepted by the Employer by signing the Acceptance part of this Form of Offer and Acceptance and returning one copy of this document to the Tenderer before the end of the period of validity stated in the Tender Data, whereupon the Tenderer becomes the party named as the Contractor in the Conditions of Contract identified in the Contract Data.

THIS OFFER IS MADE BY THE FOLLOWING: (cross out block which is not applicable)

Company or Close Corporation:		Natural Person or Partnership:
	OR	·

And: Whose Registration Number is:		Whose Identity Nur	nber(s) is/are:
And: Whose Income Tax Reference Number is	s:	Whose Income Tax	Reference Number is/are:
CSD supplier number:		CSD supplier	
	AND WHO IS (if app	l plicable):	
Trading under the name and style of:			
	AND WHO IS		
Represented herein, and who is duly authorise	ed to do so, by:	Note:	
Mr/Mrs/Ms:		the Directors / Mei Entity must accon	wer of Attorney, signed by all mbers / Partners of the Legal npany this Offer, authorizing e to make this offer.
In his/her capacity as:			
SIGNED FOR THE TENDERER:			
Name of representative	Sign	nature	Date
WITNESSED BY:			
Name of witness	Sign	nature	Date

This Offer is in respect of: (Please indicate with an "X" in the appropriate block)

The official documents The official alternative	(N.B.: Separate Offer and Acceptance forms are to be completed for the main and for each alternative offer)
Own alternative (only if documentation makes provision therefore)	
SECURITY OFFERED:	

ACCEPTANCE

By signing this part of this Form of Offer and Acceptance, the Employer identified below accepts the Tenderer's Offer. In consideration thereof, the Employer shall pay the Contractor the amount due in accordance with the Conditions of Contract identified in the Contract Data. Acceptance of the Tenderer's Offer shall form an agreement, between the Employer and the Tenderer upon the terms and conditions contained in this Agreement and in the, Contract that is the subject of this Agreement.

The terms of the contract, are contained in:

Part C1 Agreements and Contract Data, (which includes this Agreement)

Part C2 Pricing Data

Part C3 Specification

Part C4 Locality Plan

and Tender drawings and documents or parts thereof, which may be incorporated by reference into Parts C1 to C4. Deviations from and amendments to the documents listed in the Tender Data and any addenda thereto listed in the Tender Schedules as well as any changes to the terms of the Offer agreed by the Tenderer and the Employer during this process of offer and acceptance, are contained in the Schedule of Deviations attached to and forming part of this Agreement. No amendments to or deviations from said documents are valid unless contained in this schedule.

The Tenderer shall within two weeks after receiving a letter of acceptance, contact the Employer's agent (whose details are given in the Contract Data) to arrange the delivery of guarantees, proof of insurance and any other documentation to be provided in terms of the Conditions of Contract identified in the Contract Data. Failure to fulfil any of these obligations in accordance with those terms shall constitute a repudiation of this Agreement.

Notwithstanding anything contained herein, this Agreement comes into effect on the date when the Tenderer receives one fully completed original copy of this document, including the Schedule of Deviations (if any). Unless the Tenderer (now Contractor) within five days of the date of such receipt notifies the Employer in writing of any reason why he cannot accept the contents of this Agreement, this Agreement shall constitute a binding contract between the parties

NAME(s): (BLOCK LETTERS)		
CAPACITY of authorized agents:		
SIGNATURE(s) of authorized agents:		
SIGNED at	on this day	of
WITNESSE(s): (Full name – BLOCK L	.ETTERS – and signature)	
1		

T2.1 & T2.2 RETURNABLE DOCUMENTS

BIDDERS DISCLOSURE

Failure to complete this form in <u>full</u> and signed by the duly authorized person, as indicated on the Resolution of board of directors or Special resolution of consortia or joint ventures, may render the tender non-responsive and will be removed from any and all further contention.

PURPOSE OF THE FORM

Any person (natural or juristic) may make an offer or offers in terms of this invitation to bid. In line with the principles of transparency, accountability, impartiality, and ethics as enshrined in the Constitution of the Republic of South Africa and further expressed in various pieces of legislation, it is required for the bidder to make this declaration in respect of the details required hereunder.

Where a person/s are listed in the Register for Tender Defaulters and / or the List of Restricted Suppliers, that person will automatically be disqualified from the bid process.

2. Bidder's declaration

- 2.1 Is the bidder, or any of its directors / trustees / shareholders / members / partners or any person having a controlling interest ¹in the enterprise, employed by the state?

 YES/NO
- 2.1.1 If so, furnish particulars of the names, individual identity numbers, and, if applicable, state employee numbers of sole proprietor/ directors / trustees / shareholders / members/ partners or any person having a controlling interest in the enterprise, in table below.

Full Name	Identity Number	Name of Stateinstitution

¹ The power, by one person or a group of persons holding the majority of the equity of an enterprise, alternatively, the person/s having the deciding vote or power to influence or to direct the course and decisions of the enterprise.

2.2	Do you, or any person connected with the bidder, have a relationship with any person who is employed by the procuring institution? YES/NO
2.2.1	If so, furnish particulars:
2.3	Does the bidder or any of its directors / trustees / shareholders / members / partners or any person having a controlling interest in the enterprise have any interest in any other related enterprise whether or not they are bidding for this contract? YES/NO
2.3.1	If so, furnish particulars:
3	DECLARATION
	undersigned, (name)
3.1	I have read and I understand the contents of this disclosure;
3.2	I understand that the accompanying bid will be disqualified if this disclosure is found not to be true and complete in every respect;

3.3 The bidder has arrived at the accompanying bid independently from, and without consultation, communication, agreement or arrangement with any competitor. However, communication between partners in a joint venture or consortium² will not be construed as collusive bidding.

- 3.4 In addition, there have been no consultations, communications, agreements or arrangements with any competitor regarding the quality, quantity, specifications, prices, including methods, factors or formulas used to calculate prices, market allocation, the intention or decision to submit or not to submit the bid, bidding with the intention not to win the bid and conditions or delivery particulars of the products or services to which this bid invitation relates.
- 3.5 The terms of the accompanying bid have not been, and will not be, disclosed by the bidder, directly or indirectly, to any competitor, prior to the date and time of the official bid opening or of the awarding of the contract.
- 3.6 There have been no consultations, communications, agreements or arrangements made by the bidder with any official of the procuring institution in relation to this procurement process prior to and during the bidding process except to provide clarification on the bid submitted where so required by the institution; and the bidder was not involved in the drafting of the specifications or terms of reference for this bid.
- 3.7 I am aware that, in addition and without prejudice to any other remedy provided to combat any restrictive practices related to bids and contracts, bids that are suspicious will be reported to the Competition Commission for investigation and possible imposition of administrative penalties in terms of section 59 of the Competition Act No 89 of 1998 and or may be reported to the National Prosecuting Authority (NPA) for criminal investigation and or may be restricted from conducting business with the public sector for a period not exceeding ten (10) years in terms of the Prevention and Combating of Corrupt Activities Act No 12 of 2004 or any other applicable legislation.

I CERTIFY THAT THE INFORMATION FURNISHED IN PARAGRAPHS 1, 2 and 3 ABOVE IS CORRECT.

I ACCEPT THAT THE STATE MAY REJECT THE BID OR ACT AGAINST ME IN TERMS OF PARAGRAPH 6 OF PFMA SCM INSTRUCTION 03 OF 2021/22 ON PREVENTING AND COMBATING ABUSE IN THE SUPPLY CHAIN MANAGEMENT SYSTEM SHOULD THIS DECLARATION PROVE TO BE FALSE.

² Joint venture or Consortium means an association of persons for the purpose of combining their expertise, property, capital, efforts, skill and knowledge in an activity for the execution of a contract.

Signature	Date
Capacity	Name of Bidder



RESOLUTION OF BOARD OF DIRECTORS

RESOLUTION of a meeting of the Board of *Directors / Members / Partners of:						
					_	
(Le	egally correct full name and registration number, if applicable, of the	Enterprise)				
Held at		(place)on	(date) F	RESOLV	ΈD	
tha	ıt:					
1.	The Enterprise submits a Bid / Tender to the Department of For following project:				the	
	(Project description as per Bid / Tender Document)				_	
	Bid / Tender Number:	(Bid / Tender N	umber as per B	id / Ten	der	
2.	*Mr/Mrs/Ms:					
	in *his/her Capacity as:		(Position	in	the	
	and who will sign as follows:					

be, and is hereby, authorized to sign the Bid / Tender, and any and all other documents and/or correspondence in connection with and relating to the Bid / Tender, as well as to sign any Contract, and any and all documentation, resulting from the award of the Bid / Tender to the Enterprise mentioned above.

No.	Name	Capacity	Signature
1			
2			
3			
4			
5			
6			
7			



The bidding enterprise hereby absolves the Department of Forestry, Fisheries and Environment from any liability whatsoever that mayarise as a result of this document being signed.

Note:

- 1. * Delete which is not applicable.
- 2. **NB:** This resolution must, where possible, be signed by <u>all</u> the Directors / Members / Partners of the Bidding Enterprise.
- 3. In the event that paragraph 2 cannot be complied with, the resolution must be signed by Directors / Members / Partners holding a majority of the shares / ownership of the Bidding Enterprise (attach proof of shareholding / ownership hereto).
- 4. Directors / Members / Partners of the Bidding Enterprise may alternatively appoint a person to sign this document on behalf of the Bidding Enterprise, which person must be authorized by way of a duly completed power of attorney, signed by the Directors / Members / Partners holding a majority of the shares / ownership of the Bidding Enterprise (proof of shareholding / ownership and power of attorney are to be attached hereto).
- 5. Should the number of Directors / Members / Partners exceed the space available above, additional names and signatures must be supplied on a separate page.

ENTERPRISE STAMP



RESOLUTION OF BOARD OF DIRECTORS TO ENTER INTOCONSORTIA OR JOINT VENTURES

RESOLUTION of a meeting of the Board of *Directors / Members / Partners of:		
(Legally correct full name and registration number, if applic	cable, of the Enterprise)	
Held at	(place)on(date) RESOLVED that:	
The Enterprise submits a Bid /Tender, in consortium/Jo	oint Venture with the following Enterprises:	
(List all the legally correct full names and registration number forming the Consortium/JointVenture)	bers, if applicable, of the Enterprises	
to the Department of Forestry, Fisheries and Environment	in respect of the following project:	
MP - SWILE MAVOKWENI GAME FARM AND WILDLIFE	<u>E (</u> Project description as per Bid /Tender Document)	
Bid / Tender Number:	(Bid / Tender Number as per Bid / Tender	

2.	*Mr/Mrs/Ms:		
	is/her Capacity as: rprise)		(Position in the
and	who will sign as follow	<i>y</i> s:	
1 ab	ove, and any and all	red to sign a consortium/joint venture agreement with the par other documents and/or correspondence in connection win n respect of the project described under item 1 above.	
3.	obligations of the joi	nts joint and several liabilities with the parties listed under item 1 nt venture deriving from, and in any way connected with, the C ect of the project described under item 1 above.	
4.		ses as its <i>domicilium citandi et executandi</i> for all purposes aris th the Department in respect of the project under item 1 abov	
Phys	ical address:		
		(code)	
Post	al Address:		
		(code)	
Tele	phone number:		

Fax number:

No.	Name	Capacity	Signature
1			
2			
3			
4			
5			
6			
7			
8			
9			
10			
11			
12			

The bidding enterprise hereby absolves the Department of Forestry, Fisheries and the Environment from any liability whatsoever that mayarise as a result of this document being signed

Note:

- 1. * Delete which is not applicable.
- NB: This resolution must, where possible, be signed by <u>allthe Directors</u> / Members / Partners of the Bidding Enterprise.
- In the event that paragraph 2 cannot be complied with, theresolution must be signed by Directors / Members / Partners holding a majority of the shares / ownership of the Bidding Enterprise (attach proof of shareholding / ownership hereto).
- 4. Directors / Members / Partners of the Bidding Enterprise may alternatively appoint a person to sign this document on behalf of the Bidding Enterprise, which person must beso authorized by way of a duly completed power of attorney, signed by the Directors / Members / Partners holding a majority of the shares / ownership of the BiddingEnterprise (proof of shareholding / ownership and power ofattorney are to be attached hereto).
- Should the number of Directors / Members / Partners exceed the space available above, additional names and signatures must be supplied on a separate page.

ENTERPRISE STAMP	



SPECIAL RESOLUTION OF CONSORTIA OR JOINT VENTURES

RESOLUTION of a meeting of the duly authorized representatives of the following legal entities whohave entered into a consortium/joint venture to jointly bid for the project mentioned below: (*legally correct full names and registration numbers, if applicable, of the Enterprises forming a Consortium/Joint Venture*)

1.	
2.	
_	
3.	
_	
4.	
_	
5.	
Ο.	

6.	
7.	
8.	

He	Held at((<i>place</i>)on	_(date) RESOLVED that:
RE	RESOLVED that:		
A.	A. The above-mentioned Enterprises submit a Bid in Consortium/Jo Fisheries, and the Environment in respect of the following project:	int Venture	to the Department ofForestry,
	MP - SWILE MAVOKWENI GAME FARM AND WILDLIFE (Project d	escription as	per Bid /Tender Document)
	Bid / Tender Number:	<u>(</u> Bid / Tender	Number as per Bid /Tender
В.	3. *Mr/Mrs/Ms:		
	in *his/her Capacity as:		(Position in the
	and who will sign as follows:		
	be, and is hereby, authorized to sign the Bid, and any and all other do with and relating to the Bid, as well as to sign any Contract, and any are of the Bid to the Enterprises in Consortium/Joint Venture mentioned a	nd all docume	•
C.	C. The Enterprises constituting the Consortium/Joint Venture, notwithstar business under the name and style of:	nding its comp	position, shall conductall

- D. The Enterprises to the Consortium/Joint Venture accept joint and several liabilities for the due fulfilment of the obligations of the Consortium/Joint Venture deriving from, and in any way connected with, the Contract entered into with the Department in respect of the project described under item A above.
- E. Any of the Enterprises to the Consortium/Joint Venture intending to terminate the consortium/joint ventureagreement,

for whatever reason, shall give the Department 30 days' written notice of such intention. Notwithstanding such decision to terminate, the Enterprises shall remain jointly and severally liable to the Department for the due fulfilment of the obligations of the Consortium/Joint Venture as mentioned underitem D above.

- F. No Enterprise to the Consortium/Joint Venture shall, without the prior written consent of the other Enterprises to the Consortium/Joint Venture and of the Department, cede any of its rights or assign any of its obligations under the consortium/joint venture agreement in relation to the Contract with the Department referred to herein.
- G. The Enterprises choose as the *domicilium citandi et executandi* of the Consortium/Joint Venture for all purposes arising from the consortium/joint venture agreement and the Contract with the Department in respect of the project under item A above:

Physical address:	
	(code)
Postal Address:	
	(code)
Telephone number:	
Fax number:	

No.	Name	Capacity	Signature
1			
2			
3			
4			
5			
6			
7			
8			
9			
10			
11			
12			
13			
14			
15			

The bidding enterprise hereby absolves the Department of Fisheries and the Environment from any liability whatsoever that may arise as a result of this document being signed.

Note:

- 1. * Delete which is not applicable.
- 2. NB: This resolution must be signed by <u>all</u> the Duly Authorized Representatives of the Legal Entities to the consortium/joint venture submitting this tender, as named in item 2 of Resolution of board of directors to enter into consortia or joint ventures.
- 3. Should the number of the Duly Authorized Representatives of the Legal Entities joining forces in this tender exceed the space available above, additional names, capacity and signatures must be supplied on a separate page.
- 4. Resolution of board of directors to enter into consortia or joint ventures, duly completed and signed, from the separate Enterprises who participate in this consortium/joint venture, must be attached to this Special Resolution (special resolution of consortia or joint ventures).



Pre-tender Site Inspection Meeting Certificate

Project Name:	MP - SWILE MAVOKWENI GAME FARM AND WILDLIFE		
Tender no:	DFFE-T017(23-24)	DFFE-T017(23-24) Reference no: EPIP-A17	
Advertising date:	04 August 2023	Closing date:	07 September 2023
his is to certify that I.			representing
			in the company of
visited the site on:			
am satisfied with the desc	ription of the work, and exp	•	ne cost thereof. I further certify that ection meeting, and that I perfectly tract.
Name of T	enderer	Signature	Date
			<u> </u>

Name of DFFE Representative (PM / SCM)	Signature	Date

PREFERENCE POINTS CLAIM FORM IN TERMS OF THE PREFERENTIAL PROCUREMENT REGULATIONS 2022

This preference form must form part of all tenders invited. It contains general information and serves as a claim form for preference points for specific goals.

NB: BEFORE COMPLETING THIS FORM, TENDERERS MUST STUDY THE GENERAL CONDITIONS, DEFINITIONS AND DIRECTIVES APPLICABLE IN RESPECT OF THE TENDER AND PREFERENTIAL PROCUREMENT REGULATIONS, 2022

1. GENERAL CONDITIONS

- 1.1 The following preference point systems are applicable to invitations to tender:
 - the 80/20 system for requirements with a Rand value of up to R50 000 000 (all applicable taxes included).
 - The applicable preference point system for this tender is the 80/20 preference point system.
- 1.2 Points for this tender shall be awarded for:
 - (a) Price; and
 - (b) Specific Goals.

1.3 To be completed by the organ of state:

The total points for this tender are allocated as follows:

	POINTS
PRICE	80
SPECIFIC GOALS	20
Total points for Price and SPECIFIC GOALS	100

- 1.4 Failure on the part of a tenderer to submit proof or documentation required in terms of this tender to claim points for specific goals with the tender, will be interpreted to mean that preference points for specific goals are not claimed.
- 1.5 The organ of state reserves the right to require of a tenderer, either before a tender is adjudicated or at any time subsequently, to substantiate any claim in regard to preferences, in any manner required by the organ of state.

2. **DEFINITIONS**

(a) "tender" means a written offer in the form determined by an organ of state in response to an invitation to provide goods or services through price quotations,

competitive tendering process or any other method envisaged in legislation;

- (b) "price" means an amount of money tendered for goods or services, and includes all applicable taxes less all unconditional discounts;
- (c) "rand value" means the total estimated value of a contract in Rand, calculated at the time of bid invitation, and includes all applicable taxes;
- (d) "tender for income-generating contracts" means a written offer in the form determined by an organ of state in response to an invitation for the origination of income-generating contracts through any method envisaged in legislation that will result in a legal agreement between the organ of state and a third party that produces revenue for the organ of state, and includes, but is not limited to, leasing and disposal of assets and concession contracts, excluding direct sales and disposal of assets through public auctions; and
- (e) "the Act" means the Preferential Procurement Policy Framework Act, 2000 (Act No. 5 of 2000).

3. FORMULAE FOR PROCUREMENT OF GOODS AND SERVICES

3.1. POINTS AWARDED FOR PRICE

3.1.1 THE 80/20 PREFERENCE POINT SYSTEMS

A maximum of 80 points is allocated for price on the following basis:

80/20

$$Ps = 80\left(1 - \frac{Pt - Pmin}{Pmin}\right)$$

Where

Ps = Points scored for price of tender under consideration

Pt = Price of tender under consideration

Pmin = Price of lowest acceptable tender

4. POINTS AWARDED FOR SPECIFIC GOALS

- 4.1. In terms of **Regulation 4(2)**of the Preferential Procurement Regulations, preference points must be awarded for specific goals stated in the tender. For the purposes of this tender the tenderer will be allocated points based on the goals stated in table 1 below as may be supported by proof/ documentation stated in the conditions of this tender:
 - (a) any other invitation for tender, that is 80/20 preference point system will apply and that the lowest acceptable tender will be used to determine the applicable preference point system, then the organ of state must indicate the points allocated for specific goals for 80/20 preference point system.

Table 1: Specific goals for the tender and points claimed are indicated per the table below.

Note to tenderers: The tenderer must indicate how they claim points for each preference point system.)

A: Number of points allocated (80/20 system) (To be completed by the organ of state)	B: Number of points claimed (80/20 system) (To be completed by the tenderer) B=A(20)
20	
20	
20	
	points allocated (80/20 system) (To be completed by the organ of state) 20

NB: POINTS CLAIMED BY SUPPLIER MUST BE THE SAME AS POINTS IN A FOR SPECIFIC GOALS

DECLARATION WITH REGARD TO COMPANY/FIRM

4.2.	Name of company/firm					
4.3.	Company registration number:					
4.4.	TYPE OF COMPANY/ FIRM					
	 □ Partnership/Joint Venture / Consortium □ One-person business/sole propriety □ Close corporation □ Public Company □ Personal Liability Company □ (Pty) Limited □ Non-Profit Company □ State Owned Company [TICK APPLICABLE BOX] 					

- 4.5. I, the undersigned, who is duly authorised to do so on behalf of the company/firm, certify that the points claimed, based on the specific goals as advised in the tender, qualifies the company/ firm for the preference(s) shown and I acknowledge that:
 - i) The information furnished is true and correct;
 - ii) The preference points claimed are in accordance with the General Conditions as indicated in paragraph 1 of this form;

- iii) In the event of a contract being awarded as a result of points claimed as shown in paragraphs 1.4 and 4.2, the contractor may be required to furnish documentary proof to the satisfaction of the organ of state that the claims are correct;
- iv) If the specific goals have been claimed or obtained on a fraudulent basis or any of the conditions of contract have not been fulfilled, the organ of state may, in addition to any other remedy it may have
 - (a) disqualify the person from the tendering process;
 - recover costs, losses or damages it has incurred or suffered as a result of that person's conduct;
 - (c) cancel the contract and claim any damages which it has suffered as a result of having to make less favourable arrangements due to such cancellation;
 - (d) recommend that the tenderer or contractor, its shareholders and directors, or only the shareholders and directors who acted on a fraudulent basis, be restricted from obtaining business from any organ of state for a period not exceeding 10 years, after the audi alteram partem (hear the other side) rule has been applied; and
 - (e) forward the matter for criminal prosecution, if deemed necessary.

	SIGNATURE(S) OF TENDERER(S)
SURNAME AND NAME:	
DATE:	
ADDRESS:	

DECLARATION WITH REGARD TO COMPANY/FIRM

4.3.	Name	of company/firm
4.4.	Comp	pany registration number:
4.5.	TYPE	OF COMPANY/ FIRM
		Partnership/Joint Venture / Consortium
		One-person business/sole propriety
		Close corporation
		Public Company
		Personal Liability Company
		(Pty) Limited
		Non-Profit Company
		State Owned Company
	[TICK	APPLICABLE BOX]

- 4.6. I, the undersigned, who is duly authorised to do so on behalf of the company/firm, certify that the points claimed, based on the specific goals as advised in the tender, qualifies the company/ firm for the preference(s) shown and I acknowledge that:
 - i) The information furnished is true and correct;
 - ii) The preference points claimed are in accordance with the General Conditions as indicated in paragraph 1 of this form;
 - iii) In the event of a contract being awarded as a result of points claimed as shown in paragraphs 1.4 and 4.2, the contractor may be required to furnish documentary proof to the satisfaction of the organ of state that the claims are correct;
 - iv) If the specific goals have been claimed or obtained on a fraudulent basis or any of the conditions of contract have not been fulfilled, the organ of state may, in addition to any other remedy it may have
 - (b) disqualify the person from the tendering process;
 - (c) recover costs, losses or damages it has incurred or suffered as a result of that person's

conduct;

- (d) cancel the contract and claim any damages which it has suffered as a result of having to make less favourable arrangements due to such cancellation;
- (e) recommend that the tenderer or contractor, its shareholders and directors, or only the shareholders and directors who acted on a fraudulent basis, be restricted from obtaining business from any organ of state for a period not exceeding 10 years, after the audi alteram partem (hear the other side) rule has been applied; and
- (f) forward the matter for criminal prosecution, if deemed necessary.

WITNESSES	
	SIGN
1. <u>.</u>	
2	DATE
2	
	ADDRESS

SIGNATURE(S) OF BIDDERS(S)
DATE
ADDRESS

Schedule of Tenderer's Current and Completed Projects

Project Name:	MP - SWILE MAVOKWENI GAME FARM AND WILDLIFE					
Tender No:	OFFE-T017(23-24) Closing date: 07 September 2023					
Advertising date:	04 August 2023	4 August 2023 Validity period: 120 days				

1. Particulars of Tenderer's Current and Completed commitments.

1.1. Current Projects

Projec	ts currently engaged in	Name of the Employer or Representative of the Employer	Contact Cell / Tel. no. of the Employer or Representative of the Employer	Contract amount	Contractual commencement date	Contractual completion date	Current percentage progress
1							
2							
3							
4							
5							

6				
7				
8				

1.2. Completed Projects

	ojects completed not above 10 en) years	Name of the Employer or Representative of the Employer	Contact Cell / Tel. no. of the Employer or Representative of the Employer	Contract amount	Contractual commencement date	Contractual completion date	Actual completion date	Date of Certificate of Practical Completion
1								
2								
3								
4								
5								
6								

7									
8									
9									
10									
Name of Tenderer			Signature			Date			



RECORD OF ADDENDA TO TENDER DOCUMENTS

Project Name:	MP - SWILE MAVOKWENI GAME FARM AND WILDLIFE				
Tender no:	DFFE-T017(23-24)	Reference no:	EPIP-A170102698		

1. I/We confirm that the following communications received from the Department of Forestry, Fisheries and Environment before the submission of this tender offer, amending the tender documents, have been taken into account in this tender offer: (Attach additional pages if more space is required)

No.	Date	Title or Details
1.		
2.		
3.		
4.		
5.		
6.		
7.		
8.		
9.		

10.			
	Name of Tenderer	Signature	Date
		were received from the Department of Forestry, Fish is tender offer, amending the tender documents.	neries and
	N 67 1		
	Name of Tenderer	Signature	Date



SCHEDULE FOR IMPORTED MATERIALS AND EQUIPMENT

Project Name:	MP - SWILE MAVOKWENI GAME FARM AND WILDLIFE		
Tender no:	DFFE-T017(23-24)	Reference no:	EPIP-A170102698

This schedule should be completed by the tenderer. (Attach additional pages if more space is required)

Item	Material / Equipment	Rand (R) (Excluding VAT)
1.		R
2.		R
3.		R
4.		R
5.		R
6.		R

The Contractor shall list imported items, materials and/or equipment which shall be excluded from the Contract Price Adjustment Provisions (if applicable) and shall be adjusted in terms of currency fluctuations only. Copies of the supplier's quotations for the items, materials or equipment (provided that such costs shall not be higher than the relevant contract rate as listed above) should be lodged with the Principal Agent / Engineer of the Department of Forestry, Fisheries and Environment within sixty (60) days from the date of acceptance of the tender. No adjustment of the local VAT amount, nor the contractor's profit, discount, mark-up, handling costs, etc. shall be allowed.

These net amounts will be adjusted as follows:

The net amount to be added to or deducted from the contract sum:A = $V(\underline{Z} - 1)$

Υ

A = the amount (R) of adjustment

V = the net amount (supplier's quotation) (R) of the imported itemY = exchange rate at the closing date of tender submission

Z = exchange rate on the date of payment.

Name of Tenderer	Signature	Date

VOLUME 3: THE CONTRACT PART A

Agreement and Contract

24

C1.2 CONTRACT DATA:

JBCC 2000 PRINCIPAL BUILDING AGREEMENT (Edition 6.2 of May 2018)

Project Name:	MP SWILE MAVOKWENI GAME FARM AND WILDLIFE
Reference no.:	EPIP-A170102698

Advertisement Date:	04 August 2023	Validity:	120
Closing Date:	30 August 2023	Closing time:	11:h00am

The Conditions of Contract are clauses 1 to 14 of the **JBCC** Series 2000 Principal Building Agreement (Edition 6.2 of May 2018) prepared by the Joint Building Contracts Committee.

Copies of these conditions of contract may be obtained through most regional offices of the Association of South African Quantity Surveyors, Master Builders Association, South African Association of Consulting Engineers, South African Institute of Architects, Association of Construction Project Managers, Building Industries Federation South Africa, South African Property Owners Association or Specialist Engineering Contractors Committee.

A PROJECT INFORMATION

A 1.0 Works [1.1]

	The project comprises the following main deliverables:	
Works Description:	 a) Construction of a New Accommodation facility, b) Construction of a New Administration facility, c) Construction of a New Guard house, d) Construction of New Water/Electrical Services and External works e) Construction of new boundary fence 	
	The description of the Works is not necessarily complete and shall not limit the work to be carried out by the Contractor under this Contract.	

A 2.0 Site [1.1]

Erf / Stand number:	R/E of farm Islington 219 KU
Town / Suburb:	Islington
Site Address:	R/E of farm, Islington
Local Authority:	Bushbuckridge Local Municipality

24

A 3.0 Employer [1.1]

Official Name of Organ of State / Public Sector Body	Department of Forestry, Fisheries, and the Environment
Postal address: Department of Forestry, Fisheries, and the Environment Private Bag X 447 Pretoria 0001	
Physical address:	Environmental House Ground Floor of the Department of Forestry, Fisheries and Environment 473 Steve Biko Road Arcadia, Pretoria 0083
Business registration number:	Government Department
Country:	South Africa
Employer's representative: Name	
E-mail:	
Mobile Number:	
Telephone number:	

A 4.0 Principal Agent [1.1]

Name (contact person)	
Company Name:	Department of Forestry, Fisheries & the Environment
Practice number:	
Telephone number:	012 399 9892
Mobile number	
Country:	South Africa
E-mail:	
Postal address:	Private Bag X 447, Pretoria, 0001
Physical address:	Environmental House, 473 Steve Biko Road, Arcadia, Pretoria, 0083

A 5.0 Principal Consultant [1.1, 6.2]

Name (contact person)	
Company Name:	
Practice number:	
Telephone number:	
Mobile number	
Country:	
E-mail:	
Postal address:	
Physical address:	

A 6.0 Agent [1.1, 6.2] [Quantity Surveying]

A 7.0 Agent [1.1, 6.2]	[Architect]	
Physical address:		
Postal address:		
E-mail:		
Country:		
Mobile number		
Telephone number:		
Practice number:		
Company Name:		
Name (contact person)		

Name (contact person)	
Company Name:	
Practice number:	
Telephone number:	
Mobile number	
Country:	
E-mail:	
Postal address:	
Physical address:	

A 8.0 Agent [1.1, 6.2] [Structural Engineer]

Name (contact person)	
Company Name:	
Practice number:	
Telephone number:	
Mobile number	
Country:	
E-mail:	
Postal address:	
Physical address:	

A 9.0 Agent [1.1, 6.2] [Civil Engineering]

Name (contact person)	
Company Name:	
Practice number:	
Telephone number:	
Mobile number	

Country:	
E-mail:	
Postal address:	
Physical address:	
A 10.0 Agent [1.1, 6.2]	[Structural Engineering]
Name (contact person)	
Company Name:	
Practice number:	
Telephone number:	
Mobile number	
Country:	
E-mail:	
Postal address:	
Physical address:	
A 11.0 Agent [1.1, 6.2] Name (contact person)	
Company Name:	
Practice number:	
Telephone number:	
Mobile number	
Country:	
E-mail:	
Postal address:	
Physical address:	
A 12.0 Agent [1.1, 6.2]	
Name (contact person)	
Company Name:	
Practice number:	
Telephone number:	
Mobile number	
Country:	
E-mail:	
Postal address:	
Physical address:	

A 13.0 Agent [1.1, 6.2]

Name (contact person)	
Company Name:	
Practice number:	
Telephone number:	
Mobile number	
Country:	
E-mail:	
Postal address:	
Physical address:	
A 14.0 Agent [1.1, 6.2]	I
Name (contact person)	
Company Name:	
Practice number:	
Telephone number:	
Mobile number	
Country:	/
E-mail:	/
Postal address:	
Physical address:	
A 15.0 Agent [1.1, 6.2]	
Name (contact person)	
Company Name:	
Practice number:	
Telephone number:	
Mobile number	
Country:	
E-mail:	
Postal address:	
Physical address:	
A 16.0 Agent [1.1, 6.2]	
Name (contact person)	
Company Name:	
Practice number:	
Telephone number:	
Mobile number	
Country:	
E-mail:	
Postal address:	
Physical address:	

A 17.0 Agent [1.1, 6.2]

Name (contact person)	
Company Name:	
Practice number:	
Telephone number:	
Mobile number	
Country:	
E-mail:	
Postal address:	
Physical address:	

A 18.0 Agent [1.1, 6.2]

, , , , , , , , , , , , , , , , , , ,	
Name (contact person)	
Company Name:	
Practice number:	
Telephone number:	
Mobile number	
Country:	
E-mail:	
Postal address:	
Physical address:	

B CONTRACT INFORMATION

B 1.0 Definitions [1.1]

Bills of quantities: System/Method of measurement

Seventh Edition 2015 of the Standard System of Measuring Builder's Work

B 2.0 Law, regulations, and notices [2.0]

Law applicable to the works, state country [2.1]

Republic of South Africa

B 3.0 Offer and acceptance [3.0]

Currency applicable to this agreement [3.2]

South African Rands

B 4.0 Documents [5.0]

The original signed **agreement** is to be held by the **principal agent** [5.2], if not, indicate by whom Number of copies of **construction information** issued to the **contractor** at no cost [5.6]

Employer (the Department)

2

Documents comprising the **agreement**The **JBCC**® Principal Building Agreement, Edition
6.2 May 2018

Page numbers 1 to 30

24

The **JBCC**® Principal Building Agreement - Contract

Data for Organs of State and other Public Sector 1 to 14

Bodies, Edition 6.2 May 2018

The JBCC® General Preliminaries for use with the

JBCC® Principal Building Agreement, Edition 6.2 1 to 7

May 2018

Bills of Quantities Refer to index

Additional documentation as stated in Procurement document

Contract drawings

Refer to drawings included in tender document annexures

B 5.0 Employer's agents [6.0]

Authority is delegated to the following agents to issue contrac of the works [6.2]	t instructions and perform duties for specific aspects
RodLam Consulting	

Principal agent's and agents' interest or involvement in the works other than a professional interest [6.3]			
N/A			

B 6.0 Insurances [10.0]

Insurances by employer		Amount including tax	Deductible including tax	amount
Contract works insurance:				
	New works [10.1.1]			
	(contract sum or amount)			
or	Works with practical completion in sections [10.2]			
	(contract sum or amount)			
or	Works with alterations and additions [10.3]			
	(reinstatement value of existing structures with or			
	including new works)			
	Direct contractors [10.1.1; 10.2] where applicable,			
	to be included in the contract works insurance			
	Free issue [10.1.1; 10.2] where applicable, to be			
	included in the contract works insurance			
	Escalation, professional fees and reinstatement costs			
	if not included above			
Tota	I of the above contract works insurance amount			
Supplementary insurance [10.1.2; 10.2]				
Public liability insurance [10.1.3; 10.2]				
Removal of lateral support insurance [10.1.4; 10.2]				
Other insurances [10.1.5]				

24

Yes / No	If yes, description 1	
Yes / No	If yes, description 2	

and/or

Insu	rances by c	contractor		Amount including	tax		Deductible including tax	amount
Cont	ract works in	surance:						
	New works [10.1.1]				Sum	+	To be paid in a	any event
	(contract s	sum or amount)		10%			by Contractor	•
or	Works with	practical comple	etion in sections [10.2]					
	(contract su	um or amount)						
or		alterations and ad						
			ting structures with or					
	including ne							
			10.2] where applicable,	n/a				
		led in the contract						
			here applicable, to be	n/a				
	included in the contract works insurance				/			
		•	and reinstatement costs	n/a				
	if not includ			/				
		the above contract works insurance amount						
		nsurance [10.1.2]		n/a				
Publ	ic liability ins	urance [10.1.3]		R 10 milli	on		To be paid in a by Contractor	
Rem	Removal of lateral support insurance [10.1.4]							
Othe	Other insurances [10.1.5] Refer B17.0							
Yes	Yes / No If yes, description 1							
		Yes	SASRIA					
Yes	/ No		If yes, description 2					

B 7.0 Obligation of the employer [12.1]

Existing premises will be in use and occupied [12.1.2]				
A portion of the buildings to be renove	ated may be	e occupied		
[12.1.2]	Yes/no?	No		
services to be preserved by the contractor [12.1.3]	Yes/no?	No		
eas that the contractor may not occupy [12.1.4]	Yes/no?	No		
סן	Yes/no?	No		
		A portion of the buildings to be renovated may be [12.1.2] Yes/no? Services to be preserved by the contractor [12.1.3] Yes/no? Pas that the contractor may not occupy [12.1.4] Yes/no?		

B 8.0 Nominated subcontractors [14.0]

Yes/No No	If yes, description of Specialisation
Specialisation 1	
Specialisation 2	
Specialisation 3	
Specialisation 4	
Specialisation 5	

B 9.0 Selected subcontractors [15.0]

Yes/No Y	⁄es	If yes, description of Specialisation	/
			_
Specialisation 1	1	To be confirmed by Contractor	
Specialisation 2	2		/
Specialisation 3	3		
Specialisation 4			/
Specialisation 5			/

B 10.0 Direct contractors [16.0]

Yes/No	No	If yes, description of extent of work
Extent of wor	k [12.1.11	
Extent of wor	k [12.1.11	
Extent of wor	k [12.1.11	
Extent of wor	k [12.1.11	
Extent of wor	k [12.1.11	

B 11.0 Description of sections [20.1]

Section 1	
Section 2	
Section 3	
Section 4	
Section 5	
Section 6	
Section	Remainder of the works

B 12.0 Possession of site [12.1.5], practical completion [19.0; 20.0] and penalty [24.0]

Practical completion for the works as a whole	Intended date of possession of the site Refer B17.0 [12.1.5; 12.2.22]	Period for inspection by the principal agent [19.3]	The date for practical completion shall be the period as indicated below from the date of possession of the	Penalty for late completion [24.1]
			possession of the site by the	
			contractor	

24

			[12.2.7; 24.1]	
	Date	working days	Date	Penalty amount per calendar day (excl. tax)
	TBC	TBC	TBC	R 0,025 per R100 of Contract Sum

or where sections are applicable

Practical completion for the works as a whole	Intended date of possession of the site Refer B17.0 [12.1.5; 12.2.22]	Period for inspection by the principal agent [19.3]	The date for practical completion shall be the period as indicated below from the date of possession of the site by the contractor [12.2.7; 24.1]	Penalty for late completion [24.1]
	Date	working days	Date	Penalty amount per calendar day (excl. tax)
			/	R
Section 1				
Section 2				
Section 3				
Section 4		/		
Section 5				
Section 6				
Section 7				
Section 8				
Remainder of the works		/		

Criteria to achieve practical comp	letion not covered in the definition of practical completion
N/A	
	/

Defects liability period [21.0]

Extended defects liability period: Refer B17.0 [21.13]			No
If yes, description of applicable elements	eg: Electrical reticulation / Air conditioning system / Landscapii 13.1 13.2 13.3 13.4 13.5 13.6	ng	

Payment [25.0]

Date of month for issue of regular payment certificates [25.2]	30 th of Month		
Contract price adjustment / Cost fluctuations [25.3.4; 26.9.5]	Yes/no?	No	
If yes, method to calculate		·	
Employer shall pay the contractor within: [25.10]	Twenty-one (21) calendar days		

Dispute resolution [30.0]

Adjudication [30.6.1; 30.10]	To be agreed between parties
Name of nominating body	μ
Applicable rules for adjudication [30.6.2]	As per Association of Arbitrators (SA)
Arbitration [30.7.4; 30.10]	Association of Arbitrators (SA)
name of nominating body	Association of Arbitrators (SA)
Applicable rules for arbitration [30.7.5]	As per Association of Arbitrators (SA)

JBCC® General Preliminaries – selections

Provisional bills of quantities [P2.2]		Yes/No	Yes	
Availability of construction information [P2.3]		Yes/No	Yes	
Previous work - dimensional accuracy - details of previous contract(s) [P3.1]		n/a		
Previous work - defects - details	of previous contract(s) [P3.2]	n/a		
Inspection of adjoining properties	- details [P3.3]	n/a	n/a	
Handover of site in stages - spec	ific requirements [P4.1]	n/a	/	
Enclosure of the works - specific	requirements [P4.2]	Yes	/	
Geotechnical and other investigat [P4.3]	ions - specific requirements	Yes		
Existing premises occupied - deta	nils [P4.5]	No		
Services - known - specific require	ements [P4.6]	Yes		
Water	By contractor	Yes/No	Yes	
[P8.1]	By employer	Yes/No	No	
	By employer – metered	Yes/No	No	
Electricity	By contractor	Yes/No	Yes	
[P8.2]	By employer	Yes/No	No	
	By employer – metered	Yes/No	No	
Ablution and welfare facilities	By contractor	Yes/No	Yes	
[P8.3]	By employer	Yes/No	No	
/				

Communication facilities - specific requirements [P8.4]	N/a
Protection of the works - s pecific requirements [P11.1]	Yes
Protection / isolation of existing works and works occupied in sections - specific requirements [P11.2]	N/a
Disturbance - specific requirements [P11.5]	Yes
Environmental disturbance - specific requirements [P11.6]	Yes

Changes made to JBCC® documentation

Reference may be made to other documents forming part of this agreement		
SHORTENED VEF	RSION OF THE PRELIMINARIES AS PER THE BoQ.	

C TENDERER'S SELECTIONS

Security [11/0]				
Guarantee for cons	struction: Select Option	A or B		
Option A Gua	on A Guarantee for construction (variable) by contractor [11.1.1]			
Option B Guarantee for construction (fixed) by contractor [11.1.2]				
Guarantee for pa	yment by employer [11.5	5.1; 11.10]	Not applicable	
Advance payment, [11.2.2; 11.3]	, subject to a guarantee f	or advance payment	Not applicable	
C 2.0 Contract	tor's annual holida	ay periods durin	g the construct	ion period
Year 1				
contractor's annual holiday period	start date		end date	
Year 2 contractor annual holiday period	's start date		end date	
Year 3 contractor annual holiday period	's start date		end date	
C 3.0 Paymen	t of preliminaries	[25.0]		
Contractor's sel	ection			
Select Option A	or B			
Where the cont	ractor does not selec	ct an option, Option	A shall apply	
Payment method	ls			
Option A The preliminaries shall be paid in accordance with an amount prorated to the value of the works executed in the same ratio as the amount of the preliminaries to the contract sum, which contract sum shall exclude the amount of preliminaries. Contingency sum(s) and any provision for cost fluctuations shall be excluded for the calculation of the aforesaid ratio			ies to the contract sum, ontingency sum(s) and any	
Option B			initial establishment charge, ent of the time-related	

Lump sum contract

TENDER NO: DFFE-T017(23-

24

Where the amount of **preliminaries** is not provided it shall be taken as 7.5% (seven and a half per cent) of the **contract sum**, excluding contingency sum(s) and any provision for cost fluctuations

C 4.0 Adjustment of preliminaries [26.9.4]

Contractor's selection
Select Option A or B
Where the contractor does not select an option, Option A shall apply

Provision of particulars

The **contractor** shall provide the particulars for the purpose of the adjustment of **preliminaries** in terms of his selection. Where completion in **sections** is required, the **contractor** shall provide an apportionment of **preliminaries** per **section**

Option A	An allocation of the preliminaries amounts into Fixed, Value-related and Time-related amounts as defined for adjustment method Option A below, within fifteen (15) working days of the date of acceptance of the tender
Option B	A detailed breakdown of the preliminaries amounts within fifteen (15) working days of possession of the site . Such breakdown shall include, inter alia, the administrative and supervisory staff, the use of construction equipment , establishment and disestablishment charges, insurances and guarantees, all in terms of the Programme

Adjustment methods

The amount of **preliminaries** shall be adjusted to take account of the effect which changes in time and/or value have on **preliminaries**. Such adjustment shall be based on the particulars provided by the **contractor** for this purpose in terms of Options A or B, shall preclude any further adjustment of the amount of **preliminaries** and shall apply notwithstanding the actual employment of resources by the **contractor** in the execution of the **works**

Option A	The preliminaries shall be adjusted in accordance with the allocation of preliminaries amounts provided by the contractor, apportioned to sections where completion in sections is required Fixed - An amount which shall not be varied Value-related - An amount varied in proportion to the contract value as compared to
	the contract sum . Both the contract sum and the contract value shall exclude the amount of preliminaries , contingency sum(s) and any provision for cost fluctuations Time-related - An amount varied in proportion to the number of calendar days extension to the date of practical completion to which the contractor is entitled with an adjustment of the contract value [23.2; 23.3] as compared to the number of calendar days in the initial construction period [26.9.4]

Option B	The adjustment of preliminaries shall be based on the number of calendar days	
	extension to the date of practical completion to which the contractor is entitled with	

an adjustment of the contract value [23.2; 23.3] as compared to the number of calendar days in the initial construction period [26.9.4]
The adjustment shall take into account the resources as set out in the detailed breakdown of the preliminaries for the period of construction during which the delay occurred

Failure to provide particulars within the period stated

Option A	Where the allocation of preliminaries amounts for Option A is not provided, the following allocation of preliminaries amounts shall apply:
	Fixed - Ten per cent (10%) Value-related - Fifteen per cent (15%) Time-related - Seventy-five per cent (75%)
	Where the apportionment of the preliminaries per section is not provided, the categorised amounts shall be prorated to the cost of each section within the contract sum as determined by the principal agent
Option B	Where the detailed breakdown of preliminaries amounts for Option B is not provided, Option A shall apply

Lump sum contract

Where the amount of **preliminaries** is not provided it shall be taken as 7.5% (seven and a half per cent) of the **contract sum**, excluding contingency sum(s) and any provision for cost fluctuations.

C1.4 HEALTH AND SAFETY AGREEMENTS

24



JBCC ===	For use with the JBCC® Principal B	uilding Agreement	edition /date		
GUARANTOR DETAILS					
Guarantor:					
Physical address:					
Guarantor's signatory 1:			Capacity		
Guarantor's signatory 2:			Capacity		
Employer:					
Contractor:					
Principal Agent:					
Works:					
Site:					
Name of Signatory:					
Contract Sum:	Accepted amount inclusive of tax	Currency			
amount in words:					
Guaranteed Sum:	The maximum aggregate amount	Currency			
amount in words:					
Guarantee for Construction	(insert variable or fixed)		Expiry date		
AGREEMENT DETAILS					
Sections	Total number / not applicable		Last section		
Principal Agent issues	'JBCC® format Interim Payment Completion and the Certificate of		al Payment Cert	ificate, the Certificate of Practical	
 1.0 GUARANTEE for CONSTRUCTION (Variable) 1,1 Where a Guarantee for Construction (Variable) in terms of the Agreement has been selected this clause 1.0 and 3.0 to 13.0 shall apply. The Guarantor's liability shall be limited to the diminishing amounts of the Guaranteed Sum as follows:- 					
GUARANTOR'S LIABILITY		PERIOD OF LIA	ABILITY		
1.1.1 Maximum Guaranteed Su contract sum) in the amour	im (not exceeding 10.0% of the nt of:	Construction and	d up to and inclu	of issue of this Guarantee for ding the date of issue of the interim excess of 50% of the contract sum	
Amount in words	:				
1.1.2 Reducing to the Guarantee contract sum) in the amour	ed Sum (not exceeding 6.0 % of the nt of:	payment certific only Certificate	ate and up to ar	er the date of the aforesaid interimed including the date of issue of the pletion or last Certificate of Practical ons	
Amount in words	:				

From and including the day after the date of the applicable Certificate of Practical Completion and up to and including the date of issue of

		the only Certificate of Final Completion or the last Certificate of Final Completion where there are sections
	Amount in words:	
_	to the Guaranteed Sum (not exceeding 2.0% of the um) in the amount of:	From and including the day after the date of the applicable Certificate of Final Completion and up to and including the date of issue of the Final Payment Certificate where payment is due to the Contractor whereafter this Guarantee for Construction shall expire. Where the Final Payment Certificate reflects payment due to the Employer this Guarantee for Construction shall expire upon payment of the full
	Amount in words:	amount certified
1,2 The Guara	antor's liability limits set out in 1.1.1 to 1.1.4 shall apply	y in respect of any claim received by the Guarantor during the Security
2.0 GUAR	ANTEE for CONSTRUCTION (Fixed)	
	Guarantee for Construction (Fixed) in terms of the Agr's liability shall be limited to the amount of the Guaran	reement has been selected this clause 2.0 and 3.0 to 13.0 shall apply. The nteed Sum as follows:-
GUARANTOR	'S LIABILITY	PERIOD OF LIABILITY
	Guaranteed Sum (not exceeding the contract sum) in the amount of:	From and including the date of issue of this Guarantee fo Construction and up to and including the date of the only Certificate of Practical Completion or the last Certificate of Practical Completion where there are sections, whereafter this Guarantee for Construction shall expire
	Amount in words:	
3.0 The Guara	antor acknowledges that:-	
3,1	Any reference in this Guarantee for Construction construed as any intention to create an accessory	to the Agreement is made for the purpose of convenience and shall not be obligation or any intention to create a suretyship
3,2	Its obligation under this Guarantee for Construction	on is restricted to the payment of money
3,3	Reference to a Recovery Statement or an Inter Completion shall mean such certificate issued by t	rim or Final Payment Certificate, or a Certificate(s) of Practical or Fina the Principal Agent
-	the Guarantor's maximum liability referred to in clau fied upon receipt of the documents identified in $4.1\mathrm{to}$	ises 1.0 or 2.0 , the Guarantor hereby undertakes to pay the Employer the 4.3:- $\frac{1}{2}$
4,1	the Principal Agent in an Interim or Final Payment	the Employer to the Contractor stating that payment of a sum certified by Certificate has not been made in terms of the Agreement and failing sucloyer intends to call upon the Guarantor to make payment in terms of 4.2
4,2	Contractor stating that a period of seven (7) cale	r to the Guarantor at the Guarantor's physical address with a copy to the ndar days has elapsed since the issue of the first written demand notice in been paid to date. The Employer herewith calls up this Guarantee fo ertified from the Guarantor
4,3	A copy of the applicable payment certificate which the sum certified in 4.0	h entitles the Employer to receive payment in terms of the Agreement of
or the ful		or 2.0, the Guarantor undertakes to pay the Employer the Guaranteed Sun demand notice from the Employer to the Guarantor at the Guarantor'ng that:-

The Agreement has been terminated due to the Contractor's default and that the Guarantee for Construction is called up in

A provisional sequestration or liquidation court order has been granted against the Contractor and that the Guarantee for

terms of 5.0. The demand notice shall enclose a copy of the notice of termination; or

Construction is called up in terms of 5.0. The demand notice shall enclose a copy of the court order

5,1

5,2

6.0	The aggregate amount of payment to be made by the Guarantor in terms of 4.0 and 5.0 shall not exceed the Guarantor's maximum liability in terms of 1.0 or 2.0				
7.0	(180) calendar days of receip Guarantee for Construction I refunded to the Guarantor in	gistered insurer and has made payment in terms of 5.0, the Er t of payment submit an expense account to the Guarantor sho ave been expended, or will be expended, and shall refund to the terms of this Guarantee for Construction shall bear interest a and calculated from the date of payment by the Guarantor to the	wing how ne Guaran at the prin	all monies received in terms of the tor any surplus amount. All monies ne overdraft rate of the Employer's	
8.0	Payment by the Guarantor in terms of 4.0 or 5.0 shall be made within seven (7) calendar days upon receipt of the first written demand notice to the Guarantor				
9.0	O The Employer shall have the absolute right to arrange his affairs with the Contractor in any manner which the Employer deems fit and the Guarantor shall not have the right to claim his release from this Guarantee for Construction on account of any conduct alleged to be prejudicial to the Guarantor				
10.0	The Guarantor chooses the p	nysical address-stated above for all transactions in relation to thi	is security		
11.0	11.0 This Guarantee for Construction is neither negotiable nor transferable and shall expire in terms of either 1.1.4 or 2.1, or on payment in full of the Guaranteed Sum or on the Guarantee expiry date, whichever is the earlier, where after no claims will be considered by the Guarantor. The original Guarantee for Construction form shall be returned to the Guarantor after it has expired				
12.0	This Guarantee for Construct purpose of obtaining a court	ion, with the required demand notices in terms of 4.0 or 5.0, slorder	hall be reg	arded as a liquid document for the	
13.0 Where this Guarantee for Construction is issued in the Republic of South Africa the Guarantor hereby consents to the jurisdiction of a court in the area where the project is located					
	Signed at		Date		
	Guarantor's Signatory 1	Guarantor's Signa	tory 2		
	Witness	w	itness _		
Guar	rantor's seal or stamp				
	JBCC® Guarantee for Construction PBA 6.2 © May 2018				



ANNEXURE D (OHS SPECIFICATION)

Table of Contents

1.	Definitions	3
2.	Responsibilities of the Department	6
3.	General Responsibilities of the Service Provider/ Contractor	7
4.	Responsibility of the Service Provider/ Contractor in relation to warranty of compliance	8
5.	Occupational Health and Safety Plan and File	g
6.	Overall supervision and responsibility for OHS	10
7.	Appointment of Responsible Persons by Service Provider/ Contractor	10
8.	Appointment of Health and Safety and COVID-19 Compliance Representative	11
9.	Appoint of first aiders	12
10.	Further (specific) supervision responsibilities for OHS	12
11.	Site rules and other restrictions	13
12.	Security and access	13
13.	Demarcation of work areas	15
14.	Appointments and training	15
15.	Supervision, discipline and reporting	16
16.	Access to the OHS-Act	16
17.	Co-operation	17
18.	Hazard identification and risk assessment and safe work operation standards and procedures	17
19.	Occupational Health and Safety meetings	17
20.	Communication and liaison	19
21.	Compensation and registration as outlined in the Expanded Public Works programme	Ministeria
dete	ermination	19
22.	Medical examinations and occupational health and hygiene	19
23.	Incident reporting and investigation	20
24.	Fire precautions and facilities	21
25	Hygiene and cleanliness	21

26.	Environment	21
27.	Personal protective equipment	23
28.	Transport, plant, machinery and equipment	25
29.	Emergency preparedness and response	27
30.	Arrangements for monitoring and review	28
31.	Clarification	29

RESPONSIBLITIES OF THE PARTIES IN RELATION TO COMPLIANCE WITH THE PROVISION OF THE OCCUPATIONAL HEALTH AND SAFETY ACT 1993 (ACT NO 85 OF 1993) ("OHS ACT") AND ALL RELEVANT REGULATIONS AS WELL AS THE OHS SPECIFICATIONS STIPULATED IN THIS ANNEXURE D.

1. **DEFINITIONS**

- 1.1 For the purposes of this Annexure D the following definitions will apply:
- 1.1.1 "Agreement" means the main Agreement entered into by the Parties for the Project for which this Annexure D is appended to;
- 1.1.2 "Competent Person" means a person who
 - 1.1.2.1 has in respect of the work or task to be performed the required knowledge, training and experience and, where applicable, qualifications, specific to that work or task: Provided that where appropriate qualifications and training are registered in terms of the provisions of the National Qualification Framework Act, 2008 (Act No.67 of 2008), those qualifications and that training must be regarded as the required qualifications and training; and
 - 1.1.2.2 is familiar with the OHS Act and with the applicable Regulations;
- 1.1.3 "Contractor/Sub Contractor" has the same meaning as defined in the Agreement;
- 1.1.4 "Construction Work" means any work in connection with the-
 - 1.1.2.1 construction, erection, maintenance, alteration, renovation, repair, demolition or dismantling of or addition to a building or any similar structure;
 - 1.1.2.2 construction, installation, erection, dismantling or maintenance of a fixed plant where such work includes the risk of a person falling;
 - 1.1.2.3 construction, maintenance, demolition or dismantling of any bridge, dam, canal, road, railway, runway, sewer or water reticulation system or any similar civil engineering structure; or
 - 1.1.2.4 moving of earth, clearing of land, the making of an excavation, piling, or any similar civil engineering or type of work;
- 1.1.5 "COVID 19" means the Novel Coronavirus (COVID 19) which is an infectious disease caused by a virus, which emerged during 2019 and was declared a global

- pandemic by the World Health Organization during the year 2020 that has previously not been scientifically identified in humans;
- 1.1.6 "COVID 19 Response Team" means a team of COVID 19 Compliance Representatives consisting of Service Provider(s)/Contractor(s), site supervisor(s), and Employees/ Participants representative(s);
- 1.1.7 **"COVID 19 Compliance Representatives"** means a person responsible to perform duties as stipulated in the COVID 19 Compliance Representatives appointment letter;
- 1.1.8 "Department" means the Department of Forestry, Fisheries and the Environment;
- 1.1.9 "Employees/Participants" means all Employees, servants, Mandatary / Principle Contractor/ Contractors, agents, invitees and the like of the Service Provider/ Contractor;
- 1.1.10 "ENATIS" means Electronic National Administration Traffic Information Systems;
- 1.1.11 "Fall Arrest Equipment" means equipment used to arrest a person in a fall, including personal equipment, a body harness, lanyards, deceleration devices, lifelines or similar equipment;
- 1.1.12 "Fall Prevention Equipment" means equipment used to prevent persons from falling from a fall risk position, including personal equipment, a body harness, lanyards, lifelines or physical equipment such as guardrails, screens, barricades, anchorages or similar equipment;
- 1.1.13 "Fall Protection Plan" means a documented plan, which includes and provides for
 - 1.1.13.1 all risks relating to working from a fall risk position, considering the nature of work undertaken;
 - 1.1.13.2 the procedures and methods to be applied in order to eliminate the risk of falling; and
 - 1.1.13.3 a rescue plan and procedures;
- 1.1.14 "Health and Safety Representative/ H & S Representative" means a person designated in terms of section 17 (1) of the Occupational Health and Safety Act, 1993 (Act No. 85 of 1993);
- 1.1.15 "Occupational Health and Safety Committee" means a committee established under section 19, of the Occupational Health and Safety Act, 1993 (Act No. 85 of 1993);

- 1.1.16 "OHS Act" means the Occupational Health and Safety Act, 1993 (Act No.85 of 1993);
- 1.1.17 "Occupational Health and Safety File" means a file, or other record in permanent form, containing the information required as contemplated in the Construction Regulations 2014 Government Gazette Notice No 40883 of 2 June 2017) ("the Construction Regulations"). A Occupational Health and Safety file is to be a document that consists of various other documents (as per attached Annexure F) that resembles the entire health and safety history of the contract, from start to finish;
- 1.1.18 "Occupational Health and Safety Plan/ OHS Plan" means a Site, activity or project specific documented plan in accordance with the Department's Occupational Health and Safety specifications;
- 1.1.19 "Occupational Health and Safety Specification/ OHS Specification" means this Annexure D which is a documented specification of all health and safety requirements pertaining to the associated Works on a Site, so as to ensure the health and safety of persons;
- 1.1.20 "Risk Assessment" means a program to determine any risk associated with any hazard at a Site/ Premises, in order to identify the steps needed to be taken to remove, reduce or control such hazard:
- 1.1.21 "Responsible Person" means the Employee, or contractor appointed by the Service Provider/ Contractor and who performs the duties on behalf of the Service Provider/ Contractor;
- 1.1.22 "Medical Surveillance" means a planned programme or periodic examination (which may include clinical examinations, biological monitoring or medical tests) of employees by an occupational health practitioner or, in prescribed cases, by an occupational medicine practitioner;
- 1.1.23 "Occupational Health Practitioner" means an occupational medicine practitioner or a person who holds a qualification in occupational health recognized as such by the South African Medical and Dental Council as referred to in the Medical, Dental and Supplementary Health Service Professions Act, 1974 (Act No. 56 of 1974), or the South African Nursing Council as referred to in the Nursing Act, 2005 (Act No. 33 of 2005);
- 1.1.24 "Personal Protective Equipment (PPE)" means equipment or clothing that must be provided to protect and minimise the risk of injury to the health and safety of all persons entering the workplace for example helmets, goggles, gloves, work boots, life jackets, etc.

- 1.1.25 "Premises" means all such Premises as identified by the Department, where the Service Provider/ Contractor and its Employees/ Participants perform Work or render a service for and on behalf of the Department;
- 1.1.26 "Site/s" means any location where the Service Provider/ Contractor and its Employees / Participants perform Work or render a service for and have equipment or infrastructure installed, on behalf of the Department;
- 1.1.27 "SHEQ Procedures and Standards" means the Procedures and Standards contained in Branch: Environmental Programme's Occupational Health and Safety (OHS) Master File as well as other Standard Operating Procedures (SOP), Quality and Technical Standards applicable to the work, which the Service Provider is obliged to follow when performing work on behalf of the Department.
- 1.1.28 "Service Provider/ Contractor" means the Service Provider/ Contractor as defined in the Agreement; and
- 1.1.29 "Works / Scope of Work" mean the Project as described in the Agreement.

2. RESPONSIBILITIES OF THE DEPARTMENT

- 2.1. The Department shall discuss and negotiate with the Service Provider/Contractor the contents of the Occupational Health and Safety (OHS) Plan.
 - 2.1.1. The Department will take reasonable steps to ensure that the OHS Plan of the Service Provider/ Contractor is implemented and maintained. The steps taken will include periodic audits at intervals agreed between the Department and the Service Provider/ Contractor.
- 2.2. The Department will prevent the Service Provider/Contractor and/its sub-contractor from commencing or continuing with Construction Work/Works should the Service Provider/ Contractor or its sub-contractor at any stage in the execution of the Works be found to have:
 - 2.2.1. failed to comply with any of the administrative measures required by the OHS Act and its Regulations in preparation for the Construction Works or any physical preparations necessary in terms of the OHS Act;
 - 2.2.2. failed to implement or maintain their OHS Plan;
 - 2.2.3. executed Construction Work/Works which is not in accordance with their OHS Plan; or

2.2.4. acted in any way which may pose a threat to the health and safety of any person(s) present on the Premises or Site or in its vicinity, irrespective of him/them being employed or legitimately on the Premises or Site or in its vicinity.

3. GENERAL RESPONSIBILITY OF THE SERVICE PROVIDER/ CONTRACTOR

The Service Provider/ Contractor shall:

- 3.1 notify the Department of Labour of the intended construction Work in terms of the requirements outlined in Regulation 3 of the Construction Regulations, which contains the "Notification of Construction Work" form attached to these Regulations as **Annexure A**. The Service Provider/ Contractor shall submit the notification in writing prior to commencement of Work and inform the Department accordingly. A copy of this notification shall be provided to the Department before construction commences;
- 3.2 ensure that he/she is fully conversant with the requirements of this Occupational Health and Safety (OHS) Specification ("the Specification") and all relevant health and safety legislation. This Specification is not intended to supersede the OHS Act nor the Regulations or any part of either. Those sections of the OHS Act and the Regulations or any other Regulation which apply to the Scope of Work to be performed by the Service Provider/ Contractor in terms of the Agreement will continue to be legally required of the Service Provider/ Contractor to comply with. The Service Provider/ Contractor will in no manner or means be absolved from the responsibility to comply with all applicable provisions of the OHS Act, or any Regulations under the OHS Act or any legislation which may perceivable be applicable to this Agreement;
- 3.3 provide proof of registration and "Good Standing" with the Compensation Fund or with a licensed compensation insurer prior to commencement with the Works;
- 3.4 consistently, for the duration of the Agreement demonstrate through the development, submission to the Department for approval (prior to commencement of construction Work/Works) and implementation of an OHS Plan, in terms of clause 5 below, its competence and the adequacy of its resources to perform the duties imposed on it in terms of this Specification, the OHS Act and the Regulations;
- 3.5 ensure that an Occupational Health and Safety (OHS) File, in terms of clause 5 below, is opened and kept on Site and made available to the Department or Inspector from the Department of Labour upon request;
- 3.6 ensure that all conditions imposed on its sub-contractors in terms of the OHS Act and the applicable Regulations are complied with as if they were the Service Provider/ Contractor; and

3.7 from time to time evaluate the relevance of the OHS Plan and revise this Plan as required, following which revised OHS Plan shall be submitted to the Department for approval.

4. RESPONSIBILITY OF THE SERVICE PROVIDER/ CONTRACTOR IN RELATION TO WARRANTY OF COMPLIANCE

- 4.1 The Service Provider/Contractor warrants that it has familiarized itself with the working environment and that it agrees to the arrangements of this Annexure D and the OHS Plan and Master OHS File Specifications.
- 4.2 The Service Provider/Contractor acknowledges that this OHS Specifications constitutes an agreement in terms of section 37(2) of the OHS Act, whereby all responsibility for health and safety matters relating to the Work that are to be performed on the Premises and/or Site shall be the obligation of the Service Provider/ Contractor.
- 4.3 The Service Provider/Contractor undertakes to maintain all necessary compliance with the OHS Act and its Regulations. Without derogating from the generality of the above, nor from the provisions of the Agreement, the Service Provider/Contractor shall ensure that the clauses as hereunder described are at all times adhered to by itself and its Employees/Participants/ sub-contractors.
- 4.4 The Service Provider/Contractor hereby undertakes to ensure that the health and safety of any other person on the Premises and/or Site is not endangered by the conduct and/or activities of its Employees/Participants/ sub-contractors whilst they are on the Premises and/or Site.
- 4.5 Notwithstanding the above, the Service Provider/Contractor confirms that it is familiar with and will comply with the Department's Safety, Health, Environmental and Quality (SHEQ) Procedures and Standards.
- 4.6 The Work undertaken in terms of the Agreement by the Service Provider/Contractor will be carried out in conformity with all the relevant OHS Specifications, contained in this Annexure D and in strict compliance with:
 - 4.6.1 all and/or any current OHS related legislation and any Regulations which may be promulgated under any such Act;
 - 4.6.2 all and/or any existing or new OHS Municipal or Local or Statutory Authority laws, By-laws, regulations and or Notices and Proclamations;
 - 4.6.3 all and/or any current OHS requirements of, or directives received from, any Governmental departments or bodies or Statutory Authorities charged with the administration and/or enforcement of any Acts of Parliament, Municipal or Local

- or Statutory Authority's Law, Bye Laws regulations and/or Notices and Proclamations:
- 4.6.4 the Occupational Health and Safety Act, 1993 (Act No: 85 of 1993) and its Regulations;
- 4.6.5 the Compensation for Occupational Injuries and Diseases Act, 1993 (Act No: 130 of 1993); and
- 4.6.6 any other relevant legislation (such as the COVID 19 related regulations) and additional Departmental SHEQ Procedures and Standards requirements not contained within the Agreement.

5. OCCUPATIONAL HEALTH AND SAFETY PLAN AND FILE

- 5.1 The Service Provider/Contractor must, in terms of the Construction Regulation 5(1) and the Department's SHEQ Procedures and Standards provide and demonstrate to the Department a suitable, sufficiently documented and coherent Site specific OHS Plan, attached as Annexure E to the Agreement, based on the Department's documented OHS Specifications contemplated in Construction Regulation 4(1) (a), which plan must be applied from the date of commencement of and for the duration of the construction Work/Work and which must be reviewed and updated by the principal contractor as Work progresses.
- 5.2 The Service Provider/Contractor must, in terms of Regulation 5(7) of the Construction Regulations keep an OHS File on Site at all times that must include all documentation required in terms of this Annexure D, the OHS Act, the Regulations and must also include a list of all contractors/ sub-contractors on Site that are accountable to it and the agreements between the Service Provider/Contractor and its sub-contractors and details of work being done. The OHS File for the Site must be prepared/ compiled from the date of commencement of and for the duration of execution of the Works. A more detailed list of documents and other legal requirements that must be kept in the OHS File is attached as Annexure F to the Agreement.
- 5.3 The OHS Plan must be submitted by the Service Provider/Contractor to the Department's Project Manager for approval prior to the commencement of Construction Work/Works.
- 5.4 The OHS File will remain the property of the Department throughout the Agreement period and shall be consolidated and handed over to the Department by the Service Provider/ Contractor at the completion of the Construction Work/ Works as is required in terms of Regulation 5 (8) of the Construction Regulations.

6. OVERALL SUPERVISION AND RESPONSIBILITY FOR OHS

- 6.1 The Department must ensure that the Service Provider/Contractor, appointed in terms of Regulation 4(1) (c) of the Construction Regulations, implements and maintains the agreed and approved OHS Plan. Failure on the part of the Department to comply with this requirement will not absolve the Service Provider/Contractor from any one or more of its duties under the OHS Act and the Regulations.
- 6.2 The Chief Executive Officer of the Service Provider/ Contractor shall, as required in terms of section 16 (1) of the OHS Act, ensure that their Employer (as defined in the Act) (or the Service Provider/Contractor) complies with the OHS Act and that the duties of the Service Provider/ Contractor are properly discharged.

7. APPOINTMENT OF RESPONSIBLE PERSON BY SERVICE PROVIDER/ CONTRACTOR

- 7.1 The Service Provider/Contractor shall ensure that all appointments of Responsible Persons are done in accordance with the Departments' SHEQ Procedures (Roles and Responsibilities), the OHS Act and the Regulations.
- 7.2 All appointed Responsible Persons must be competent to perform the work they are appointed for.
- 7.3 The Responsible Person shall at all times have his written appointment as well as a copy of these Specifications close at hand whilst on the Site/Premises and shall be fully familiar with the requirements thereof.
- 7.4 The Service Provider/Contractor will allow the Department to examine the appointment letter of the Responsible Person during Site inspections.
- 7.5 Prior to the commencement of any Work on the identified Site, the Responsible Person, shall conduct Site inspections in order to define hazardous areas, safety precautions, standards and procedures and equipment and emergency procedures. This must be documented in an OHS Plan.
- 7.6 The Service Provider/ Contractor will allow the Department to assess the OHS Plan and to test the knowledge of the Service Provider/ Contractor including that of the Responsible Persons, regarding these Specifications during Site inspections. Where required, the Department may request retraining or refresher training before the Works can commence.

8. APPOINTMENT OF HEALTH AND SAFETY AND COVID - 19 COMPLIANCE REPRESENTATIVE/S

- 8.1 The Service Provider/Contractor shall ensure that 1 (one) Health and Safety (H&S) Representative is nominated, trained and appointed in writing, per contract team, in terms of section 17 of the OHS Act. An additional H&S Representative shall be trained as a substitute.
- 8.2 The H&S Representative/s have to be designated in writing and the designation shall be in accordance with Department's SHEQ Procedures and Standards (H&S Representatives), and in terms of Regulation 6 of the General Administration Regulations 2003, issued under Government Gazette Notice No R929 of 25 June 2003.
- 8.3 The H&S Representative/s shall be entitled to perform duties as stipulated in section 18 of the OHS Act as well as the Department's SHEQ Procedures and Standards (H&S Representatives).
- 8.4 The designated H&S Representative/s shall conduct daily/weekly inspection of their respective areas of responsibility using a checklist and report thereon to the Service Provider/ Contractor, after which these reports shall be consolidated for submission to the relevant OHS Committee.
- 8.5 H&S Representative/s must be included in and be part of accident/incident investigations.
- 8.6 H&S Representative/s shall be members of at least 1 (one) OHS Committee and must attend all meetings of that OHS committee.
- 8.7 The Service Provider/ Contractor, with the assistance of the Department's Project Manager and Senior OHS officers, must facilitate the establishment of a COVID – 19 Compliance Officers for COVID – 19 responses.
- 8.8 The Service Provider/Contractor, with the assistance of the Department's Project Manager and Senior OHS officers, must facilitate the establishment of a COVID – 19 Compliance Team for COVID – 19 responses.
- 8.9 The team with COVID 19 Compliance Representatives should consist of different stakeholders including the Service Provider(s)/ Contractor(s), site supervisor(s), and Employees/ Participants, OHS representative(s) with at least 1 (one) female representative and/or a representative with a disability, if possible.
- 8.10 Each COVID 19 Compliance Officer and Representatives shall share and undertake the responsibilities outlined in their appointment letter as well as the Department's SHEQ Procedures and Standards (COVID 19).

8.11 The selected COVID – 19 Compliance Officers and Representative/s shall be members of at least 1 (one) OHS Committee and must attend all meetings of that OHS committee.

9. APPOINTMENT OF FIRST AIDER/S

- 9.1 The Service Provider/Contractor shall ensure that 1 (one) First Aider is nominated, trained and appointed in writing, per contract team. At least one additional First Aider shall be trained as a substitute, per contract team. First Aiders must be in possession of a valid First Aid certificate of competency and be readily available to render the necessary assistance on Site in case of an injury. A copy of this certificate must be provided to the Department at the commencement of the Agreement.
- 9.2 The First Aider shall be entitled to perform duties as stipulated in Department's SHEQ Procedures and Standards (First Aid).
- 9.3 A notice bearing, the address and telephone numbers of all emergency services including the South African Police Service, Emergency Medical Services, Fire Department and the nearest Hospital must be displayed on the Premises and it must be in English and one other language predominantly spoken by the Employees/ Participants.
- 9.4 The Service Provider/Contractor shall ensure that:
 - 9.4.1 An adequately equipped First Aid Kit shall be easily accessible at all Site/Premises;
 - 9.4.2 The First Aid Kit shall be kept fully stocked according to the stock list;
 - 9.4.3 All first aid treatment and usage of stock shall be recorded in the dressing book kept on Site and;
 - 9.4.4 The First Aid Kit shall be under the control of a trained and competent First Aider.

10. FURTHER (SPECIFIC) SUPERVISION RESPONSIBILITIES FOR OHS

Several appointments or designations of Responsible Person and competent person in specific areas of Construction Work/ Works are required by the OHS Act and the Regulations. It will be the responsibility of the Service Provider/ Contractor to ensure that all appointments comply with the OHS Act and its Regulations.

11. SITE RULES AND OTHER RESTRICTIONS

11.1 Site OHS Rules

- 11.1.1 The Service Provider/Contractor must develop a set of Site-specific OHS rules that will be applied to regulate the OHS Plan and associated aspects of the Construction Work and COVID 19 OHS requirements.
- 11.1.2 Access by third parties to Sites/Premises, as well as physical social distance between Employees/ Participants should be strictly monitored by the COVID - 19 Compliance Representatives, in order to avoid the risks of contagion.

11.2 Substance Abuse

- 11.2.1 The use of any narcotic substances is prohibited on Site.
- 11.2.2 The Service Provider/Contractors shall ensure that Employees/Participants do not perform their duties under the influence of any narcotic or alcoholic substances.
- 11.2.3 Employees/Participants who are under the influence during work hours shall be dealt with in terms of the appropriate disciplinary procedures.
- 11.2.4 Alcohol testing, where applicable, may only be done using single use test units and must be disposed of in the appropriate contaminated waste bag provided on Site.

11.3 **Security Arrangements**

- 11.3.1 The Service Provider/Contractor must establish Site access rules and implement and maintain these throughout the operational period. Access control must include the rule that non-employees shall at all times be provided with fulltime supervision while on Site.
- 11.3.2 The Service Provider/Contractor must develop a set of Security rules and procedures for the Site and maintain these throughout the operational period.

12. SECURITY AND ACCESS

12.1 The Service Provider/Contractor and its Employees/ Participants and sub-contractors shall only access and exit the Premises and/or Sites of Private Land Owners through the main gate(s) (where applicable) designated by the Department.

- 12.2 The Service Provider/Contractor shall ensure that the Employees/Participants observe the security rules of the Department at all time and shall not permit any person who is not directly associated with the Works to enter the Premises and/or Site.
- 12.3 The Service Provider and the Employees/Participants shall not enter into any area of the Premises and/or Site, which is not directly associated with the Works.
- 12.4 When required for a site by law, visitors and non-employees upon entering the site shall be recorded on an attendance register, be screened for COVID -19 symptoms through the completion of an "self-assessment questionnaire", hands and personal belongings sanitized and be issued with the required Personal Protective Equipment (PPE) as and when necessary.
- 12.5 The Service Provider/Contractor shall ensure that all materials, machinery or equipment brought by it onto the Premises and/or Site are registered at the main gate(s) (where applicable). A failure to do this may result in a refusal by the Landowner to allow the materials, machinery or equipment to be removed from the Premises and/or Site.
- 12.6 The Service Provider/Contractor shall submit to the Department, for approval, all the names of each proposed Employee/Participant prior to such Employee/Participant entering the Premises and/or Site.
- 12.7 The Department may refuse access to a Premises and/or Site by any one of the Service Provider/Contractor's Employees/Participants who has proven by his/her action to have a disregard for any of the relevant OHS requirements. Such refusal of access to the Premises by the Department shall not result in any claims on the Department by the Service Provider/Contractor.
- 12.8 The actions on the Service Provider/Contractor's Employees/ Participants referred to in paragraph 12.7 above includes but are not limited to:
 - 12.8.1 Possession of illegal drugs, liquor or other intoxicating substances on the Premises;
 - 12.8.2 Intoxication, and/or consumption of an intoxicating substance;
 - 12.8.3 Unauthorised possession of Department's property;
 - 12.8.4 Fighting/assault;
 - 12.8.5 Possession of dangerous weapon; and/ or
 - 12.8.6 Violation of health and safety rules.
- 12.9 Where an Employee/Participant show symptoms of possible COVID 19 infection when reporting for duty or whist performing duties, the protocols set out in the Department's SHEQ Procedures and Standards (COVID 19) must be followed.

12.10 Any person required to take medication shall notify the relevant Responsible Person thereof, as well as the potential side effects of the medication.

13. DEMARCATION OF WORK AREAS

- 13.1 Work areas that pose a potential danger to people must be visibly or structurally cordoned off with neat barriers, fencing or purpose made hazard tape or rope. The method used must be suitable and in direct proportion for the purpose, e.g. physical barriers or fences must be used to prevent people from falling into holes.
- 13.2 Clearly visible Safety Signs shall be installed by the Service Provider/ Contractor to alert third parties entering the Work area of any dangers / hazards that exists in such a Work area. These signs shall comply with the South African National Safety Standards and shall be appropriate for the type of Work performed in the Work area.

14. APPOINTMENTS AND TRAINING

- 14.1 The Service Provider/Contractor shall appoint competent persons as envisaged in section 16(2) of the OHS Act. These appointees must be trained on all OHS matters, and the OHS Act provisions that apply to the Work that is to be performed under their responsibility. Copies of any appointments made by the Service Provider/ Contractor in terms of section 16(2) of the OHS Act shall be made available to the Department upon its request.
- 14.2 The Service Provider/Contractor shall ensure that he has familiarized himself with the hazards associated with the Work being carried out on the Premises and/or Sites. The Service Provider/ Contractor shall further ensure that the Employees/Participants are trained on the health and safety aspects relating to the Work and that they understand the hazards associated with such Work being carried out on the Premises and/or Sites. Without derogating from the afore-going, the Service Provider/Contractor shall, in particular, ensure that all its users or operators of any materials, machinery or equipment are properly trained in the use of such materials, machinery or equipment.
- 14.3 The Service Provider/Contractor shall avail its Employees/Participants to training programmes offered by the Department for occupational competency and personal development purposes as and when required by the Department.
- 14.4 Notwithstanding the provisions of the above, the Service Provider/Contractor shall ensure that he, his appointed Responsible Persons and Employees/Participants are at all times familiar with the provisions of the OHS Act, this Specifications as well as the Department's SHEQ Procedures (Training, Competency and Awareness) and that they comply with the provisions thereof.

- 14.5 The contents and syllabi of all training required by the OHS Act and the Regulations including any other related or relevant training as required by the Department's SHEQ Procedures (Training, Competency and Awareness) must be included in the Service Provider/ Contractor's OHS Plan and OHS File.
- 14.6 All Employees/Participants of the Service Provider/ Contractor must be in possession of proof of General Induction training and Site Specific OHS Induction or other qualifying training.
- 14.7 All operators, drivers and users of vehicles, mobile plants and other equipment must be in possession of valid proof of training to operate such vehicles, mobile plants and other equipment.
- 14.8 All Employees/Participants in jobs requiring training in terms of the OHS Act and the Regulations and the Department's SHEQ Procedures (Training, Competency and Awareness) must be in possession of valid proof of training.

15. SUPERVISION, DISCIPLINE AND REPORTING

- 15.1 The Service Provider/Contractor shall ensure that, where applicable, all Work performed on the Premises and/or Sites is done under strict supervision, and that no unsafe or unhealthy Work practices are permitted. Discipline regarding non-compliance with health and safety matters shall be strictly enforced by the Service Provider/Contractor against any of its Employees/Participants.
- 15.2 The Service Provider/Contractor shall further ensure that the Employees/Participants report all unsafe or unhealthy Work situations immediately after they become aware of it, and that the Service Provider/ Contractor shall in turn report these in writing, to the Department in terms of the Department's SHEQ Procedures and Standards (Incident investigation and Non Compliance)

16. ACCESS TO THE OHS ACT

The Service Provider/Contractor shall have an updated copy of the OHS Act available in the OHS File which is accessible to its appointed Responsible Persons and Employees/Participants. The Parties may make arrangements for the Service Provider/Contractor and its Responsible Persons to have access to the Department's copies of the OHS Act.

17. CO-OPERATION

The Service Provider/Contractor and/or its Responsible Persons and Employees/Participants shall provide full co-operation and information if and when the Department or its representative enquire into OHS issues concerning the Service Provider/ Contractor. The Department and its representative shall at all times be entitled to make such enquiry.

18. HAZARD IDENTIFICATION AND RISK ASSESSMENT AND SAFE WORK OPERATION STANDARDS AND PROCEDURES

- 18.1 The Service Provider/Contractor shall ensure that a Hazard identification and Risk assessment (HIRA) is carried out on the Site where Work is to be performed. HIRA, Safe work operating standards and procedures must be developed in accordance with the Departments' SHEQ Procedures (HIRA) and be in place to address these risk.
- 18.2 The Service Provider/Contractor must, as a minimum requirement, have regard to and apply any applicable operational standards and procedures, guidelines and other documentation used by the Department as a basis for prescribing the HIRA and Safe work operating standards, procedures and practices for the Employees/Participants. The Service Provider/ Contractor, shall at all times, be responsible for ensuring compliance with the OHS Act, including ensuring that it has adequate HIRA and safe work operating standards and procedures in place. The Service Provider/ Contractor shall ensure that the Employees/Participants are made conversant and comply with the requirements of the HIRA and Safe work operating standards, procedures and practices.

19. OCCUPATIONAL HEALTH AND SAFETY MEETINGS

- 19.1 The Service Provider/Contractor shall establish its own OHS committee/s as contemplated in terms of section 19 of the OHS Act. The OHS Committees shall conduct its duties in accordance with the requirements under the OHS Act and the Department's SHEQ Procedures and Standards (OHS Committee).
- 19.2 The Service Provider/Contractor's OHS Committees shall consist of the designated H&S Representatives and COVID 19 Compliance Representatives together with a number of Department's Representatives appointed in terms of section 19(3) of the OHS Act. Provided that the Department's Representatives shall not exceed the number of the Service Provider/ Contractor's H&S Representatives on the committee. The persons nominated on an OHS Committee must be designated in writing for such period as may be determined by the Service Provider/ Contractor.
- 19.3 The OHS Committee may co-opt advisory (temporary) members and determine the procedures of the meetings including the chairmanship;

- 19.4 The Service Provider/Contractor shall have a representative on the Regional OHS Committee of the Department.
- 19.5 The OHS Committee must meet minimum monthly and consider, at least, the following Agenda for the meeting.

Agenda:

- 1. Opening and determining of chairmanship (only when necessary)
- 2. Minutes of Previous Minutes
- 3. Observations
- 4. Program and Safety considerations
- 5. Hygiene
- 6. Housekeeping improvement
- 7. Incidents & Accidents / Injuries
- 8. Registers:
 - 8.1 H&S Representatives. Inspections
 - 8.2 Matters of First Aid
 - 8.3 Registers for Cleaning and Disinfecting
 - 8.4 Scaffolding
 - 8.5 Ladders
 - 8.6 Excavations
 - 8.7 Portable Electric Equipment
 - 8.8 Fire Equipment
 - 8.9 Explosive Power Tools
 - 8.10 Power Hand tools
 - 8.11 Incident Report Investigation
 - 8.12 Pressure Vessels
 - 8.13 Personal Protective Equipment
- 9. Safety performance Evaluations
- 10. Education & Safety promotion program
- 11. First Aid Officials and training in First Aid
- 12. Demarcation of work- /hazardous-/safe areas/walkways
- 13. Posters and signage
- 14. Environmental preservation and conservation
- 15. Specific training programmes
- 16. Operational Standards and Procedures with specific reference to COVID 19 compliance implementation and monitoring
- 17. General
- 18. Date of Next Meeting
- 19. Closing

20. COMMUNICATION AND LIAISON

- 20.1 OHS liaison between the Department and the Service Provider/ Contractor, and other concerned parties shall be through the Department's OHS Committee as per the procedures determined by the OHS Committee.
- 20.2 In addition to the requirements under paragraph 20.1 above, communication regarding OHS matters between the Parties may be made, verbally (followed by written confirmation through an email) or in writing, as and when the need arises.
- 20.3 Consultation with the Employees/Participants on OHS matters will be through Supervisors, COVID 19 Representatives and H&S Representatives.
- 20.4 The Service Provider/Contractor will be responsible for the dissemination of all relevant OHS information in accordance with the Department's SHEQ Procedure (Participation and Consultation) to the other contractors e.g. design changes agreed with the Department on its behalf and the Designer, instructions by the Department exchange of information between Contractors, the reporting of hazardous/dangerous conditions/situations etc.

21. COMPENSATION AND REGISTRATION AS OUTLINED IN THE EXPANDED PUBLIC WORKS PROGRAMME (EPWP) MINISTERIAL DETERMINATION

- 21.1 It is the responsibility of the Service Provider/Contractor to arrange for all participants to be covered in terms of the Compensation for Occupational Injuries and Diseases Act,1993 (Act No 130 of 1993) (COID Act).
- 21.2 The Service Provider/Contractor must report any work-related injury or occupational disease to the Department in terms of the Department's Investigation Procedure.
- 21.3 The Service Provider/Contractor must report accidents or diseases to the Compensation Fund. Submission of all forms shall be made in compliance with the COID Act.

22. MEDICAL EXAMINATIONS AND OCCUPATIONAL HEALTH AND HYGIENE

22.1 The Service Provider/Contractor shall ensure that all the Employees/Participants undergo a Medical Surveillance Program as prescribed in the OHS Act and its Regulations and the Departmental SHEQ Procedures and Standards (Medical Surveillance), where their working environment necessitates this and also to ensure that Employees/Participants are medically fit for the purposes of the work they are to perform.

- 22.2 Prior to employment, all Participants shall undergo a medical examination performed by a registered Occupational Health Practitioner. Whenever possible, team members that resign need to undergo an exit medical examination and the results must be kept on record by the Service Provider/Contractor.
- 22.3 The Service Provider/Contractor shall be responsible for the medical welfare of its own and sub-Mandatary/sub Contractor personnel and shall provide health certificates of Employees/Participants to the Department when so requested.
- 22.4 The Service Provider/Contractor shall adhere to all applicable Regulations or the Department's guidelines for medical surveillance, COVID 19 testing and medical screening and operational hygiene monitoring.
- 22.5 If separate accommodation for Mandatary/Principle Contractor/Contractor personnel is provided (e.g. tents for camping), the Mandatary/Principle Contractor/Contractor shall comply with the relevant OHS Operational Standards for: COVID 19 OHS requirements, sanitation, sewage, hygiene, water supply, sleeping quarters, food establishments, and laundry and garbage disposal.

23. INCIDENT REPORTING AND INVESTIGATION

- 23.1 Incidents as described in terms of section 24 of the OHS Act shall be reported by the Service Provider/Contractor to the Department of Labour and to the Department. The Department shall further be provided with copies of any written documentation as per the Department's SHEQ Procedure (Incident Investigation and Non-Compliance) relating to any incident.
- 23.2 Notwithstanding the requirements of section 24 of the OHS Act, all incidents shall be investigated and reported on in writing, as per the Department's SHEQ Procedure (Incident Investigation and Non-Compliance).
- 23.3 The Department retains an interest in the notification of any incident as described in paragraphs 23.1 and 23.2 above, as well as in any formal investigation and/or inquiry conducted in terms of section 32 of the OHS Act into such incident.
- 23.4 Any incident, condition or act that could or could have caused injury, health impacts, damage or loss or affect the environment must be reported to the Department's Regional OHS Officers or to such a person in the Department as may be designated in writing to the Service Provider/Contractor.
- 23.5 The Service Provider/Contractor is responsible to oversee the investigation of all accidents/incidents where Employees/Participants and non-employees were injured to the extent that they had to receive first aid or be referred for medical treatment by a doctor,

- hospital or clinic. (see Regulation 9 of the General Administrative Regulations, 2003, published under Government Gazette Notice R929 of 25 June 2003).
- 23.6 The Service Provider/ Contractor is responsible for the investigation of all road traffic accidents relating to the operations and keeping a record of the results of such investigations including the steps taken to prevent similar accidents in future.
- 23.7 The Service Provider/ Contractor is required to maintain an acceptable disabling incident frequency rate (DIFR) of less than 0.5 and report on this to the Department on its behalf on a monthly basis.

24. FIRE PRECAUTIONS AND FACILITIES

- 24.1 The Service Provider/Contractor shall ensure that an adequate supply of fire protection and first aid facilities is provided as indicated in the Department's SHEQ Procedures (Emergency Preparedness and Response) for the Work to be performed on the Premises and/or Site. The Parties may mutually make arrangements for the provision of such facilities, subject to such arrangements being recorded in writing by the Parties thereto.
- 24.2 The Service Provider/Contractor shall further ensure that the Employees/Participants are familiar with fire precautions at the Premises and/or Site, which include the contingency plan and emergency exits and that such precautions are adhered to.

25. HYGIENE AND CLEANLINESS

- 25.1 The Service Provider/Contractor shall ensure that the area where the Work is performed is at all times maintained to reasonably practicable levels of hygiene and that they maintain the surrounding area of the Site to a reasonably practicable level of cleanliness. In this regard, no loose materials shall be left lying unnecessarily, and the Site shall be cleared of waste materials regularly and on completion of any Work performed by the Service Provider/Contractor and its Employees/Participants.
- 25.2 Disinfectant, sanitization and personal hygiene protocols as stipulated in the Department's SHEQ Procedures and Standards (COVID 19) shall be implemented, monitored and adhered too at all times on the Site/Premises.

26. ENVIRONMENT

26.1 The Service Provider/Contractor shall ensure that the Work and the manner in which the Work is executed:

- 26.1.1 complies with all relevant environmental legislation; and
- 26.1.2 complies with all environmental SHEQ Procedures and Standards (Pollution, Air, Ground & Water) or Requirements adopted by the Department from time to time.
- 26.2 The Service Provider/Contractor shall provide the Department with such reports as the Department require from time to time in order to comply with the provisions of the environmental legislation, or any competent authority in matters relating to the environmental legislation.
- 26.3 In order to comply with relevant environmental legislation, the Service Provider/ Contractor shall ensure that the following precautionary measures, but not limited to, are adhered hereto:

26.3.1 General environmental rules:

- 26.3.1.1 The Service Provider/Contractor must obtain clearance for bringing chemicals/herbicides onto the Premises and/or Site. For clearance, material safety data sheets must be available on Site for these chemicals/herbicides. It is essential that the Service Provider/Contractor Employees/Participants understand the hazards and safe handling precautions to be taken prior to the chemical/herbicides being used;
- 26.3.1.2 Ad-hoc dumping on any part of the Site is strictly prohibited and it is the responsibility of the Service Provider/Contractor to ensure that dumping on any part of the Site does not occur:
- 26.3.1.3 Machinery to be used at the Site must be fitted with muffling devices to reduce the likelihood of noise pollution.

26.3.2. General

- 26.3.2.1 The Service Provider/Contractor undertakes to rectify any environmental degradation on the Site caused by any Work or activity, to the satisfaction of the Department and in line with the relevant environmental legislation.
- 26.3.2.2 The Service Provider/Contractor will immediately report any incident that causes or has the likelihood of causing any environmental degradation or pollution to the Department;
- 26.3.2.3 The Service Provider/Contractor indemnifies the Department for any claims that may arise from any pollution or degradation that has taken place or that

is likely to take place and that was caused by any Work, act, or omission occasioned by the Service Provider/ Contractor appointed.

27. PERSONAL PROTECTIVE EQUIPMENT

- 27.1 The Service Provider/Contractor shall ensure that its Responsible Persons and the Employees/Participants are provided with, and at all relevant times wear, adequate personal protective equipment (PPE) for the work they perform at the Site, and in accordance with the requirements of Regulation 2 of the General Safety Regulations, 1986, published under Government Gazette Notice R1031 of 30 May 1986 in terms of the OHS Act as well as Department's SHEQ Procedures and Standards (PPE requirements).
- 27.2 The Service Provider/Contractor shall provide adequate and appropriate safety equipment of an approved type and quantity, as may be specified (or expected in accordance with good working practice), and shall maintain this safety equipment in a professional manner as dictated by the OHS Act and the Department's SHEQ Procedures and Standards (PPE and COVID 19 requirements). In addition, the Service Provider/Contractor shall keep up-to-date records of all said equipment. Furthermore:
 - 27.2.1 The Service Provider/Contractor shall ensure that all contract personnel under its supervision have been trained in the proper use, maintenance and limitations of safety equipment;
 - 27.2.2 The Service Provider/Contractor must ensure that there is free access, at all times, by all persons on the Site to all fire extinguishing/beaters and safety equipment;
 - 27.2.3 The Responsible Person must not require, or permit a contract employee to work unless the required safety equipment is used and in good order.
- 27.3 The Service Provider/Contractor shall supply its Contractor and sub Contractor's and Employees/Participants with adequate PPE as required in connection with the safe performance of the Work. The PPE shall be maintained in good condition, and shall be worn on all relevant occasions as indicated by notices, instructions, work permits, safety regulations and good practice (Department's SHEQ Procedures and Standards (PPE requirements):
 - 27.3.1 The PPE shall meet the minimum prescribed standards of quality as prescribed and/or approved by the South African Bureau of Standards (SANS);
 - 27.3.2 The PPE shall be replaced when it becomes ineffective through wear and tear;

- 27.3.3 The required PPE on a Site will depend on the hazards and risk identified in a Workplace Risk Assessment. Consideration must be given to the source of energy and the part of the body involved;
- 27.3.4 The PPE requirements must be included in the Service Provider/Contractor Health & Safety Plan;
- 27.3.5 The Service Provider/Contractor must keep records of all issues of PPE;
- 27.3.6 The Service Provider/Contractor must ensure that regular checks are conducted by the Contractor/supervisor on the correct use of PPE;
- 27.3.7 The Service Provider/Contractor must ensure that safety boots with steel toe or PVC moulded cap must be worn on construction Site/ Premises;
- 27.3.8 The Service Provider/Contractor must ensure that safety hats are worn in demarcated areas on the Site and in all places on the Sites where there is a possibility of head injuries;
- 27.3.9 The Service Provider/Contractor must ensure that the correct and approved Hazardous Chemical overalls, gloves, masks and respirators, are worn whenever hazardous chemical substances are handled on Site, or if there is a possibility of cutting the skin when abrasive or sharp materials are being man handled:
- 27.3.10 The Service Provider/Contractor must ensure that the correct and approved hearing protection equipment/devices, are worn when working with machinery that generates noise above 85dB (A);
- 27.3.11 The Service Provider/Contractor must ensure that safety glasses and face shields are worn when the Work on the Site involves concussive or abrasive operation likely to cause flying debris, or when decanting or handling hazardous chemicals on the Site:
- 27.3.12 The Service Provider/Contractor must ensure that Employees/Participants are familiar with the operation and application of respiratory apparatus like dust masks for dusty areas and self contained breathing apparatus for toxic environments;
- 27.3.13 Sand blasting, grinding and disc cutting operations, should preferably be done using equipment and/or procedures that do not produce dust on the Site. In cases where this is not possible, the Service Provider/Contractor must ensure that SANS-approved respiratory equipment is worn and the area must be enclosed to contain dust generation to a minimum;

- 27.3.14 The Service Provider/Contractor must ensure that fall arrest and fall prevention equipment shall be used to secure workers involved with high altitude work or when working at elevated heights (2 meters) and where falling from such heights is not protected by any other means. Where required, the Service Provider/ Contractor must ensure that a documented fall protection plan must be in place, kept on Site and implemented; and
- 27.3.15 The Service Provider/Contractor must ensure that the wearing of loose over-clothes, sandals and/or shorts on Site/ Premises is prohibited.
- 27.3.16 In addition to the existing prescribed PPE requirements for each task, the Employees/ Participants must be issued with the following PPE with respect to COVID 19 requirements by the Service Provider/Contractor:
 - I. a face mask [3 (three) material layer washable face masks an issue of a minimum of 2 (two) masks per Employee/ Participant];
 - II. a pair of working leather gloves; and
 - III. a face shield [an issue of a minimum of 2 (two) face shields per Employee/ Participant].

28. TRANSPORT, PLANT, MACHINERY AND EQUIPMENT

In terms of the OHS Act, the Service Provider/Contractor is not permitted to Work with/on equipment that is unsafe or under hazardous conditions, unless Employees/Participants exposed to these hazards, are informed of such hazards and precautionary measures are in place to manage these hazards. Where the latter cannot be complied with, Employees/Participants will not be required or permitted to work in such situations:

- 28.1 The Service Provider/Contractor shall ensure that all the plant, machinery, equipment and/or vehicles it may wish to utilize on the Premises and/or Site is/are at all times of sound order and fit for the purpose for which it is intended, and that it complies with the relevant legislative requirements as well as the Department's SHEQ Procedures and Standards (Vehicles and trailers, Machine guarding, Rope Access and Fall arrest; Hand tools and equipment, Fire-fighting equipment, Storage of flammables etc.).
- 28.2 In accordance with the provisions of section 10(4) of the OHS Act, the Service Provider/Contractor hereby assumes the liability, for taking the necessary steps to ensure that any article or substance that is erected or installed at the Premises and/or Site, and which the Service Provider/Contractor uses at work complies with all the prescribed requirements and will be safe and without risks to health when properly used.
- 28.3 The Service Provider/Contractor must ensure that all equipment, vehicles, machines, instruments and tools used by the Service Provider/Contractor's Employees/

Participants on a Site/Premises are maintained in a good, safe working order and suitable for the work to be performed and all personnel handling and/or operating same as adequately and appropriately trained to do so.

- 28.4 The Service Provider/Contractor shall not allow unauthorized, untrained or unlicensed operators to operate equipment or vehicles on the Department's Premises and/or Sites;
- 28.5 No vehicle, equipment or machine will be permitted onto the Site unless:
 - 28.5.1 such vehicle is in a roadworthy condition, and in the case of equipment and machines, have been recorded in a register, inspected and approved by the Service Provider/Contractor's Responsible Person;
 - 28.5.2 the machines and equipment displays suitable identification, stating a reinspection date. The Service Provider/Contractor may be required to remove machines or equipment without valid identification from the Site;
 - 28.5.3 the Service Provider/Contractor vehicles, equipment and machinery are subject to a visual road worthy check and/ or a safety inspection by the Department's OHS Environmental Personnel or Project Manager;
 - 28.5.4 all drivers must be recorded on a register, and must hold and be able to produce a valid driver's license as well as Professional Drivers Permit, verified through ENatis; and
 - 28.5.5 the Service Provider/Contractor shall ensure that all road vehicles used on the Premises and/or Site are recorded in a register, are in a roadworthy condition, are licensed, have a Departmental authorization disk and are insured.
- 28.6 The maximum speed limit on gravel roads on the Site is 40km/h, unless otherwise indicated.
- 28.7 The warning, safety and road signs on the Site must always be obeyed.
- 28.8 Overloading of vehicles on the Site is not permitted.
- 28.9 People, tools and equipment must be transported separately.
- 28.10 Where benches are provided in vehicles, these must be secured. In the event that any hazardous substances are to be transported on the Premises and/or Site, the Service Provider/ Contractor shall ensure that the requirements of the Hazardous Chemical Agent Regulation 2021(Government Gazette Notice No 44348 of 29 March 2021) ("the Hazardous Chemical Agent Regulations"), the National Road Traffic Act, 1996 (Act No

- 93 of 1996, as well as the Department's SHEQ Procedures and Standards (Vehicles and trailers & Hazardous Chemical Agent) are complied with at all times.
- 28.11 Reckless driving or non-observance of these instructions mentioned under paragraphs 28.5 to 28. above may be cause for the withdrawal of the authorisation of the driver to operate the vehicle.
- 28.12 The occupants of vehicles, including journeys to and from the Sites, must wear seat belts where fitted to any vehicle as a local legislative requirement.
- 28.13 During excavations on the Site, the Service Provider/Contractor shall take extra care, by consulting Site drawings, extrapolating positions from the positions of above ground equipment, etc., not to damage any underground equipment.
- 28.14 If any equipment on the Site is damaged during excavations, the necessary precautions shall be taken immediately to make the situation as safe as reasonably possible, and the Department's Project Manager must be contacted immediately for advice on further action to be taken.

29. EMERGENCY PREPAREDNESS AND RESPONSE

- 29.1 The Service Provider/Contractor will be responsible for the compilation, implementation and updating of the Emergency Evacuation Site Plan for their respective Site/ Premises operations in accordance with the Department's SHEQ Procedures (Emergency Preparedness and Response and COVID -19).
- 29.2 Each applicable Site/Premises, as identified should have supplement relevant emergency plans detailing:
 - 29.2.1 Major hazards;
 - 29.2.2 Evacuation routes;
 - 29.2.3 Assembly points;
 - 29.2.4 Emergency equipment; and
 - 29.2.5 Key personnel and contact details.
- 29.3 The emergency plan must be communicated as part of induction training for new Employees/Participants on Site and such plan should be visually displayed on the Site. Each Site shall, where applicable:
 - 29.3.1 make appropriate appointments;
 - 29.3.2 train personnel;
 - 29.3.3 have appropriate and adequate emergency equipment available;
 - 29.3.4 maintain emergency equipment; and

- 29.3.5 communicate and maintain up-to-date contact information of all role-players, and interested and affected parties.
- 29.4 If not already tasked to the H&S Representative/Officer appointed, the Service Provider/
 Contractor must appoint a competent Emergency Controller who must develop
 contingency plans for any emergency that may arise on the Premises and/or Site as
 indicated by the risk assessments. Contingency plans must be developed in consultation
 with COVID-19 Compliance Representative.

30. ARRANGEMENTS FOR MONITORING AND REVIEW

- 30.1 Audits and inspections by the Department or its Agent on its behalf.
- 30.1.1 The Department on its behalf reserves the right to conduct any other OHS compliance *ad hoc* audits and inspections as it, and/or its Agent on its behalf, deem necessary in accordance with the Department's SHEQ Procedures (Non Conformity, Corrective and Preventative Action).
- 30.1.2 A representative of the Service Provider/Contractor must accompany the Department on all audits and inspections and may conduct their own audit/inspection at the same time. Each Party will, however, take responsibility for the results of his/her own audit/inspection results.
- 30.1.3 For purposes of monitoring the Service Provider/Contractor's adherence to the OHS requirements by the Department, the Department shall allow persons nominated by the Department to audit the Service Provider/ Contractor in relation to compliance with the:
 - i. ISO 14001- Environmental Management System;
 - ii. ISO 9001- Quality Management System;
 - iii. Occupational Health and Safety Act, 1993 (Act No: 85 of 1993) and its Regulations, and the ISO 45001- Occupational Health and Management System;
 - iv. Compensation for Occupational Injuries and Diseases Act, 1993 (Act No: 130 of 1993);
 - v. Department's SHEQ Procedures and Standards; and
 - vi. Annexure D (OHS Specifications).

30.2 Reports

30.2.1 The Service Provider/Contractor shall report all incidents as stipulated in paragraph 23 of this OHS Specifications.

ANNEXURE D (OHS SPECIFICATIONS) TO THE MEMORANDUM OF AGREEEMENT ENTERED INTO BETWEEN DFFE AND (NAME OF SERVICE PROVIDER) FOR (THE PROJECT) FOR THE PERIOD (START DATE) TO (END DATE) CONTRACTOR AGREEMENT

30.2.2 The Service Provider/Contractor is required to provide the Department with copies of all statutory reports required in terms of the OHS Act and the Regulations together with a monthly "OHS Management Report".

30.3 Review

- 30.3.1 The Service Provider/Contractor must review the Hazard Identification and Risk Assessments and Safe Work Processes/Procedures at each Operational Planning and Progress Report meeting as:
 - i. the Works develops and progresses; and
 - ii. each time changes are made to the designs, plans, work methods and processes.
- 30.3.2 The Service Provider/Contractor must provide the Department or the Department's Agent acting on its behalf, Contractors and all other concerned parties with copies of any changes, alterations or amendments as contemplated in paragraph 30.3.1(ii) above.

31. CLARIFICATION

In the event that the Service Provider/Contractor requires clarification of any of the terms or provisions of this Specifications, it should contact the appropriate and designated representative of the Department whose clarification in terms hereof must be made in writing.



CORPORATE IDENTITY BRANDING GUIDELINES



Herewith the branding manual of the Environmental Protection & Infrastructure Programmes, designed and laid out in accordance with the Government, EPWP and Department of Environmental Affairs branding manuals.

CORPORATE IDENTITY BRANDING GUIDELINES

CONTENTS

LOGO CONSTRUCTION AND APPLICATION	1
EPIP logo construction	1
Monotone logo	2
Colour specifications	3
Typography	4
STATIONERY	5
Complimentary slip	5
Email signature	6
MEDIA APPLICATIONS	7
Logo and project identification	7
Posters	8
Banners	9
Gazebo	11
Brochures	12
Newsletters	13
Website	14
Umbrellas	15
CORPORATE CLOTHING	16
Head gear	16
Clothing branding guidelines	17
Protective clothing	20
Hard hats	21
SIGNAGE	22
Sian boards	22

EPIP LOGO CONSTRUCTION

The Petals

The 3 petals represent the Soil (Brown), Vegetation (Green) and Water (Blue), which represent the mandate of the Department for which the programme stand for.

Hands

The hands symbolise 1. Care for the environment, 2. Provision of opportunities (Skills Development, Job creation & SMME Development) through environmental inteventions (projects)



ENVIRONMENTAL PROTECTION & INFRASTRUCTURE PROGRAMMES

MONOTONE LOGO

The EPIP logo may be represented in black or white reflected out of any solid colour background.

It should always be positioned top left or center of the document covers or electronic media, the DEA (Department of Environmental Affairs) logo should always be positioned at the bottom left, also on a white background as per GCIS manual.

One solid signature should only be place on a solid background, preferable in white or black. This will apply primarily on signage and corporate gifts. Please avoid placing logos on textures or patterned background.

The reverse version should only be placed on 100% black to 30% black backgrounds, excluding promotional elements where it may also be embossed.



Black reversed out of white



White reversed out of black

COLOUR SPECIFICATIONS

PRIMARY COLOUR

Green is the primary colour



100c, 14m, 100y, 41k R0, G101, B50 PANTONE 356C

NOTE:

The EPIP logo may only be used over a white background. It should always be positioned top left or center of the document covers or electronic media, the DEA (Department of Environmental Affairs) logo should always be positioned at the bottom left, also on a white background as per GCIS manual.

TERTIARY COLOURS

These consist of the remaining colours of the EPIP logo



28c, 67m, 100y, 17k R162, G92, B11 PANTONE 7512C



0c, 0m, 0y,0k R255, G255, B255



98c, 77m, 6y, 0k R32, G67, B148 PANTONE 661C

TYPOGRAPHY

Condensed', a clear font found in use 12pt size, unless necessary both Windows and Mac platforms. a variation of 10% up or down is The font must be used in all recommended. A5 can use 10pt, document titles, the body text can A6 8pt. be Arial or Trebushet font styles.

The main logo is in 'Placard Typically A4 documents need to

Primary descriptor

Century Gothic Bold

A B C D E F G H I J K L M N O P Q R S T U V W X Y Z a b c d e f g h i j k l m n o p q r s t u v w x y z 1 2 3 4 5 6 7 8 9 0 ! ? % & *

Century Gothic Regular

A B C D E F G H I J K L M N O P Q R S T U V W X Y Z abcdefghijklmnopgrstuvwxyz 1234567890 ! ? % & *

STATIONERY

COMPLIMENTARY SLIP

Printing Specifications

Paper size: 210mm x 99mm (DL)

Stock: Cartridge 100-115gms

Stock colour: White

Screen: 133

Colours: Full colour

Complimentary Slips are printed on the same paper as the letterhead. Complimentary slips are specifically used for delivery scribes or rough notes by hand to external customers, the slips may be used for internal communications as well. The notes generated in this form must always take note of the Department and EPIP's representativity, it is therefore as important as it is to the letterhead to keep the slips in a secure location.

With Compliments





Tel: 012 310 3911, Fax: 012 320 7541 Fedsure Forum Building 315 Pretorius Street, Pretoria, 0002 Private Bag X447, Pretoria 0001 www.environment.gov.za




STATIONERY

EMAIL SIGNATURE

Email Footer To protect the EPIP / DEA, every email sent out must bear a footer which includes an email disclaimer. The disclaimer legally protects the EPIP / DEA against malicious use of words by the email sender by disengaging the views of the sender from those of the organisation.

The protection extends to viral infections caused by an email or attachment from the EPIP / DEA. A network administrator and / or IT support must be consulted to implement the email footer and how to configure a vacation responder. The footer may be programmed to include hyperlinks.

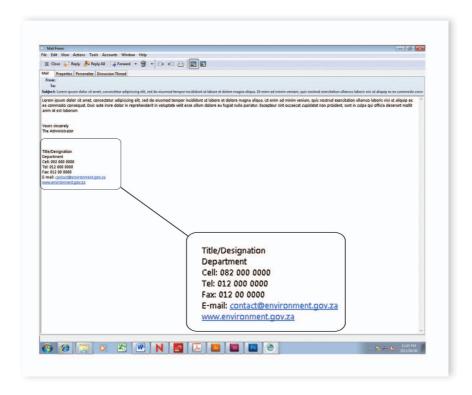

LOGO AND PROJECT IDENTIFICATION

The branding guidelines in this manual are to be strictly adhered to, on all of the garments, publications, branding and promotional items.

All branding material produced by Implementers must be signed off by the

DEA Director of Corporate Communication, or a delegated official of Corporate Communication.

Email:communications@environment.gov.za to obtain sign-off.

Sign board



Implementers logo

POSTERS

Posters come in different sizes height. Officially accredited EPIP ranging from A4, A3, A2, A1 and pictures are used. These pictures A0. The logo placement must be may be edited. 1/8th of the poster



BANNERS

Pull Up (850 x 1850) Wall Banner (4x3m) The EPIP can use any banner type and style, of which there are multitudes, however, the basic design principle of the artwork shall always apply. To illustrate this principle, if a single banner e.g. a pull up is used, it is ideal to pick a theme, say 'Job Creation' then the entire banner design revolves around 'Job creation'.

To complete the EPIP using pull up or roll up banners, 3 will have to be done in order to complete EPIP's mandate. A wall banner, preferably 4 x 3m, can be used to provide a complete view of the EPIP. The banner may be printed on fabric [internal use only] or canvas [internal & exterior use]. All other types, teardrop, Aframes, etc... are to be designed around the single theme concept.






Pull Up Banner

BANNERS

300cm W x 225cm H

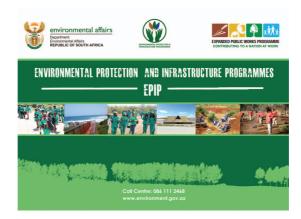


Wall Banner



Pop-up Banner

GAZEBO

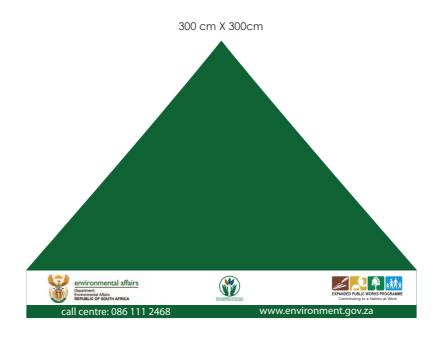



BROCHURES


Portrait Brochure




Landscape Brochure



NEWSLETTERS

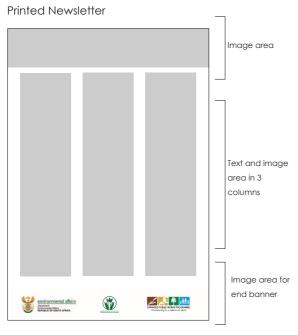

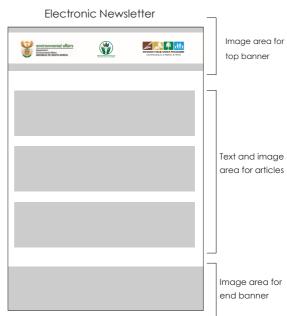

WEBSITE

The EPIP website must be designed on a CMS, Content Management System platform. The CMS is a non-static website that allows the website administrator to alter and update content accordingly. Fundamental features of the website include a dynamic link to social networking sites and video portals, enrolment to the electronic

The site is designed in a simple and basic manner to allow web browsers to easily access information, however, the EPIP may adopt any other design that upholds similar theme and look & feel.



UMBRELLAS

Solid green, blue, black or brown umbrellas must be used, of any design. The colour of the umbrella must resemble as close as possible recommended in this instance. the pantone equivalence.

solid white logo must therefore be used on 2 opposite panels. Informative text is not



HEAD GEAR

Head gear may be caps, sun hats or berets, the simple branding principle of solid colour by either white or black one colour logo always applies. This form of branding enhances visibility. An orange colour headgear may also be used, the orange is closely extracted from the coat

of arms and is to be used in outdoor activity where easy identification or spotting may be necessary e.g. working at a thick forest, using inmates, etc... The EPIP logo is embroidered onto the headgear's fabric.



CLOTHING BRANDING GUIDELINES


The EPIPT-shirts will range from round necks to golf shirts, depending on use, quantity and recipients. Solid colours of Green may be used with the appropriate logos in full colour The logo must be silk screened onto the front of the shirt. If necessary, a message may also be incorporated at the back of the shirt beneath the EPWP lettering. This use is recommended for round necks only. Corporate golf shirts and formal shirts


must have the full colour logo embroidered onto the left breast or pocket. The EPIP jackets will adopt this style of branding as well. Embroiderey logo size will be recommended or determined by the embroidery. Logos which are sewn on as a patch are not recommended due to the wear and tear. Good quality T-shirt material is recommended, eg a minimum of 180g/m. T-shirts may be white, green or yellow.



CLOTHING BRANDING GUIDELINES


Golf shirts

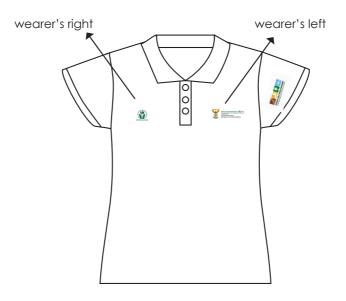

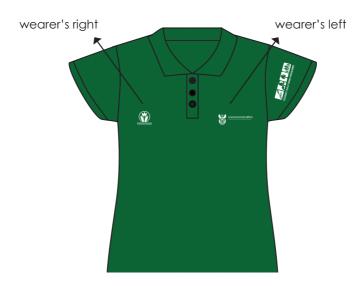

CLOTHING BRANDING GUIDELINES



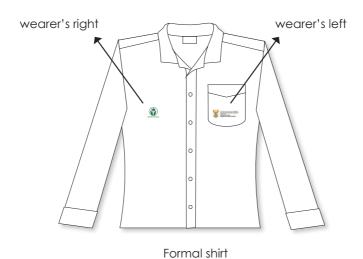

PROJECT PROTECTIVE CLOTHING

All projects should comply with the requirements applicable for prote tive clothing. The colour of the protective clothing MUST be GREEN. Hard hats may be green, white or yellow. Logos MUST be used as illustrated below. The logos may be full colour or white, and, in the event the colours are clashing and

being absorbed by the solid overall colour, the full colour system may be implemented using badges, i.e. the logo is printed on a solid white back cloth/background and then sewn/paste onto the overall. Same guidelines apply in case of any project-related clothing branding (e.g. shirts, T - shirts, etc...)



PROJECT PROTECTIVE CLOTHING - HARD HATS



SIGNAGE

SIGN BOARDS

All projects sites must be branded accordingly as per the prescribed guidelines illustrated below. The background colour for the sign boards must be GREEN. These are prescribed standards and

deviation should be sought from the responsible Provincial Project Manager. NB. Note that the size of the Logo of the Implementing Agent CANNOT be bigger than that of the Department, EPIP & EPWP.





Notes

EPIP Help: (01) 310 3426


Fax: (012) 320 754


Call centre: 086 111 x 18


Postal Address


Private Bag X447

Pretoria, 0001

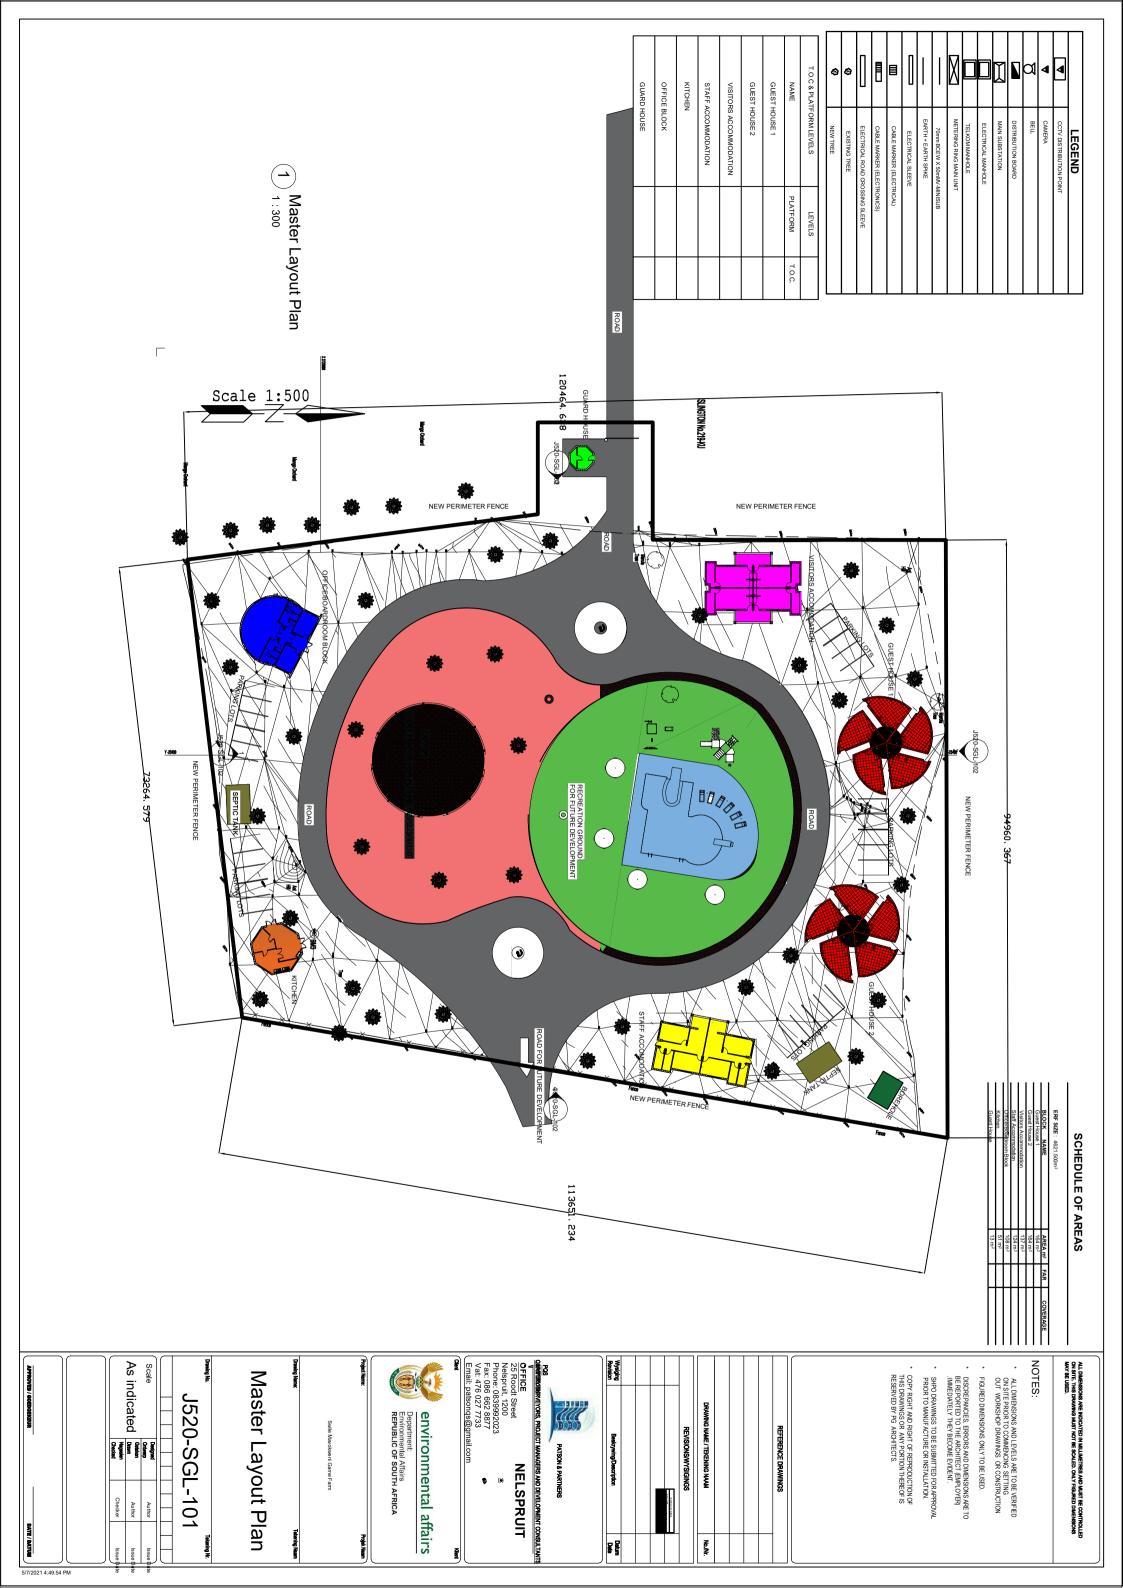

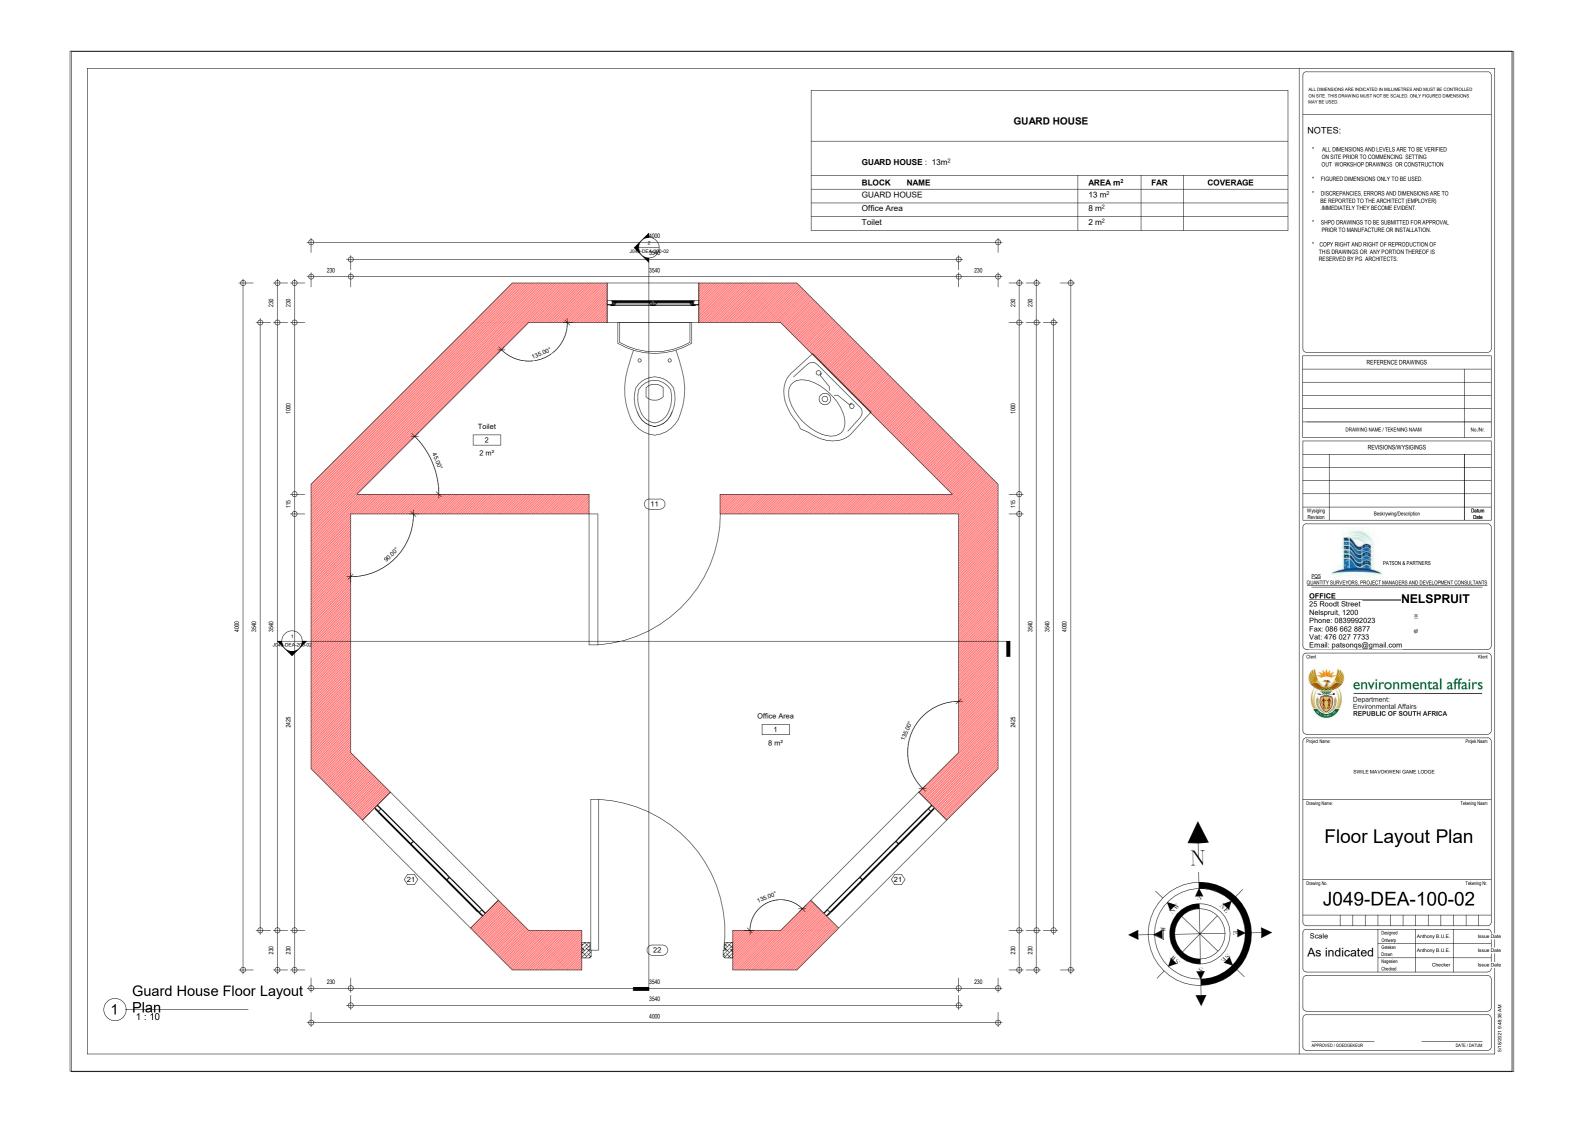

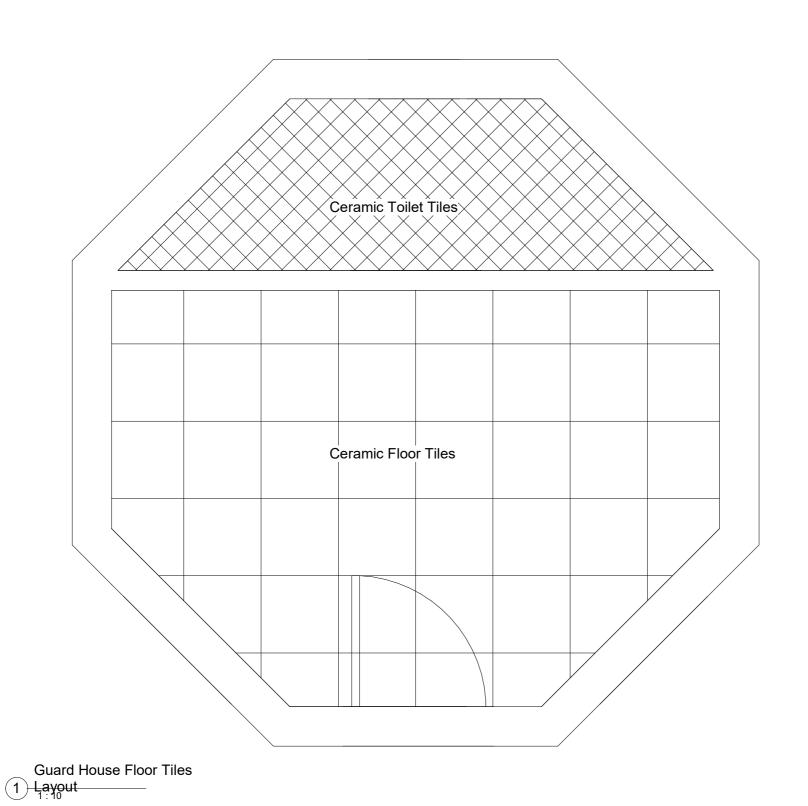

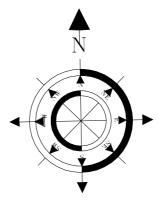

NOTES:

- * ALL DIMENSIONS AND LEVELS ARE TO BE VERIFIED ON SITE PRIOR TO COMMENCING SETTING OUT WORKSHOP DRAWINGS OR CONSTRUCTION
- * FIGURED DIMENSIONS ONLY TO BE USED.
- DISCREPANCIES, ERRORS AND DIMENSIONS ARE TO BE REPORTED TO THE ARCHITECT (EMPLOYER) .IMMEDIATELY THEY BECOME EVIDENT.
- SHPO DRAWINGS TO BE SUBMITTED FOR APPROVAL PRIOR TO MANUFACTURE OR INSTALLATION.
- * COPY RIGHT AND RIGHT OF REPRODUCTION OF THIS DRAWINGS OR ANY PORTION THEREOF IS RESERVED BY PG ARCHITECTS.

		-
		_
	DRAWING NAME / TEKENING NAAM	No./Nr.
	REVISIONS/WYSIGINGS	
Wysiging Revision	Beskrywing/Description	Datum Date



OFFICE Nelson Street Nelson 125 Rood Street Nelsonuit, 1200 Phone: 0839992023 Fax: 086 662 8877 Vat: 476 027 7733 Email: patsonqs@gmail.com -NELSPRUIT

environmental affairs

Department:
Environmental Affairs
REPUBLIC OF SOUTH AFRICA Department:
Environmental Affairs
REPUBLIC OF SOUTH AFRICA

Floor Tiles Layout


J049-DEA-100-01

Scale

As indicated

Designed Ontweep Anthony B.U.E. Gedelen Drawn
Drawn Anthony B.U.E. Checked

Checked Checker

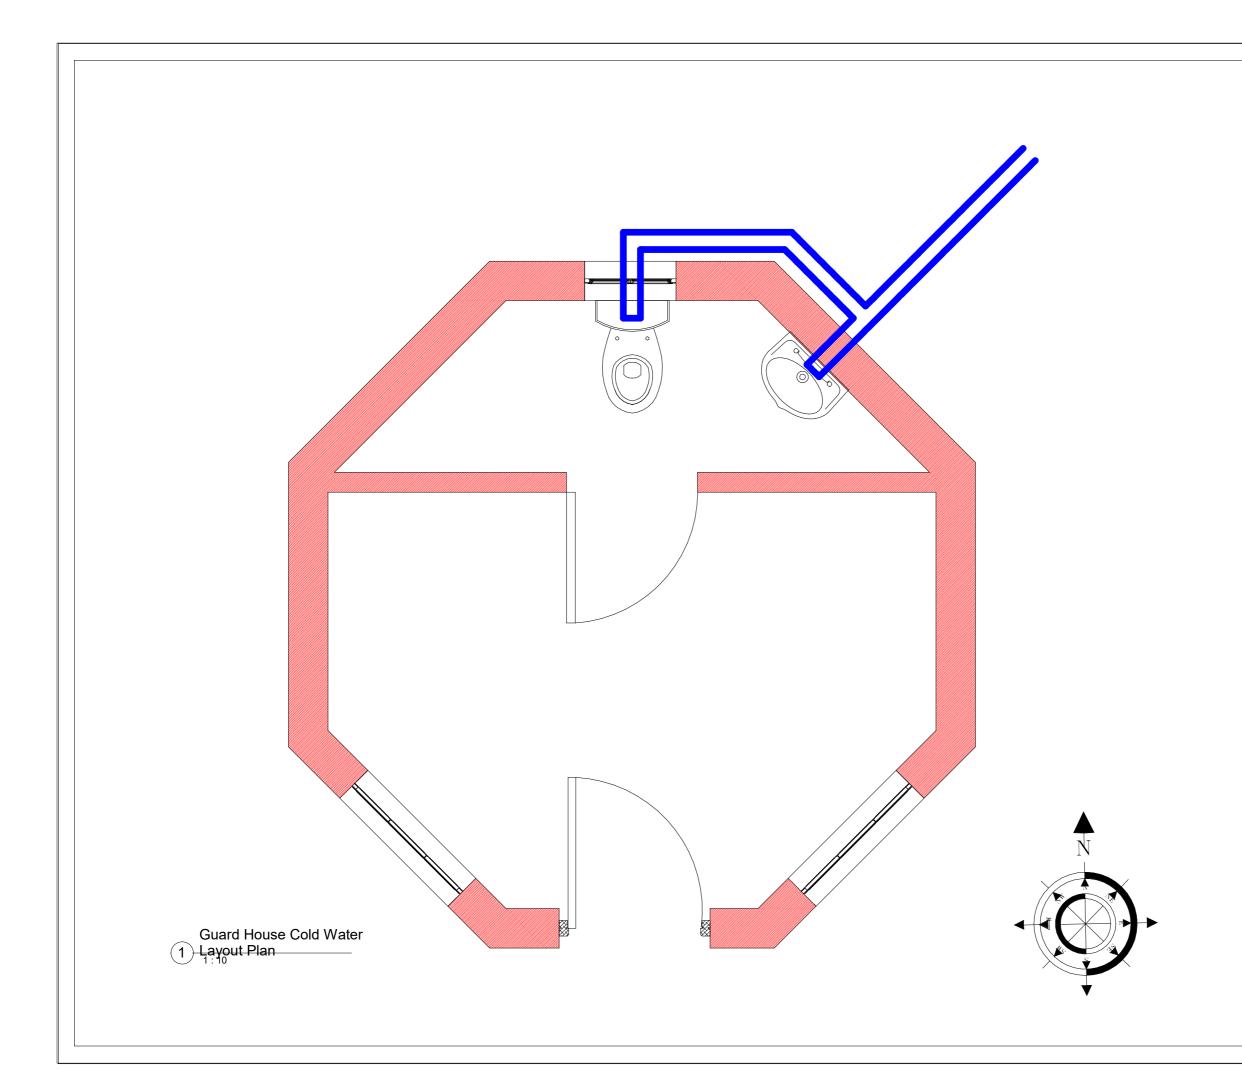

- ALL DIMENSIONS AND LEVELS ARE TO BE VERIFIED ON SITE PRIOR TO COMMENCING SETTING OUT WORKSHOP DRAWINGS OR CONSTRUCTION
- FIGURED DIMENSIONS ONLY TO BE USED.
- DISCREPANCIES, ERRORS AND DIMENSIONS ARE TO BE REPORTED TO THE ARCHITECT (EMPLOYER) .IMMEDIATELY THEY BECOME EVIDENT.
- SHPO DRAWINGS TO BE SUBMITTED FOR APPROVAL PRIOR TO MANUFACTURE OR INSTALLATION.
- COPY RIGHT AND RIGHT OF REPRODUCTION OF THIS DRAWINGS OR ANY PORTION THEREOF IS RESERVED BY PG ARCHITECTS.

	DRAWING NAME / TEKENING NAAM	No./Nr.
	REVISIONS/WYSIGINGS	
Wysiging		Datum

REFERENCE DRAWINGS



OFFICE 25 Roodt Street
Nelspruit, 1200
Phone: 0839992023
Fax: 086 662 8877
Vat: 476 027 7733
Email: patsonqs@gmail.com -NELSPRUIT

environmental affairs

Department:
Environmental Affairs Department: Environmental Affairs REPUBLIC OF SOUTH AFRICA


Cold Water Layout Plan

J049-DEA-100-03

Scale

As indicated

Designed
Ontwerp
Geteken
Drawn
Nagessien

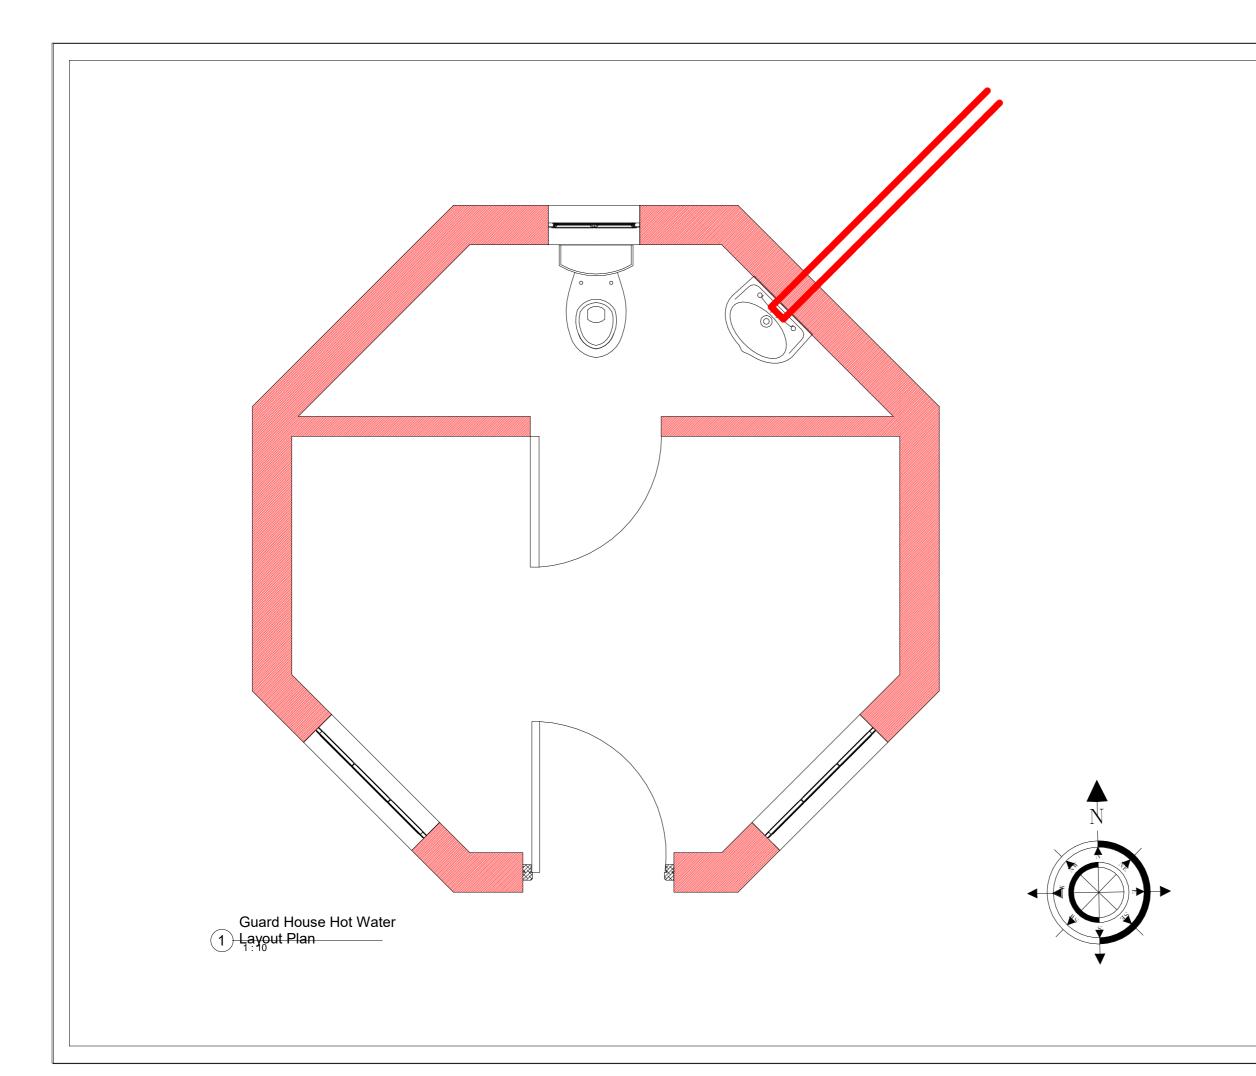

- ALL DIMENSIONS AND LEVELS ARE TO BE VERIFIED ON SITE PRIOR TO COMMENCING SETTING OUT WORKSHOP DRAWINGS OR CONSTRUCTION
- FIGURED DIMENSIONS ONLY TO BE USED.
- DISCREPANCIES, ERRORS AND DIMENSIONS ARE TO BE REPORTED TO THE ARCHITECT (EMPLOYER) .IMMEDIATELY THEY BECOME EVIDENT.
- SHPO DRAWINGS TO BE SUBMITTED FOR APPROVAL PRIOR TO MANUFACTURE OR INSTALLATION.
- COPY RIGHT AND RIGHT OF REPRODUCTION OF THIS DRAWINGS OR ANY PORTION THEREOF IS RESERVED BY PG ARCHITECTS.

	DRAWING NAME / TEKENING NAAM	No./N
	REVISIONS/WYSIGINGS	
Wysiging	Beskrywing/Description	Datu

REFERENCE DRAWINGS



OFFICE
25 Roodt Street
Nelspruit, 1200
Phone: 0839992023
Fax: 086 662 8877
Vat: 476 027 7733
Email: patsonqs@gmail.com -NELSPRUIT


environmental affairs Department: Environmental Affairs REPUBLIC OF SOUTH AFRICA

Hot Water Layout Plan

J049-DEA-100-04

Scale
As indicated

| Designed Orthwerp Gerishen Drawn Nagesien Checked |

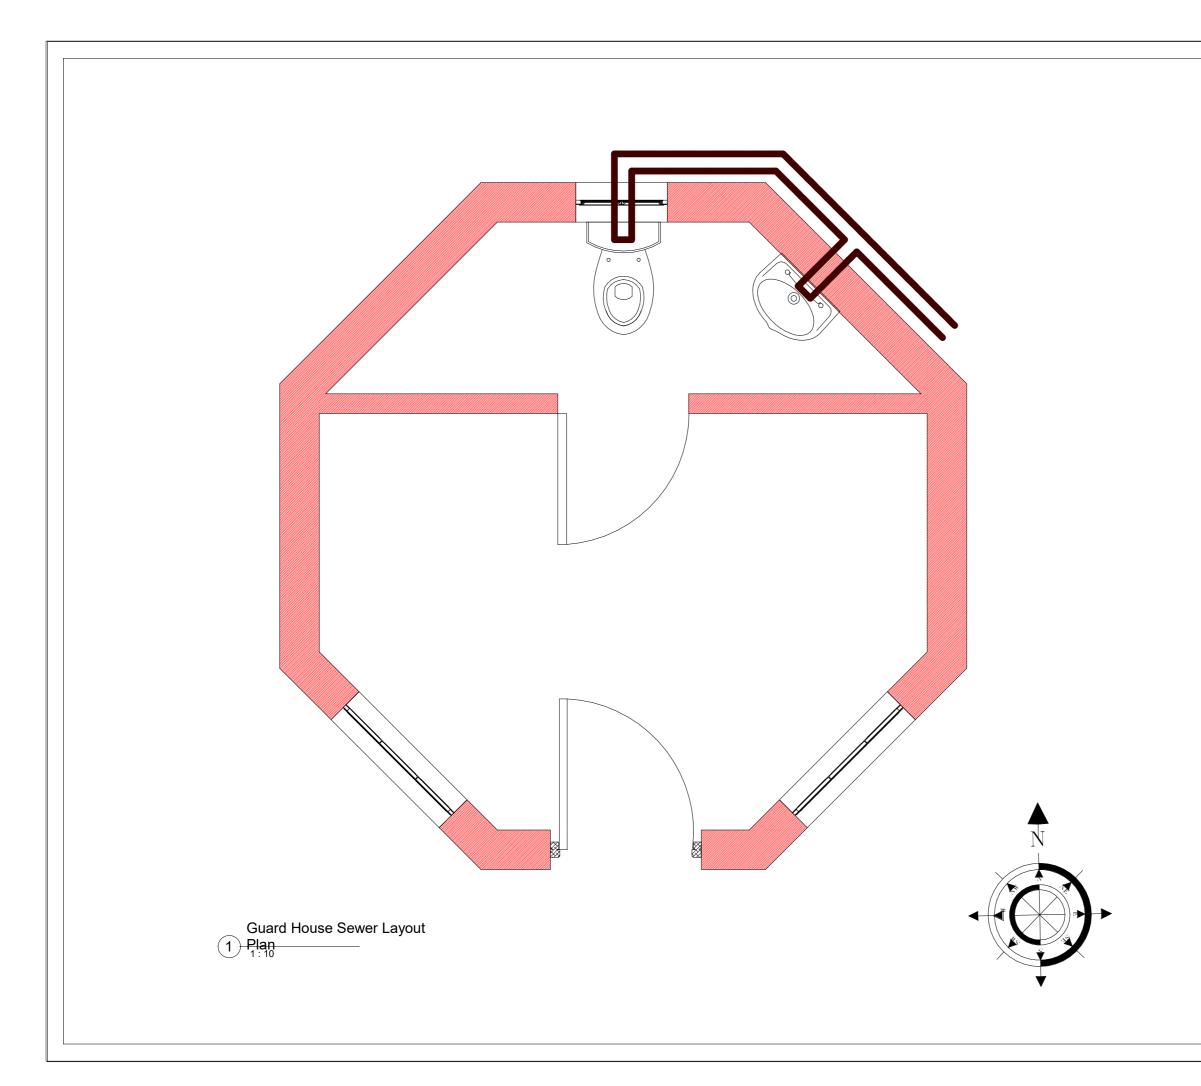

- ALL DIMENSIONS AND LEVELS ARE TO BE VERIFIED ON SITE PRIOR TO COMMENCING SETTING OUT WORKSHOP DRAWINGS OR CONSTRUCTION
- FIGURED DIMENSIONS ONLY TO BE USED.
- DISCREPANCIES, ERRORS AND DIMENSIONS ARE TO BE REPORTED TO THE ARCHITECT (EMPLOYER) .IMMEDIATELY THEY BECOME EVIDENT.
- SHPO DRAWINGS TO BE SUBMITTED FOR APPROVAL PRIOR TO MANUFACTURE OR INSTALLATION.
- COPY RIGHT AND RIGHT OF REPRODUCTION OF THIS DRAWINGS OR ANY PORTION THEREOF IS RESERVED BY PG ARCHITECTS.

	REFERENCE DRAWINGS	
	DRAWING NAME / TEKENING NAAM	No./Nr.
	REVISIONS/WYSIGINGS	
Wysiging Revision	Beskrywing/Description	Datum Date



OFFICE
25 Roodt Street
Nelspruit, 1200
Phone: 0839992023
Fax: 086 662 8877
Vat: 476 027 7733
Email: patsonqs@gmail.com -NELSPRUIT

environmental affairs


Department: Environmental Affairs REPUBLIC OF SOUTH AFRICA

Sewer Layout Plan

J049-DEA-100-05

Scale
As indicated

| Designed Orthwerp Gerishen Drawn Nagesien Checked |

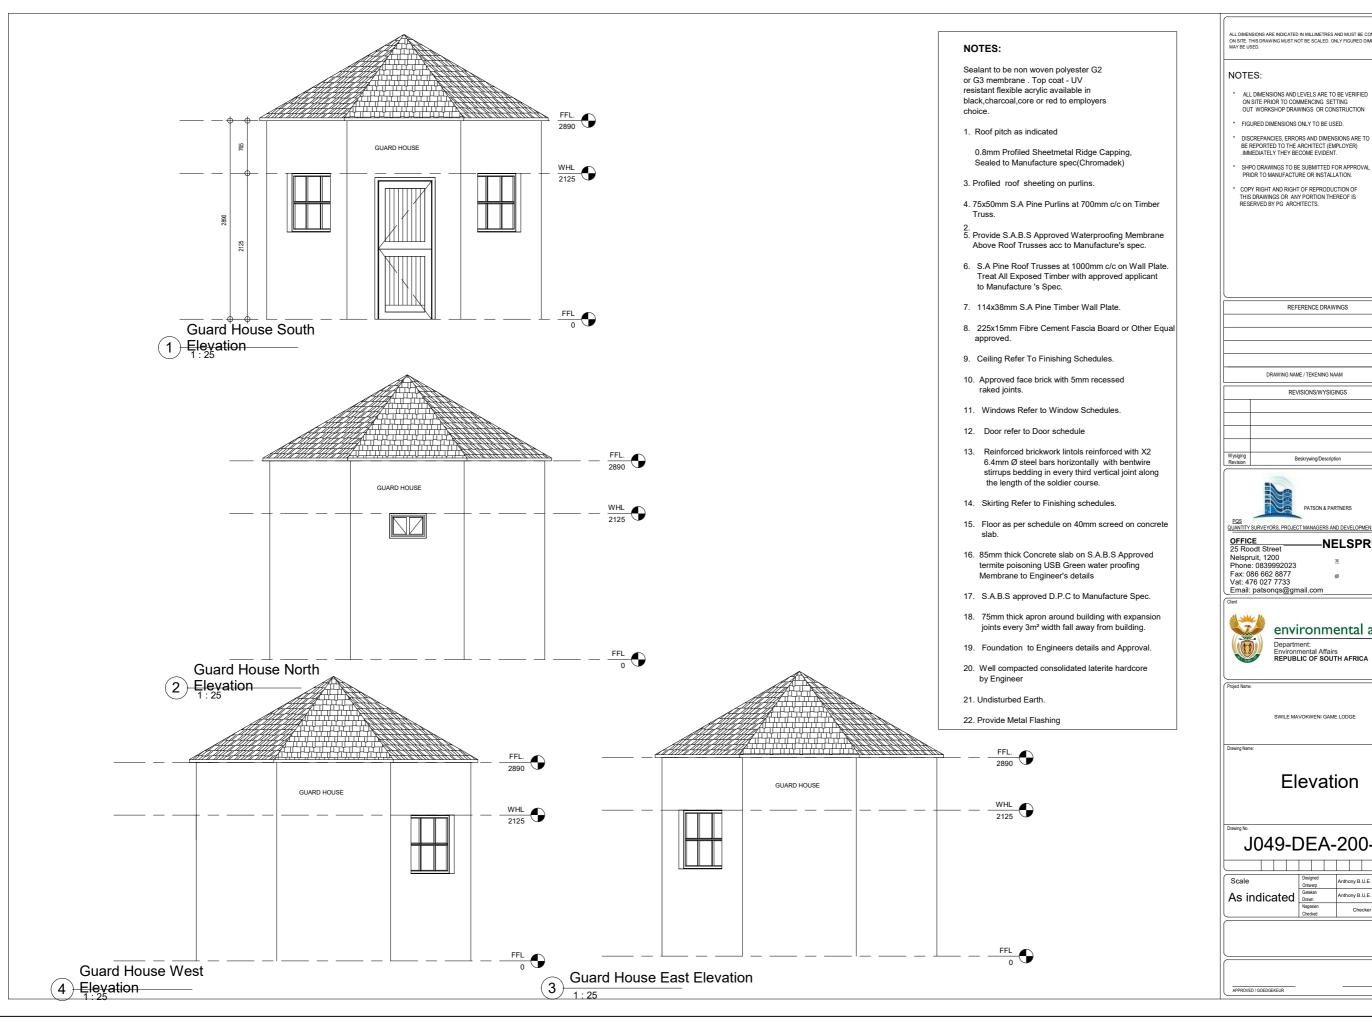

- DISCREPANCIES, ERRORS AND DIMENSIONS ARE TO


	REFERENCE DRAWINGS	
	DRAWING NAME / TEKENING NAAM	No./Nr.
	REVISIONS/WYSIGINGS	
Wysiging Revision	Beskrywing/Description	Datum Date


-NELSPRUIT


environmental affairs Department: Environmental Affairs REPUBLIC OF SOUTH AFRICA

oject Name:	Projek Naam
SWILE MAVOKW	/ENI GAME LODGE

J049-DEA-200-01

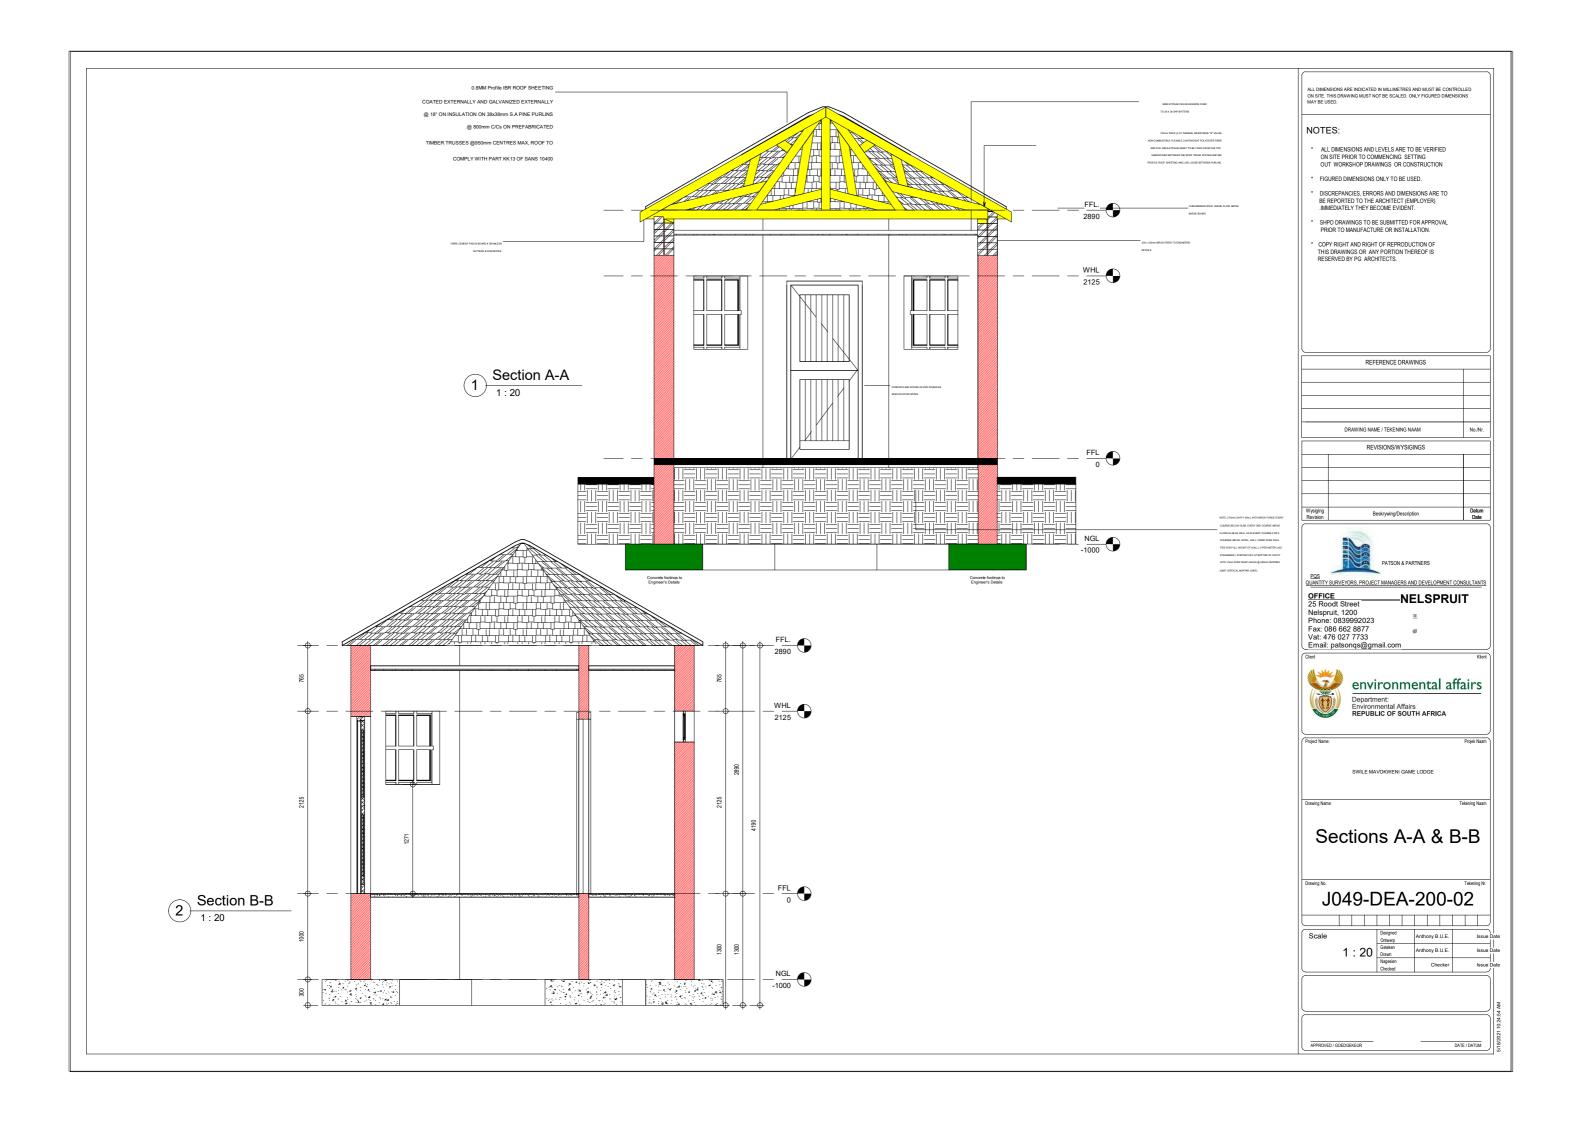

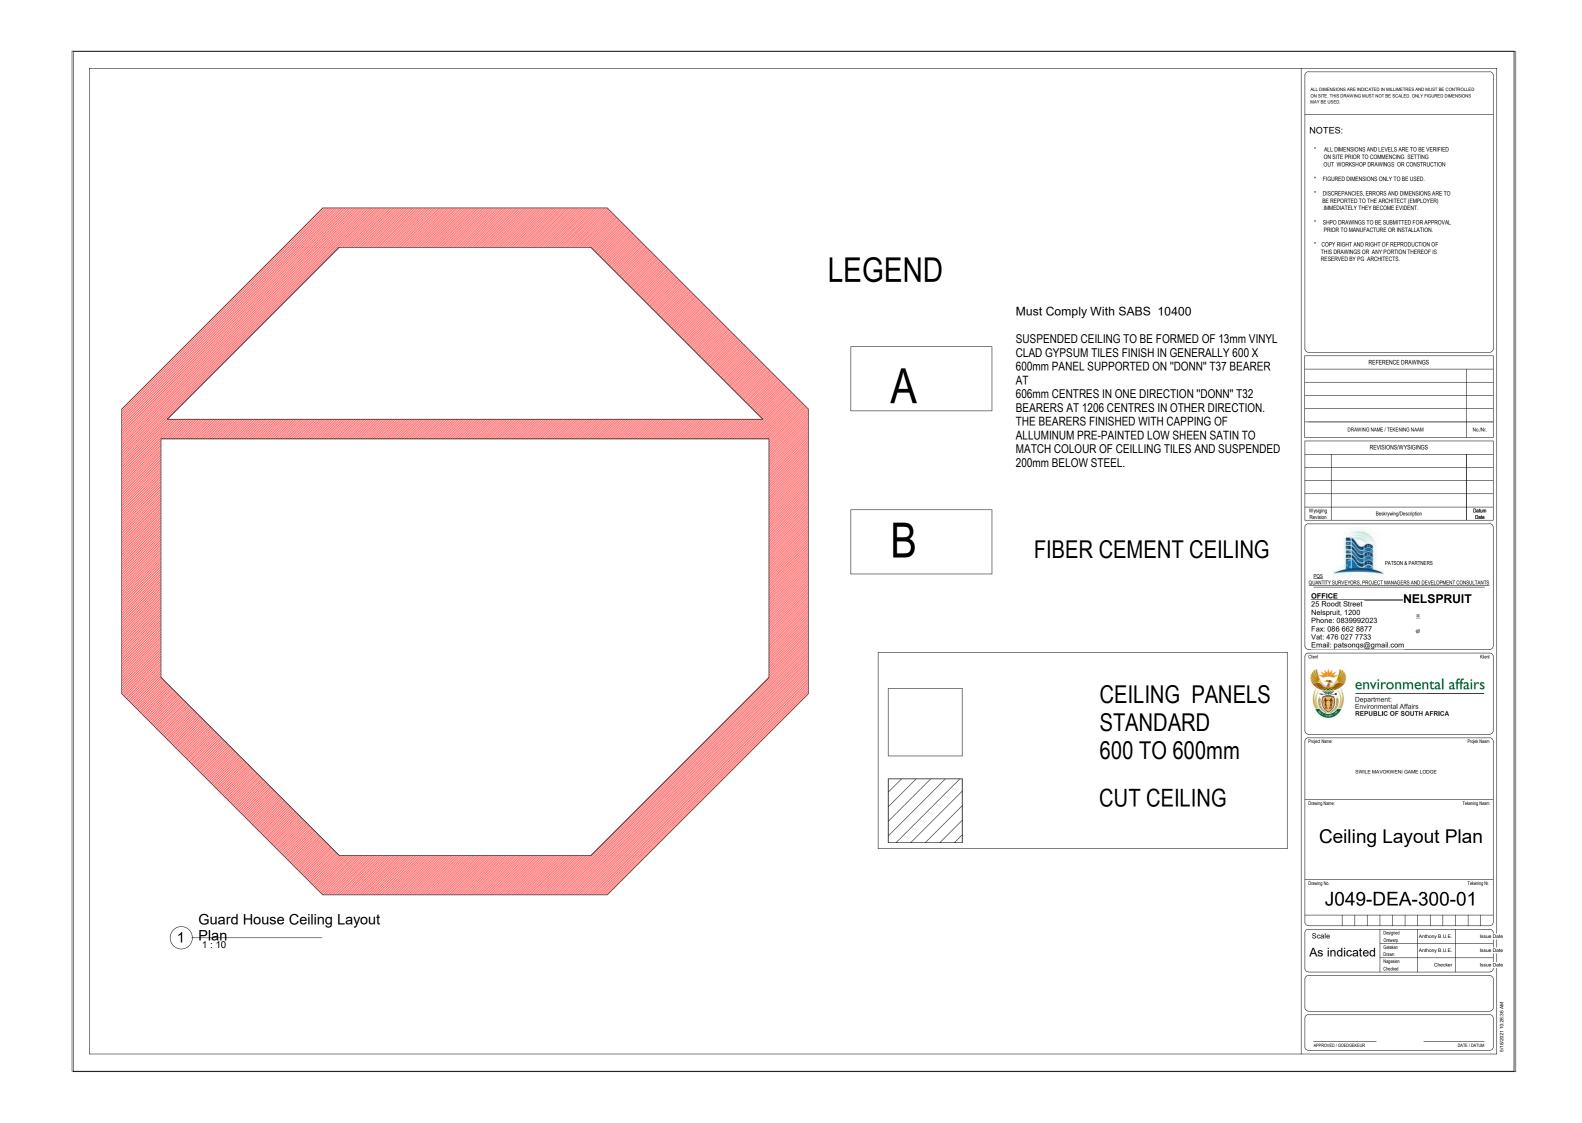

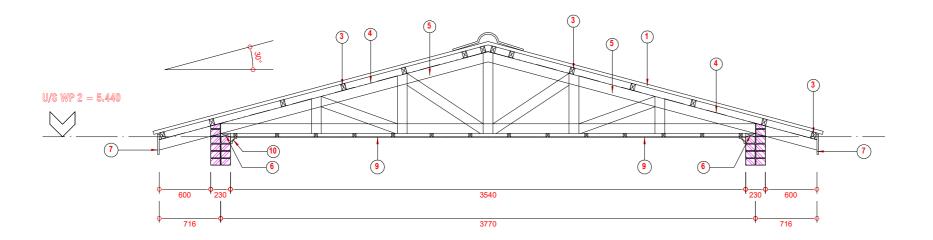

ROOF TRUSS TYPE "C" SCALE 1:20

Guard House Roof Truss

1 Details


Sealant to be non woven polyester G2 or G3 membrane . Top coat - UV resistant flexible acrylic available in black, charcoal, core or red to employers choice.

- Profiled roof sheeting on 75x50mm
 SA pine purlins on prefabricated roof structure, treat all exposed timber with approved applicant.
- 2. Proved Fibre Cement Barge Boad
- 3. 75x50mm S.A pine Timber Purlins at 700mm c/c on timber trusses.
- 4. 0.5mm thick SABS Approved water proofing membane
- 5. 114x38mm S.A pine Timber Trusses at 1200mm c/c on wall plate
- 6. 114x38mm S.A pine Timber wall plate
- 7. 225x15mm Fibre cement fascia board or other equal approved
- 8. 38x38mm S.A pine Timber Brandering at 450mm c/c
- 9. 6mm thick Fibre cement ceiling to finishing schedule
- 10. Cornice to finishing schedule
- 11. Provide Head and Counter Metal Flashing
- 12. 152x89mm Timber Rafters, Roof Truss Members to Engineer's Details and Spec
- 13. Reinforced Concrete Gutter to Engineer's Details and
- 14. 120x55mm Channel fixed to Details
- 15. Profiled roof sheeting

ON SITE. THIS DRAWING MUST NOT BE SCALED. ONLY FIGURED DIMEN MAY BE USED.

NOTES:

- ALL DIMENSIONS AND LEVELS ARE TO BE VERIFIED ON SITE PRIOR TO COMMENCING SETTING OUT WORKSHOP DRAWINGS OR CONSTRUCTION
- FIGURED DIMENSIONS ONLY TO BE USED.
- DISCREPANCIES. FRRORS AND DIMENSIONS ARE TO BE REPORTED TO THE ARCHITECT (EMPLOYER)
 .IMMEDIATELY THEY BECOME EVIDENT.
- SHPO DRAWINGS TO BE SUBMITTED FOR APPROVAL PRIOR TO MANUFACTURE OR INSTALLATION.
- COPY RIGHT AND RIGHT OF REPRODUCTION OF THIS DRAWINGS OR ANY PORTION THEREOF IS RESERVED BY PG ARCHITECTS.

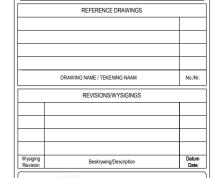




-NELSPRUIT 25 ROOD Street
Nelspruit, 1200
Phone: 0839992023
Fax: 086 662 8877
Vat: 476 027 7733
Email: patsonqs@gmail.com

environmental affairs Department: Environmental Affairs REPUBLIC OF SOUTH AFRICA

Roof Truss Details

J049-DEA-300-02

Ontwerp As indicated Geteken Drawn Nagesien Anthony B.U.E.

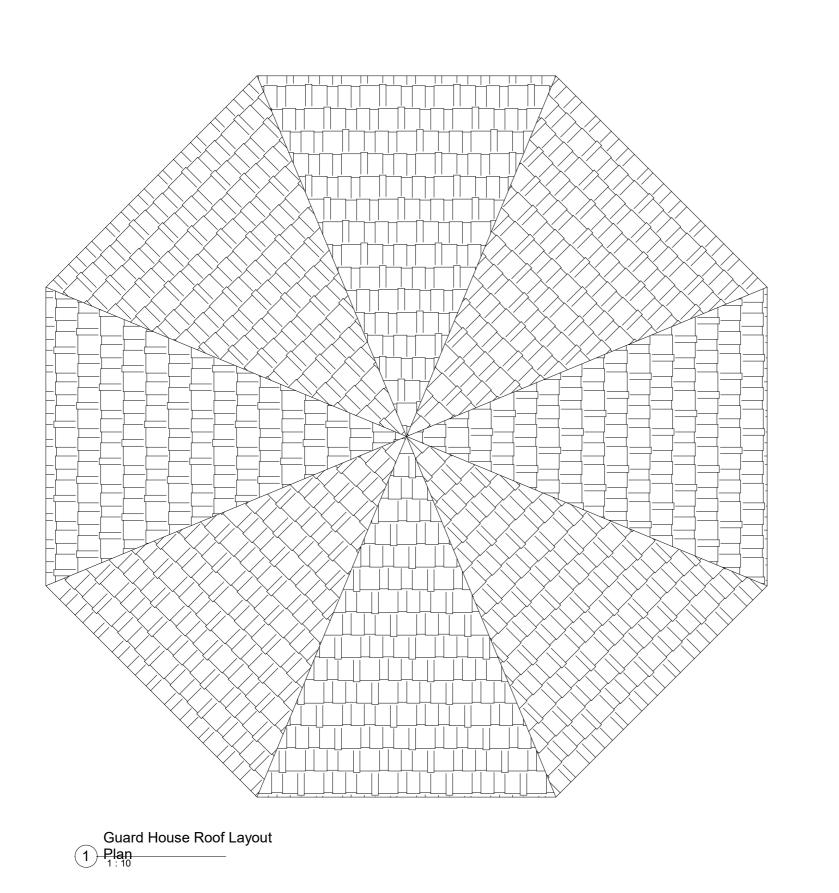

1. Fibre Cement Facia

2. Wood Float Plaster And Paint

3. Truss By Specialist

NOTES:

- ALL DIMENSIONS AND LEVELS ARE TO BE VERIFIED ON SITE PRIOR TO COMMENCING SETTING OUT WORKSHOP DRAWINGS OR CONSTRUCTION
- FIGURED DIMENSIONS ONLY TO BE USED.
- DISCREPANCIES, ERRORS AND DIMENSIONS ARE TO BE REPORTED TO THE ARCHITECT (EMPLOYER) .IMMEDIATELY THEY BECOME EVIDENT.
- SHPO DRAWINGS TO BE SUBMITTED FOR APPROVAL PRIOR TO MANUFACTURE OR INSTALLATION.
- COPY RIGHT AND RIGHT OF REPRODUCTION OF THIS DRAWINGS OR ANY PORTION THEREOF IS RESERVED BY PG ARCHITECTS.

	DRAWING NAME / TEKENING NAAM	No./Ni
	REVISIONS/WYSIGINGS	
Wysiging	Beskrywing/Description	Datun Date

REFERENCE DRAWINGS



-NELSPRUIT

OFFICE Nelspruit, 1200
Phone: 0839992023
Fax: 086 662 8877
Vat: 476 027 7733
Email: patsongs@gmail.com

environmental affairs Department: Environmental Affairs REPUBLIC OF SOUTH AFRICA

Roof Layout Plan


J049-DEA-400-01


Scale

As indicated

Designed Ontweep Anthony B.U.E. Gedelen Drawn
Drawn Anthony B.U.E. Checked

Checked Checker

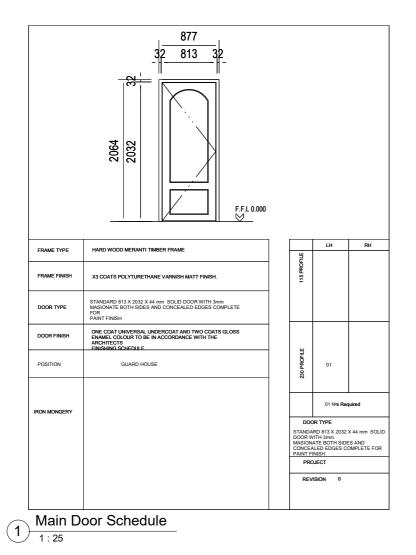

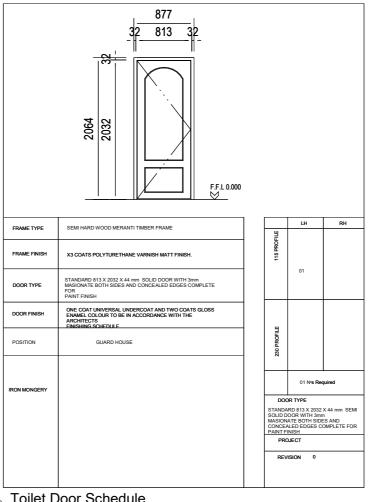

Toilet Door Schedule 2 I oile

ALL DIMENSIONS ARE INDICATED IN MILLIMETRES AND MUST BE CONTROLLED ON SITE. THIS DRAWING MUST NOT BE SCALED, ONLY FIGURED DIMENSIONS MAY BE USED.

NOTES:

- * ALL DIMENSIONS AND LEVELS ARE TO BE VERIFIED ON SITE PRIOR TO COMMENCING SETTING OUT WORKSHOP DRAWINGS OR CONSTRUCTION
- * FIGURED DIMENSIONS ONLY TO BE USED.
- DISCREPANCIES, ERRORS AND DIMENSIONS ARE TO BE REPORTED TO THE ARCHITECT (EMPLOYER)
 .IMMEDIATELY THEY BECOME EVIDENT.
- SHPO DRAWINGS TO BE SUBMITTED FOR APPROVAL PRIOR TO MANUFACTURE OR INSTALLATION.
- * COPY RIGHT AND RIGHT OF REPRODUCTION OF THIS DRAWINGS OR ANY PORTION THEREOF IS RESERVED BY PG ARCHITECTS.

		_
	DRAWING NAME / TEKENING NAAM	No./Nr.
	REVISIONS/WYSIGINGS	<u>'</u>
Wysiging Revision	Beskrywing/Description	Datum Date

REFERENCE DRAWINGS






Door Schedule

J049-DEA-400-02

1 : 25 Designed Ontwerp Anthony B.U.E. Geleken Drawn Anthony B.U.E. Nagesien Checker

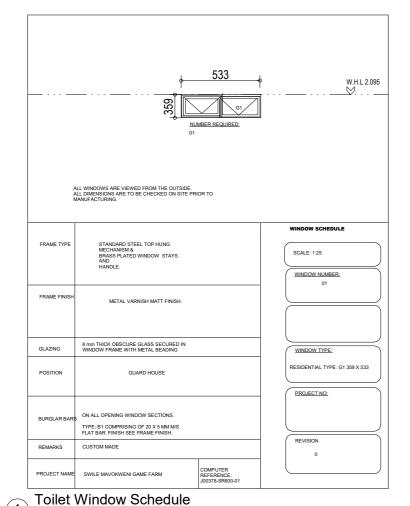

W.H.L 2.095 NUMBER REQUIRED: ALL WINDOWS ARE VIEWED FROM THE OUTSIDE.
ALL DIMENSIONS ARE TO BE CHECKED ON SITE PRIOR TO
MANUFACTURING. STANDARD STEEL TOP HUNG MECHANISM & BRASS PLATED WINDOW STAYS AND FRAME TYPE SCALE: 1:25 WINDOW NUMBER: FRAME FINIS METAL VARNISH MATT FINISH. 6 mm THICK OBSCURE GLASS SECURED IN WINDOW FRAME WITH METAL BEADING GLAZING WINDOW TYPE: POSITION GUARD HOUSE PROJECT NO: REVISION REMARKS CUSTOM MADE PROJECT NAME SWILE MAVOKWENI GAME FARM

Main Window Schedule

NOTES: * ALL DIMENSIONS AND LEVELS ARE TO BE VERIFIED ON SITE PRIOR TO COMMENCING SETTING OUT WORKSHOP DRAWINGS OR CONSTRUCTION

ALL DIMENSIONS ARE INDICATED IN MILLIMETRES AND MUST BE CONTROLLED ON SITE. THIS DRAWING MUST NOT BE SCALED, ONLY FIGURED DIMENSIONS MAY BE USED.

* FIGURED DIMENSIONS ONLY TO BE USED.

DISCREPANCIES, ERRORS AND DIMENSIONS ARE TO BE REPORTED TO THE ARCHITECT (EMPLOYER)
.IMMEDIATELY THEY BECOME EVIDENT.

SHPO DRAWINGS TO BE SUBMITTED FOR APPROVAL PRIOR TO MANUFACTURE OR INSTALLATION.

* COPY RIGHT AND RIGHT OF REPRODUCTION OF THIS DRAWINGS OR ANY PORTION THEREOF IS RESERVED BY PG ARCHITECTS.

	REFERENCE DRAWINGS	
	DRAWING NAME / TEKENING NAAM	No./Nr.
	REVISIONS/WYSIGINGS	
Wysiging Revision	Beskrywing/Description	Datum Date



PQS QUANTITY SURVEYORS, PROJECT MANAGERS AND DEVELOPMENT CONSULTANTS

-NELSPRUIT 25 Roodt Street Nelspruit, 1200 Phone: 0839992023 Fax: 086 662 8877 Vat: 476 027 7733 Email: patsonqs@gmail.com

environmental affairs

Department:
Environmental Affairs
REPUBLIC OF SOUTH AFRICA

SWILE MAVOKWENI GAME LODGE

Window Schedule

J049-DEA-400-03


1 : 25 Designed Ontwerp Anthony B.U.E. Geleken Drawn Anthony B.U.E. Nagesien Chapter


1:25

KITCHEN

KITCHEN: 51m²

BLOCK NAME	AREA m ²	FAR	COVERAGE
KITCHEN	51 m ²		
Dinning Area	20 m ²		
Store Room	9 m ²		
Cooking Area	14 m ²		
Toilet	1 m ²		

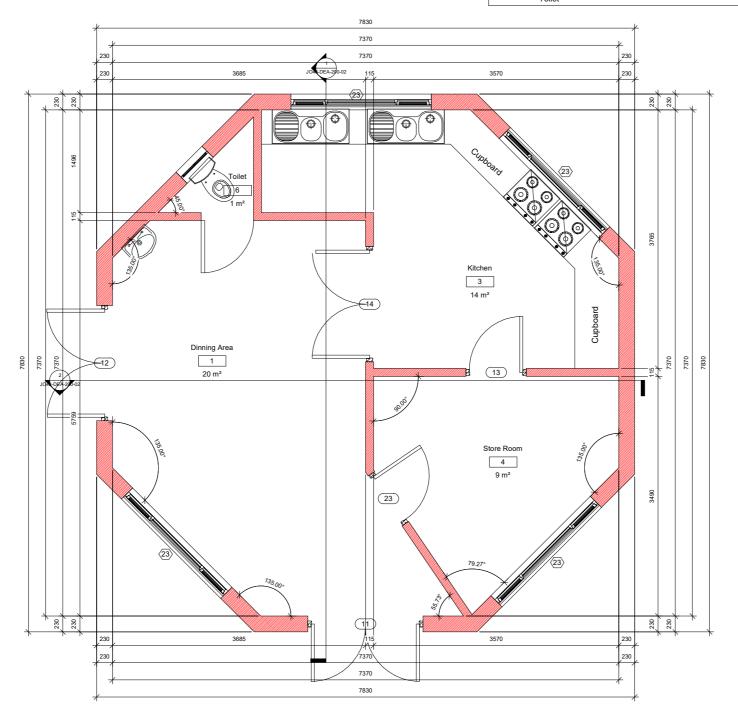

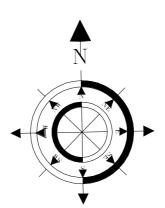

NOTES:

- ALL DIMENSIONS AND LEVELS ARE TO BE VERIFIED ON SITE PRIOR TO COMMENCING SETTING OUT WORKSHOP DRAWINGS OR CONSTRUCTION
- FIGURED DIMENSIONS ONLY TO BE USED.
- DISCREPANCIES, ERRORS AND DIMENSIONS ARE TO BE REPORTED TO THE ARCHITECT (EMPLOYER) .IMMEDIATELY THEY BECOME EVIDENT.
- SHPO DRAWINGS TO BE SUBMITTED FOR APPROVAL PRIOR TO MANUFACTURE OR INSTALLATION.
- COPY RIGHT AND RIGHT OF REPRODUCTION OF THIS DRAWINGS OR ANY PORTION THEREOF IS RESERVED BY PG ARCHITECTS.

	THE ENERGE DIVINITION	
	DRAWING NAME / TEKENING NAAM	No./Nr.
	REVISIONS/WYSIGINGS	
Wysiging Revision	Beskrywing/Description	Datum Date

REFERENCE DRAWINGS



OFFICE
25 Roodt Street
Nelspruit, 1200
Phone: 0839992023
Fax: 086 662 8877
Vat: 476 027 7733
Email: patsonqs@gmail.com -NELSPRUIT



Floor Layout Plan


JO48-DEA-100-02


Scale

As indicated

Designed Ontwerp
Geteken Drawn
Nagesien

Kitchen Floor Layout Plan
1:25

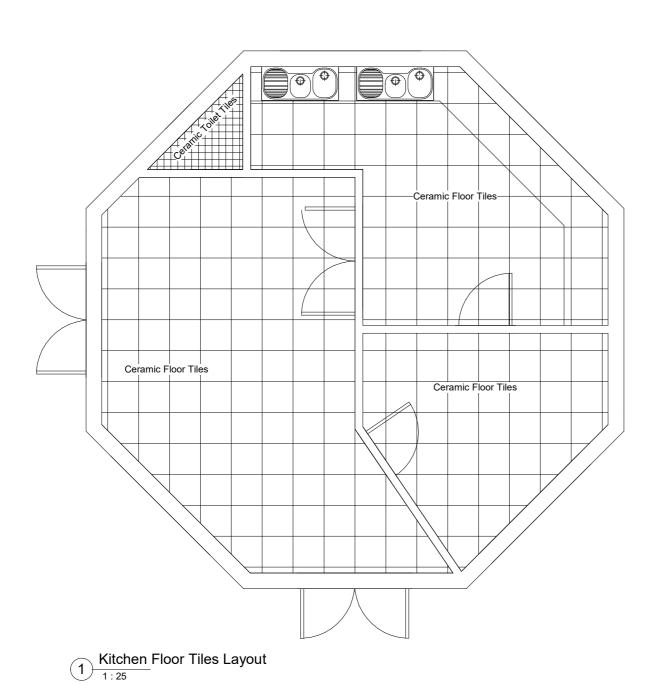

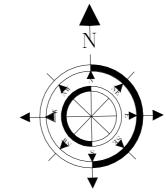

- * ALL DIMENSIONS AND LEVELS ARE TO BE VERIFIED ON SITE PRIOR TO COMMENCING SETTING OUT WORKSHOP DRAWINGS OR CONSTRUCTION
- * FIGURED DIMENSIONS ONLY TO BE USED.
- DISCREPANCIES, ERRORS AND DIMENSIONS ARE TO BE REPORTED TO THE ARCHITECT (EMPLOYER) .IMMEDIATELY THEY BECOME EVIDENT.
- SHPO DRAWINGS TO BE SUBMITTED FOR APPROVAL PRIOR TO MANUFACTURE OR INSTALLATION.
- * COPY RIGHT AND RIGHT OF REPRODUCTION OF THIS DRAWINGS OR ANY PORTION THEREOF IS RESERVED BY PG ARCHITECTS.

1	DRAWING NAME / TEKENING NAAM	No./Nr.
	REVISIONS/WYSIGINGS	
Wysiging Revision	Beskrywing/Description	Datum Date

REFERENCE DRAWINGS



OFFICE Nelspruit, 1200
Phone: 0839992023
Fax: 086 662 8877
Vat: 476 027 7733
Email: patsonqs@gmail.com -NELSPRUIT



Floor Tiles Layout


JO48-DEA-100-01

Scale

As indicated

Designed Ontweep Anthony B.U.E. Gedelen Drawn
Drawn Anthony B.U.E. Checked

Checked Checker

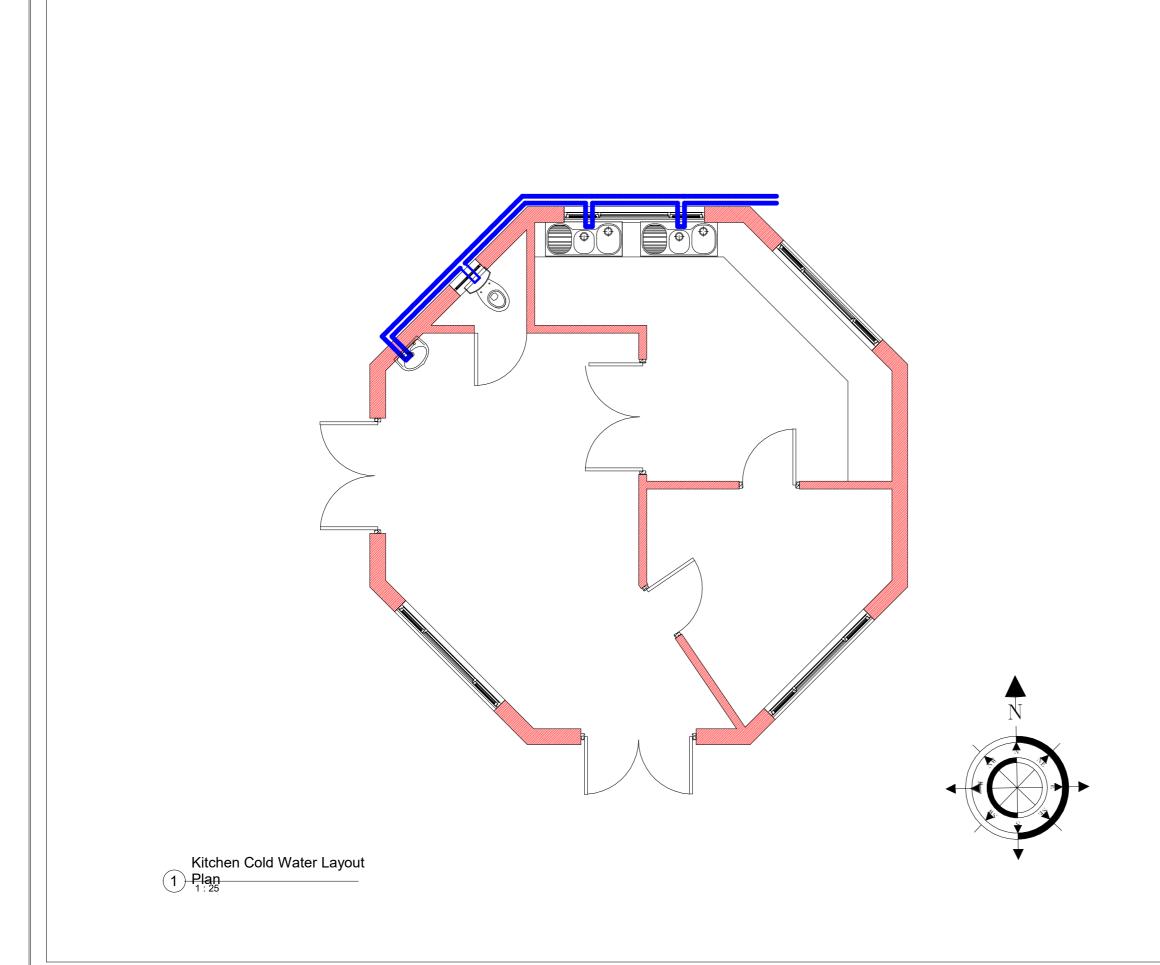

- ALL DIMENSIONS AND LEVELS ARE TO BE VERIFIED ON SITE PRIOR TO COMMENCING SETTING OUT WORKSHOP DRAWINGS OR CONSTRUCTION
- FIGURED DIMENSIONS ONLY TO BE USED.
- DISCREPANCIES, ERRORS AND DIMENSIONS ARE TO BE REPORTED TO THE ARCHITECT (EMPLOYER) .IMMEDIATELY THEY BECOME EVIDENT.
- SHPO DRAWINGS TO BE SUBMITTED FOR APPROVAL PRIOR TO MANUFACTURE OR INSTALLATION.
- COPY RIGHT AND RIGHT OF REPRODUCTION OF THIS DRAWINGS OR ANY PORTION THEREOF IS RESERVED BY PG ARCHITECTS.

REFERENCE DRAWINGS	
DRAWING NAME / TEKENING NAAM	No./Nr.
REVISIONS/WYSIGINGS	



OFFICE
25 Roodt Street
Nelspruit, 1200
Phone: 0839992023
Fax: 086 662 8877
Vat: 476 027 7733
Email: patsonqs@gmail.com -NELSPRUIT

environmental affairs Department: Environmental Affairs REPUBLIC OF SOUTH AFRICA


Cold Water Layout Plan


JO48-DEA-100-03

Scale

As indicated

Designed
Ontwerp
Geteken
Drawn
Nagessien

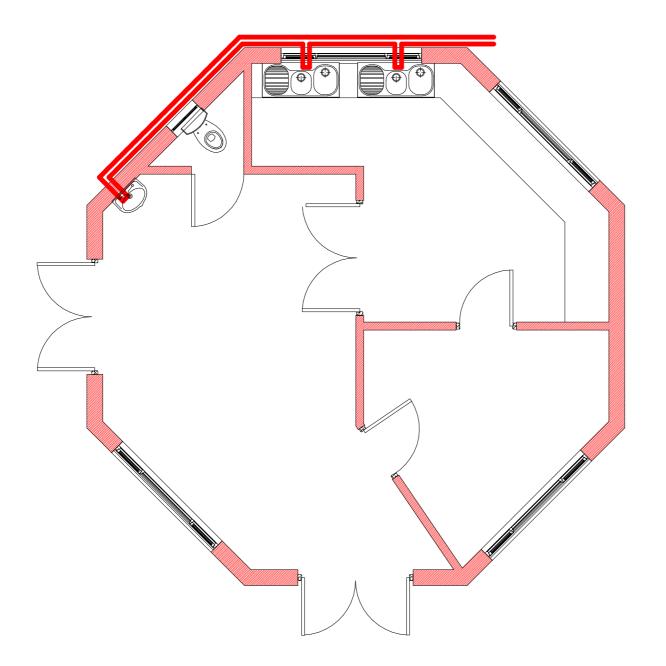

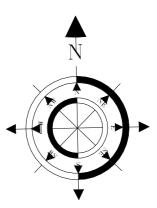

- ALL DIMENSIONS AND LEVELS ARE TO BE VERIFIED ON SITE PRIOR TO COMMENCING SETTING OUT WORKSHOP DRAWINGS OR CONSTRUCTION
- FIGURED DIMENSIONS ONLY TO BE USED.
- DISCREPANCIES, ERRORS AND DIMENSIONS ARE TO BE REPORTED TO THE ARCHITECT (EMPLOYER) .IMMEDIATELY THEY BECOME EVIDENT.
- SHPO DRAWINGS TO BE SUBMITTED FOR APPROVAL PRIOR TO MANUFACTURE OR INSTALLATION.
- COPY RIGHT AND RIGHT OF REPRODUCTION OF THIS DRAWINGS OR ANY PORTION THEREOF IS RESERVED BY PG ARCHITECTS.

	DRAWING NAME / TEKENING NAAM	No./Nr.
	REVISIONS/WYSIGINGS	
Wysiging Revision	Beskrywing/Description	Datum Date

REFERENCE DRAWINGS



OFFICE
25 Roodt Street
Nelspruit, 1200
Phone: 0839992023
Fax: 086 662 8877
Vat: 476 027 7733
Email: patsonqs@gmail.com -NELSPRUIT



Hot Water Layout Plan

JO48-DEA-100-04


Scale

As indicated

Designed
Ontwerp
Geteken
Drawn
Nagessien

Kitchen Hot Water Layout

1 Plan
1:25

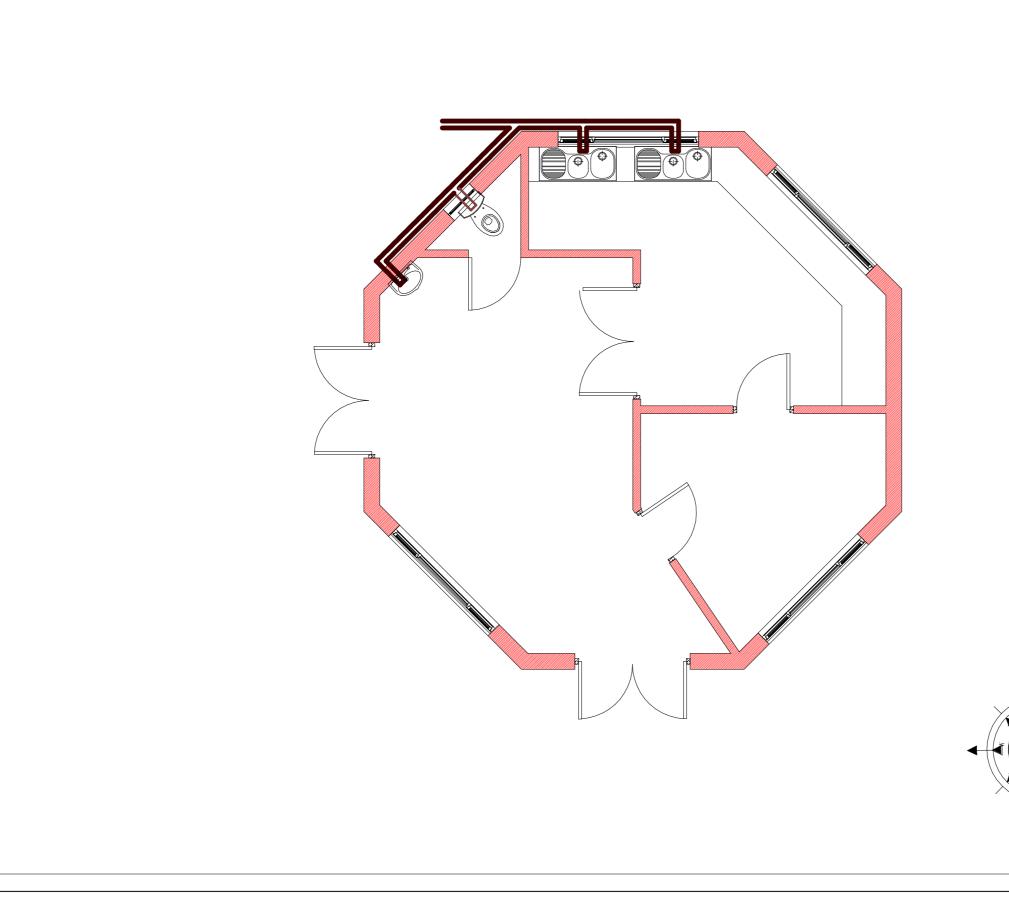

- ALL DIMENSIONS AND LEVELS ARE TO BE VERIFIED ON SITE PRIOR TO COMMENCING SETTING OUT WORKSHOP DRAWINGS OR CONSTRUCTION
- FIGURED DIMENSIONS ONLY TO BE USED.
- DISCREPANCIES, ERRORS AND DIMENSIONS ARE TO BE REPORTED TO THE ARCHITECT (EMPLOYER) .IMMEDIATELY THEY BECOME EVIDENT.
- SHPO DRAWINGS TO BE SUBMITTED FOR APPROVAL PRIOR TO MANUFACTURE OR INSTALLATION.
- COPY RIGHT AND RIGHT OF REPRODUCTION OF THIS DRAWINGS OR ANY PORTION THEREOF IS RESERVED BY PG ARCHITECTS.

	PRAWING NAME / TEKENING NAAM	No./Nr
	REVISIONS/WYSIGINGS	
Wysiging Revision	Beskrywing/Description	Datum Date



OFFICE 25 Roodt Street
Nelspruit, 1200
Phone: 0839992023
Fax: 086 662 8877
Vat: 476 027 7733
Email: patsonqs@gmail.com -NELSPRUIT




Sewer Layout Plan

JO48-DEA-100-05


Scale

As indicated


Creary
Geteken
Drawn
Nagesien
Checked

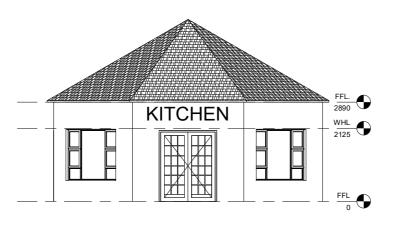

Kitchen South Elevation

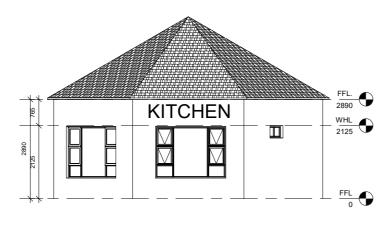

Kitchen North Elevation

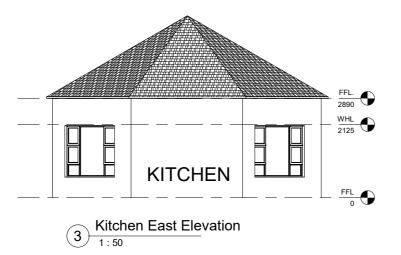


NOTES:

Sealant to be non woven polyester G2 or G3 membrane . Top coat - UV resistant flexible acrylic available in black,charcoal,core or red to employers

1. Roof pitch as indicated

0.8mm Profiled Sheetmetal Ridge Capping, Sealed to Manufacture spec(Chromadek)

- 3. Profiled roof sheeting on purlins.
- 4. 75x50mm S.A Pine Purlins at 700mm c/c on Timber
- Provide S.A.B.S Approved Waterproofing Membrane Above Roof Trusses acc to Manufacture's spec.
- 6. S.A Pine Roof Trusses at 1000mm c/c on Wall Plate. Treat All Exposed Timber with approved applicant to Manufacture 's Spec.
- 7. 114x38mm S.A Pine Timber Wall Plate.
- 8. 225x15mm Fibre Cement Fascia Board or Other Equal approved.
- 9. Ceiling Refer To Finishing Schedules.
- 10. Approved face brick with 5mm recessed raked joints.
- 11. Windows Refer to Window Schedules.
- 12. Door refer to Door schedule
- 13. Reinforced brickwork lintols reinforced with X2 6.4mm Ø steel bars horizontally with bentwire stirrups bedding in every third vertical joint along the length of the soldier course.
- 14. Skirting Refer to Finishing schedules.
- 15. Floor as per schedule on 40mm screed on concrete slab.
- 16. 85mm thick Concrete slab on S.A.B.S Approved termite poisoning USB Green water proofing Membrane to Engineer's details
- 17. S.A.B.S approved D.P.C to Manufacture Spec.
- 18. 75mm thick apron around building with expansion joints every 3m² width fall away from building.
- 19. Foundation to Engineers details and Approval.
- 20. Well compacted consolidated laterite hardcore by Engineer
- 21. Undisturbed Earth.
- 22. Provide Metal Flashing

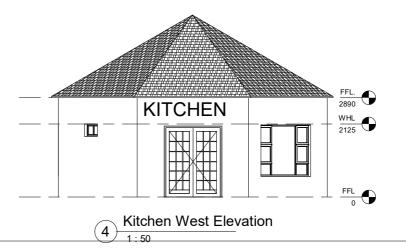

NOTES:

- ALL DIMENSIONS AND LEVELS ARE TO BE VERIFIED ON SITE PRIOR TO COMMENCING SETTING OUT WORKSHOP DRAWINGS OR CONSTRUCTION
- FIGURED DIMENSIONS ONLY TO BE USED.
- DISCREPANCIES, ERRORS AND DIMENSIONS ARE TO BE REPORTED TO THE ARCHITECT (EMPLOYER)
 .IMMEDIATELY THEY BECOME EVIDENT.
- SHPO DRAWINGS TO BE SUBMITTED FOR APPROVAL PRIOR TO MANUFACTURE OR INSTALLATION.
- COPY RIGHT AND RIGHT OF REPRODUCTION OF THIS DRAWINGS OR ANY PORTION THEREOF IS RESERVED BY PG ARCHITECTS.

	REFERENCE DRAWINGS	
	DRAWING NAME / TEKENING NAAM	No./Nr.
	REVISIONS/WYSIGINGS	
Wysiging		Datum
Revision	Beskrywing/Description	Date



-NELSPRUIT 25 Roods Street
Nelspruit, 1200
Phone: 0839992023
Fax: 086 662 8877
Vat: 476 027 7733
Email: patsonqs@gmail.com





Project Name:		Projek Naa
	SWILE MAVOKWENI GAME LODGE	
Drawing Name:		Tekening Naa

Elevation

JO48-DEA-200-01

Scale		Ontwerp	Anthony B.U.E.	Issi
	1 . 50	Geteken	Anthony B.U.E.	Issu
	1:50	Drawn	Antiliony B.O.L.	1000
		Nagesien	Checker	Issu
(Checked	Checker	1550

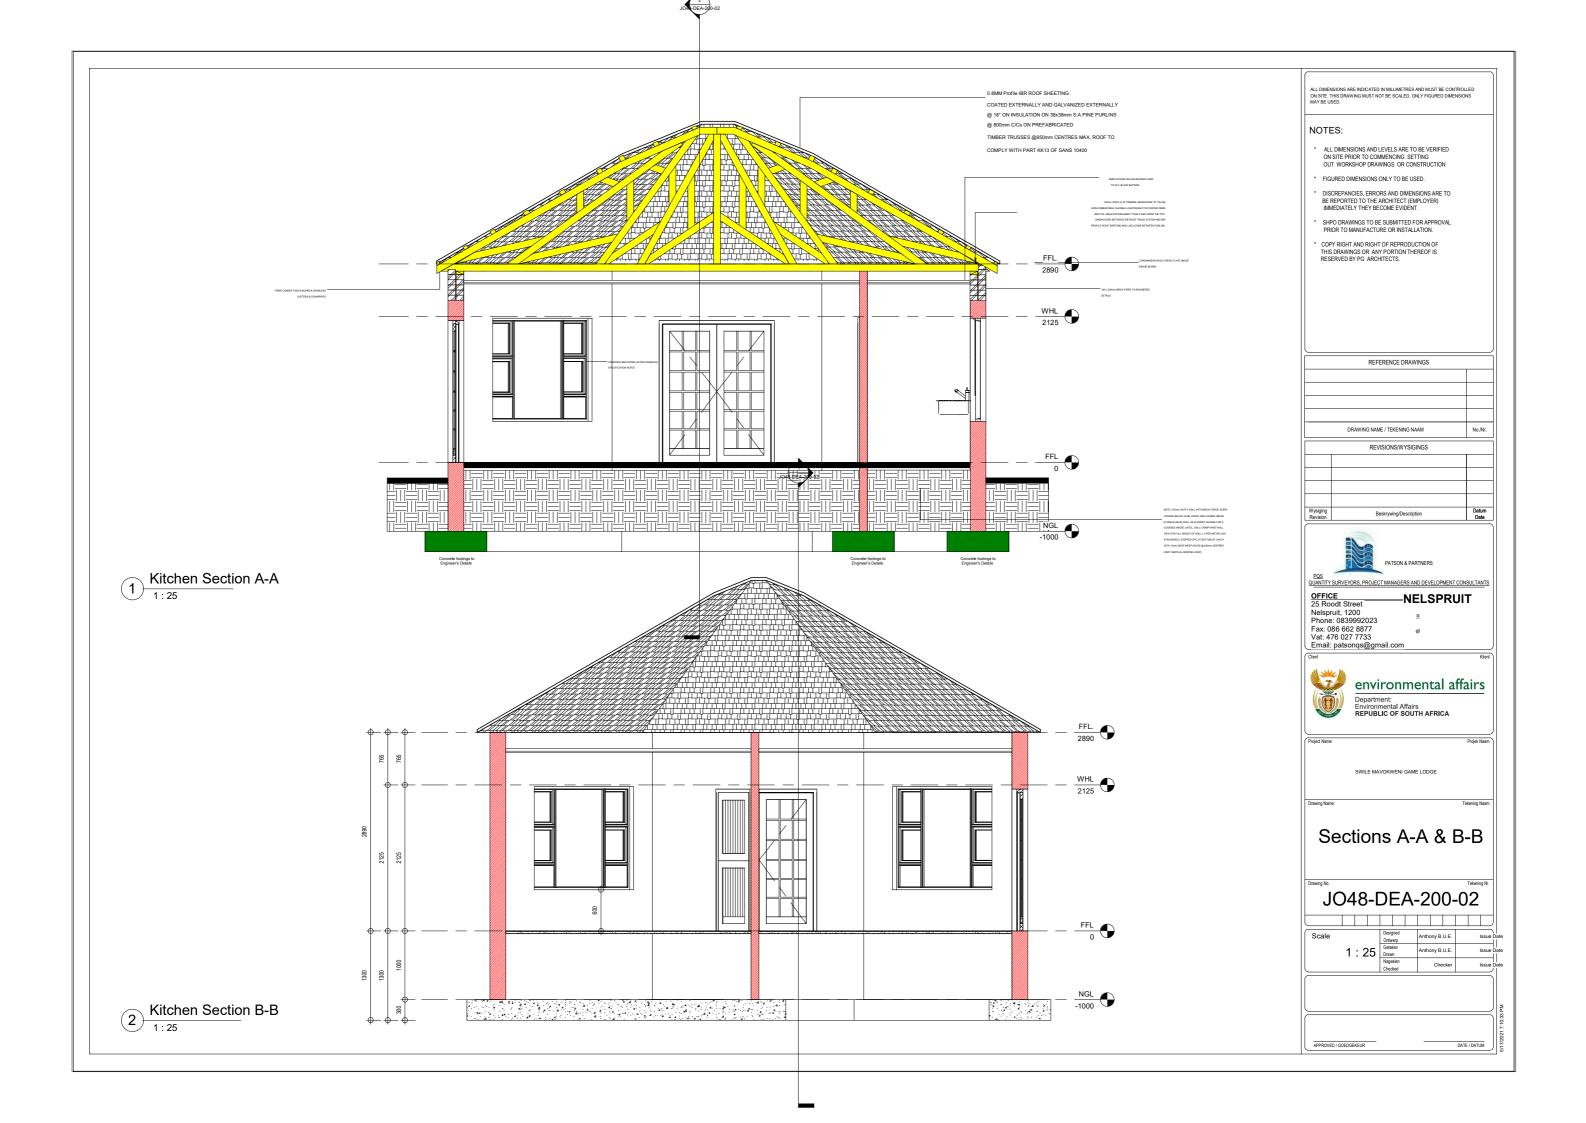

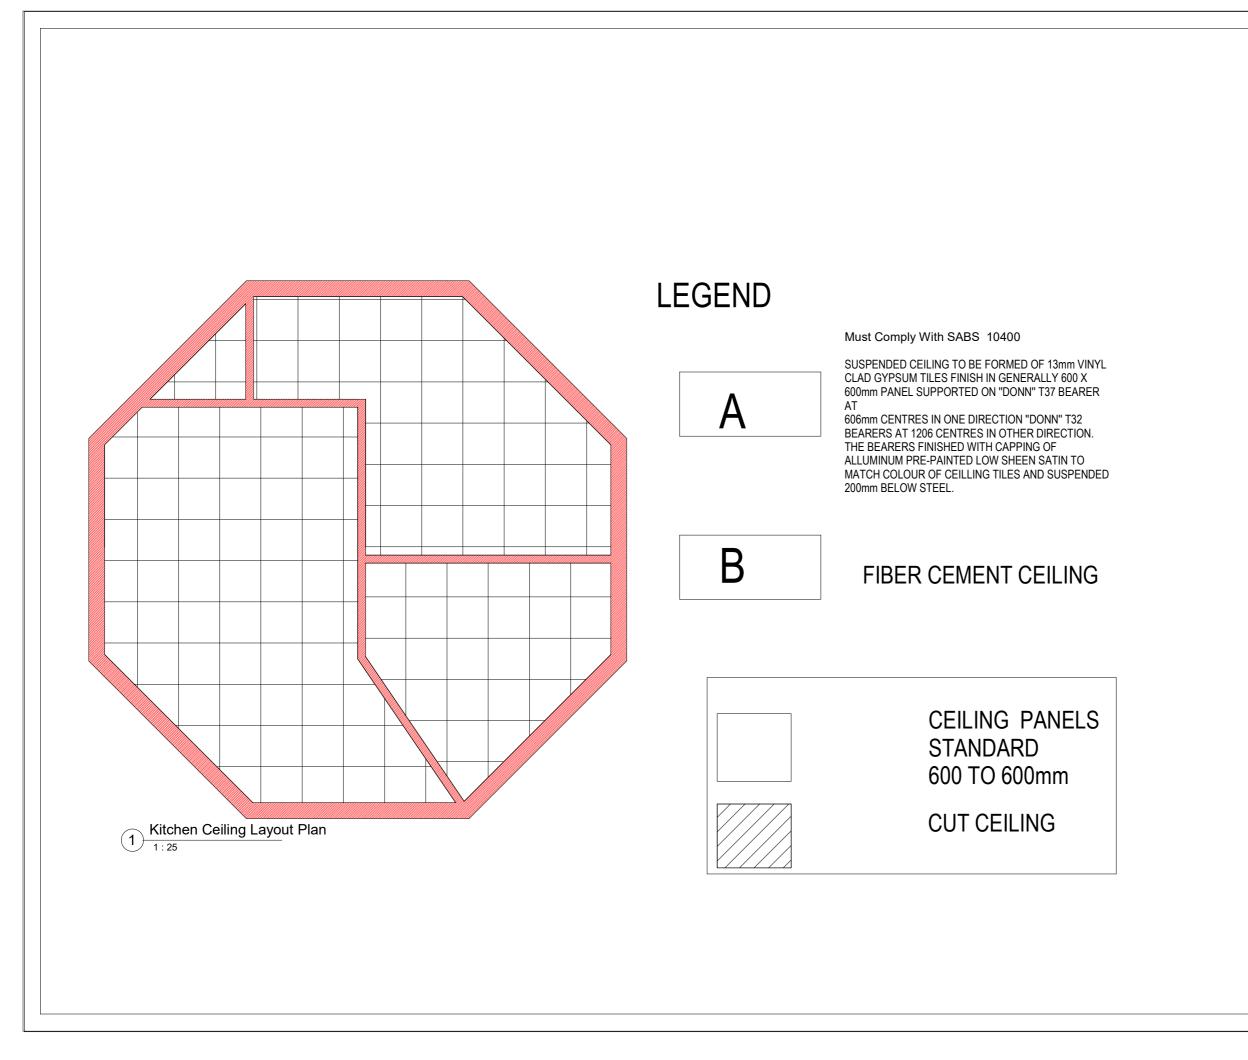

- ALL DIMENSIONS AND LEVELS ARE TO BE VERIFIED ON SITE PRIOR TO COMMENCING SETTING OUT WORKSHOP DRAWINGS OR CONSTRUCTION
- DISCREPANCIES. FRRORS AND DIMENSIONS ARE TO BE REPORTED TO THE ARCHITECT (EMPLOYER)
 .IMMEDIATELY THEY BECOME EVIDENT.
- SHPO DRAWINGS TO BE SUBMITTED FOR APPROVAL PRIOR TO MANUFACTURE OR INSTALLATION.
- COPY RIGHT AND RIGHT OF REPRODUCTION OF THIS DRAWINGS OR ANY PORTION THEREOF IS RESERVED BY PG ARCHITECTS.

	DRAWING NAME / TEKENING NAAM	No./Nr.
	REVISIONS/WYSIGINGS	
Wysiging Revision	Beskrywing/Description	Datum Date

REFERENCE DRAWINGS




OFFICE
25 Roodt Street
Nelspruit, 1200
Phone: 0839992023
Fax: 086 662 8877
Vat: 476 027 7733
Email: patsonqs@gmail.com -NELSPRUIT



Ceiling Layout Plan

JO48-DEA-300-01

1: 25

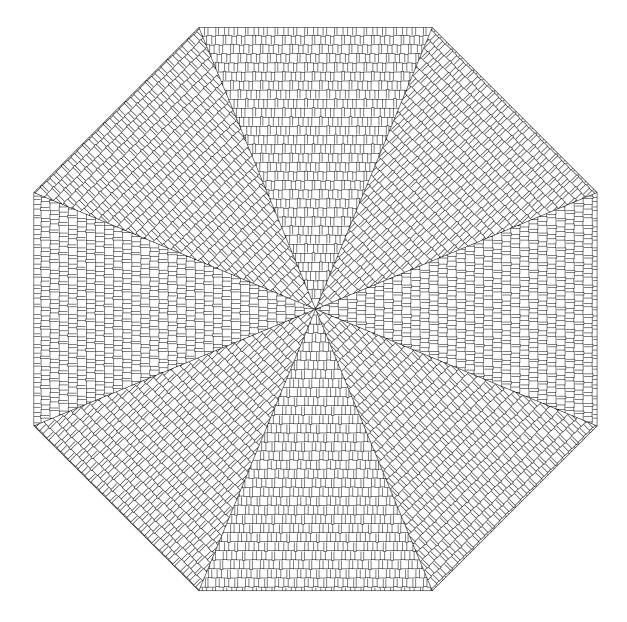

1. Fibre Cement Facia

2. Wood Float Plaster And Paint

3. Truss By Specialist

NOTES:

- ALL DIMENSIONS AND LEVELS ARE TO BE VERIFIED ON SITE PRIOR TO COMMENCING SETTING OUT WORKSHOP DRAWINGS OR CONSTRUCTION
- FIGURED DIMENSIONS ONLY TO BE USED.
- DISCREPANCIES. FRRORS AND DIMENSIONS ARE TO BE REPORTED TO THE ARCHITECT (EMPLOYER)
 .IMMEDIATELY THEY BECOME EVIDENT.
- SHPO DRAWINGS TO BE SUBMITTED FOR APPROVAL PRIOR TO MANUFACTURE OR INSTALLATION.
- COPY RIGHT AND RIGHT OF REPRODUCTION OF THIS DRAWINGS OR ANY PORTION THEREOF IS RESERVED BY PG ARCHITECTS.

	DRAWING NAME / TEKENING NAAM	No./Nr.
	REVISIONS/WYSIGINGS	
Wysiging Revision	Beskrywing/Description	Datum Date

REFERENCE DRAWINGS



-NELSPRUIT 25 Roodt Street Nelspruit, 1200 Phone: 0839992023 Fax: 086 662 8877 Vat: 476 027 7733 Email: patsonqs@gmail.com

environmental affairs


Department: Environmental Affairs REPUBLIC OF SOUTH AFRICA

Roof Layout Plan

JO48-DEA-300-02

1:25 Geteken Drawn Nagesien

Kitchen Roof Layout Plan

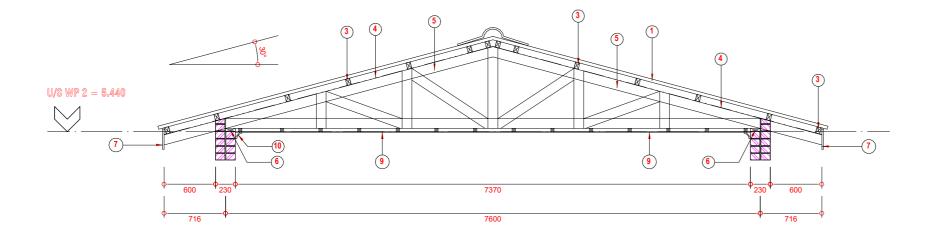

ROOF TRUSS TYPE "C" SCALE 1:20

Roof Truss Details

1:20

NOTES:

Sealant to be non woven polyester G2 or G3 membrane. Top coat - UV resistant flexible acrylic available in black, charcoal,core or red to employers choice.

- Profiled roof sheeting on 75x50mm
 SA pine purlins on prefabricated roof structure. treat all exposed timber with approved applicant.
- 2. Proved Fibre Cement Barge Boad
- 3. 75x50mm S.A pine Timber Purlins at 700mm c/c on timber trusses.
- 4. 0.5mm thick SABS Approved water proofing membane
- 114x38mm S.A pine Timber Trusses at 1200mm c/c on wall plate
- 6. 114x38mm S.A pine Timber wall plate
- 225x15mm Fibre cement fascia board or other equal approved
- 38x38mm S.A pine Timber Brandering at 450mm c/c minimum
- 9. 6mm thick Fibre cement ceiling to finishing schedule
- 10. Cornice to finishing schedule
- 11. Provide Head and Counter Metal Flashing
- 12. 152x89mm Timber Rafters, Roof Truss Members to Engineer's Details and Spec
- 13. Reinforced Concrete Gutter to Engineer's Details and Spec
- 14. 120x55mm Channel fixed to Details
- 15. Profiled roof sheeting

ALL DIMENSIONS ARE INDICATED IN MILLIMETRES AND MUST BE CONTROLLED ON SITE. THIS DRAWING MUST NOT BE SCALED. ONLY FIGURED DIMENSIONS MAY BE USED.

NOTES:

- ALL DIMENSIONS AND LEVELS ARE TO BE VERIFIED ON SITE PRIOR TO COMMENCING SETTING OUT WORKSHOP DRAWINGS OR CONSTRUCTION
- FIGURED DIMENSIONS ONLY TO BE USED.
- DISCREPANCIES, ERRORS AND DIMENSIONS ARE TO BE REPORTED TO THE ARCHITECT (EMPLOYER) .IMMEDIATELY THEY BECOME EVIDENT.
- * SHPO DRAWINGS TO BE SUBMITTED FOR APPROVAL PRIOR TO MANUFACTURE OR INSTALLATION.
- COPY RIGHT AND RIGHT OF REPRODUCTION OF THIS DRAWINGS OR ANY PORTION THEREOF IS RESERVED BY PG ARCHITECTS.

	REFERENCE DRAWINGS	
	DRAWING NAME / TEKENING NAAM	No./Nr.
	REVISIONS/WYSIGINGS	
Wysiging Revision	Beskrywing/Description	Datum Date



PATSON & PARTNE

QUANTITY SURVEYORS, PROJECT MANAGERS AND DEVELOPMENT CONSULTA

OFFICE NELSPRUIT
25 Roodt Street
Nelspruit, 1200
Phone: 0839992023
Fax: 086 662 8877
Vat: 476 027 7733
Email: patsonqs@gmail.com



ect Name:

SWILE MAVOKWENI GAME LOD

lame:

Roof Truss Details

Orawing No.


JO48-DEA-300-03

Scale

As indicated

| Designed | Contemp | Co

DATUM

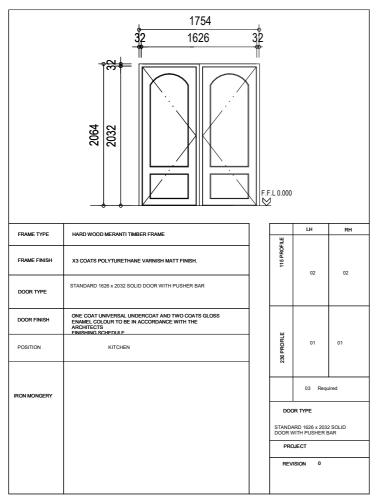

F.F.L 0.000 ⋈ FRAME TYPE HARD WOOD MERANTI TIMBER FRAME FRAME FINISH STANDARD 813 X 2032 X 44 mm. SOLID DOOR WITH 3mm MASIONATE BOTH SIDES AND CONCEALED EDGES COMPLETE FOR PAINT FINISH DOOR TYPE ONE COAT UNIVERSAL UNDERCOAT AND TWO COATS GLOSS ENAMEL COLOUR TO BE IN ACCORDANCE WITH THE ARCHITECTS ENISHING SCHEDULE DOOR FINISH IRON MONGERY

2064

877

813

LH RH

03 Ns Required

DOOR TYPE
STANDARD 813 X 2032 X 44 mm SOLID
DOOR WITH 3mm
MASIONATE BOTH SIDES AND
CONCEALE EDGES COMPLETE FOR
PAINT FINISH
PROJECT

DOOR TYPE

REVISION 0

Store Room Door Schedule 2 31016

ALL DIMENSIONS ARE INDICATED IN MILLIMETRES AND MUST BE CONTROLLED ON SITE. THIS DRAWING MUST NOT BE SCALED, ONLY FIGURED DIMENSIONS MAY BE USED.

NOTES:

- ALL DIMENSIONS AND LEVELS ARE TO BE VERIFIED ON SITE PRIOR TO COMMENCING SETTING OUT WORKSHOP DRAWINGS OR CONSTRUCTION
- * FIGURED DIMENSIONS ONLY TO BE USED.
- DISCREPANCIES, ERRORS AND DIMENSIONS ARE TO BE REPORTED TO THE ARCHITECT (EMPLOYER)
 .IMMEDIATELY THEY BECOME EVIDENT.
- SHPO DRAWINGS TO BE SUBMITTED FOR APPROVAL PRIOR TO MANUFACTURE OR INSTALLATION.
- COPY RIGHT AND RIGHT OF REPRODUCTION OF THIS DRAWINGS OR ANY PORTION THEREOF IS RESERVED BY PG ARCHITECTS.

	DRAWING NAME / TEKENING NAAM	No./Nr.
	REVISIONS/WYSIGINGS	
Wysiging Revision	Beskrywing/Description	Datum Date
	3	

REFERENCE DRAWINGS



OFFICE
25 Roodt Street
Nelspruit, 1200
Phone: 0839992023
Fax: 086 662 8877
Vat: 476 027 7733
Email: patsonqs@gmail.com

environmental affairs


Department:
Environmental Affairs
REPUBLIC OF SOUTH AFRICA

Door Schedule

JO48-DEA-300-04

1 : 25 Designed Ontwerp Anthony B.U.E. Geleken Drawn Anthony B.U.E. Nagesien Checker

Main Door Schedule 1:25

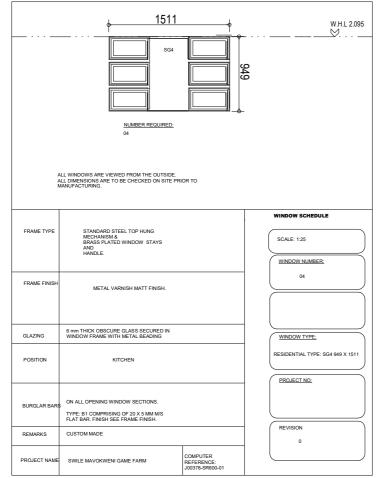

Main Window Schedule

1 IVIaii i

PROJECT NAME SWILE MAVOKWENI GAME FARM Toilet Window Schedule 2 1 Oller 1 : 25

GLAZING

POSITION

REMARKS

W.H.L 2.095 ALL WINDOWS ARE VIEWED FROM THE OUTSIDE.
ALL DIMENSIONS ARE TO BE CHECKED ON SITE PRIOR TO
MANUFACTURING. STANDARD STEEL TOP HUNG MECHANISM & BRASS PLATED WINDOW STAYS AND HANDLE. SCALE: 1:25 POS QUANTITY SURVEYORS, PROJECT MANAGERS AND DEVELOPMENT CONSULTANTS WINDOW NUMBER: METAL VARNISH MATT FINISH. 6 mm THICK OBSCURE GLASS SECURED IN WINDOW FRAME WITH METAL BEADING WINDOW TYPE: KITCHEN ON ALL OPENING WINDOW SECTIONS. TYPE: B1 COMPRISING OF 20 X 5 MM M/S FLAT BAR. FINISH SEE FRAME FINISH. REVISION CUSTOM MADE

ALL DIMENSIONS ARE INDICATED IN MILLIMETRES AND MUST BE CONTROLLED ON SITE. THIS DRAWING MUST NOT BE SCALED, ONLY FIGURED DIMENSIONS MAY BE USED.

NOTES:

- * ALL DIMENSIONS AND LEVELS ARE TO BE VERIFIED ON SITE PRIOR TO COMMENCING SETTING OUT WORKSHOP DRAWINGS OR CONSTRUCTION
- * FIGURED DIMENSIONS ONLY TO BE USED.
- DISCREPANCIES, ERRORS AND DIMENSIONS ARE TO BE REPORTED TO THE ARCHITECT (EMPLOYER)
 .IMMEDIATELY THEY BECOME EVIDENT.
- SHPO DRAWINGS TO BE SUBMITTED FOR APPROVAL PRIOR TO MANUFACTURE OR INSTALLATION.
- COPY RIGHT AND RIGHT OF REPRODUCTION OF THIS DRAWINGS OR ANY PORTION THEREOF IS RESERVED BY PG ARCHITECTS.

	DRAWING NAME / TEKENING NAAM	No./Nr.
	REVISIONS/WYSIGINGS	
Wysiging Revision	Beskrywing/Description	Datum Date



-NELSPRUIT

SWILE MAVOKWENI GAME LODGE

Window Schedule


JO48-DEA-300-05


1 : 25 Designed Ontwerp Anthony B.U.E. Geteken Drawn Anthony B.U.E. Nagesien Checker

SCHEDULE OF GUEST HOUSE 1

GUEST HOUSE 1: 164m²

BLOCK NAME	AREA m ²	FAR	COVERAGE
Guest House 1	164 m²		
Bedroom 1	20 m ²		
Bedroom 2	20 m ²		
Bedroom 3	20 m ²		
Bedroom 4	20 m ²		
Bedroom 5	20 m ²		
Toilet 1	3 m ²		
Toilet 2	3 m ²		
Toilet 3	3 m ²		
Toilet 4	3 m ²		
Toilet 5	3 m ²		

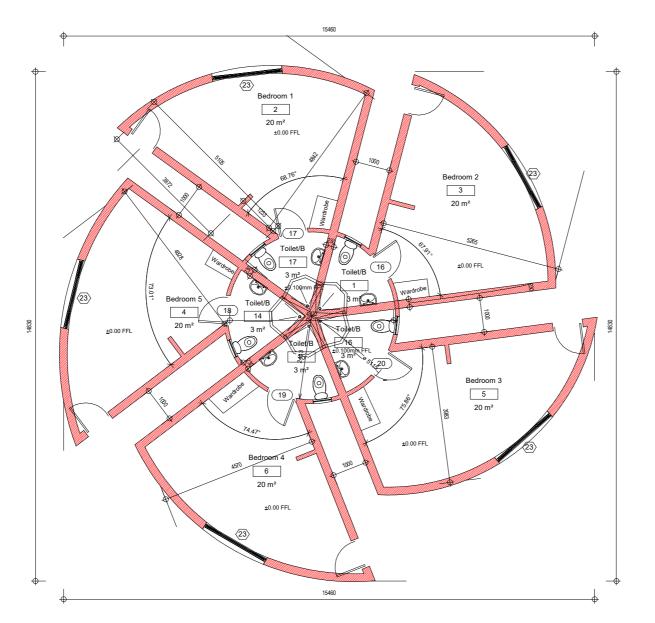

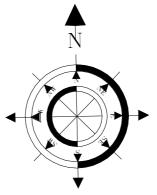

ALL DIMENSIONS ARE INDICATED IN MILLIMETRES AND MUST BE CONTR ON SITE. THIS DRAWING MUST NOT BE SCALED. ONLY FIGURED DIMENS MAY BE JUSTD.

NOTES:

- * ALL DIMENSIONS AND LEVELS ARE TO BE VERIFIED ON SITE PRIOR TO COMMENCING SETTING OUT WORKSHOP DRAWINGS OR CONSTRUCTION
- * FIGURED DIMENSIONS ONLY TO BE USED.
- * DISCREPANCIES, ERRORS AND DIMENSIONS ARE TO BE REPORTED TO THE ARCHITECT (EMPLOYER) .IMMEDIATELY THEY BECOME EVIDENT.
- * SHPO DRAWINGS TO BE SUBMITTED FOR APPROVAL PRIOR TO MANUFACTURE OR INSTALLATION.
- COPY RIGHT AND RIGHT OF REPRODUCTION OF THIS DRAWINGS OR ANY PORTION THEREOF IS RESERVED BY PG ARCHITECTS.

		REFERENCE DRA	WINGS	
	DF	AWING NAME / TEKENING	NAAM	No./Nr.
		REVISIONS/WYS	IGINGS	_
Wysiging Revision		Beskrywing/Descr	ription	Datum Date
OFFIC 25 Ro Nelspi Phone Fax: 0 Vat: 4	DE odt Str ruit, 12 e: 0839 086 662 76 027	eet 00 992023 8877		
Client	•	1-63		Klient
Client Project Name		Environm Department: Environmental Affa REPUBLIC OF SO	iirs	


Floor Layout Plan

J045-DEA-100-02

PPROVED / GOEDGEKEUR DATE / DATUM


Main Accomodation Floor

1 Layout Plan

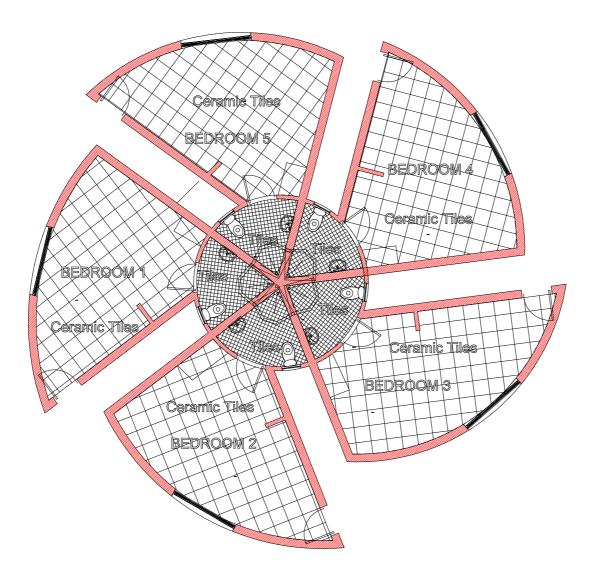

Main Accomodation Floor

1 Layout Plan 2

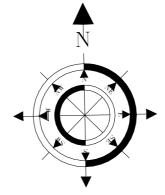

NOTES:

- ALL DIMENSIONS AND LEVELS ARE TO BE VERIFIED ON SITE PRIOR TO COMMENCING SETTING OUT WORKSHOP DRAWINGS OR CONSTRUCTION
- FIGURED DIMENSIONS ONLY TO BE USED.
- DISCREPANCIES, ERRORS AND DIMENSIONS ARE TO BE REPORTED TO THE ARCHITECT (EMPLOYER) .IMMEDIATELY THEY BECOME EVIDENT.
- SHPO DRAWINGS TO BE SUBMITTED FOR APPROVAL PRIOR TO MANUFACTURE OR INSTALLATION.
- COPY RIGHT AND RIGHT OF REPRODUCTION OF THIS DRAWINGS OR ANY PORTION THEREOF IS RESERVED BY PG ARCHITECTS.

	DRAWING NAME / TEKENING NAAM	No./Nr
	REVISIONS/WYSIGINGS	
Wysiging Revision	Beskrywing/Description	Datum Date




OFFICE
25 Roodt Street
Nelspruit, 1200
Phone: 0839992023
Fax: 086 662 8877
Vat: 476 027 7733
Email: patsonqs@gmail.com -NELSPRUIT

environmental affairs Department: Environmental Affairs REPUBLIC OF SOUTH AFRICA

Tiles Layout Plan

J045-DEA-100-01

1:50

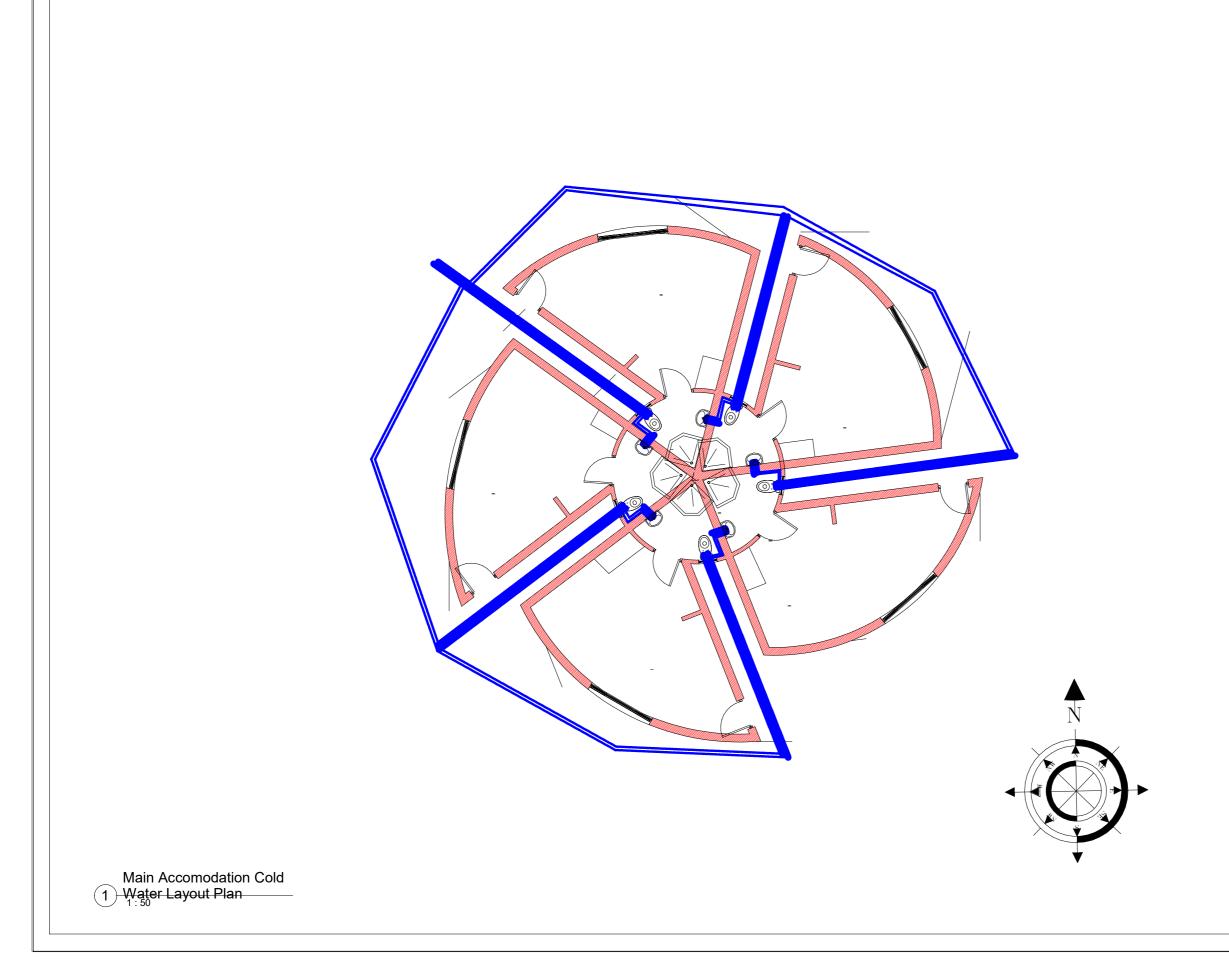

- ALL DIMENSIONS AND LEVELS ARE TO BE VERIFIED ON SITE PRIOR TO COMMENCING SETTING OUT WORKSHOP DRAWINGS OR CONSTRUCTION
- FIGURED DIMENSIONS ONLY TO BE USED.
- DISCREPANCIES, ERRORS AND DIMENSIONS ARE TO BE REPORTED TO THE ARCHITECT (EMPLOYER) .IMMEDIATELY THEY BECOME EVIDENT.
- SHPO DRAWINGS TO BE SUBMITTED FOR APPROVAL PRIOR TO MANUFACTURE OR INSTALLATION.
- COPY RIGHT AND RIGHT OF REPRODUCTION OF THIS DRAWINGS OR ANY PORTION THEREOF IS RESERVED BY PG ARCHITECTS.

	REFERENCE DRAWINGS	
	DRAWING NAME / TEKENING NAAM	No./Nr.
	REVISIONS/WYSIGINGS	
Wysiging Revision	Beskrywing/Description	Datum Date




OFFICE
25 Roodt Street
Nelspruit, 1200
Phone: 0839992023
Fax: 086 662 8877
Vat: 476 027 7733
Email: patsonqs@gmail.com -NELSPRUIT

environmental affairs Department: Environmental Affairs REPUBLIC OF SOUTH AFRICA

Floor Coled Water Layout Plan

J045-DEA-100-03

1:50 Designed Ontwerp Geteken Drawn Nagesien

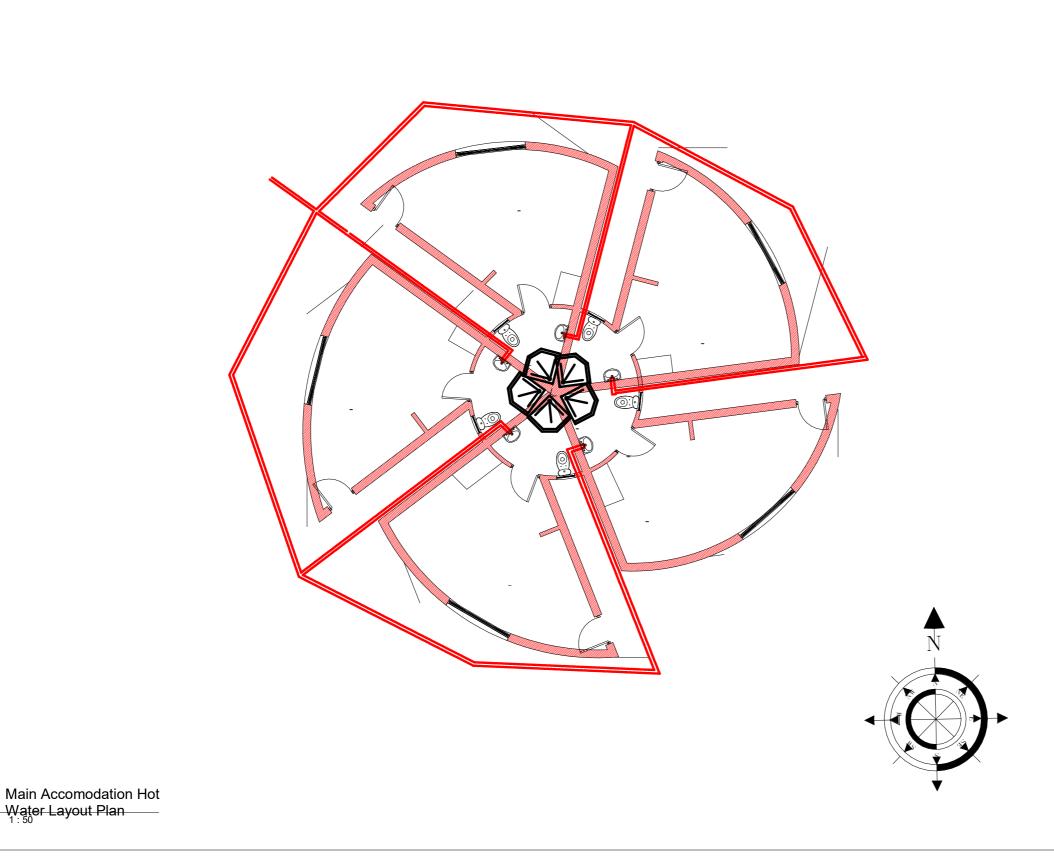

1) Water Layout Plan

NOTES:

- ALL DIMENSIONS AND LEVELS ARE TO BE VERIFIED ON SITE PRIOR TO COMMENCING SETTING OUT WORKSHOP DRAWINGS OR CONSTRUCTION
- DISCREPANCIES, ERRORS AND DIMENSIONS ARE TO BE REPORTED TO THE ARCHITECT (EMPLOYER) .IMMEDIATELY THEY BECOME EVIDENT.
- SHPO DRAWINGS TO BE SUBMITTED FOR APPROVAL PRIOR TO MANUFACTURE OR INSTALLATION.
- COPY RIGHT AND RIGHT OF REPRODUCTION OF THIS DRAWINGS OR ANY PORTION THEREOF IS RESERVED BY PG ARCHITECTS.

	DRAWING NAME / TEKENING NAAM	No./Nr
	REVISIONS/WYSIGINGS	
Wysiging Revision	Beskrywing/Description	Datum Date

REFERENCE DRAWINGS



OFFICE
25 Roodt Street
Nelspruit, 1200
Phone: 0839992023
Fax: 086 662 8877
Vat: 476 027 7733
Email: patsonqs@gmail.com -NELSPRUIT


environmental affairs

Department: Environmental Affairs REPUBLIC OF SOUTH AFRICA

Floor Hot Water Layout Plan

J045-DEA-100-04

1:50 Designed Ontwerp Geteken Drawn Nagesien

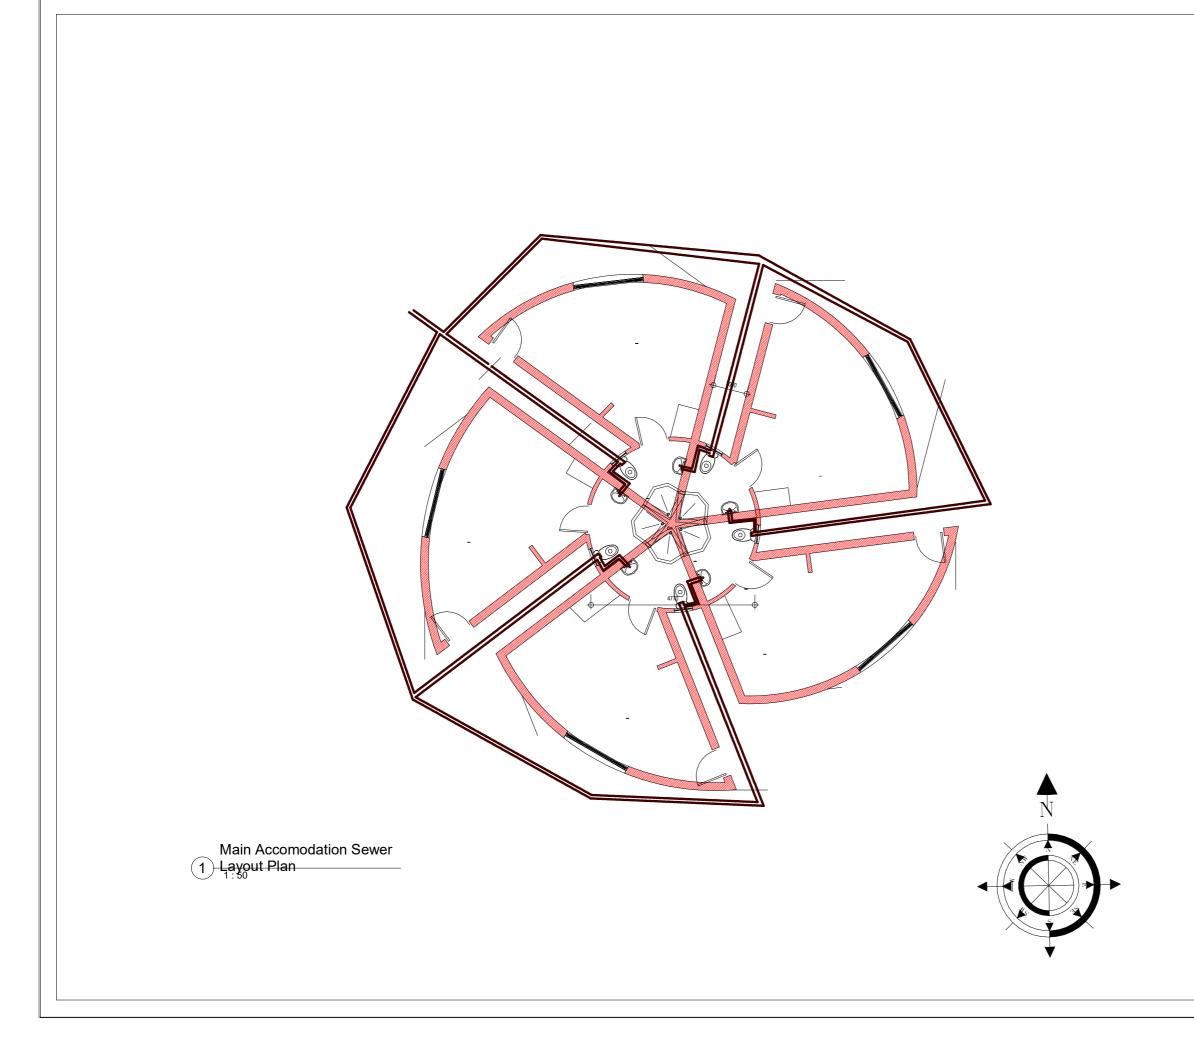

- ALL DIMENSIONS AND LEVELS ARE TO BE VERIFIED ON SITE PRIOR TO COMMENCING SETTING OUT WORKSHOP DRAWINGS OR CONSTRUCTION
- FIGURED DIMENSIONS ONLY TO BE USED.
- DISCREPANCIES, ERRORS AND DIMENSIONS ARE TO BE REPORTED TO THE ARCHITECT (EMPLOYER) .IMMEDIATELY THEY BECOME EVIDENT.
- SHPO DRAWINGS TO BE SUBMITTED FOR APPROVAL PRIOR TO MANUFACTURE OR INSTALLATION.
- COPY RIGHT AND RIGHT OF REPRODUCTION OF THIS DRAWINGS OR ANY PORTION THEREOF IS RESERVED BY PG ARCHITECTS.

	REFERENCE DRAWINGS	
	DRAWING NAME / TEKENING NAAM	No./Nr
	REVISIONS/WYSIGINGS	
Wysiging Revision	Beskrywing/Description	Datum Date



OFFICE 25 Roodt Street Nelspruit, 1200 Phone: 0839992023 Fax: 086 662 8877 Vat: 476 027 7733 Email: patsonqs@gmail.com -NELSPRUIT

environmental affairs Department: Environmental Affairs REPUBLIC OF SOUTH AFRICA


Floow Sewer Layout Plan


J045-DEA-100-05


Designed Ontwerp Anthony, B.U.E.

Ontwerp Anthony, B.U.E.

Geleken Anthony, B.U.E.
Nagesien Ontwerp Anthony, B.U.E.

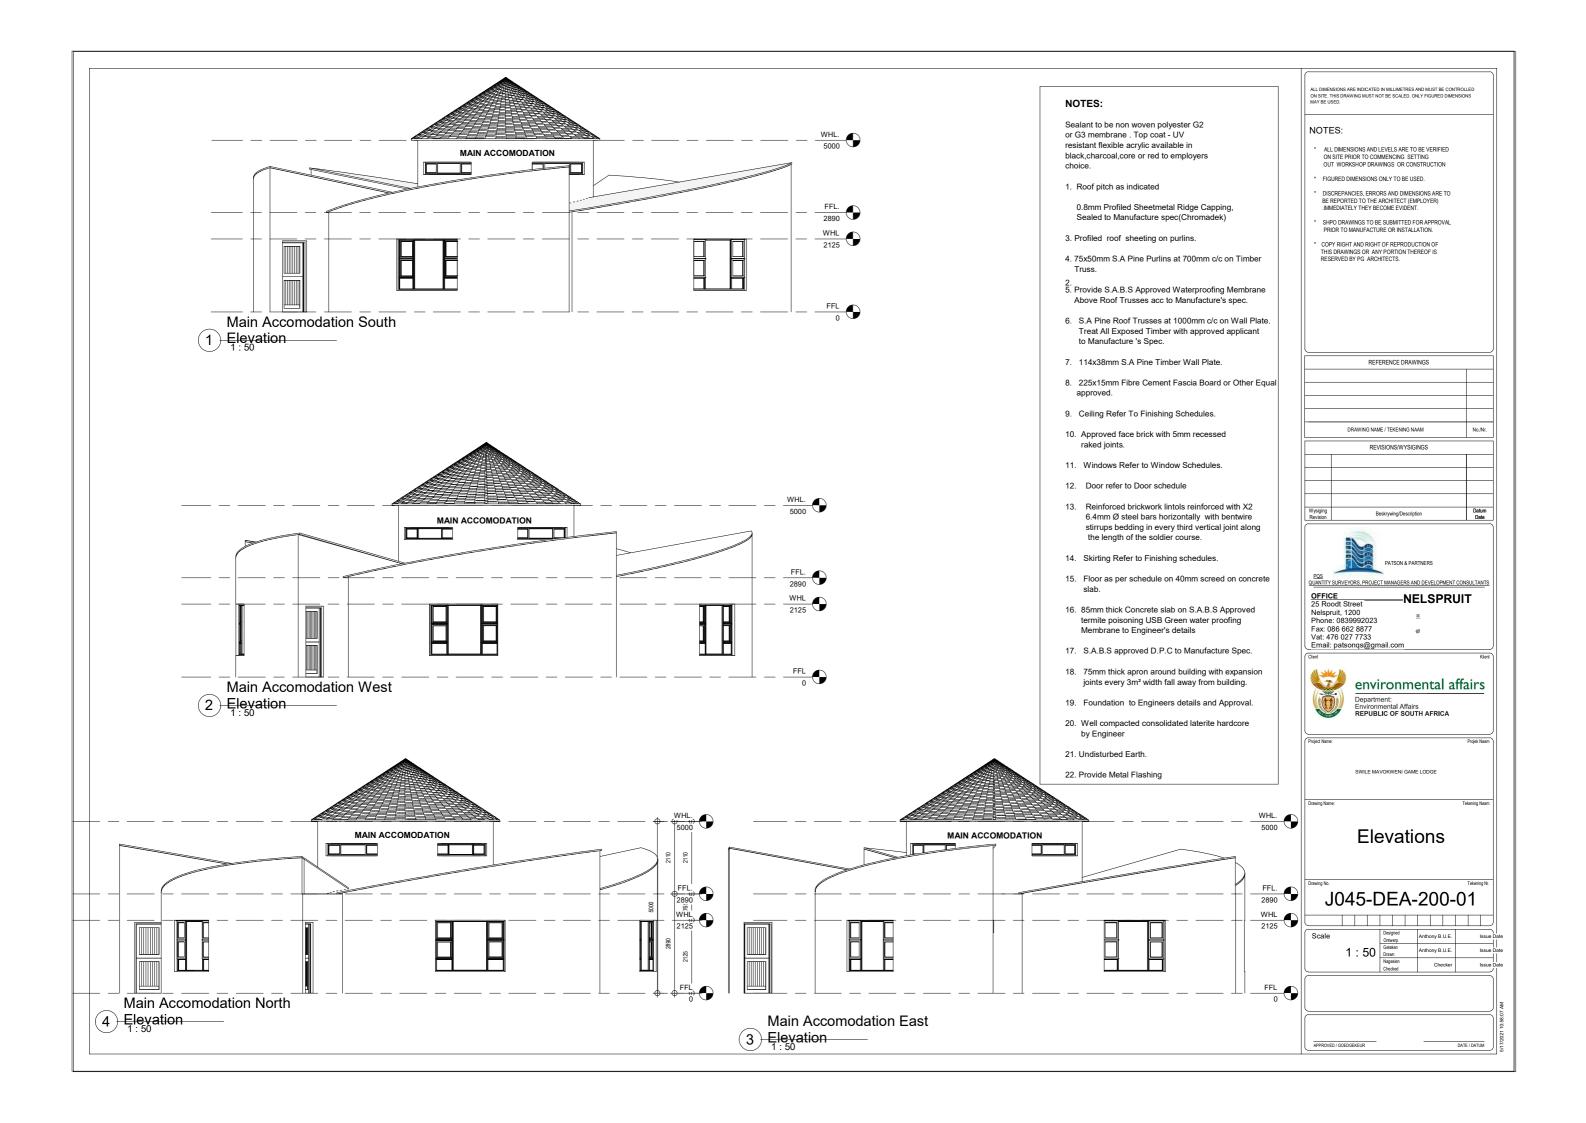

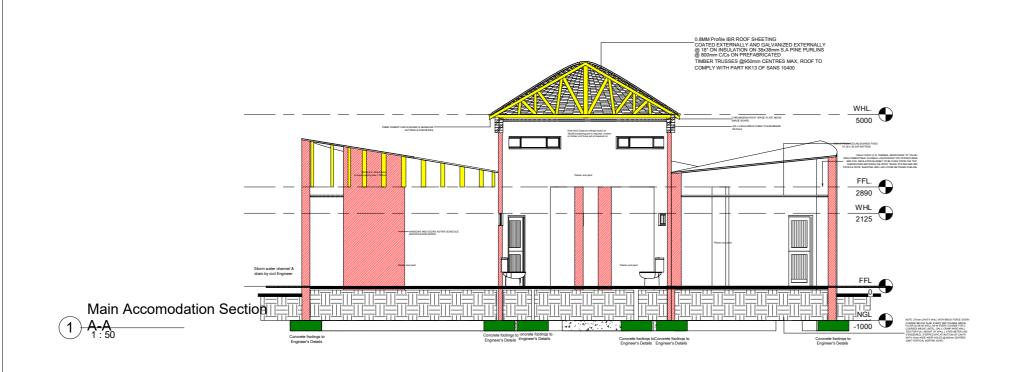

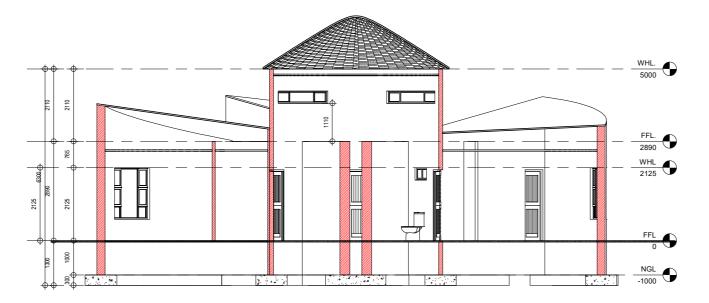

Main Accomodation Section

2 B-B 1:50

NOTES:

- ALL DIMENSIONS AND LEVELS ARE TO BE VERIFIED ON SITE PRIOR TO COMMENCING SETTING OUT WORKSHOP DRAWINGS OR CONSTRUCTION
- FIGURED DIMENSIONS ONLY TO BE USED.
- DISCREPANCIES, ERRORS AND DIMENSIONS ARE TO BE REPORTED TO THE ARCHITECT (EMPLOYER)
 .IMMEDIATELY THEY BECOME EVIDENT.
- SHPO DRAWINGS TO BE SUBMITTED FOR APPROVAL PRIOR TO MANUFACTURE OR INSTALLATION.
- COPY RIGHT AND RIGHT OF REPRODUCTION OF THIS DRAWINGS OR ANY PORTION THEREOF IS RESERVED BY PG ARCHITECTS.

	DRAWING NAME / TEKENING NAAM	No./Nr.
	REVISIONS/WYSIGINGS	
Wysiging Revision	Beskrywing/Description	Datum Date

REFERENCE DRAWINGS




OFFICE Nelspruit, 1200
Phone: 0839992023
Fax: 086 662 8877
Vat: 476 027 7733
Email: patsong@gmail.com -NELSPRUIT



Sections A-A & B-B

J045-DEA-200-02

1 : 50 Designed Ontwerp Anthony B.U.E. Geteken Desay Anthony B.U.E. Nagesien

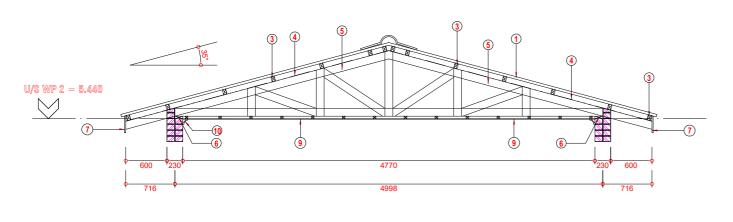

ROOF TRUSS TYPE "C" SCALE 1:25

Main Accomodation Higher 1 Roof Truss Details

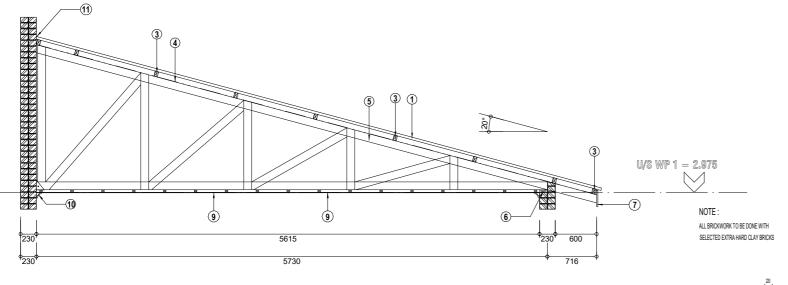


TABLE FOR SEPTIC TANK SIZE

ONS				С	D	Е	G	Н
NUMBER OF PERSONS	CHURCH	HOUSE/HOSTEL	HOSPITAL BEDS	WATER DEPTH	TOTAL DEPTH	ВКЕАОТН	LENGTH	LENGTH
開	500	46	18	1500	1 900	2 500	1 700	3 400
	1000	50	20	2 000	2 400	2 200	2 000	3 500

NOTES:

Sealant to be non woven polyester G2 or G3 membrane Top coat - UV resistant flexible acrylic available in black,

SA pine purlins on prefabricated roof structure. treat all exposed timber with approved applicant.

4. 0.5mm thick SABS Approved water proofing membane

8. 38x38mm S.A pine Timber Brandering at 450mm c/c

9. 6mm thick Fibre cement ceiling to finishing schedule

13. Reinforced Concrete Gutter to Engineer's Details and

11. Provide Head and Counter Metal Flashing

12. 152x89mm Timber Rafters, Roof Truss Members to Engineer's Details and Spec

14. 120x55mm Channel fixed to Details

15. Profiled roof sheeting

10. Cornice to finishing schedule

charcoal,core or red to employers choice.

1. Profiled roof sheeting on 75x50mm

2. Proved Fibre Cement Barge Boad


3. 75x50mm S.A pine Timber Purlins at 700mm

5. 114x38mm S.A pine Timber Trusses at 1200mm c/c on wall plate 6. 114x38mm S.A pine Timber wall plate 7. 225x15mm Fibre cement fascia board or other equal approved

ROOF TRUSS TYPE II MII

SCALE 1:25

Main Accomodation Lower 2 Roof Truss Details

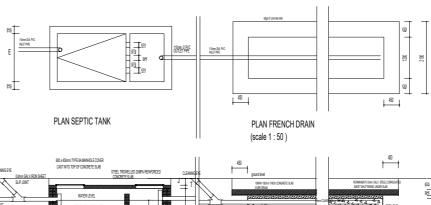

Septic Tank

NOTES:

- ALL DIMENSIONS AND LEVELS ARE TO BE VERIFIED ON SITE PRIOR TO COMMENCING SETTING OUT WORKSHOP DRAWINGS OR CONSTRUCTION
- FIGURED DIMENSIONS ONLY TO BE USED.
- DISCREPANCIES, ERRORS AND DIMENSIONS ARE TO BE REPORTED TO THE ARCHITECT (EMPLOYER)
 .IMMEDIATELY THEY BECOME EVIDENT.
- SHPO DRAWINGS TO BE SUBMITTED FOR APPROVAL PRIOR TO MANUFACTURE OR INSTALLATION.
- COPY RIGHT AND RIGHT OF REPRODUCTION OF THIS DRAWINGS OR ANY PORTION THEREOF IS RESERVED BY PG ARCHITECTS.

	REFERENCE DRAWINGS	
	DRAWING NAME / TEKENING NAAM	No./I
	REVISIONS/WYSIGINGS	<u>'</u>
Wysiging Revision	Beskrywing/Description	Dati Da



-NELSPRUIT

25 Roodt Street Nelspruit, 1200 Phone: 0839992023 Fax: 086 662 8877 Vat: 476 027 7733 Email: patsonqs@gmail.com

environmental affairs Department: Environmental Affairs REPUBLIC OF SOUTH AFRICA


Roof Truss Details & Septic Tank

J045-DEA-300-01

Scale	Designed Ontwerp		Antho	ny B.I	J.E.	Issi
As indicated	Geteken Drawn		Anthony B.U.E.		Issu	
	Nagesien Checked			Chec	ker	Issi

SECTION THROUGH SEPTIC TANK

SECTION THROUGH FRENCH DRAIN

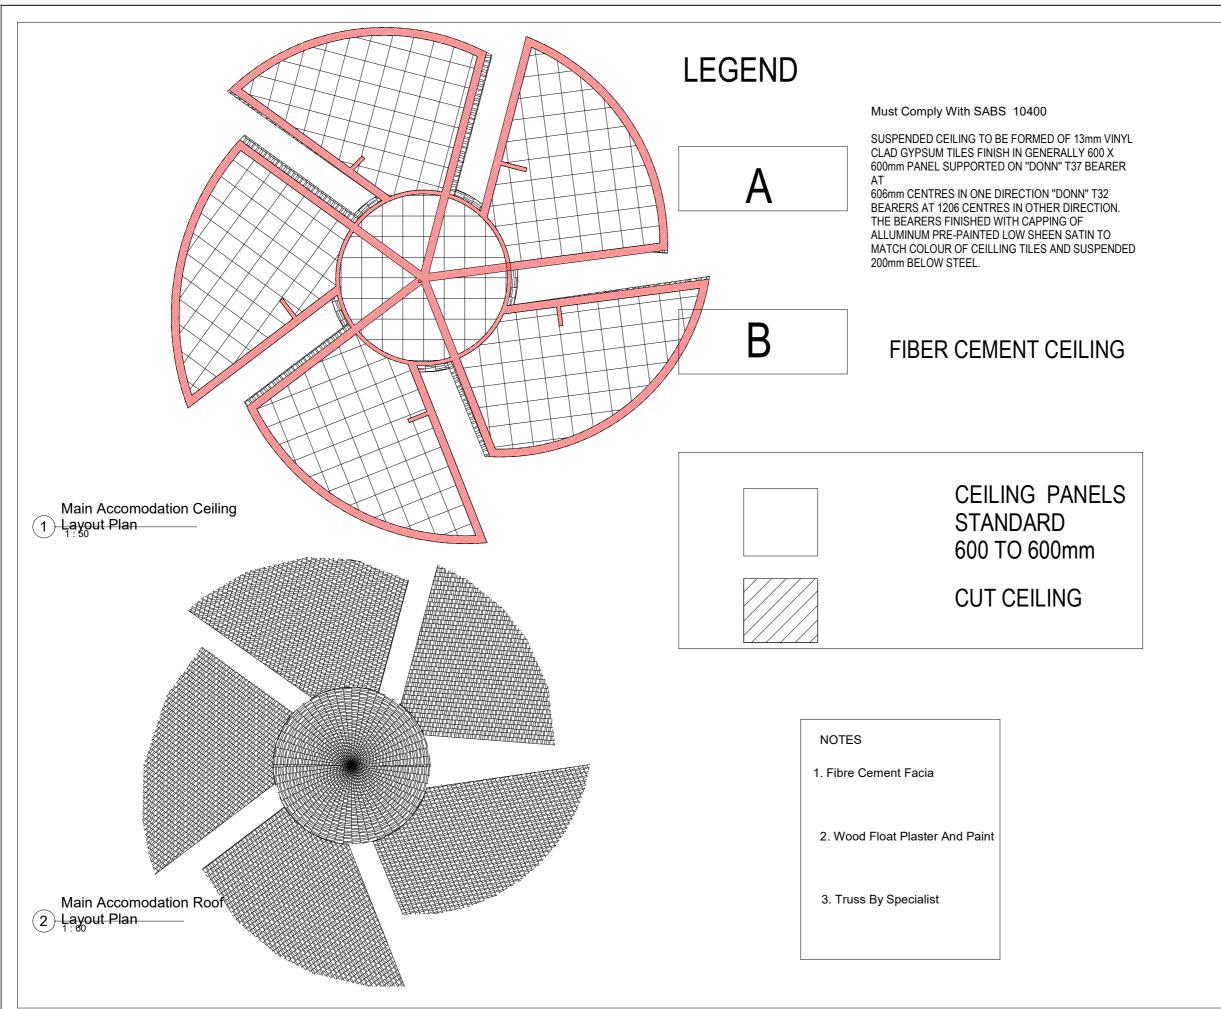

ALL DIMENSIONS ARE INDICATED IN MILLIMETRES AND MUST BE CONTROLLE!
ON SITE. THIS DRAWING MUST NOT BE SCALED. ONLY FIGURED DIMENSIONS
MAY BE USED.

NOTES:

- ALL DIMENSIONS AND LEVELS ARE TO BE VERIFIED ON SITE PRIOR TO COMMENCING SETTING OUT WORKSHOP DRAWINGS OR CONSTRUCTION
- * FIGURED DIMENSIONS ONLY TO BE USE
- DISCREPANCIES, ERRORS AND DIMENSIONS ARE TO BE REPORTED TO THE ARCHITECT (EMPLOYER) .IMMEDIATELY THEY BECOME EVIDENT.
- * SHPO DRAWINGS TO BE SUBMITTED FOR APPROVAL PRIOR TO MANUFACTURE OR INSTALLATION.
- COPY RIGHT AND RIGHT OF REPRODUCTION OF THIS DRAWINGS OR ANY PORTION THEREOF IS RESERVED BY PG ARCHITECTS.

	REFERENCE DRAWINGS	
	DRAWING NAME / TEKENING NAAM	No./Nr.
	REVISIONS/WYSIGINGS	
Wysiging Revision	Beskrywing/Description	Datum Date

OFFICE
DFFICE
SROOdt Street
Nelspruit, 1200
Phone: 0839992023
Fax: 086 662 8877
Vat: 476 027 7733
Email: patsonqs@gmail.com

Clert Klert

environmental affairs

Department:
Environmental Affairs
REPUBLIC OF SOUTH AFRICA

Project Name: Projek
SWILE MAVOKWENI GAME LODGE


Ceiling & Roof layout Plan


J045-DEA-300-02

Scale
As indicated

Designed Anthony B.U.E. Issue Da Geliëken Checker Issue Da Nathony B.U.E. Issue Da Checker Checker Issue Da Checker Issue Da Checker Checker Issue Da Checke

PROVED / GOEDGEKEUR DATE / DATUM

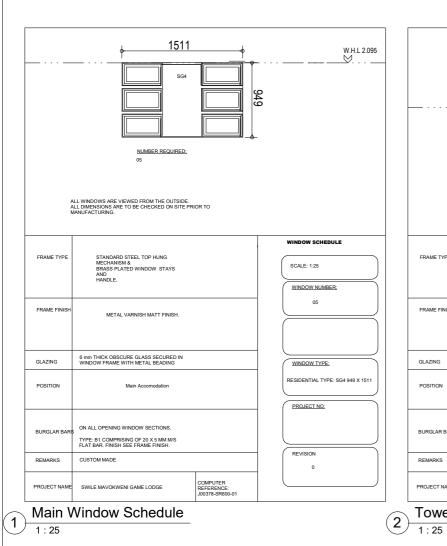

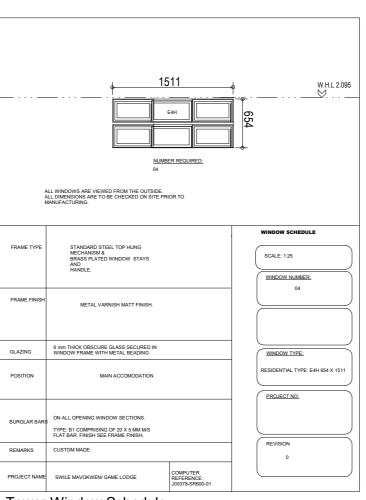

ALL WINDOWS ARE VIEWED FROM THE CUTSIDE
ALL DIMENSIONS ARE VIEWED FROM THE CUTSIDE
ALL DIMENSIONS ARE TO BE CHECKED ON SITE PRIOR TO

MANUFACTURING.

FRAME TYPE

STANDARD STEEL TOP HUNG
MECHANISM &
BRASS PLATED WINDOW STAYS
AND
NO
HANGLE

FRAME FRISH

METAL VARNISH MATT FRISH.

GLAZING

G mm THICK OBSCURE GLASS SECURED IN
WINDOW FRAME WITH METAL BEADING

POSITION

MAIN ACCOMMODATION

BURGLAR BARS
ON ALL OPENING WINDOW SECTIONS.
TYPE: BI COMPRISING OF 20 X 5 MM MGS
FLAT BAR FRISH SEE FRAME FRISH.

REMARKS

CUSTOM MADE

PROJECT NAME

SWILE MAVOKWENI GAME LODGE

COMPUTER
REFERENCE.

COMPUTER
R


Toilet Window


Tower Window Schedule

ALL DIMENSIONS ARE INDICATED IN MILLIMETRES AND MUST BE CONTROLLED ON SITE. THIS DRAWING MUST NOT BE SCALED. ONLY FIGURED DIMENSIONS MAY BE USED. NOTES: * ALL DIMENSIONS AND LEVELS ARE TO BE VERIFIED ON SITE PRIOR TO COMMENCING SETTING OUT WORKSHOP DRAWINGS OR CONSTRUCTION * FIGURED DIMENSIONS ONLY TO BE USED. DISCREPANCIES, ERRORS AND DIMENSIONS ARE TO BE REPORTED TO THE ARCHITECT (EMPLOYER)
.IMMEDIATELY THEY BECOME EVIDENT. SHPO DRAWINGS TO BE SUBMITTED FOR APPROVAL PRIOR TO MANUFACTURE OR INSTALLATION. COPY RIGHT AND RIGHT OF REPRODUCTION OF THIS DRAWINGS OR ANY PORTION THEREOF IS RESERVED BY PG ARCHITECTS. REFERENCE DRAWINGS DRAWING NAME / TEKENING NAAM No./Nr. REVISIONS/WYSIGINGS Wysiging Revision Beskrywing/Description PQS QUANTITY SURVEYORS, PROJECT MANAGERS AND DEVELOPMENT CONSULTANTS -NELSPRUIT 25 Roods Street
Nelspruit, 1200
Phone: 0839992023
Fax: 086 662 8877
Vat: 476 027 7733
Email: patsonqs@gmail.com environmental affairs

Department:
Environmental Affairs
REPUBLIC OF SOUTH AFRICA SWILE MAVOKWENI GAME LODGE Window Schedule J045-DEA-300-03 1 : 25 Designed Ontwerp Anthony B.U.E.

Ontwerp Anthony B.U.E.
Drawn Anthony B.U.E.
Nagesien Chapter

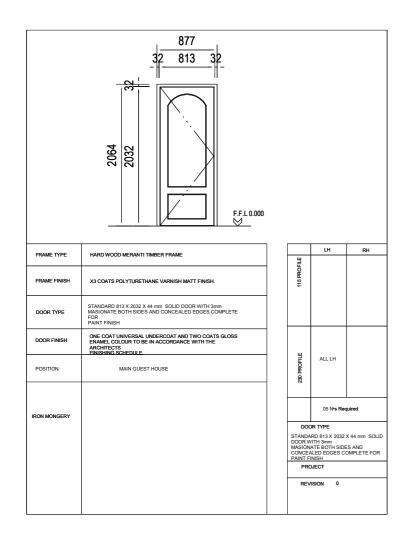

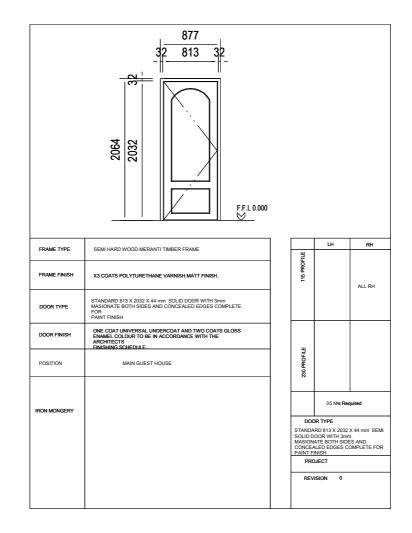

Room Door Schedule 2 Room 1:25

Toilet Door Schedule

ALL DIMENSIONS ARE INDICATED IN MILLIMETRES AND MUST BE CONTROLLED ON SITE. THIS DRAWING MUST NOT BE SCALED. ONLY FIGURED DIMENSIONS MAY BE USED.

NOTES:

- ALL DIMENSIONS AND LEVELS ARE TO BE VERIFIED ON SITE PRIOR TO COMMENCING SETTING OUT WORKSHOP DRAWINGS OR CONSTRUCTION
- * FIGURED DIMENSIONS ONLY TO BE USED.
- DISCREPANCIES, ERRORS AND DIMENSIONS ARE TO BE REPORTED TO THE ARCHITECT (EMPLOYER)
 .IMMEDIATELY THEY BECOME EVIDENT.
- SHPO DRAWINGS TO BE SUBMITTED FOR APPROVAL PRIOR TO MANUFACTURE OR INSTALLATION.
- COPY RIGHT AND RIGHT OF REPRODUCTION OF THIS DRAWINGS OR ANY PORTION THEREOF IS RESERVED BY PG ARCHITECTS.

	DANIELO MARE L'ESCENDIO MARA	
	RAWING NAME / TEKENING NAAM	No./Nr.
	REVISIONS/WYSIGINGS	1
Wysiging Revision	Beskrywing/Description	Datum Date

REFERENCE DRAWINGS



POS QUANTITY SURVEYORS, PROJECT MANAGERS AND DEVELOPMENT CONSULTANTS

-NELSPRUIT

Door Schedule


J045-DEA-300-04

1 : 25 Designed Ontwerp Anthony B.U.E. Geleken Drawn Anthony B.U.E. Nagesien Chapter

OFFICE BLOCK


OFFICE BLOCK: 108m²

BLOCK NAME	AREA m ²	FAR	COVERAGE
OFFICE BLOCK	108 m ²		
Office 1	11 m ²		
Office 2	11 m ²		
passage 1	6 m ²		
Passage 2	6 m ²		
Male Toilet 1	1 m ²		
Mail Toilet 2	1 m ²		
FemaleToilet 1	1 m ²		
Female Toilet 2	1 m ²		
Urinary Area	5 m ²		
Wash-hand Area	5 m ²		
Boardroom	40 m ²		
Kitchenette	7 m ²		

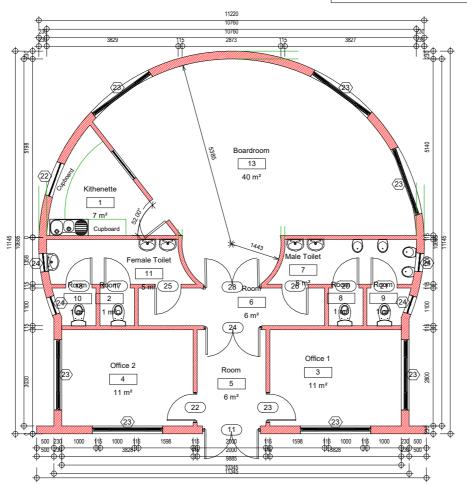

Office/Boardroom Floor

1 Layout Plan

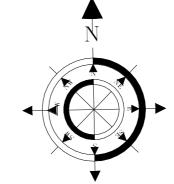

ALL DIMENSIONS ARE INDICATED IN MILLIMETRES AND MUST BE CONTRY
ON SITE. THIS DRAWING MUST NOT BE SCALED. ONLY FIGURED DIMENSI
MAY BE USED.

NOTES:

- * ALL DIMENSIONS AND LEVELS ARE TO BE VERIFIED ON SITE PRIOR TO COMMENCING SETTING OUT WORKSHOP DRAWINGS OR CONSTRUCTION
- * FIGURED DIMENSIONS ONLY TO BE USED.
- * DISCREPANCIES, ERRORS AND DIMENSIONS ARE TO BE REPORTED TO THE ARCHITECT (EMPLOYER) .IMMEDIATELY THEY BECOME EVIDENT.
- * SHPO DRAWINGS TO BE SUBMITTED FOR APPROVAL PRIOR TO MANUFACTURE OR INSTALLATION.
- COPY RIGHT AND RIGHT OF REPRODUCTION OF THIS DRAWINGS OR ANY PORTION THEREOF IS RESERVED BY PG ARCHITECTS.

	REFERENCE DRAWINGS	
	DRAWING NAME / TEKENING NAAM	No./Nr.
	REVISIONS/WYSIGINGS	
Wysiging Revision	Beskrywing/Description	Datum Date



PATSON & PARTNERS

TITTY SURVEYORS, PROJECT MANAGERS AND DEVELOPMENT CONSULTAN

OFFICE NELSPRUIT
25 Roodt Street
Nelspruit, 1200
Phone: 0839992023
Fax: 086 662 8877
Vat: 476 027 7733
Email: patsonqs@gmail.com

. h.




SWILE MAYOKWENI GAME LODGE

Floor Layout Plan

JO47-DEA-100-02

Scale Designed Anthony B.U.E. Issue D. Geteken Anthony B.U.E. Issue D. Geteken Anthony B.U.E. Issue D. Geteken Nagesien Checker Issue D. Checked Checker Issue D. Checker Issue

PPROVED / GOEDGEKEUR DATE / DATUM

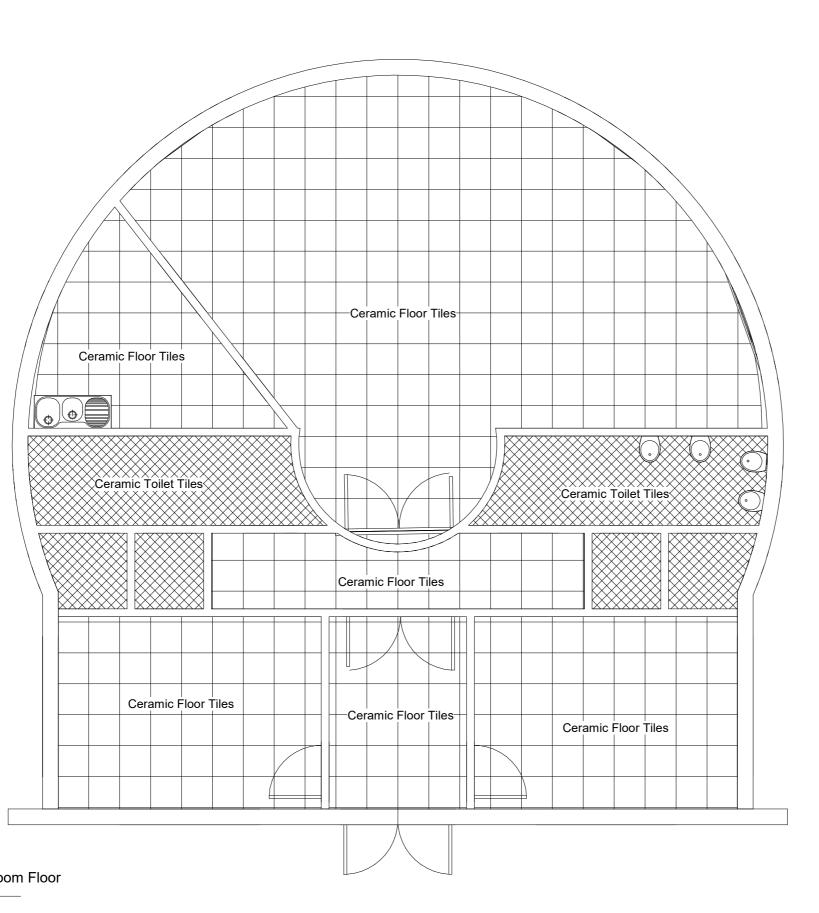

ALL DIMENSIONS ARE INDICATED IN MILLIMETRES AND MUST BE CONTROLLED ON SITE. THIS DRAWING MUST NOT BE SCALED. ONLY FIGURED DIMENSIONS MAY BE USED.

NOTES:

- * ALL DIMENSIONS AND LEVELS ARE TO BE VERIFIED ON SITE PRIOR TO COMMENCING SETTING OUT WORKSHOP DRAWINGS OR CONSTRUCTION
- * FIGURED DIMENSIONS ONLY TO BE USED.
- DISCREPANCIES, ERRORS AND DIMENSIONS ARE TO BE REPORTED TO THE ARCHITECT (EMPLOYER) .IMMEDIATELY THEY BECOME EVIDENT.
- SHPO DRAWINGS TO BE SUBMITTED FOR APPROVAL PRIOR TO MANUFACTURE OR INSTALLATION.
- COPY RIGHT AND RIGHT OF REPRODUCTION OF THIS DRAWINGS OR ANY PORTION THEREOF IS RESERVED BY PG ARCHITECTS.

	REFERENCE DRAWINGS	
	DRAWING NAME / TEKENING NAAM	No./N
	REVISIONS/WYSIGINGS	
Wysiging Revision	Beskrywing/Description	Datur Date



OFFICE Nelspruit, 1200
Phone: 0839992023
Fax: 086 662 8877
Vat: 476 027 7733
Email: patsongs@gmail.com -NELSPRUIT

environmental affairs

Department:
Environmental Affairs
REPUBLIC OF SOUTH AFRICA


Department:
Environmental Affairs
REPUBLIC OF SOUTH AFRICA


Site Layout Plan


JO47-DEA-100-01

Scale Designed Ordewep Anthony B.U.E. Gedelen Desam Anthony B.U.E. Desam Anthony B.U.E. Desam Chapter

Office/Boardroom Floor 1 Tiles Layout

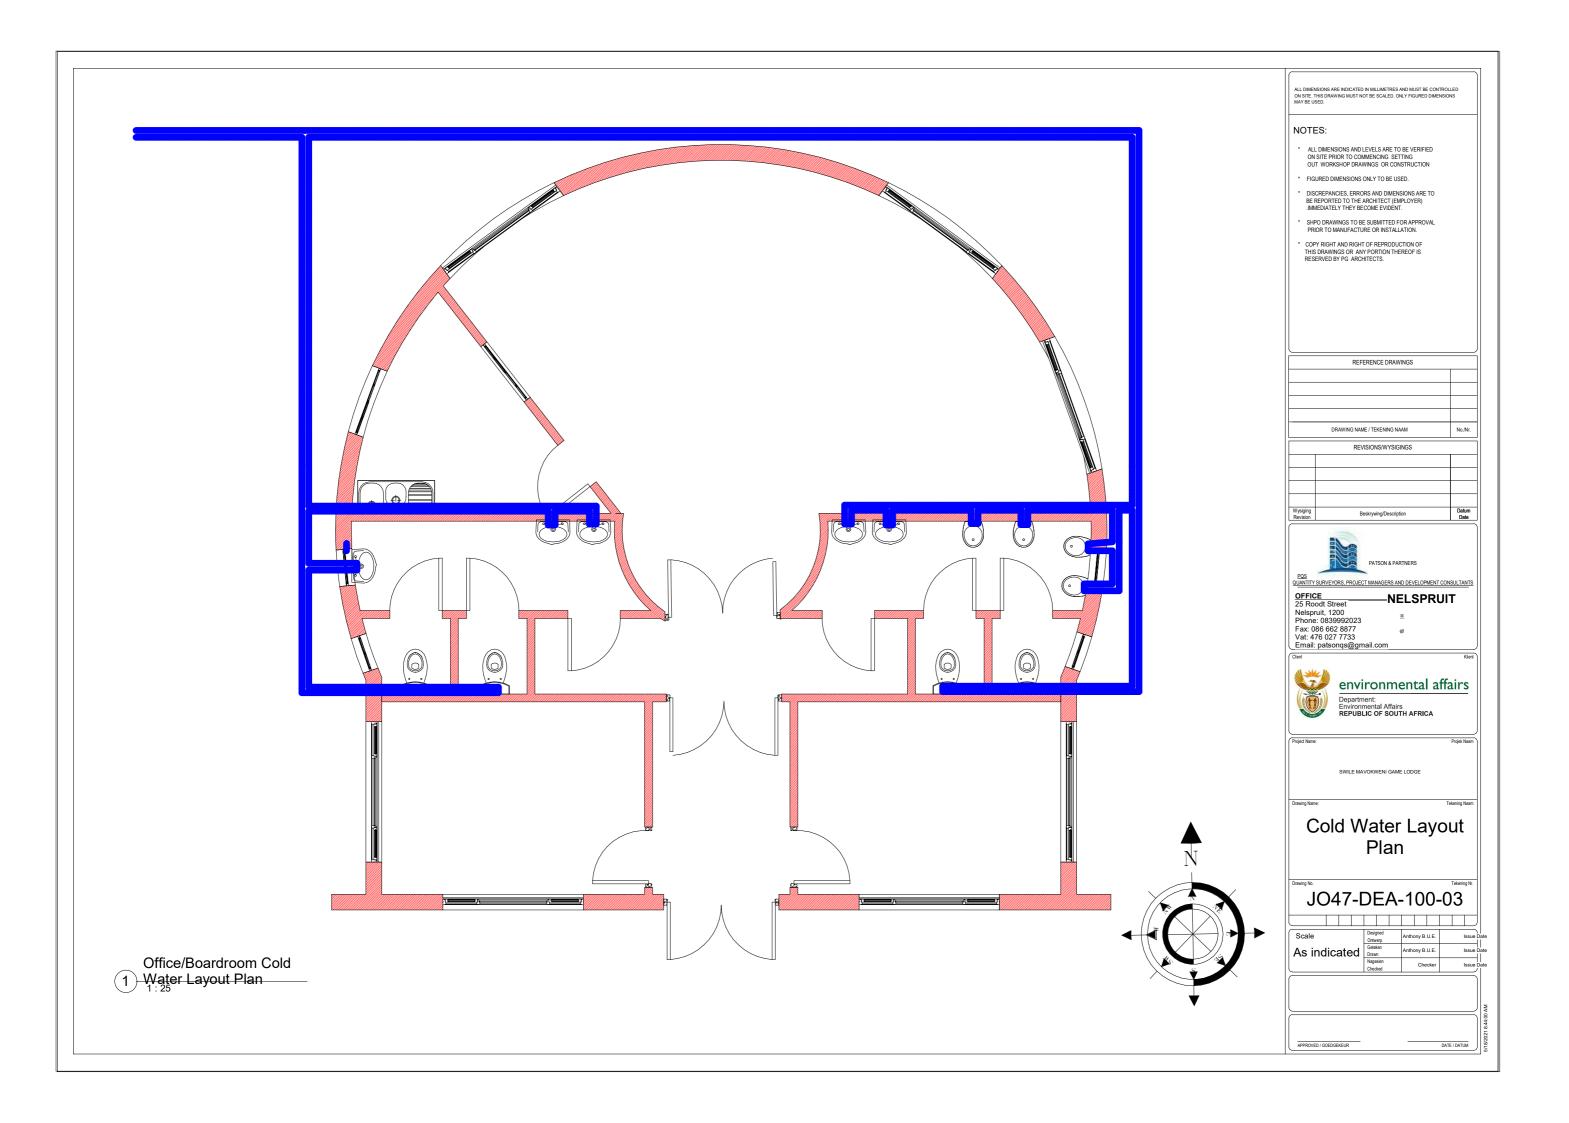

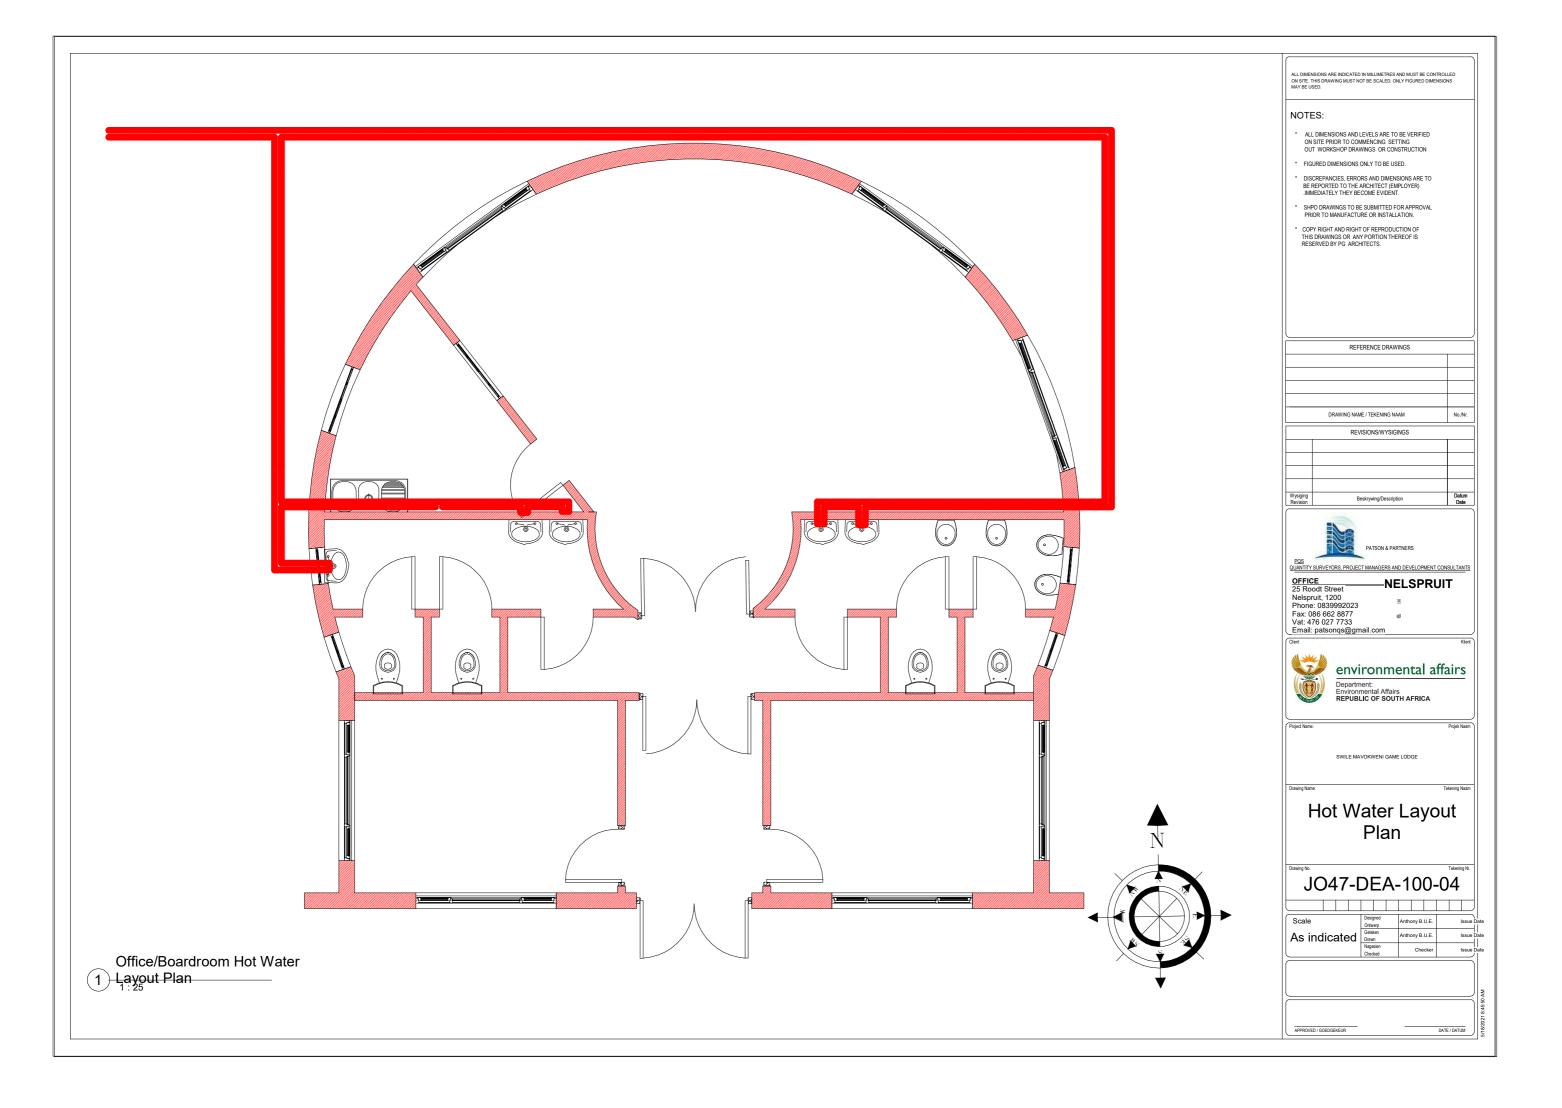

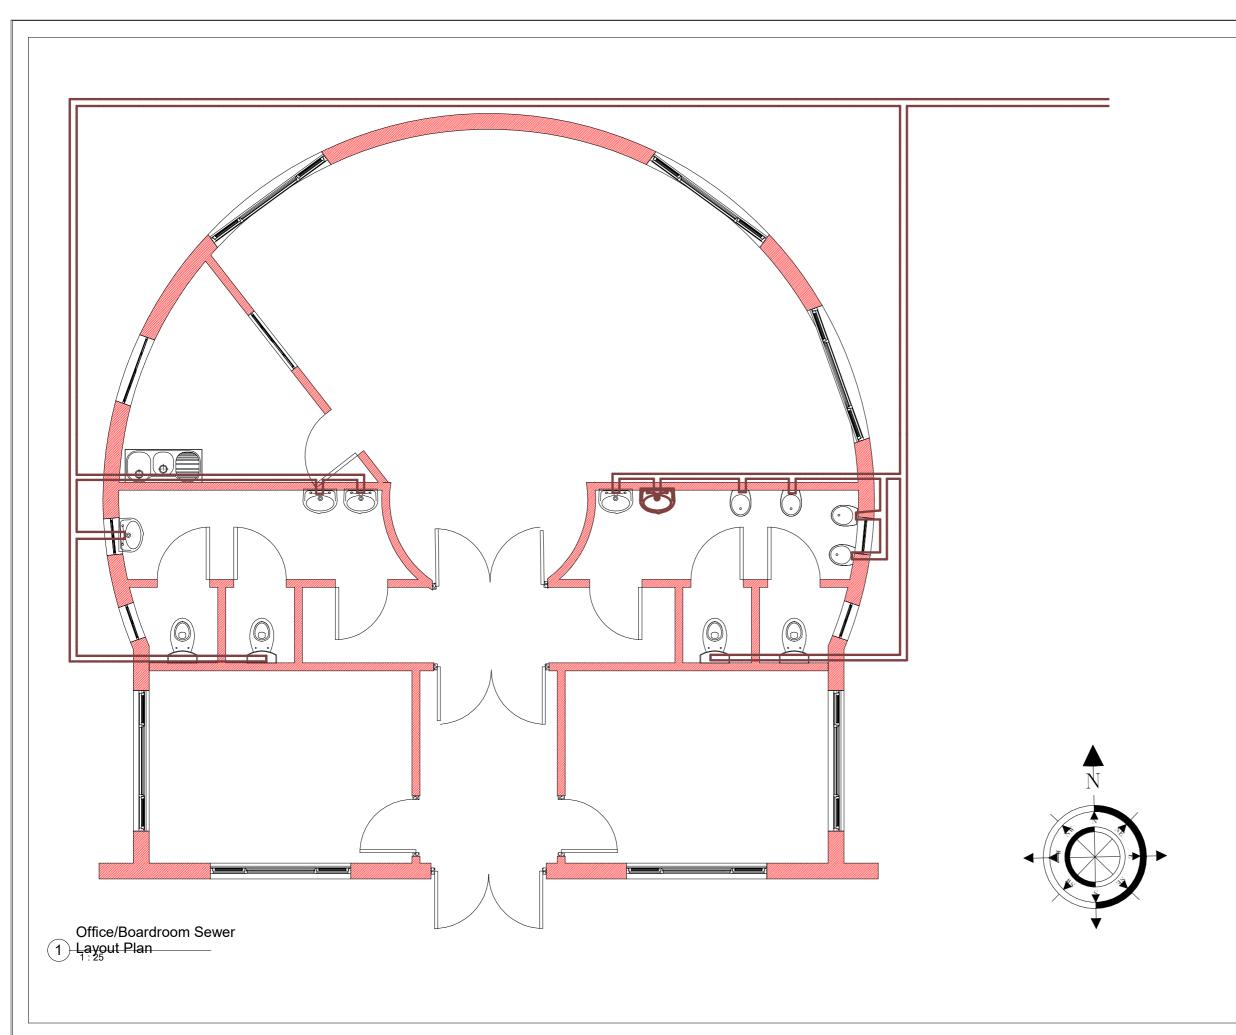

- ALL DIMENSIONS AND LEVELS ARE TO BE VERIFIED ON SITE PRIOR TO COMMENCING SETTING OUT WORKSHOP DRAWINGS OR CONSTRUCTION
- FIGURED DIMENSIONS ONLY TO BE USED.
- DISCREPANCIES, ERRORS AND DIMENSIONS ARE TO BE REPORTED TO THE ARCHITECT (EMPLOYER) .IMMEDIATELY THEY BECOME EVIDENT.
- SHPO DRAWINGS TO BE SUBMITTED FOR APPROVAL PRIOR TO MANUFACTURE OR INSTALLATION.
- COPY RIGHT AND RIGHT OF REPRODUCTION OF THIS DRAWINGS OR ANY PORTION THEREOF IS RESERVED BY PG ARCHITECTS.

	DRAWING NAME / TEKENING NAAM	No./Ni
	REVISIONS/WYSIGINGS	
Wysiging Revision	Beskrywing/Description	Datum Date

REFERENCE DRAWINGS



OFFICE
25 Roodt Street
Nelspruit, 1200
Phone: 0839992023
Fax: 086 662 8877
Vat: 476 027 7733
Email: patsonqs@gmail.com -NELSPRUIT




Sewer Layout Plan

JO47-DEA-100-05

Scale

As indicated

Designed
Contwerp
Geteken
Dran
Nagesien

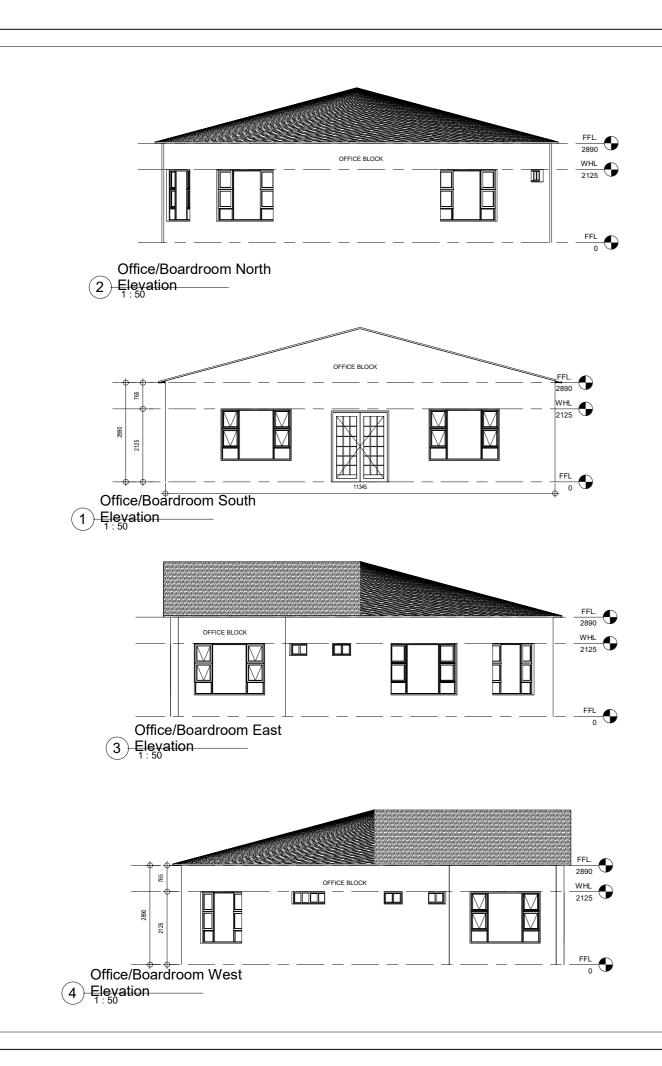

IOTES:

Sealant to be non woven polyester G2 or G3 membrane . Top coat - UV resistant flexible acrylic available in black,charcoal,core or red to employers choice.

1. Roof pitch as indicated


0.8mm Profiled Sheetmetal Ridge Capping, Sealed to Manufacture spec(Chromadek)

- 3. Profiled roof sheeting on purlins.
- 4. 75x50mm S.A Pine Purlins at 700mm c/c on Timber Truss.
- Provide S.A.B.S Approved Waterproofing Membrane Above Roof Trusses acc to Manufacture's spec.
- S.A Pine Roof Trusses at 1000mm c/c on Wall Plate.
 Treat All Exposed Timber with approved applicant to Manufacture 's Spec.
- 7. 114x38mm S.A Pine Timber Wall Plate.
- 225x15mm Fibre Cement Fascia Board or Other Equal approved.
- 9. Ceiling Refer To Finishing Schedules.
- Approved face brick with 5mm recessed raked joints.
- 11. Windows Refer to Window Schedules.
- 12. Door refer to Door schedule
- Reinforced brickwork lintols reinforced with X2 6.4mm Ø steel bars horizontally with bentwire stirrups bedding in every third vertical joint along the length of the soldier course.
- 14. Skirting Refer to Finishing schedules.
- Floor as per schedule on 40mm screed on concrete slab.
- 85mm thick Concrete slab on S.A.B.S Approved termite poisoning USB Green water proofing Membrane to Engineer's details
- 17. S.A.B.S approved D.P.C to Manufacture Spec.
- 75mm thick apron around building with expansion joints every 3m² width fall away from building.
- 19. Foundation to Engineers details and Approval.
- 20. Well compacted consolidated laterite hardcore by Engineer
- 21. Undisturbed Earth.
- 22. Provide Metal Flashing

ALL DIMENSIONS ARE INDICATED IN MILLIMETRES AND MUST BE CONTROLLED ON SITE. THIS DRAWING MUST NOT BE SCALED. ONLY FIGURED DIMENSIONS MAY BE USED.

NOTES:

- ALL DIMENSIONS AND LEVELS ARE TO BE VERIFIED ON SITE PRIOR TO COMMENCING SETTING OUT WORKSHOP DRAWINGS OR CONSTRUCTION
- FIGURED DIMENSIONS ONLY TO BE USED.
- DISCREPANCIES, ERRORS AND DIMENSIONS ARE TO BE REPORTED TO THE ARCHITECT (EMPLOYER) IMMEDIATELY THEY BECOME EVIDENT.
- * SHPO DRAWINGS TO BE SUBMITTED FOR APPROVAL PRIOR TO MANUFACTURE OR INSTALLATION.
- * COPY RIGHT AND RIGHT OF REPRODUCTION OF THIS DRAWINGS OR ANY PORTION THEREOF IS RESERVED BY PG ARCHITECTS.

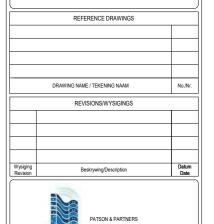



-NELSPRUIT



Project Name: Projek Na
SWILE MAVOKWENI GAME LODGE
Drawing Name: Tekening Na


Elevations


JO47-DEA-200-01

Scale

Designed Anthony B.U.E. Issue Contemp Geleten Anthony B.U.E. Issue State Contemp Contem

APPROVED / COED/SEKELIR DATE / DATI

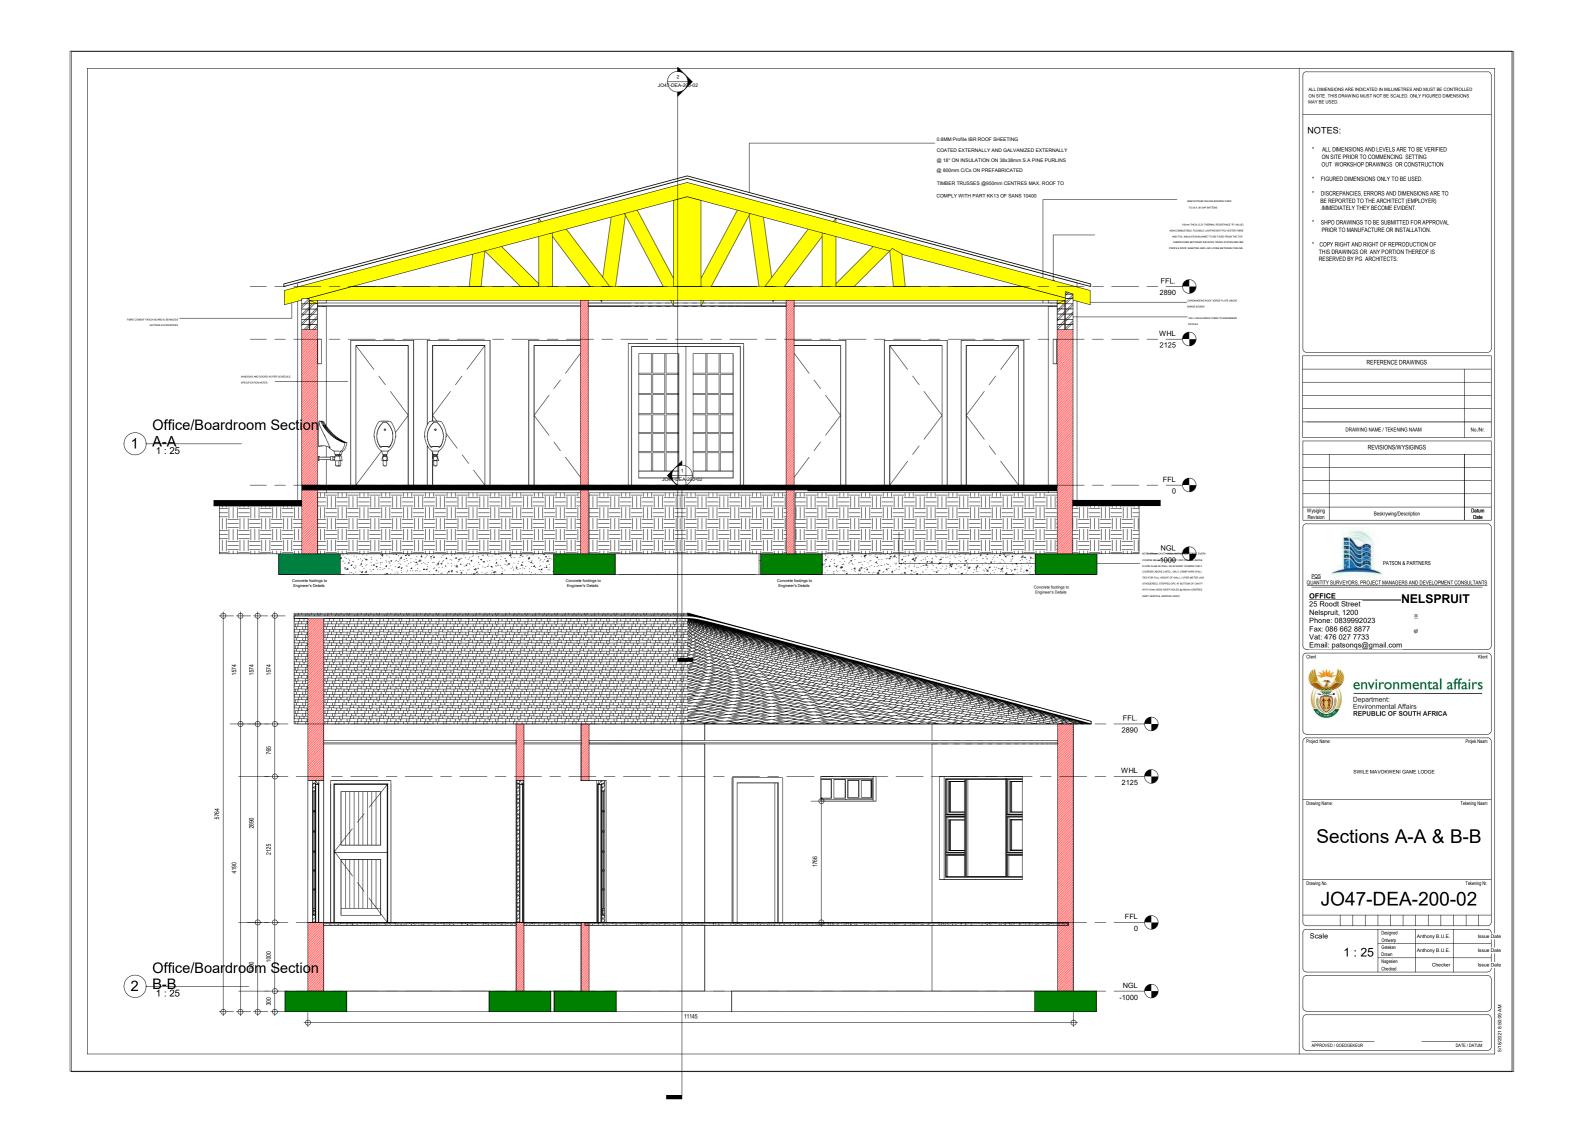

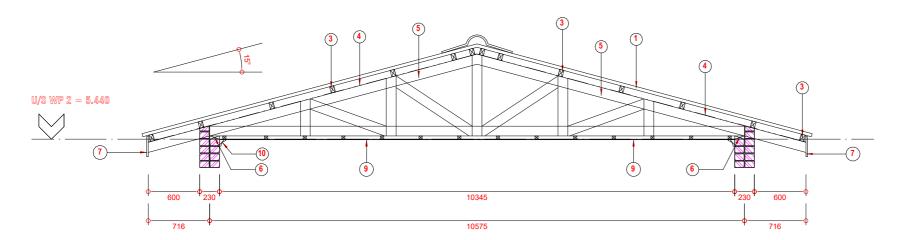

ROOF TRUSS TYPE "C" SCALE 1:20

Office/Boardroom Roof 1) Truss Details

Sealant to be non woven polyester G2 or G3 membrane . Top coat - UV resistant flexible acrylic available in black, charcoal,core or red to employers choice.

- 1. Profiled roof sheeting on 75x50mm SA pine purlins on prefabricated roof structure. treat all exposed timber with approved applicant.
- 2. Proved Fibre Cement Barge Boad
- 3. 75x50mm S.A pine Timber Purlins at 700mm c/c on timber trusses.
- 4. 0.5mm thick SABS Approved water proofing membane
- 5. 114x38mm S.A pine Timber Trusses at 1200mm c/c on wall plate
- 6. 114x38mm S.A pine Timber wall plate
- 7. 225x15mm Fibre cement fascia board or other equal approved
- 8. 38x38mm S.A pine Timber Brandering at 450mm c/c
- 9. 6mm thick Fibre cement ceiling to finishing schedule
- 10. Cornice to finishing schedule
- 11. Provide Head and Counter Metal Flashing
- 12. 152x89mm Timber Rafters, Roof Truss Members to Engineer's Details and Spec
- 13. Reinforced Concrete Gutter to Engineer's Details and
- 14. 120x55mm Channel fixed to Details
- 15. Profiled roof sheeting

NOTES:

- ALL DIMENSIONS AND LEVELS ARE TO BE VERIFIED ON SITE PRIOR TO COMMENCING SETTING OUT WORKSHOP DRAWINGS OR CONSTRUCTION
- FIGURED DIMENSIONS ONLY TO BE USED.
- DISCREPANCIES. FRRORS AND DIMENSIONS ARE TO BE REPORTED TO THE ARCHITECT (EMPLOYER)
 .IMMEDIATELY THEY BECOME EVIDENT.
- SHPO DRAWINGS TO BE SUBMITTED FOR APPROVAL PRIOR TO MANUFACTURE OR INSTALLATION.
- COPY RIGHT AND RIGHT OF REPRODUCTION OF THIS DRAWINGS OR ANY PORTION THEREOF IS RESERVED BY PG ARCHITECTS.

	REFERENCE DRAWINGS	
	DRAWING NAME / TEKENING NAAM	No./N
	REVISIONS/WYSIGINGS	
Wysiging Revision	Beskrywing/Description	Datu Date




OFFICE
25 Roodt Street
Nelspruit, 1200
Phone: 0839992023
Fax: 086 662 8877
Vat: 476 027 7733
Email: patsonqs@gmail.com -NELSPRUIT




Roof Truss Details

JO47-DEA-300-01

Ontwerp As indicated Geteken Drawn Nagesien Anthony B.U.E.

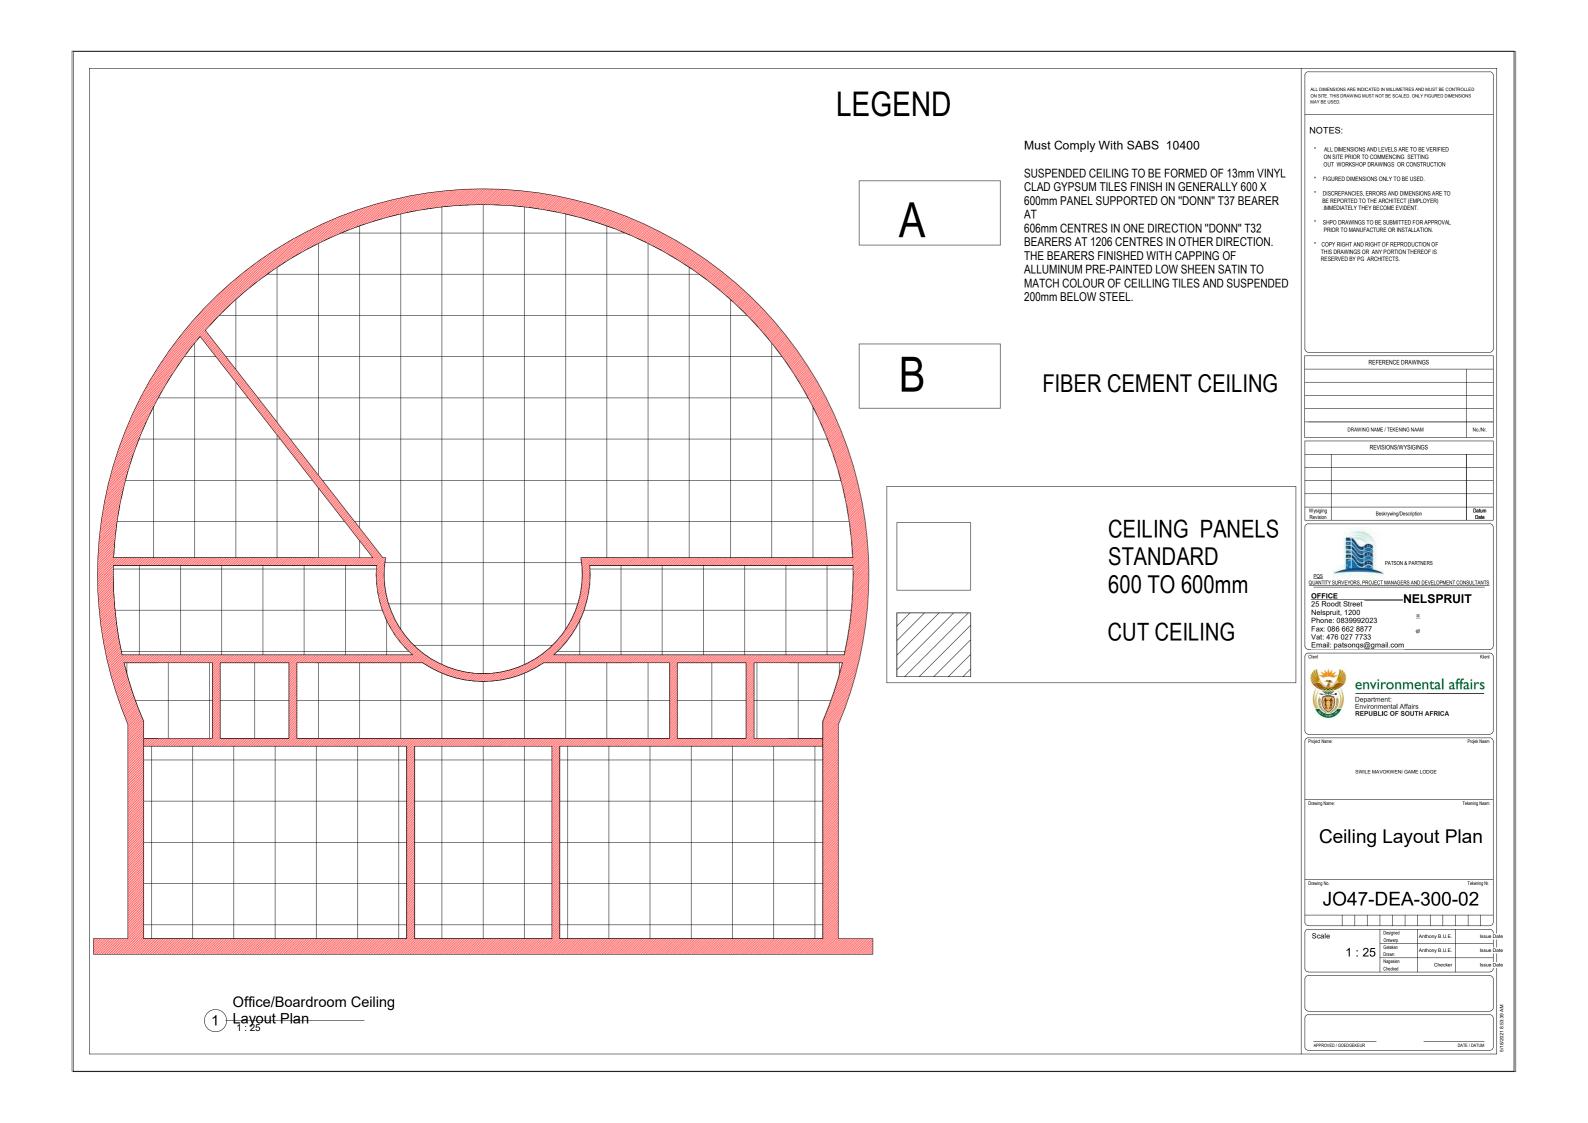

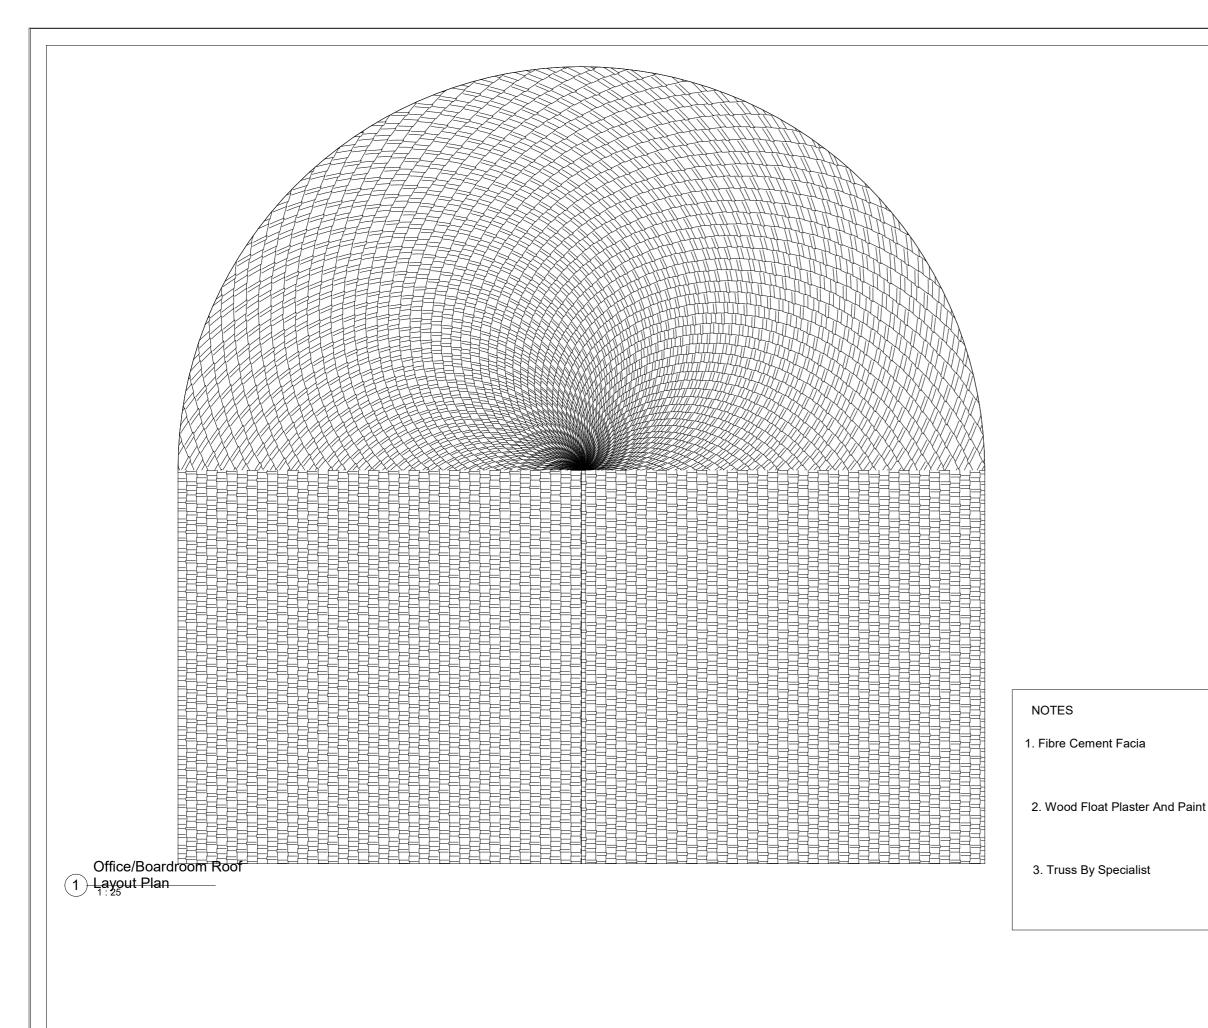

ALL DIMENSIONS ARE INDICATED IN MILLIMETRES AND MUST BE CONTROLLE ON SITE. THIS DRAWING MUST NOT BE SCALED. ONLY FIGURED DIMENSIONS MAY BE USED.

NOTES:

- * ALL DIMENSIONS AND LEVELS ARE TO BE VERIFIED ON SITE PRIOR TO COMMENCING SETTING OUT WORKSHOP DRAWINGS OR CONSTRUCTION
- FIGURED DIMENSIONS ONLY TO BE USED.
- DISCREPANCIES, ERRORS AND DIMENSIONS ARE TO BE REPORTED TO THE ARCHITECT (EMPLOYER) .IMMEDIATELY THEY BECOME EVIDENT.
- * SHPO DRAWINGS TO BE SUBMITTED FOR APPROVAL PRIOR TO MANUFACTURE OR INSTALLATION.
- COPY RIGHT AND RIGHT OF REPRODUCTION OF THIS DRAWINGS OR ANY PORTION THEREOF IS RESERVED BY PG ARCHITECTS.

	PRAWING NAME / TEKENING NAAM	No./Nr
	REVISIONS/WYSIGINGS	
Wysiging Revision	Beskrywing/Description	Datum Date

REFERENCE DRAWINGS



PATSON & PARTNERS

QUANTITY SURVEYORS, PROJECT MANAGERS AND DEVELOPMENT CONSULTAN

OFFICE
25 Roodt Street
Nelspruit, 1200
Phone: 0839992023
Fax: 086 662 8877
Vat: 476 027 7733
Email: patsonqs@gmail.com

anvinanmental affai

environmental affairs

Department:
Environmental Affairs
REPUBLIC OF SOUTH AFRICA

Project Name:

SWILE MAVOKWENI GAME LODI

Drawing Name:

Tekening Naam


Roof Layout Plan


JO47-DEA-300-03


Scale

Designed Anthony B.U.E. Issue Da Contemp Geteken Anthony B.U.E. Issue Da Dawn Anthony B.U.E. Issue Da Contemp Code (Contemp Code)
Nagesien Checker Issue Da Checker Issue Da

APPROVED / GOEDGEKEUR DATE / DATU

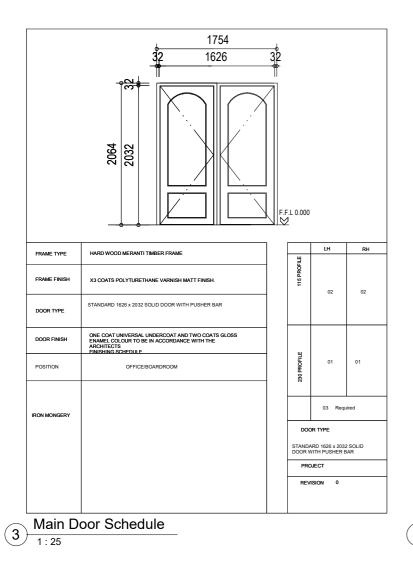

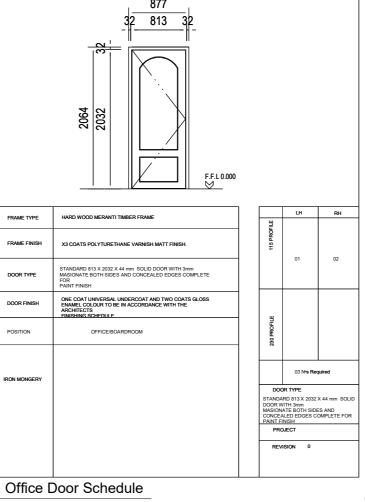

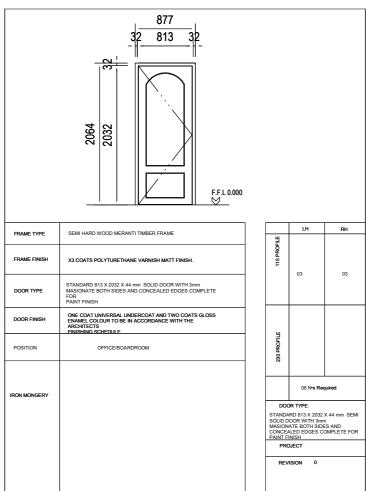

Wysiging Revision Beskrywing/Description PQS QUANTITY SURVEYORS, PROJECT MANAGERS AND DEVELOPMENT CONSULTANTS OFFICE
25 Roodt Street
Nelspruit, 1200
Phone: 0839992023
Fax: 086 662 8877
Vat: 476 027 7733
Email: patsonqs@gmail.com -NELSPRUIT environmental affairs
Department:
Environmental Affairs
REPUBLIC OF SOUTH AFRICA Department: Environmental Affairs REPUBLIC OF SOUTH AFRICA Door Schedule

ALL DIMENSIONS ARE INDICATED IN MILLIMETRES AND MUST BE CONTROLLED ON SITE. THIS DRAWING MUST NOT BE SCALED. ONLY FIGURED DIMENSIONS MAY BE USED.

ALL DIMENSIONS AND LEVELS ARE TO BE VERIFIED ON SITE PRIOR TO COMMENCING SETTING OUT WORKSHOP DRAWINGS OR CONSTRUCTION * FIGURED DIMENSIONS ONLY TO BE USED. DISCREPANCIES, ERRORS AND DIMENSIONS ARE TO BE REPORTED TO THE ARCHITECT (EMPLOYER)
.IMMEDIATELY THEY BECOME EVIDENT. SHPO DRAWINGS TO BE SUBMITTED FOR APPROVAL PRIOR TO MANUFACTURE OR INSTALLATION.

COPY RIGHT AND RIGHT OF REPRODUCTION OF THIS DRAWINGS OR ANY PORTION THEREOF IS RESERVED BY PG ARCHITECTS.

REFERENCE DRAWINGS

DRAWING NAME / TEKENING NAAM

REVISIONS/WYSIGINGS

JO47-DEA-400-01

1 : 25 Designed Ontwerp Anthony B.U.E. Geleken Drawn Anthony B.U.E. Nagesien Charles


No./Nr.


NOTES:


2 Office 1:25

1:25

Toilet Door Schedule

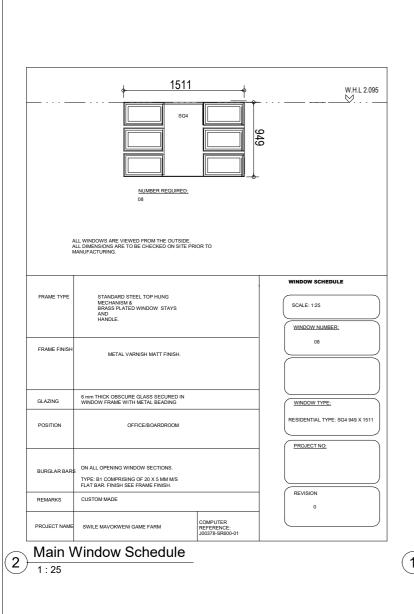

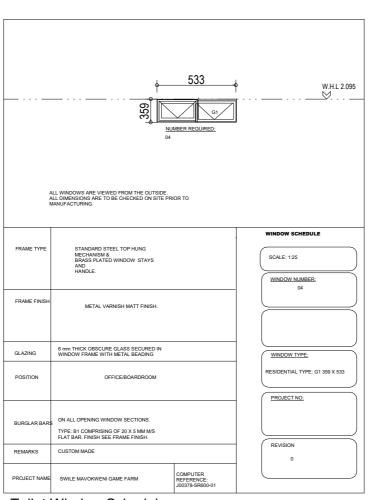

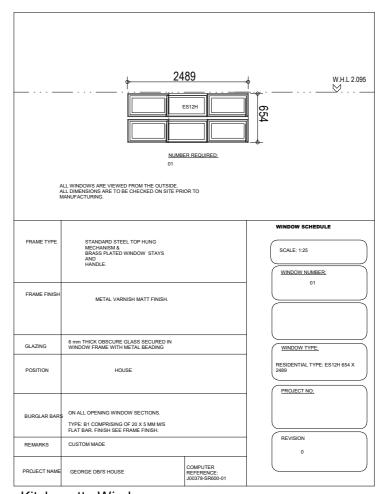

Toilet Window Schedule

Kitchenette Window

ALL DIMENSIONS ARE INDICATED IN MILLIMETRES AND MUST BE CONTROLLED ON SITE. THIS DRAWING MUST NOT BE SCALED. ONLY FIGURED DIMENSIONS MAY BE USED.

NOTES:

- * ALL DIMENSIONS AND LEVELS ARE TO BE VERIFIED ON SITE PRIOR TO COMMENCING SETTING OUT WORKSHOP DRAWINGS OR CONSTRUCTION
- * FIGURED DIMENSIONS ONLY TO BE USED.
- * DISCREPANCIES, ERRORS AND DIMENSIONS ARE TO BE REPORTED TO THE ARCHITECT (EMPLOYER) .IMMEDIATELY THEY BECOME EVIDENT.
- * SHPO DRAWINGS TO BE SUBMITTED FOR APPROVAL PRIOR TO MANUFACTURE OR INSTALLATION.
- COPY RIGHT AND RIGHT OF REPRODUCTION OF THIS DRAWINGS OR ANY PORTION THEREOF IS RESERVED BY PG ARCHITECTS.

	REFERENCE DRAWINGS	
	DRAWING NAME / TEKENING NAAM	No./Nr.
	REVISIONS/WYSIGINGS	
ysiging evision	Beskrywing/Description	Datum Date
PQS IANTITY	PATSON & PARTINERS SURVEYORS, PROJECT MANAGERS AND DEVELOPMENT CON	SI II TANTS
OFFIC		
	SENELSPRUI	I



l			
	Project Name:		Projek Naam
	s	WILE MAVOKWENI GAME LODGE	
	Drawing Name:		Tekening Naam

Window Schedule

JO47-DEA-400-02


Scale		Designed Ontwerp	Anthony B.U.E.	Issue E
	1:25	Geteken Drawn	Anthony B.U.E.	Issue E
		Nagesien Checked	Checker	Issue E


PPROVED / GOEDGEKEUR DATE / DATUM

STAFF ACCOMMODATION

STAFF ACCOMMODATION: 124m²

BLOCK NAME AREA m² FAR COVERAGE STAFF ACCOMMODATION 124 m² 124 m² Bedroom 1 12 m² 12 m² Bedroom 2 12 m² 12 m² Bedroom 3 12 m² 12 m² Toilet 1 4 m² 4 m² Toilet 2 4 m² 4 m² Toilet 3 4 m² 4 m² Patio 1 5 m² 5 m² Patio 2 5 m² 11 m² Kitchen/Living Room Area 1 11 m² 11 m² Kitchen/Living Room Area 2 11 m² 4 m² Passage 1 4 m² 4 m²				
Bedroom 1	BLOCK NAME	AREA m ²	FAR	COVERAGE
Bedroom 2	STAFF ACCOMMODATION	124 m ²		
Bedroom 3	Bedroom 1	12 m ²		
Bedroom 4	Bedroom 2	12 m ²		
Toilet 1	Bedroom 3	12 m ²		
Toilet 2 Toilet 3 4 m² 4 m² Toilet 4 4 m² Patio 1 Patio 2 Kitchen/Living Room Area 1 Kitchen/Living Room Area 2 Passage 1 4 m² 4 m² 4 m² 11 m² 4 m²	Bedroom 4	12 m ²		
Toilet 2 Toilet 3 Toilet 4 4 m² 4 m² Patio 1 5 m² Patio 2 Kitchen/Living Room Area 1 Kitchen/Living Room Area 2 Passage 1 4 m²	Toilet 1	4 m ²		
Toilet 4	Toilet 2	4 m ²		
Patio 1 5 m ² Patio 2 5 m ² Kitchen/Living Room Area 1 11 m ² Kitchen/Living Room Area 2 11 m ² Passage 1 4 m ²	Toilet 3	4 m ²		
Patio 2 5 m ² Kitchen/Living Room Area 1 11 m ² Kitchen/Living Room Area 2 11 m ² Passage 1 4 m ²	Toilet 4	4 m ²		
Fatio 2	Patio 1	5 m ²		
Kitchen/Living Room Area 2 11 m ² Passage 1 4 m ²	Patio 2	5 m ²		
Passage 1 4 m ²	Kitchen/Living Room Area 1	11 m ²		
i assage i	Kitchen/Living Room Area 2	11 m ²		
Passage 2 4 m ²		4 m ²		
	Passage 2	4 m ²		

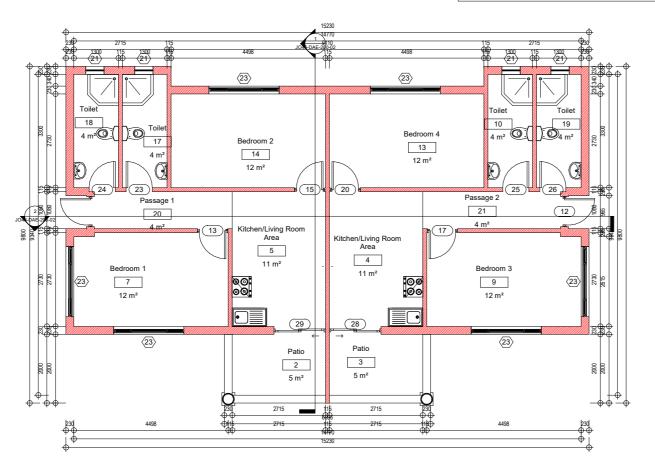

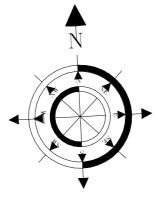

ALL DIMENSIONS ARE INDICATED IN MILLIMETRES AND MUST BE CONTROLLED.
ON SITE: THIS DRAWING MUST NOT BE SCALED. ONLY FIGURED DIMENSIONS
MAY BE USED.

NOTES:

- * ALL DIMENSIONS AND LEVELS ARE TO BE VERIFIED ON SITE PRIOR TO COMMENCING SETTING OUT WORKSHOP DRAWINGS OR CONSTRUCTION
- * FIGURED DIMENSIONS ONLY TO BE USED.
- * DISCREPANCIES, ERRORS AND DIMENSIONS ARE TO BE REPORTED TO THE ARCHITECT (EMPLOYER) .IMMEDIATELY THEY BECOME EVIDENT.
- * SHPO DRAWINGS TO BE SUBMITTED FOR APPROVAL PRIOR TO MANUFACTURE OR INSTALLATION.
- COPY RIGHT AND RIGHT OF REPRODUCTION OF THIS DRAWINGS OR ANY PORTION THEREOF IS RESERVED BY PG ARCHITECTS.

	REFERENCE DRAWINGS	
	DRAWING NAME / TEKENING NAAM	No./Nr.
	REVISIONS/WYSIGINGS	
Wysiging Revision	Beskrywing/Description	Datum Date
PQS QUANTITY	PATSON & PARTINERS SURVEYORS, PROJECT MANAGERS AND DEVELOPMENT CON	SULTANTS
OFFIC 25 Ro	net Street NELSPRUI	Г
Phone	uit, 1200 :: 0839992023	
Vat: 4	86 662 8877 76 027 7733 patsongs@gmail.com	
Client	paisonqs@gmaii.com	Klient



Project Name: Projek Naam
SWILE MAVOKWENI GAME LODGE
Drawing Name: Tekening Naam

Floor Layout Plan

JO46-DAE-100-02


	$\overline{}$			
	Scale	Designed	Anthony B.U.E.	Issue Date
	Scale	Ontwerp	Antiliony B.U.E.	ISSUE DAI
	A - !!! 4	Geteken	Anthony B.U.E.	Issue Date
	As indicated	Drawn	Antilony B.O.L.	issue Dati
		Nagesien	Checker	Issue Date
- 1	(Checked	CHECKEL	/ /

APPROVED / GOEDGEKEUR DATE / DATUM


Staff Accomodation Floor

1 Layout Plan

1:50

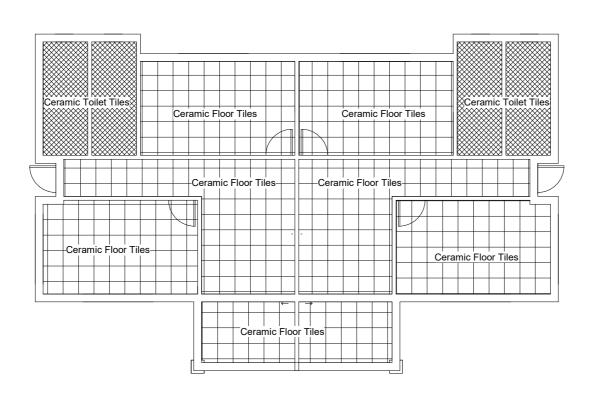

Staff Accomodation Site 1 Layout Plan

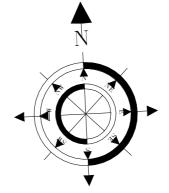

NOTES:

- ALL DIMENSIONS AND LEVELS ARE TO BE VERIFIED ON SITE PRIOR TO COMMENCING SETTING OUT WORKSHOP DRAWINGS OR CONSTRUCTION
- FIGURED DIMENSIONS ONLY TO BE USED.
- DISCREPANCIES, ERRORS AND DIMENSIONS ARE TO BE REPORTED TO THE ARCHITECT (EMPLOYER) .IMMEDIATELY THEY BECOME EVIDENT.
- SHPO DRAWINGS TO BE SUBMITTED FOR APPROVAL PRIOR TO MANUFACTURE OR INSTALLATION.
- COPY RIGHT AND RIGHT OF REPRODUCTION OF THIS DRAWINGS OR ANY PORTION THEREOF IS RESERVED BY PG ARCHITECTS.

	REFERENCE DRAWINGS	
	DRAWING NAME / TEKENING NAAM	No./Nr.
	REVISIONS/WYSIGINGS	
Wysiging Revision	Beskrywing/Description	Datum Date




OFFICE Nelspruit, 1200
Phone: 0839992023
Fax: 086 662 8877
Vat: 476 027 7733
Email: patsonqs@gmail.com -NELSPRUIT




Site Layout Plan

JO46-DAE-100-01

1:50 Designed Ontwerp Geteken Drawn Nagesien

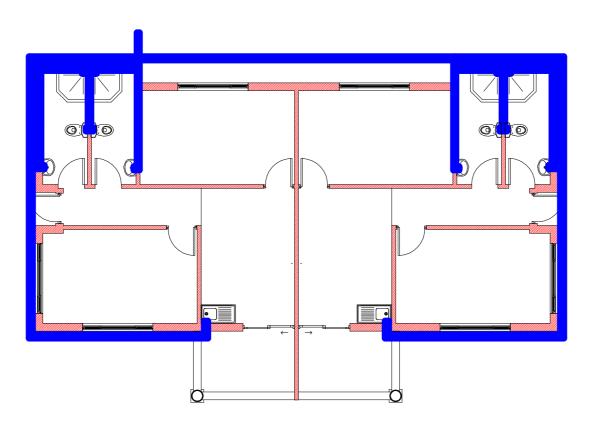

Staff Accomodation Cold 1) Water Layout Plan

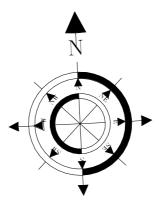

ALL DIMENSIONS ARE INDICATED IN MILLIMETRES AND MUST BE CONTROLLED.
ON SITE: THIS DRAWING MUST NOT BE SCALED. ONLY FIGURED DIMENSIONS
MAY BE USED.

NOTES:

- ALL DIMENSIONS AND LEVELS ARE TO BE VERIFIED ON SITE PRIOR TO COMMENCING SETTING OUT WORKSHOP DRAWINGS OR CONSTRUCTION
- FIGURED DIMENSIONS ONLY TO BE USED.
- DISCREPANCIES, ERRORS AND DIMENSIONS ARE TO BE REPORTED TO THE ARCHITECT (EMPLOYER) .IMMEDIATELY THEY BECOME EVIDENT.
- SHPO DRAWINGS TO BE SUBMITTED FOR APPROVAL PRIOR TO MANUFACTURE OR INSTALLATION.
- * COPY RIGHT AND RIGHT OF REPRODUCTION OF THIS DRAWINGS OR ANY PORTION THEREOF IS RESERVED BY PG ARCHITECTS.

	DRAWING NAME / TEKENING NAAM	No./Nr.
	REVISIONS/WYSIGINGS	
Wysiging Revision	Beskrywing/Description	Datum Date

REFERENCE DRAWINGS



OFFICE Nelson Street Nelson 125 Rood Street Nelsonuit, 1200 Phone: 0839992023 Fax: 086 662 8877 Vat: 476 027 7733 Email: patsonqs@gmail.com -NELSPRUIT


environmental affairs


Department: Environmental Affairs REPUBLIC OF SOUTH AFRICA

Cold Water Layout Plan

JO46-DAE-100-03

1 : 50 Designed Ontwerp Anthony B.U.E. Geleken Drawn Anthony B.U.E. Nagesien Chapter

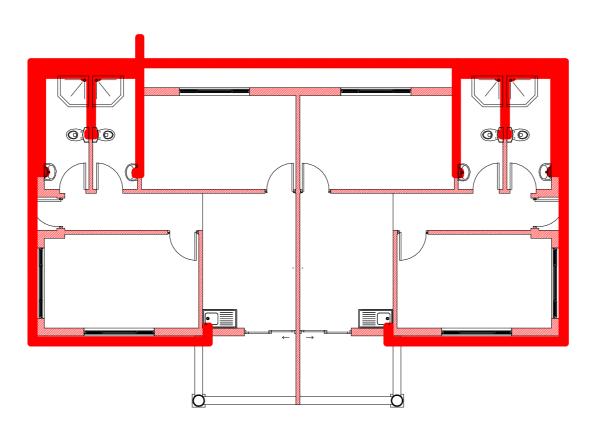

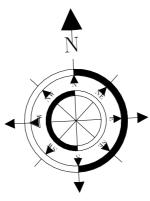

- ALL DIMENSIONS AND LEVELS ARE TO BE VERIFIED ON SITE PRIOR TO COMMENCING SETTING OUT WORKSHOP DRAWINGS OR CONSTRUCTION
- FIGURED DIMENSIONS ONLY TO BE USED.
- DISCREPANCIES, ERRORS AND DIMENSIONS ARE TO BE REPORTED TO THE ARCHITECT (EMPLOYER) .IMMEDIATELY THEY BECOME EVIDENT.
- SHPO DRAWINGS TO BE SUBMITTED FOR APPROVAL PRIOR TO MANUFACTURE OR INSTALLATION.
- COPY RIGHT AND RIGHT OF REPRODUCTION OF THIS DRAWINGS OR ANY PORTION THEREOF IS RESERVED BY PG ARCHITECTS.

	REFERENCE DRAWINGS	
	DRAWING NAME / TEKENING NAAM	No./Nr
	REVISIONS/WYSIGINGS	
Wysiging Revision	Beskrywing/Description	Datum Date



OFFICE Nelspruit, 1200
Phone: 0839992023
Fax: 086 662 8877
Vat: 476 027 7733
Email: patsonqs@gmail.com -NELSPRUIT





Hot Water Layout Plan

JO46-DAE-100-04

1 : 50 Designed Ontwerp Anthony B.U.E. Geleken Drawn Anthony B.U.E. Nagesien Charles

Staff Accomodation Hot 1) Water Layout Plan

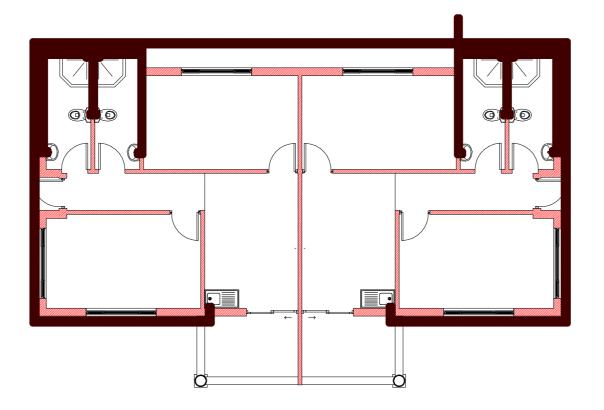

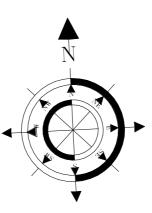

- ALL DIMENSIONS AND LEVELS ARE TO BE VERIFIED ON SITE PRIOR TO COMMENCING SETTING OUT WORKSHOP DRAWINGS OR CONSTRUCTION
- FIGURED DIMENSIONS ONLY TO BE USED.
- DISCREPANCIES, ERRORS AND DIMENSIONS ARE TO BE REPORTED TO THE ARCHITECT (EMPLOYER) .IMMEDIATELY THEY BECOME EVIDENT.
- SHPO DRAWINGS TO BE SUBMITTED FOR APPROVAL PRIOR TO MANUFACTURE OR INSTALLATION.
- * COPY RIGHT AND RIGHT OF REPRODUCTION OF THIS DRAWINGS OR ANY PORTION THEREOF IS RESERVED BY PG ARCHITECTS.

	REFERENCE DRAWINGS	
	RAWING NAME / TEKENING NAAM	No./N
	REVISIONS/WYSIGINGS	
Wysiging Revision	Beskrywing/Description	Datur Date



OFFICE Nelson Street Nelson 125 Rood Street Nelsonuit, 1200 Phone: 0839992023 Fax: 086 662 8877 Vat: 476 027 7733 Email: patsonqs@gmail.com -NELSPRUIT

environmental affairs Department:
Environmental Affairs
REPUBLIC OF SOUTH AFRICA


Sewer Layout Plan

JO46-DAE-100-05

Designed Ontwerp Anthony B.U.E.

1 : 50 Geleken Drawn Anthony B.U.E.
Nagesien Checker

Staff Accomodation Sewer 1 Layout Plan

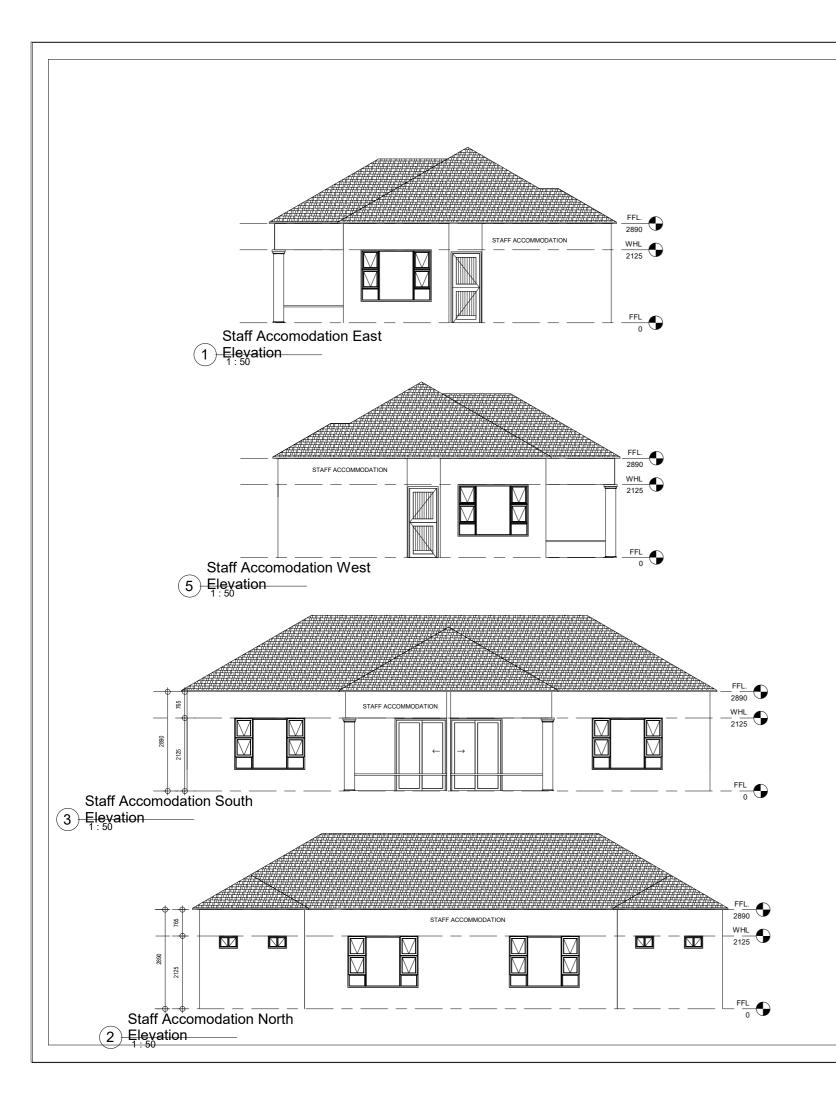

Sealant to be non woven polyester G2 or G3 membrane . Top coat - UV resistant flexible acrylic available in black,charcoal,core or red to employers choice.

1. Roof pitch as indicated

0.8mm Profiled Sheetmetal Ridge Capping, Sealed to Manufacture spec(Chromadek)

- 3. Profiled roof sheeting on purlins.
- 4. 75x50mm S.A Pine Purlins at 700mm c/c on Timber Truss.
- Provide S.A.B.S Approved Waterproofing Membrane Above Roof Trusses acc to Manufacture's spec.
- S.A Pine Roof Trusses at 1000mm c/c on Wall Plate.
 Treat All Exposed Timber with approved applicant to Manufacture 's Spec.
- 7. 114x38mm S.A Pine Timber Wall Plate.
- 225x15mm Fibre Cement Fascia Board or Other Equal approved.
- 9. Ceiling Refer To Finishing Schedules.
- Approved face brick with 5mm recessed raked joints.
- 11. Windows Refer to Window Schedules.
- 12. Door refer to Door schedule
- Reinforced brickwork lintols reinforced with X2 6.4mm Ø steel bars horizontally with bentwire stirrups bedding in every third vertical joint along the length of the soldier course.
- 14. Skirting Refer to Finishing schedules.
- Floor as per schedule on 40mm screed on concrete slab.
- 85mm thick Concrete slab on S.A.B.S Approved termite poisoning USB Green water proofing Membrane to Engineer's details
- 17. S.A.B.S approved D.P.C to Manufacture Spec.
- 75mm thick apron around building with expansion joints every 3m² width fall away from building.
- 19. Foundation to Engineers details and Approval.
- 20. Well compacted consolidated laterite hardcore by Engineer
- 21. Undisturbed Earth.
- 22. Provide Metal Flashing

LL DIMENSIONS ARE INDICATED IN MILLIMETRES AND MUST BE CONTROLLED N SITE. THIS DRAWING MUST NOT BE SCALED. ONLY FIGURED DIMENSIONS AV RE I ISED.

NOTES:

- * ALL DIMENSIONS AND LEVELS ARE TO BE VERIFIED ON SITE PRIOR TO COMMENCING SETTING OUT WORKSHOP DRAWINGS OR CONSTRUCTION
- * FIGURED DIMENSIONS ONLY TO BE USED.
- DISCREPANCIES, ERRORS AND DIMENSIONS ARE TO BE REPORTED TO THE ARCHITECT (EMPLOYER) IMMEDIATELY THEY BECOME EVIDENT.
- SHPO DRAWINGS TO BE SUBMITTED FOR APPROVAL PRIOR TO MANUFACTURE OR INSTALLATION.
- * COPY RIGHT AND RIGHT OF REPRODUCTION OF THIS DRAWINGS OR ANY PORTION THEREOF IS RESERVED BY PG ARCHITECTS.

	REFERENCE DRAWINGS	
	DRAWING NAME / TEKENING NAAM	No./Nr.
	REVISIONS/WYSIGINGS	
Wysiging Revision	Beskrywing/Description	Datum Date
PQS QUANTITY	PATSON & PARTNERS SURVEYORS, PROJECT MANAGERS AND DEVELOPMENT CON	SULTANTS
OFFIC 25 Ro	odt Street NELSPRUI	Т
	ruit, 1200 ± 0839992023	
Fax: 0	86 662 8877 76 027 7733	
	patsonqs@gmail.com	





Project Name:		Projek Naa
	SWILE MAVOKWENI GAME LODGE	
Drawing Name:		Tekening Naa

Elevations

JO46-DAE-200-01

Scale Designed Ontherp B.U.E. Issue Dai Onther

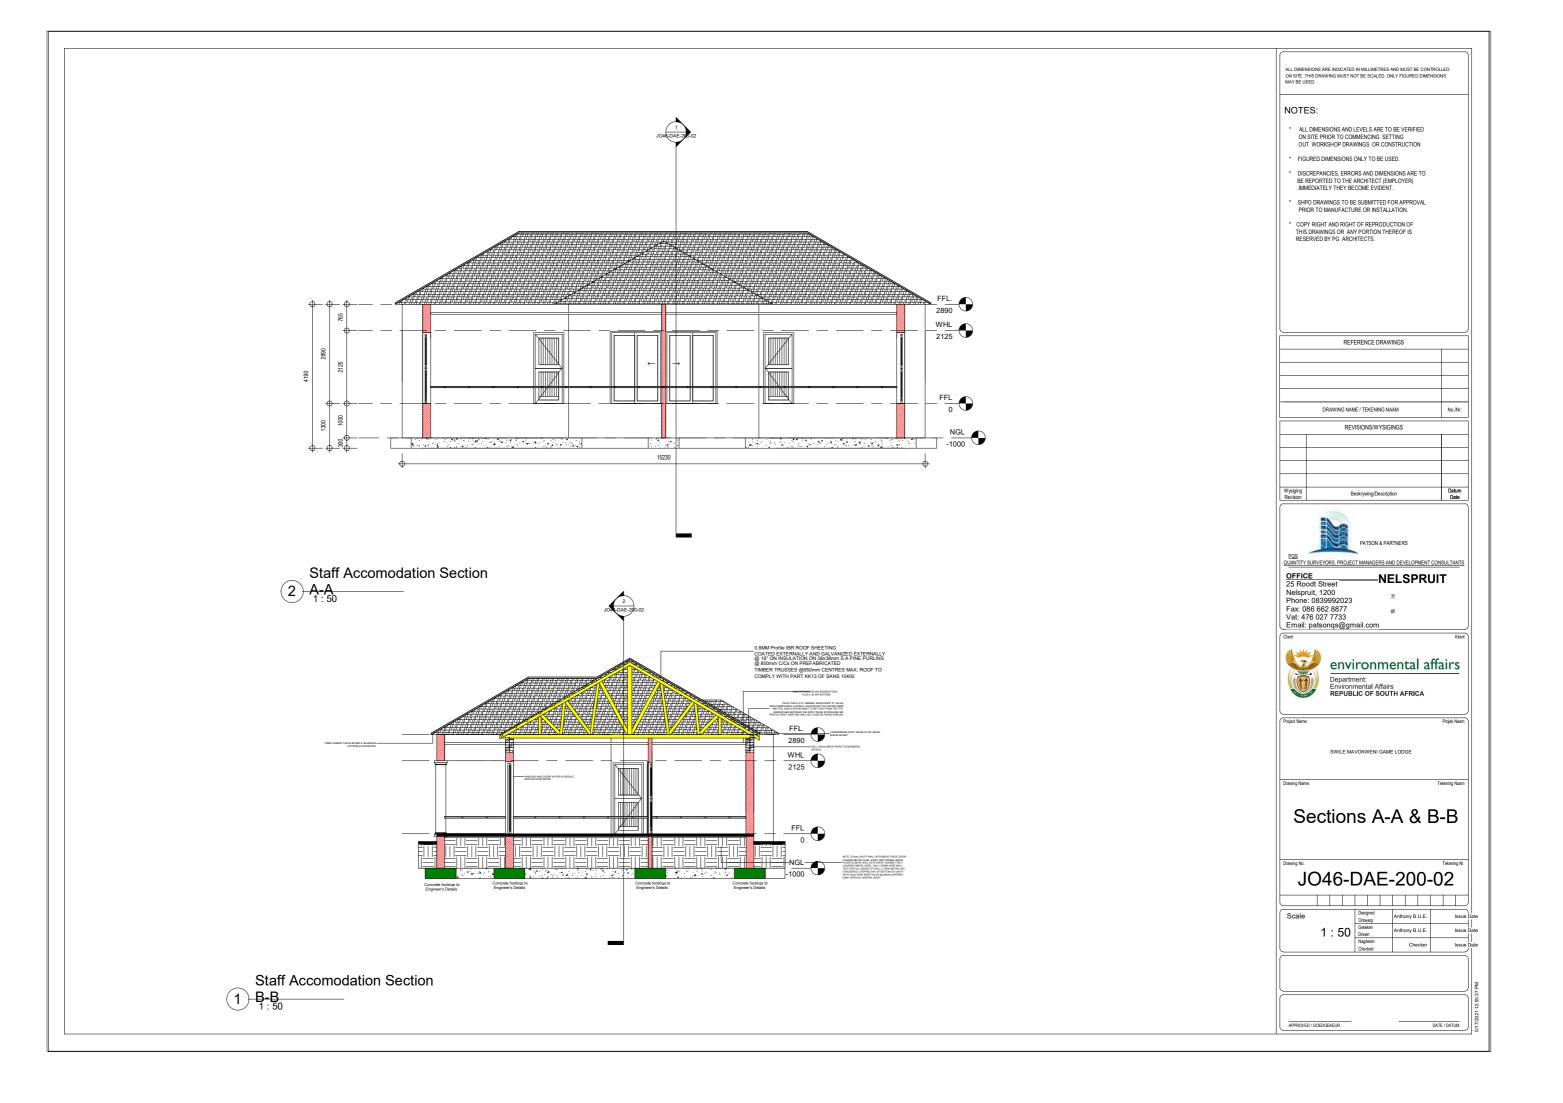

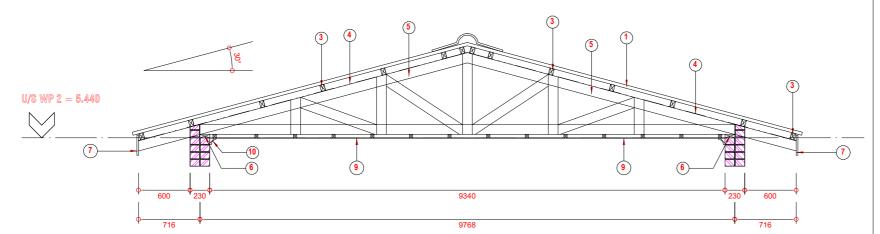

ROOF TRUSS TYPE "C" SCALE 1:25

Staff Accomodation Roof 1) Truss Details


Sealant to be non woven polyester G2 or G3 membrane . Top coat - UV resistant flexible acrylic available in black, charcoal, core or red to employers choice.

- 1. Profiled roof sheeting on 75x50mm SA pine purlins on prefabricated roof structure. treat all exposed timber with approved applicant.
- 2. Proved Fibre Cement Barge Boad
- 3. 75x50mm S.A pine Timber Purlins at 700mm c/c on timber trusses.
- 4. 0.5mm thick SABS Approved water proofing membane
- 5. 114x38mm S.A pine Timber Trusses at 1200mm c/c on wall plate
- 6. 114x38mm S.A pine Timber wall plate
- 7. 225x15mm Fibre cement fascia board or other equal approved
- 8. 38x38mm S.A pine Timber Brandering at 450mm c/c
- 9. 6mm thick Fibre cement ceiling to finishing schedule
- 10. Cornice to finishing schedule
- 11. Provide Head and Counter Metal Flashing
- 12. 152x89mm Timber Rafters, Roof Truss Members to Engineer's Details and Spec
- 13. Reinforced Concrete Gutter to Engineer's Details and
- 14. 120x55mm Channel fixed to Details
- 15. Profiled roof sheeting

ON SITE. THIS DRAWING MUST NOT BE SCALED. ONLY FIGURED DIMENSIONS MAY BE USED.

NOTES:

- ALL DIMENSIONS AND LEVELS ARE TO BE VERIFIED ON SITE PRIOR TO COMMENCING SETTING OUT WORKSHOP DRAWINGS OR CONSTRUCTION
- FIGURED DIMENSIONS ONLY TO BE USED.
- DISCREPANCIES. FRRORS AND DIMENSIONS ARE TO BE REPORTED TO THE ARCHITECT (EMPLOYER)
 .IMMEDIATELY THEY BECOME EVIDENT.
- SHPO DRAWINGS TO BE SUBMITTED FOR APPROVAL PRIOR TO MANUFACTURE OR INSTALLATION.
- COPY RIGHT AND RIGHT OF REPRODUCTION OF THIS DRAWINGS OR ANY PORTION THEREOF IS RESERVED BY PG ARCHITECTS.

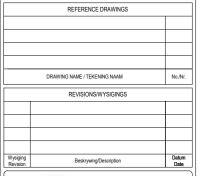



-NELSPRUIT 25 Roodt Street Nelspruit, 1200 Phone: 0839992023 Fax: 086 662 8877 Vat: 476 027 7733 Email: patsonqs@gmail.com





Roof Truss Details


JO46-DAE-300-01

Ontwerp As indicated Drawn Nagesien Anthony B.U.E.

LEGEND NOTES: Must Comply With SABS 10400 ALL DIMENSIONS AND LEVELS ARE TO BE VERIFIED ON SITE PRIOR TO COMMENCING SETTING OUT WORKSHOP DRAWINGS OR CONSTRUCTION SUSPENDED CEILING TO BE FORMED OF 13mm VINYL CLAD GYPSUM TILES FINISH IN GENERALLY 600 X 600mm PANEL SUPPORTED ON "DONN" T37 BEARER DISCREPANCIES, ERRORS AND DIMENSIONS ARE TO BE REPORTED TO THE ARCHITECT (EMPLOYER) .IMMEDIATELY THEY BECOME EVIDENT. 606mm CENTRES IN ONE DIRECTION "DONN" T32 SHPO DRAWINGS TO BE SUBMITTED FOR APPROVAL PRIOR TO MANUFACTURE OR INSTALLATION. BEARERS AT 1206 CENTRES IN OTHER DIRECTION. COPY RIGHT AND RIGHT OF REPRODUCTION OF THIS DRAWINGS OR ANY PORTION THEREOF IS RESERVED BY PG ARCHITECTS. THE BEARERS FINISHED WITH CAPPING OF ALLUMINUM PRE-PAINTED LOW SHEEN SATIN TO MATCH COLOUR OF CEILLING TILES AND SUSPENDED 200mm BELOW STEEL B REFERENCE DRAWINGS FIBER CEMENT CEILING DRAWING NAME / TEKENING NAAM No./Nr. REVISIONS/WYSIGINGS Wysiging Revision Staff Accomodation Ceiting **CEILING PANELS** 1 Layout Plan **STANDARD** 600 TO 600mm -NELSPRUIT 25 Roodt Street Nelspruit, 1200 Phone: 0839992023 Fax: 086 662 8877 Vat: 476 027 7733 Email: patsonqs@gmail.com **CUT CEILING** environmental affairs Department: Environmental Affairs REPUBLIC OF SOUTH AFRICA **NOTES** Ceiling & Roof Plan 1. Fibre Cement Facia JO46-DAE-300-02 2. Wood Float Plaster And Paint As indicated Drawn 3. Truss By Specialist Staff Accomodation Roof 2 Layout Plan

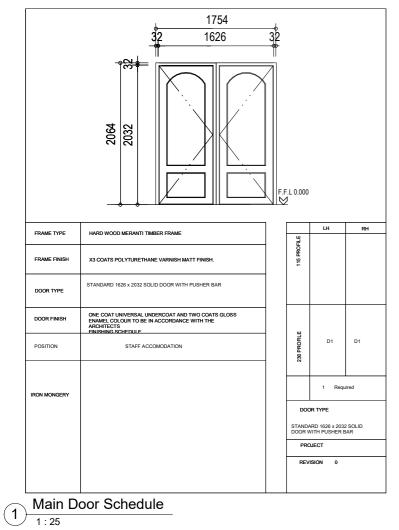

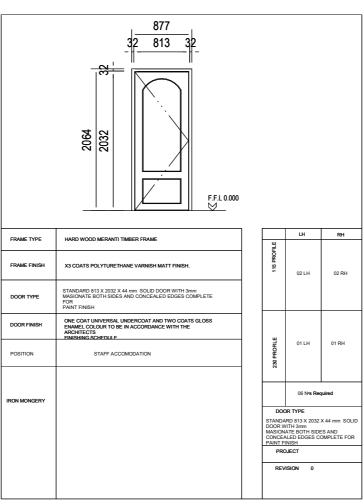

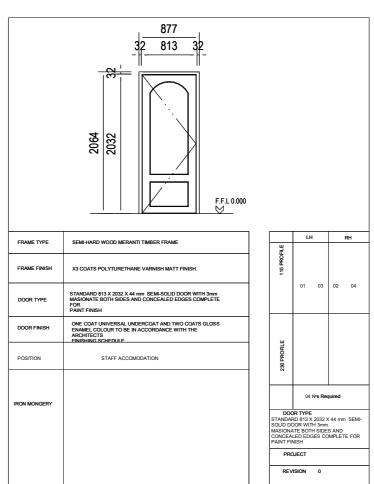



ALL DIMENSIONS ARE INDICATED IN MILLIMETRES AND MUST BE CONTROLLED. ON SITE THIS DRAWING MUST NOT BE SCALED. ONLY FIGURED DIMENSIONS MAY BE USED.

ALL DIMENSIONS AND LEVELS ARE TO BE VERIFIED ON SITE PRIOR TO COMMENCING SETTING OUT WORKSHOP DRAWINGS OR CONSTRUCTION FIGURED DIMENSIONS ONLY TO BE USED. DISCREPANCIES, ERRORS AND DIMENSIONS ARE TO BE REPORTED TO THE ARCHITECT (EMPLOYER)
.IMMEDIATELY THEY BECOME EVIDENT. SHPO DRAWINGS TO BE SUBMITTED FOR APPROVAL PRIOR TO MANUFACTURE OR INSTALLATION.

COPY RIGHT AND RIGHT OF REPRODUCTION OF THIS DRAWINGS OR ANY PORTION THEREOF IS RESERVED BY PG ARCHITECTS.

No./Nr.

-NELSPRUIT

JO46-DAE-400-01


1 : 25 Designed Ontwerp Anthony B.U.E. Geleken Drawn Anthony B.U.E. Nagesien Charles

NOTES:


Room Door Schedule 1:25

Toilet Door Schedule

1:25

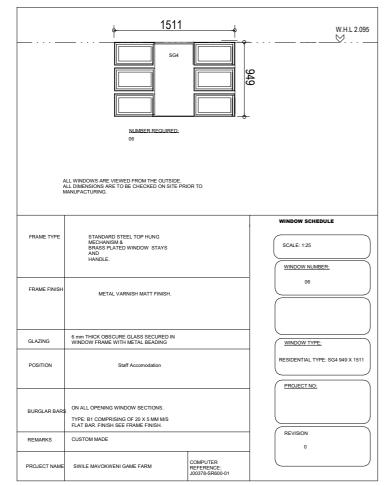

Main Window Schedule 1:25

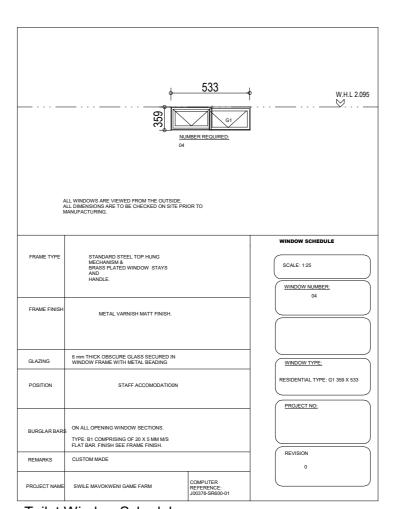

Toilet Window Schedule 2 Tollet

ALL DIMENSIONS ARE INDICATED IN MILLIMETRES AND MUST BE CONTROLLED ON SITE. THIS DRAWING MUST NOT BE SCALED, ONLY FIGURED DIMENSIONS MAY BE USED.

NOTES:

- * ALL DIMENSIONS AND LEVELS ARE TO BE VERIFIED ON SITE PRIOR TO COMMENCING SETTING OUT WORKSHOP DRAWINGS OR CONSTRUCTION
- * FIGURED DIMENSIONS ONLY TO BE USED.
- DISCREPANCIES, ERRORS AND DIMENSIONS ARE TO BE REPORTED TO THE ARCHITECT (EMPLOYER)
 .IMMEDIATELY THEY BECOME EVIDENT.
- SHPO DRAWINGS TO BE SUBMITTED FOR APPROVAL PRIOR TO MANUFACTURE OR INSTALLATION.
- * COPY RIGHT AND RIGHT OF REPRODUCTION OF THIS DRAWINGS OR ANY PORTION THEREOF IS RESERVED BY PG ARCHITECTS.

	INEI EINENGE DIOAWINGS	
	DRAWING NAME / TEKENING NAAM	No./Nr.
	REVISIONS/WYSIGINGS	•
Wysiging Revision	Beskrywing/Description	Datum Date

REFERENCE DRAWINGS



POS QUANTITY SURVEYORS, PROJECT MANAGERS AND DEVELOPMENT CONSULTANT

-NELSPRUIT 25 Roodt Street Nelspruit, 1200 Phone: 0839992023 Fax: 086 662 8877 Vat: 476 027 7733 Email: patsonqs@gmail.com

environmental affairs

Department:
Environmental Affairs
REPUBLIC OF SOUTH AFRICA

SWILE MAVOKWENI GAME LODGE

Window Schedule


JO46-DAE-400-02


1 : 25 Designed Ontwerp Anthony B.U.E. Geteken Drawn Anthony B.U.E. Nagesien Checker

SCHEDULE OF VISITORS ACCOMMODATION

VISITORS ACCOMMODATION: 137m²

BLOCK NAME		AREA m ²	FAR	COVERAGE	
VISITORS ACCOMMODAT	ION	137 m ²			
Bedroom 1		20 m ²			
Bedroom 2		20 m ²			
Bedroom 3		19 m ²			
Bedroom 4		20 m ²			
Patio 1		10 m ²			
Toilet 1		5 m ²			
Toilet 2		5 m ²			
Toilet 3		5 m ²			
Toilet 4		5 m ²			
Potio 2	•	10 m ²		•	

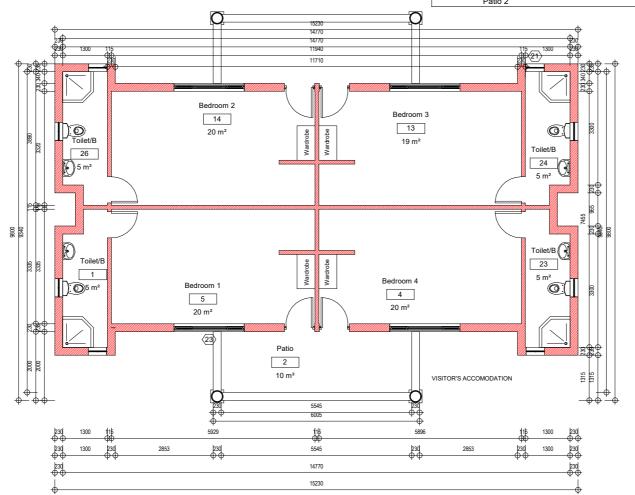

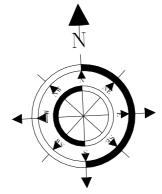

NOTES:

- ALL DIMENSIONS AND LEVELS ARE TO BE VERIFIED ON SITE PRIOR TO COMMENCING SETTING OUT WORKSHOP DRAWINGS OR CONSTRUCTION
- FIGURED DIMENSIONS ONLY TO BE USED.
- DISCREPANCIES, ERRORS AND DIMENSIONS ARE TO BE REPORTED TO THE ARCHITECT (EMPLOYER) .IMMEDIATELY THEY BECOME EVIDENT.
- SHPO DRAWINGS TO BE SUBMITTED FOR APPROVAL PRIOR TO MANUFACTURE OR INSTALLATION.
- COPY RIGHT AND RIGHT OF REPRODUCTION OF THIS DRAWINGS OR ANY PORTION THEREOF IS RESERVED BY PG ARCHITECTS.

	THE ENERGE DIVINITION	
	DRAWING NAME / TEKENING NAAM	No./Nr.
	REVISIONS/WYSIGINGS	
ysiging	Beskrywing/Description	Datum Date

REFERENCE DRAWINGS



OFFICE 25 Roodt Street
Nelspruit, 1200
Phone: 0839992023
Fax: 086 662 8877
Vat: 476 027 7733
Email: patsonqs@gmail.com -NELSPRUIT

environmental affairs Department: Environmental Affairs REPUBLIC OF SOUTH AFRICA


Floor Layout Plan

J050-DEA-100-02


Scale	Designed Ontwerp	Anthony B.U.E.	Issue D
As indicated	Geteken Drawn	Anthony B.U.E.	Issue D
	Nagesien	Checker	Issue D
	Checked		

Visitors Accomodation Floor 1 Layout Plan



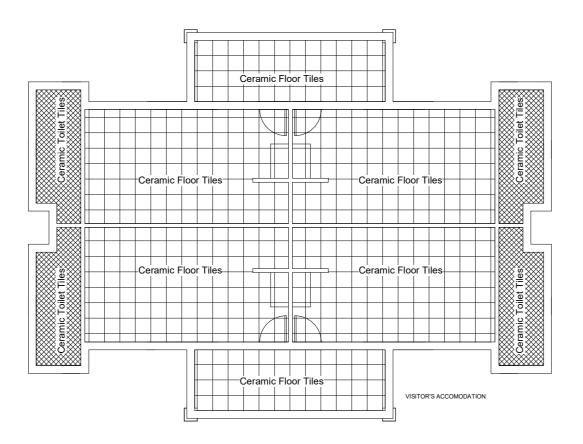

Visitors Accomodation Floor 1 Tiles Layout

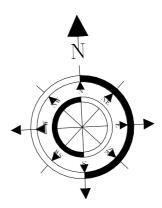

NOTES:

- ALL DIMENSIONS AND LEVELS ARE TO BE VERIFIED ON SITE PRIOR TO COMMENCING SETTING OUT WORKSHOP DRAWINGS OR CONSTRUCTION
- FIGURED DIMENSIONS ONLY TO BE USED.
- DISCREPANCIES, ERRORS AND DIMENSIONS ARE TO BE REPORTED TO THE ARCHITECT (EMPLOYER) .IMMEDIATELY THEY BECOME EVIDENT.
- SHPO DRAWINGS TO BE SUBMITTED FOR APPROVAL PRIOR TO MANUFACTURE OR INSTALLATION.
- COPY RIGHT AND RIGHT OF REPRODUCTION OF THIS DRAWINGS OR ANY PORTION THEREOF IS RESERVED BY PG ARCHITECTS.

	DRAWING NAME / TEKENING NAAM	No./Nr.
	REVISIONS/WYSIGINGS	
Wysiging Revision	Beskrywing/Description	Datum Date

REFERENCE DRAWINGS




OFFICE
25 Roodt Street
Nelspruit, 1200
Phone: 0839992023
Fax: 086 662 8877
Vat: 476 027 7733
Email: patsonqs@gmail.com -NELSPRUIT




Floor Tiles Layout

J050-DEA-100-01

1:50 Geteken
Drawn
Nagesien

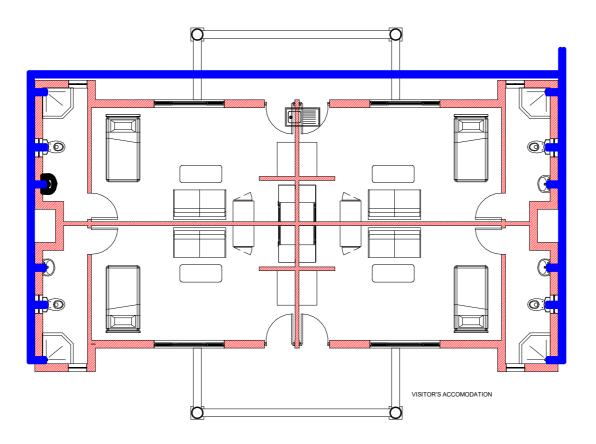

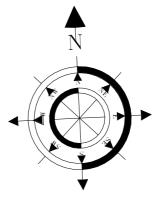

ALL DIMENSIONS ARE INDICATED IN MILLIMETRES AND MUST BE CONTROLLED.
ON SITE: THIS DRAWING MUST NOT BE SCALED. ONLY FIGURED DIMENSIONS MAY BE USED.

NOTES:

- ALL DIMENSIONS AND LEVELS ARE TO BE VERIFIED ON SITE PRIOR TO COMMENCING SETTING OUT WORKSHOP DRAWINGS OR CONSTRUCTION
- FIGURED DIMENSIONS ONLY TO BE USED.
- DISCREPANCIES, ERRORS AND DIMENSIONS ARE TO BE REPORTED TO THE ARCHITECT (EMPLOYER) .IMMEDIATELY THEY BECOME EVIDENT.
- SHPO DRAWINGS TO BE SUBMITTED FOR APPROVAL PRIOR TO MANUFACTURE OR INSTALLATION.
- COPY RIGHT AND RIGHT OF REPRODUCTION OF THIS DRAWINGS OR ANY PORTION THEREOF IS RESERVED BY PG ARCHITECTS.

	REFERENCE DRAWINGS	
	DRAWING NAME / TEKENING NAAM	No./Nr.
	REVISIONS/WYSIGINGS	
Wysiging Revision	Beskrywing/Description	Datum Date



OFFICE Nelson Street Nelson 125 Rood Street Nelsonuit, 1200 Phone: 0839992023 Fax: 086 662 8877 Vat: 476 027 7733 Email: patsonqs@gmail.com -NELSPRUIT


environmental affairs Department: Environmental Affairs REPUBLIC OF SOUTH AFRICA

Cold Water Layout Plan

J050-DEA-100-03

1 : 50 Designed Ontwerp Anthony B.U.E. Geleken Drawn Anthony B.U.E. Nagesien Chapter

Visitors Accomodation Cold 1 Water Layout Plan

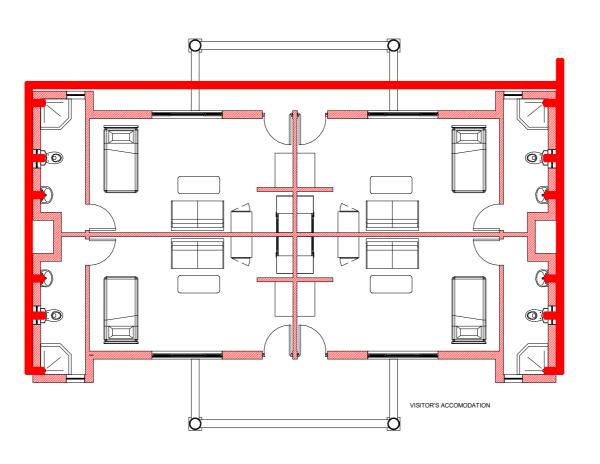

ALL DIMENSIONS ARE INDICATED IN MILLIMETRES AND MUST BE CONTROLLED.
ON SITE: THIS DRAWING MUST NOT BE SCALED. ONLY FIGURED DIMENSIONS MAY BE USED.

NOTES:

- ALL DIMENSIONS AND LEVELS ARE TO BE VERIFIED ON SITE PRIOR TO COMMENCING SETTING OUT WORKSHOP DRAWINGS OR CONSTRUCTION
- FIGURED DIMENSIONS ONLY TO BE USED.
- DISCREPANCIES, ERRORS AND DIMENSIONS ARE TO BE REPORTED TO THE ARCHITECT (EMPLOYER) .IMMEDIATELY THEY BECOME EVIDENT.
- SHPO DRAWINGS TO BE SUBMITTED FOR APPROVAL PRIOR TO MANUFACTURE OR INSTALLATION.
- COPY RIGHT AND RIGHT OF REPRODUCTION OF THIS DRAWINGS OR ANY PORTION THEREOF IS RESERVED BY PG ARCHITECTS.

	REFERENCE DRAWINGS	
	DRAWING NAME / TEKENING NAAM	No./Nr.
	REVISIONS/WYSIGINGS	
Wysiging Revision	Beskrywing/Description	Datum Date



OFFICE Nelson Street Nelson 125 Rood Street Nelsonuit, 1200 Phone: 0839992023 Fax: 086 662 8877 Vat: 476 027 7733 Email: patsonqs@gmail.com -NELSPRUIT





Hot Water Layout Plan

J050-DEA-100-04

1 : 50 Designed Ontwerp Anthony B.U.E. Geleken Drawn Anthony B.U.E. Nagesien Chapter

Visitors Accomodation Hot 1 Water Layout Plan

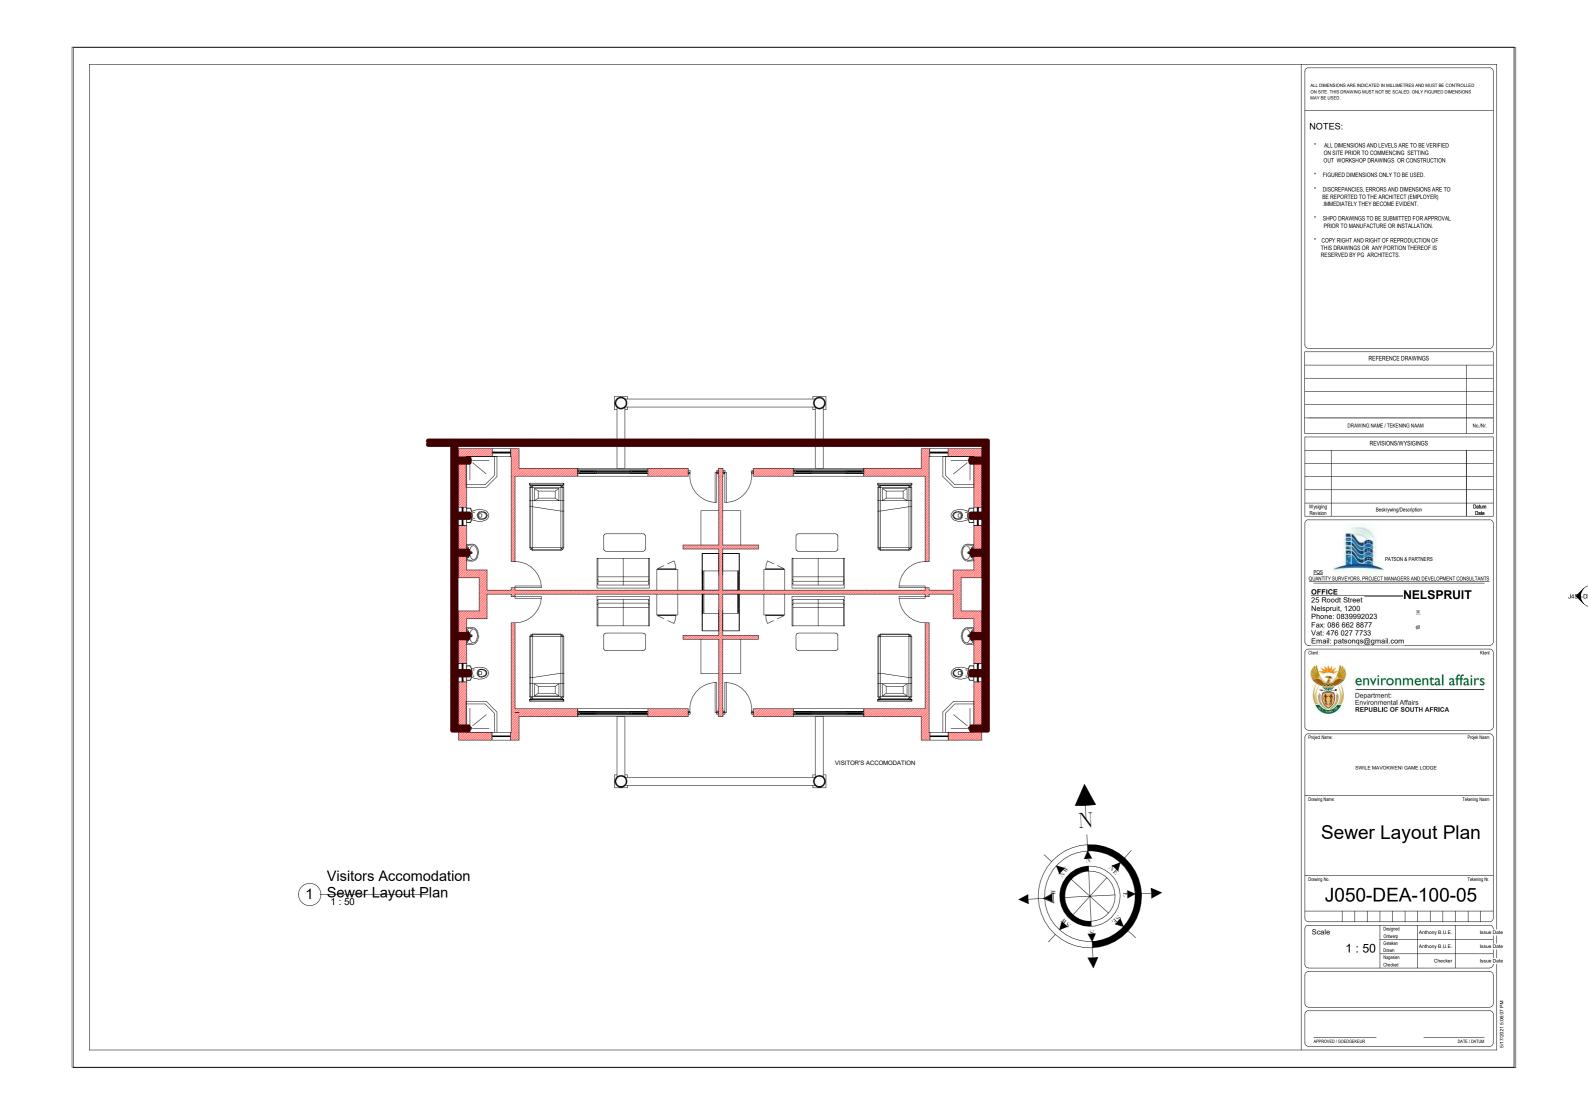

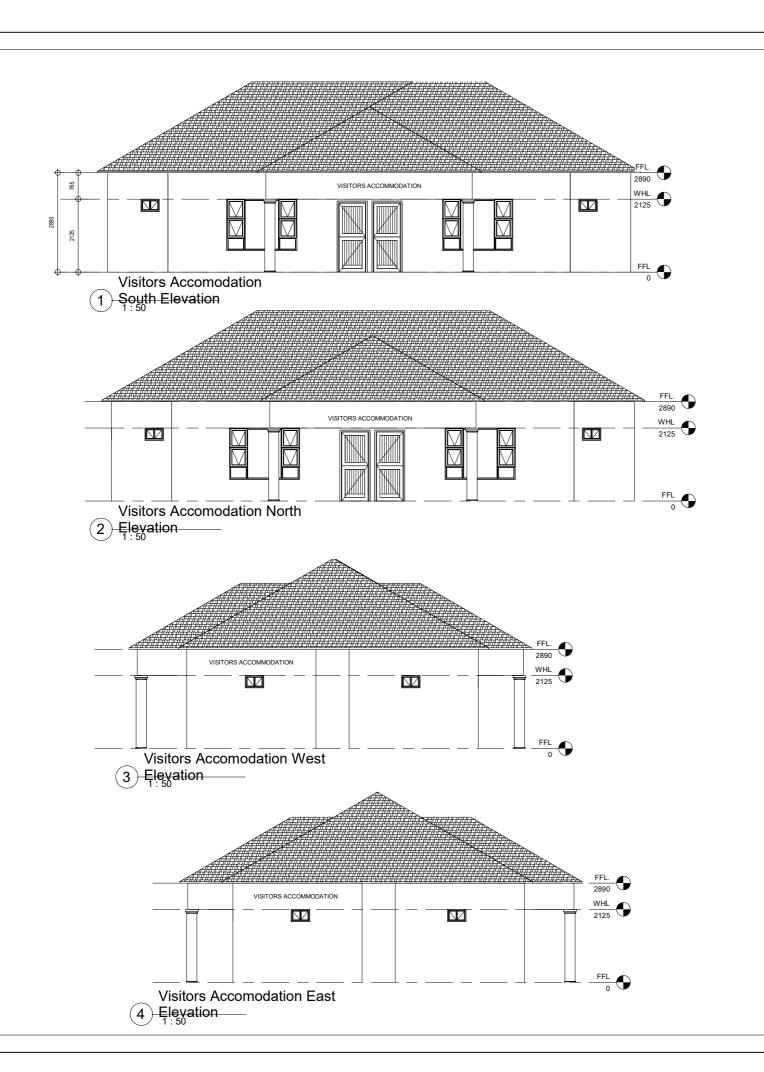

Sealant to be non woven polyester G2 or G3 membrane . Top coat - UV resistant flexible acrylic available in black,charcoal,core or red to employers choice.

1. Roof pitch as indicated

0.8mm Profiled Sheetmetal Ridge Capping, Sealed to Manufacture spec(Chromadek)

- 3. Profiled roof sheeting on purlins.
- 4. 75x50mm S.A Pine Purlins at 700mm c/c on Timber
- Provide S.A.B.S Approved Waterproofing Membrane Above Roof Trusses acc to Manufacture's spec.
- 6. S.A Pine Roof Trusses at 1000mm c/c on Wall Plate. Treat All Exposed Timber with approved applicant to Manufacture 's Spec.
- 7. 114x38mm S.A Pine Timber Wall Plate.
- 8. 225x15mm Fibre Cement Fascia Board or Other Equal approved.
- 9. Ceiling Refer To Finishing Schedules.
- 10. Approved face brick with 5mm recessed
- 11. Windows Refer to Window Schedules.
- 12. Door refer to Door schedule
- 13. Reinforced brickwork lintols reinforced with X2 6.4mm Ø steel bars horizontally with bentwire stirrups bedding in every third vertical joint along the length of the soldier course.
- 14. Skirting Refer to Finishing schedules.
- 15. Floor as per schedule on 40mm screed on concrete
- 16. 85mm thick Concrete slab on S.A.B.S Approved termite poisoning USB Green water proofing Membrane to Engineer's details
- 17. S.A.B.S approved D.P.C to Manufacture Spec.
- 18. 75mm thick apron around building with expansion joints every 3m² width fall away from building.
- 19. Foundation to Engineers details and Approval.
- 20. Well compacted consolidated laterite hardcore by Engineer
- 21 Undisturbed Farth
- 22. Provide Metal Flashing

NOTES:

- ALL DIMENSIONS AND LEVELS ARE TO BE VERIFIED ON SITE PRIOR TO COMMENCING SETTING OUT WORKSHOP DRAWINGS OR CONSTRUCTION
- FIGURED DIMENSIONS ONLY TO BE USED.
- DISCREPANCIES, ERRORS AND DIMENSIONS ARE TO BE REPORTED TO THE ARCHITECT (EMPLOYER)
 .IMMEDIATELY THEY BECOME EVIDENT.
- SHPO DRAWINGS TO BE SUBMITTED FOR APPROVAL PRIOR TO MANUFACTURE OR INSTALLATION.
- COPY RIGHT AND RIGHT OF REPRODUCTION OF THIS DRAWINGS OR ANY PORTION THEREOF IS RESERVED BY PG ARCHITECTS.

	REFERENCE DRAWINGS	
	DRAWING NAME / TEKENING NAAM	No./Nr.
	REVISIONS/WYSIGINGS	
		_
Wysiging Revision	Beskrywing/Description	Datum Date
	-3	



25 Roods Street
Nelspruit, 1200
Phone: 0839992023
Fax: 086 662 8877
Vat: 476 027 7733
Email: patsonqs@gmail.com


environmental affairs Department: Environmental Affairs REPUBLIC OF SOUTH AFRICA


Project Name:		Projek Naam
	SWILE MAVOKWENI GAME LODGE	
Drawing Name:		Tekening Naam

Elevation

J050-DEA-200-01

1:50 Geteken Drawn Nagesien

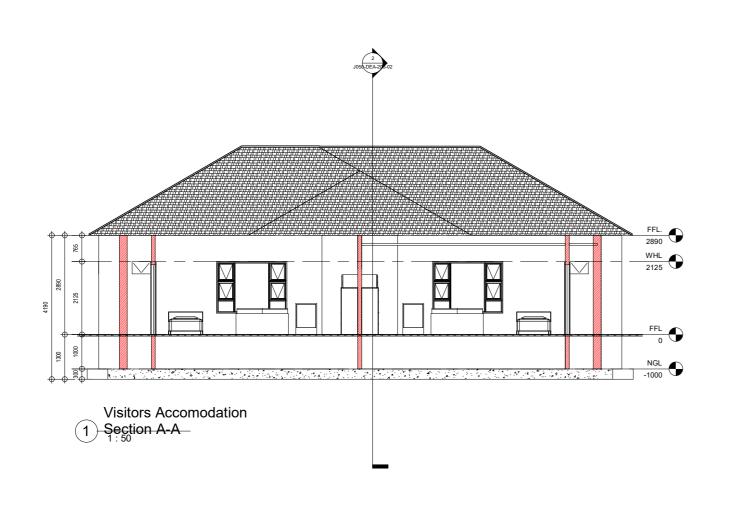

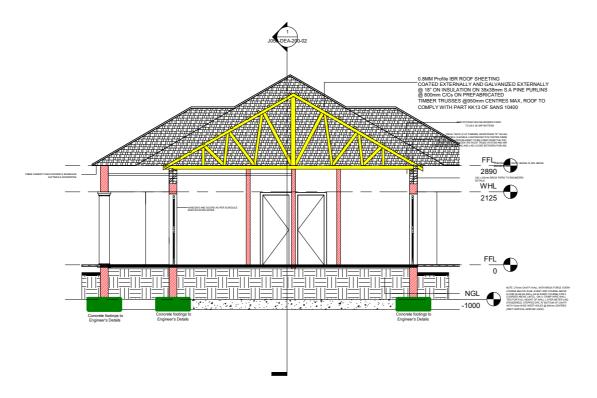

Visitors Accomodation 2 Section B-B

NOTES:

- ALL DIMENSIONS AND LEVELS ARE TO BE VERIFIED ON SITE PRIOR TO COMMENCING SETTING OUT WORKSHOP DRAWINGS OR CONSTRUCTION
- FIGURED DIMENSIONS ONLY TO BE USED.
- DISCREPANCIES, ERRORS AND DIMENSIONS ARE TO BE REPORTED TO THE ARCHITECT (EMPLOYER) .IMMEDIATELY THEY BECOME EVIDENT.
- SHPO DRAWINGS TO BE SUBMITTED FOR APPROVAL PRIOR TO MANUFACTURE OR INSTALLATION.
- COPY RIGHT AND RIGHT OF REPRODUCTION OF THIS DRAWINGS OR ANY PORTION THEREOF IS RESERVED BY PG ARCHITECTS.

DRAWING NAME / TEKENING NAAM	No./Nr.
REVISIONS/WYSIGINGS	

REFERENCE DRAWINGS



OFFICE 25 Roodt Street
Nelspruit, 1200
Phone: 0839992023
Fax: 086 662 8877
Vat: 476 027 7733
Email: patsonqs@gmail.com -NELSPRUIT


environmental affairs Department: Environmental Affairs REPUBLIC OF SOUTH AFRICA

Sections A-A & B-B

J050-DEA-200-02

1:50 Geteken
Drawn
Nagesien

LEGEND NOTES: Must Comply With SABS 10400 ALL DIMENSIONS AND LEVELS ARE TO BE VERIFIED ON SITE PRIOR TO COMMENCING SETTING OUT WORKSHOP DRAWINGS OR CONSTRUCTION SUSPENDED CEILING TO BE FORMED OF 13mm VINYL CLAD GYPSUM TILES FINISH IN GENERALLY 600 X 600mm PANEL SUPPORTED ON "DONN" T37 BEARER DISCREPANCIES, ERRORS AND DIMENSIONS ARE TO A BE REPORTED TO THE ARCHITECT (EMPLOYER) .IMMEDIATELY THEY BECOME EVIDENT. 606mm CENTRES IN ONE DIRECTION "DONN" T32 SHPO DRAWINGS TO BE SUBMITTED FOR APPROVAL PRIOR TO MANUFACTURE OR INSTALLATION. BEARERS AT 1206 CENTRES IN OTHER DIRECTION. COPY RIGHT AND RIGHT OF REPRODUCTION OF THIS DRAWINGS OR ANY PORTION THEREOF IS RESERVED BY PG ARCHITECTS. THE BEARERS FINISHED WITH CAPPING OF ALLUMINUM PRE-PAINTED LOW SHEEN SATIN TO MATCH COLOUR OF CEILLING TILES AND SUSPENDED 200mm BELOW STEEL. B REFERENCE DRAWINGS FIBER CEMENT CEILING DRAWING NAME / TEKENING NAAM No./Nr. REVISIONS/WYSIGINGS VISITOR'S ACCOMODATION **CEILING PANELS** Visitors Accomodation 1) Ceiling Layout Plan **STANDARD** 600 TO 600mm OFFICE 25 Roodt Street Nelspruit, 1200 Phone: 0839992023 Fax: 086 662 8877 Vat: 476 027 7733 Email: patsonqs@gmail.com -NELSPRUIT **CUT CEILING** environmental affairs Department: Environmental Affairs REPUBLIC OF SOUTH AFRICA **NOTES** Ceiling & Roof 1. Fibre Cement Facia Layout Plan J050-DEA-300-01 2. Wood Float Plaster And Paint As indicated Drawn 3. Truss By Specialist Visitors Accomodation Roof 2 Layout Plan

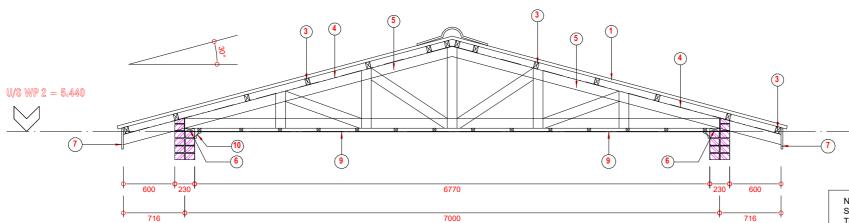

ROOF TRUSS TYPE "C" SCALE 1:20

Visitors Accomodation Roof

1 Trus Details

NOTES:

Sealant to be non woven polyester G2 or G3 membrane . Top coat - UV resistant flexible acrylic available in black, charcoal,core or red to employers choice.

- Profiled roof sheeting on 75x50mm
 SA pine purlins on prefabricated roof structure, treat all exposed timber with approved applicant.
- 2. Proved Fibre Cement Barge Boad
- 3. 75x50mm S.A pine Timber Purlins at 700mm c/c on timber trusses.
- 4. 0.5mm thick SABS Approved water proofing membane
- 5. 114x38mm S.A pine Timber Trusses at 1200mm c/c on wall plate
- 6. 114x38mm S.A pine Timber wall plate
- 225x15mm Fibre cement fascia board or other equal approved
- 38x38mm S.A pine Timber Brandering at 450mm c/c minimum
- 9. 6mm thick Fibre cement ceiling to finishing schedule
- 10. Cornice to finishing schedule
- 11. Provide Head and Counter Metal Flashing
- 12. 152x89mm Timber Rafters, Roof Truss Members to Engineer's Details and Spec
- 13. Reinforced Concrete Gutter to Engineer's Details and Spec
- 14. 120x55mm Channel fixed to Details
- 15. Profiled roof sheeting

ALL DIMENSIONS ARE INDICATED IN MILLIMETRES AND MUST BE CONTROLLED.
ON SITE. THIS DRAWING MUST NOT BE SCALED. ONLY FIGURED DIMENSIONS
MAY BE USED.

NOTES:

- * ALL DIMENSIONS AND LEVELS ARE TO BE VERIFIED ON SITE PRIOR TO COMMENCING SETTING OUT WORKSHOP DRAWINGS OR CONSTRUCTION
- FIGURED DIMENSIONS ONLY TO BE USED.
- DISCREPANCIES, ERRORS AND DIMENSIONS ARE TO BE REPORTED TO THE ARCHITECT (EMPLOYER) .IMMEDIATELY THEY BECOME EVIDENT.
- * SHPO DRAWINGS TO BE SUBMITTED FOR APPROVAL PRIOR TO MANUFACTURE OR INSTALLATION.
- COPY RIGHT AND RIGHT OF REPRODUCTION OF THIS DRAWINGS OR ANY PORTION THEREOF IS RESERVED BY PG ARCHITECTS.

	REFERENCE DRAWINGS	
	DRAWING NAME / TEKENING NAAM	No./Nr.
	REVISIONS/WYSIGINGS	
Wysiging Revision	Beskrywing/Description	Datum Date



PATSON & PARTNERS

PQS QUANTITY SURVEYORS, PROJECT MANAGERS AND DEVELOPMENT CONSULTANT:

OFFICE 25 Roodt Street

NELSPRUIT

Nelspruit, 1200

Phone: 0839992023

Fax: 086 662 8877

√at: √476 027 7733

Email: patsonqs@gmail.com

alsoniqs@gmail.com



REPUBLIC OF SOUTH AFRICA

Project Name:

Project Na


me:


Roof Truss Details

J050-DEA-300-02

APPROVED / GOEDGEKEUR DATE / DATE

IIIM

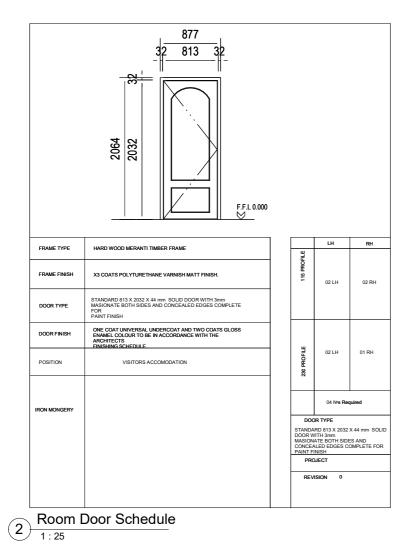

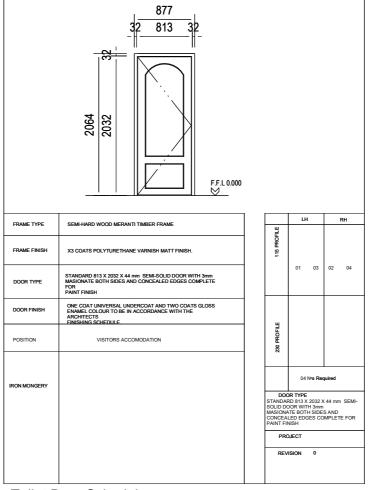

Toilet Door Schedule

ALL DIMENSIONS ARE INDICATED IN MILLIMETRES AND MUST BE CONTROLLED ON SITE. THIS DRAWING MUST NOT BE SCALED. ONLY FIGURED DIMENSIONS MAY BE USED.

NOTES:

- * ALL DIMENSIONS AND LEVELS ARE TO BE VERIFIED ON SITE PRIOR TO COMMENCING SETTING OUT WORKSHOP DRAWINGS OR CONSTRUCTION
- * FIGURED DIMENSIONS ONLY TO BE USED.
- DISCREPANCIES, ERRORS AND DIMENSIONS ARE TO BE REPORTED TO THE ARCHITECT (EMPLOYER) IMMEDIATELY THEY BECOME EVIDENT.
- * SHPO DRAWINGS TO BE SUBMITTED FOR APPROVAL PRIOR TO MANUFACTURE OR INSTALLATION.
- COPY RIGHT AND RIGHT OF REPRODUCTION OF THIS DRAWINGS OR ANY PORTION THEREOF IS RESERVED BY PG ARCHITECTS.

DRAWING NAME / TEKENING NAAM	No./Nr.
REVISIONS/WYSIGINGS	
	Datum

REFERENCE DRAWINGS





Project Name: Projek Na
SWILE MAVOKWENI GAME LODGE
Drawing Name: Telephing Na

Door Schedule


J050-DEA-400-01

Scale


Designed Anthony B.U.E. Issue D. Cheker Dawn

1:25 Designed Anthony B.U.E. Issue D. Dawn
Nagesien Checker Issue D. Checker Issue D.

PDROVED I COEDICEVEUR DATE / DATI IM

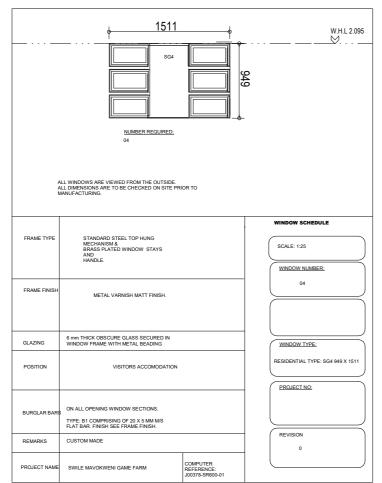

Main Window Schedule 1:25

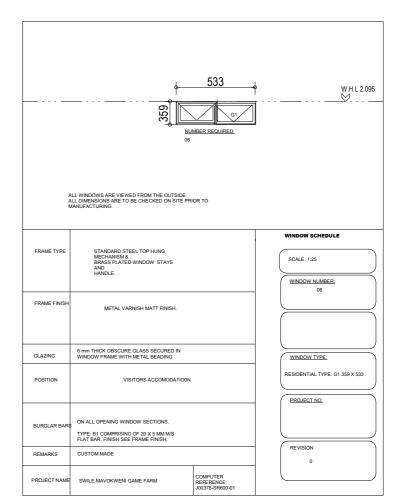

Toilet Window Schedule 1:25

ALL DIMENSIONS ARE INDICATED IN MILLIMETRES AND MUST BE CONTROLLED ON SITE. THIS DRAWING MUST NOT BE SCALED, ONLY FIGURED DIMENSIONS MAY BE USED.

NOTES:

- * ALL DIMENSIONS AND LEVELS ARE TO BE VERIFIED ON SITE PRIOR TO COMMENCING SETTING OUT WORKSHOP DRAWINGS OR CONSTRUCTION
- * FIGURED DIMENSIONS ONLY TO BE USED.
- DISCREPANCIES, ERRORS AND DIMENSIONS ARE TO BE REPORTED TO THE ARCHITECT (EMPLOYER)
 .IMMEDIATELY THEY BECOME EVIDENT.
- SHPO DRAWINGS TO BE SUBMITTED FOR APPROVAL PRIOR TO MANUFACTURE OR INSTALLATION.
- * COPY RIGHT AND RIGHT OF REPRODUCTION OF THIS DRAWINGS OR ANY PORTION THEREOF IS RESERVED BY PG ARCHITECTS.

	DRAWING NAME / TEKENING NAAM	No./Nr.		
REVISIONS/WYSIGINGS				
Wysiging Revision	Beskrywing/Description	Datum Date		
	-3			

REFERENCE DRAWINGS



environmental affairs


Department:
Environmental Affairs
REPUBLIC OF SOUTH AFRICA Department: Environmental Affairs REPUBLIC OF SOUTH AFRICA


SWILE MAVOKWENI GAME LODGE


Window Schedule


J050-DEA-400-02


1 : 25 Designed Ontwerp Anthony B.U.E. Geteken Drawn Anthony B.U.E. Nagesien Checker

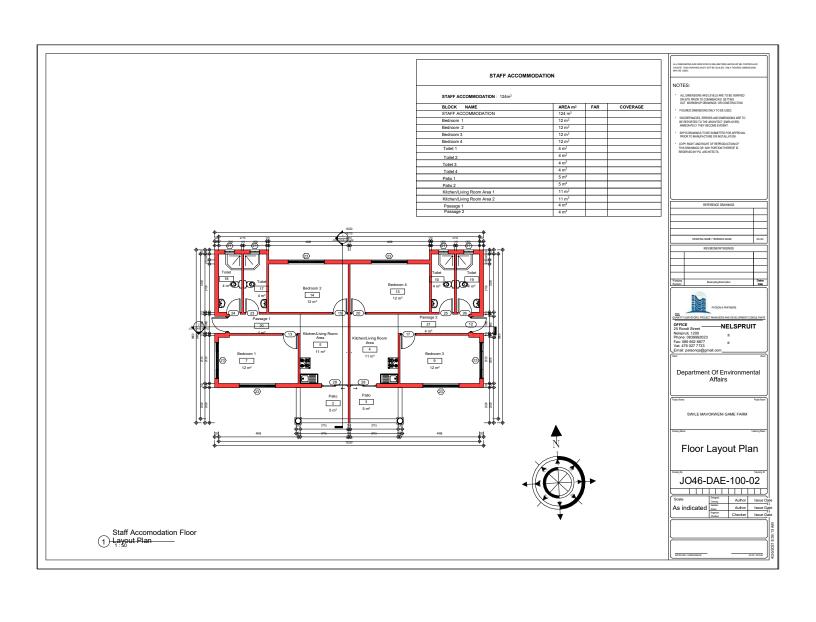


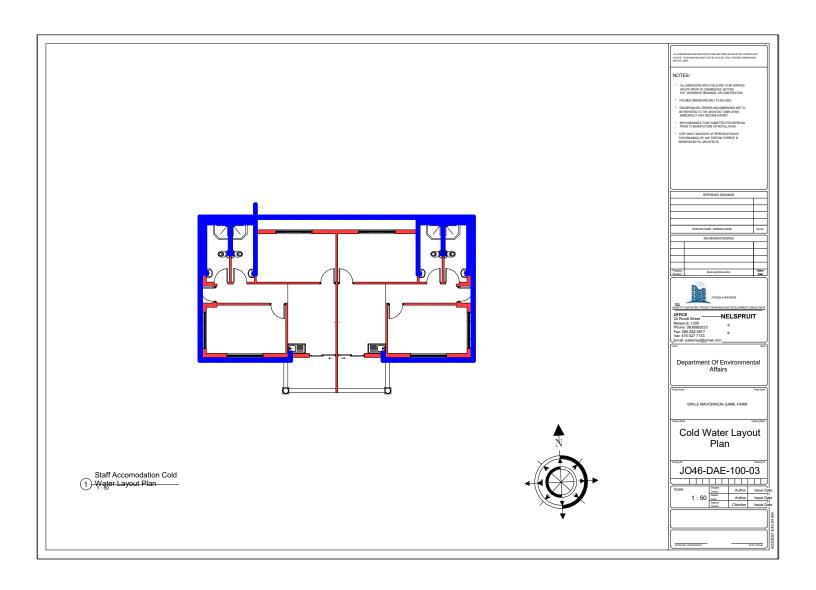


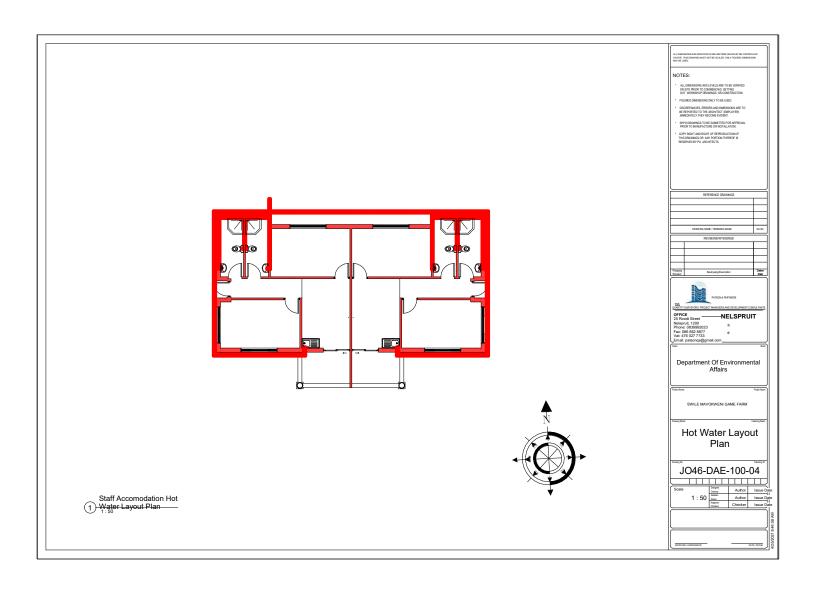


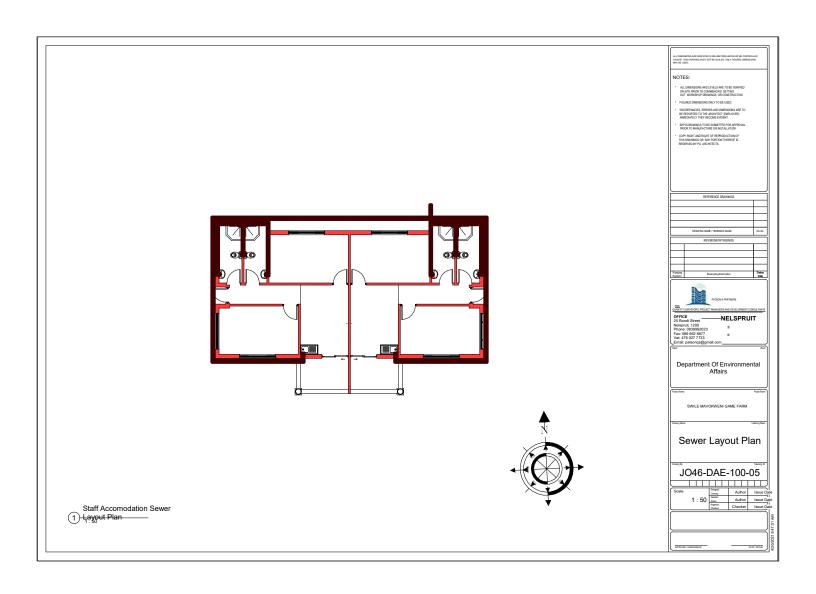


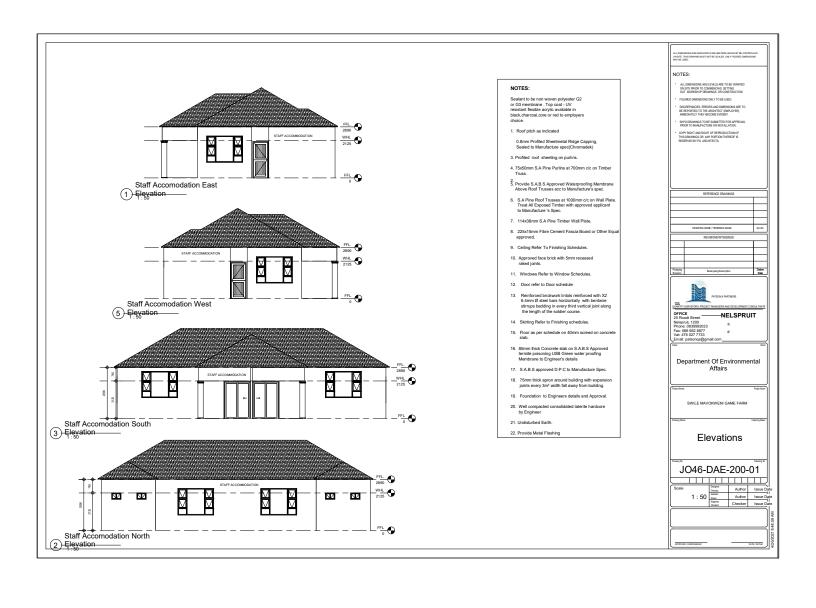


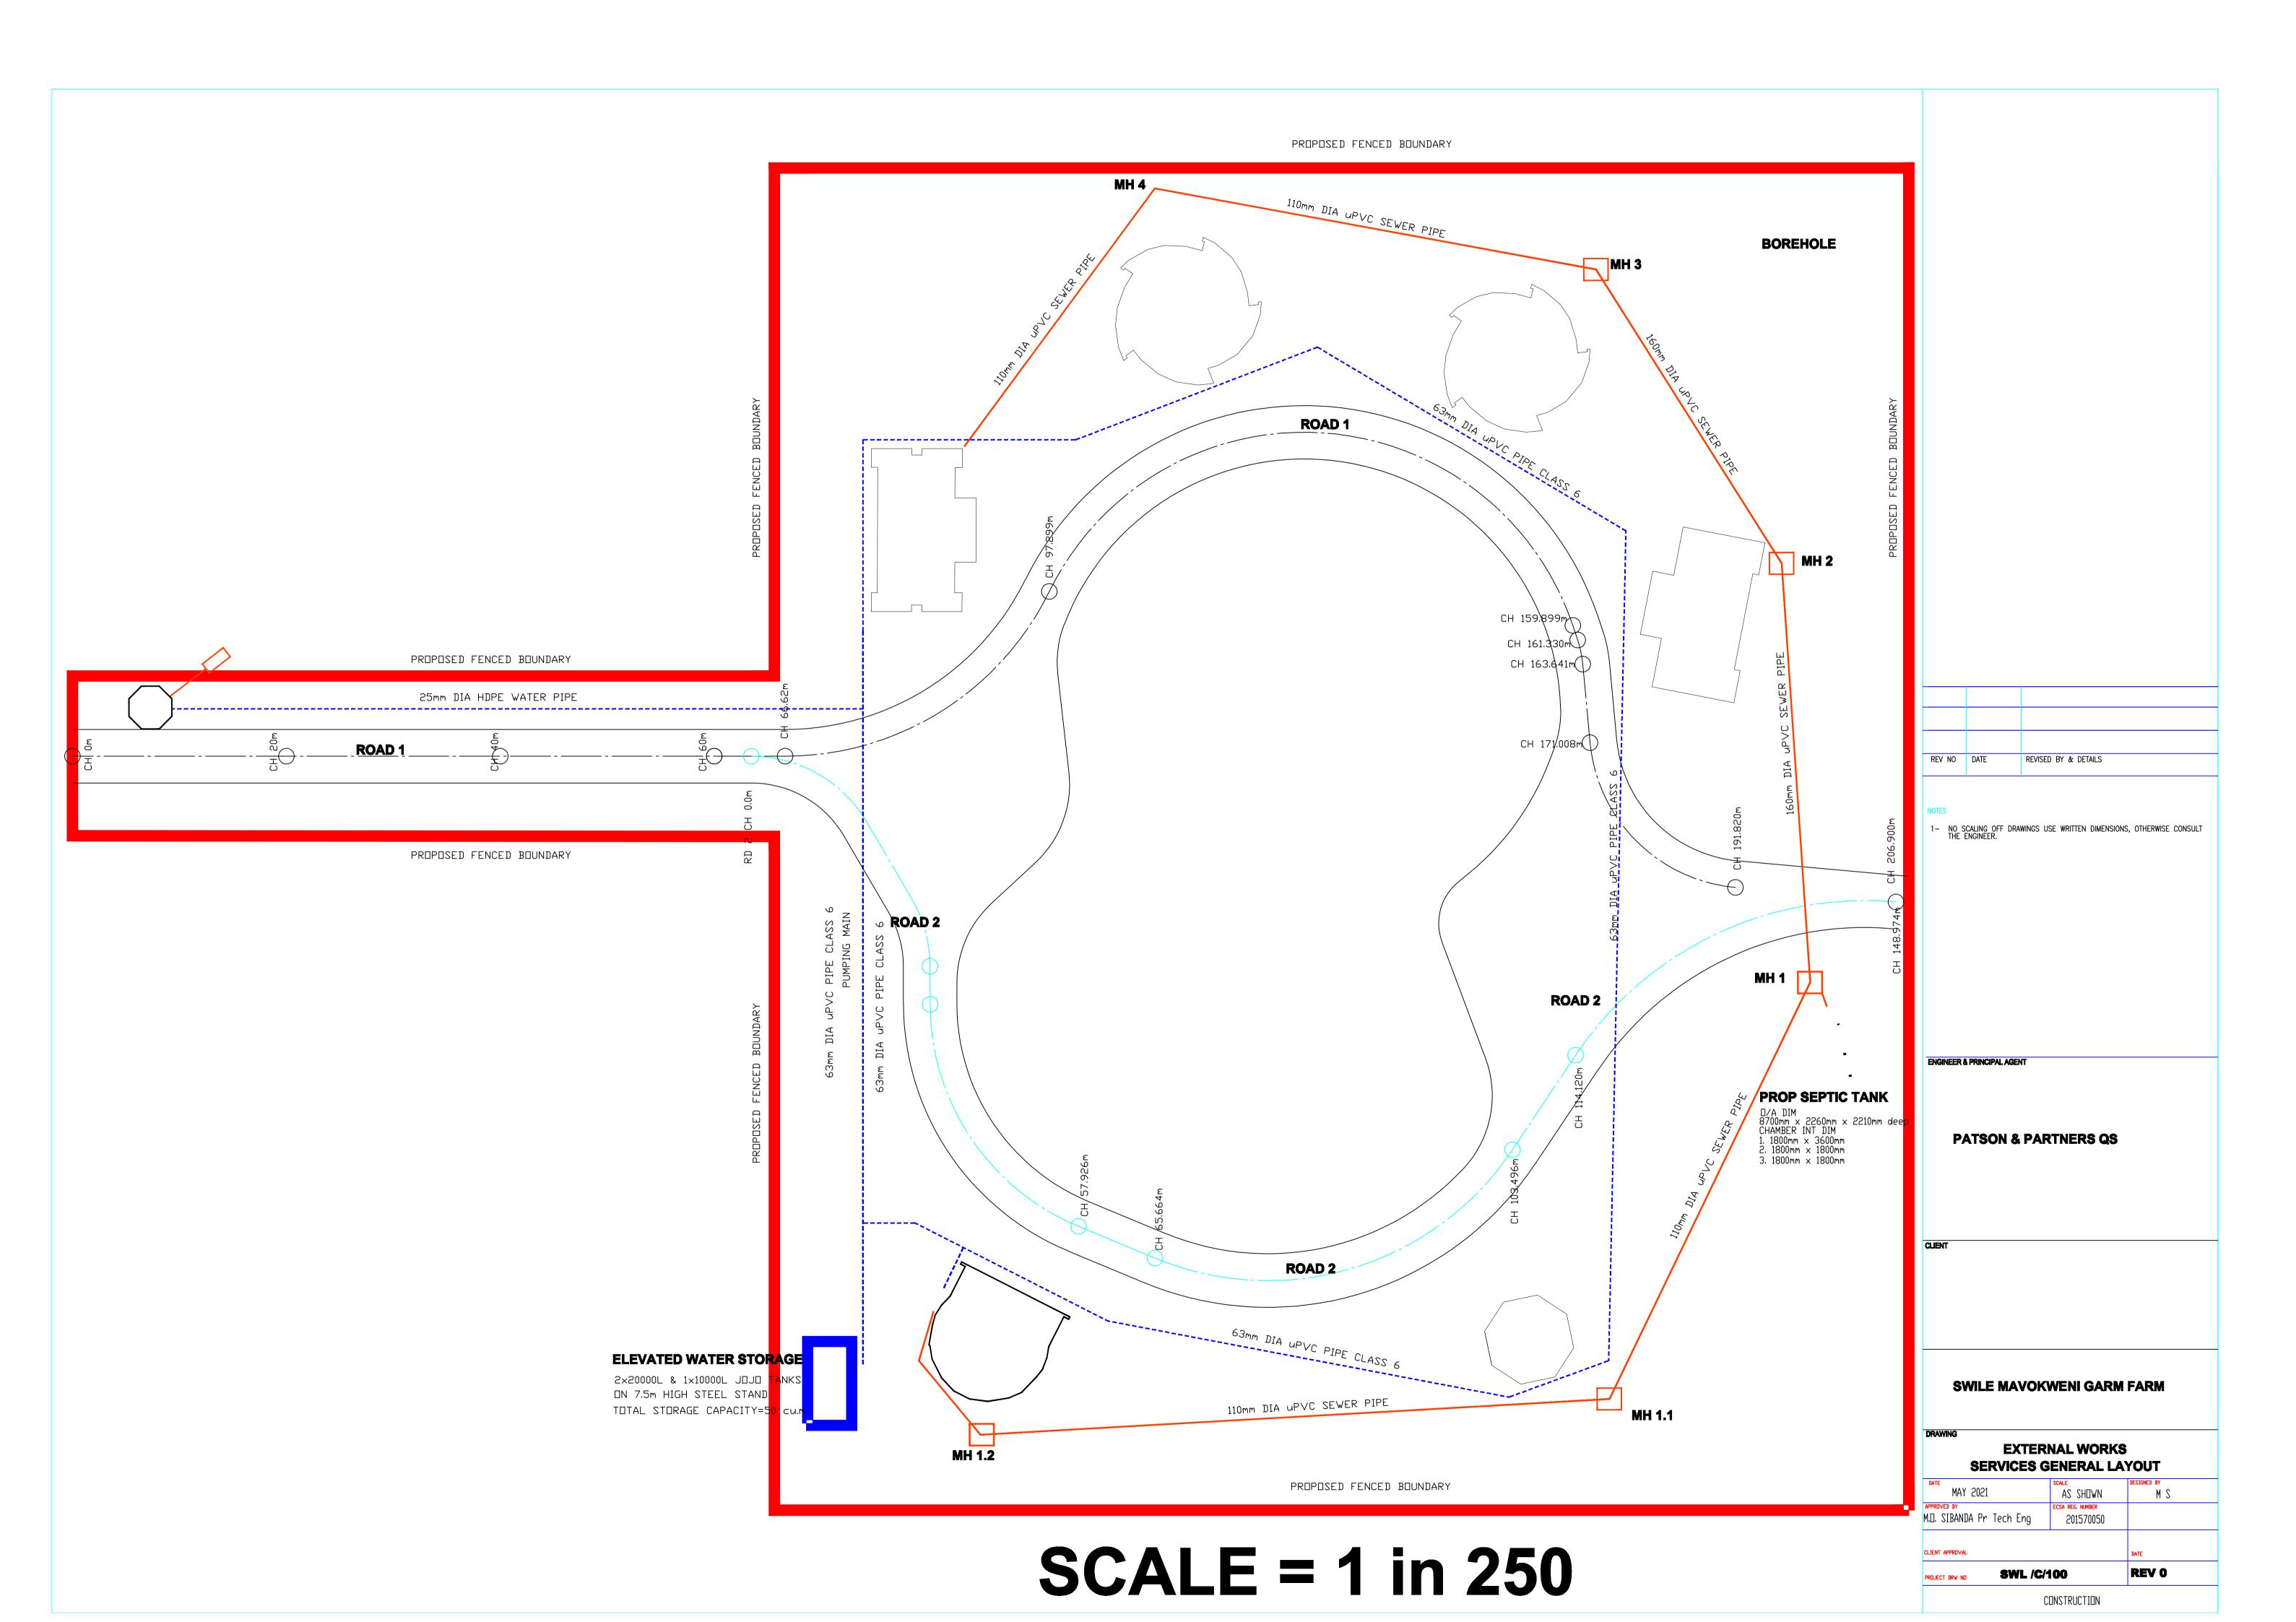


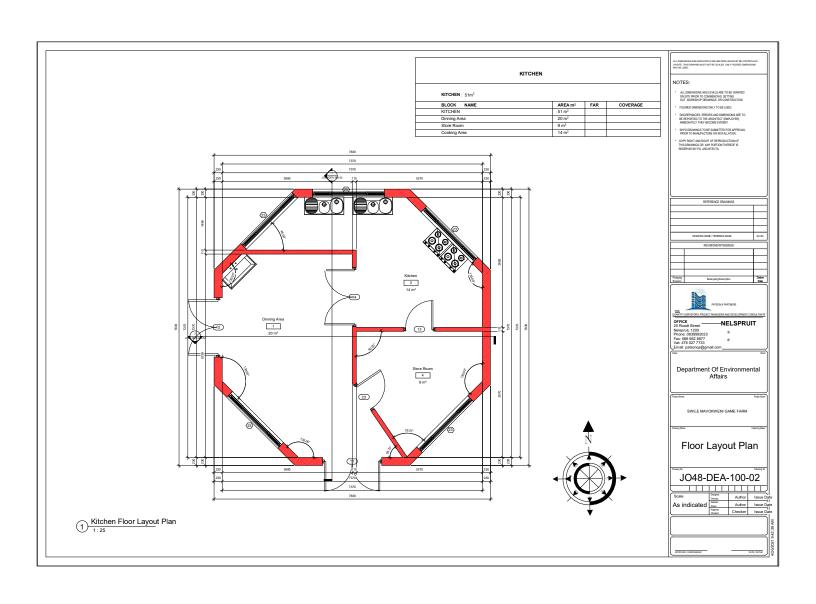


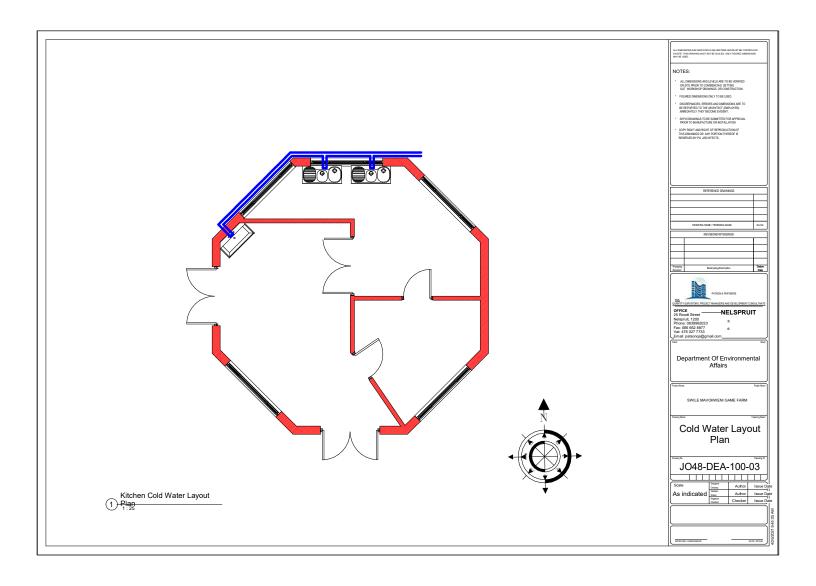


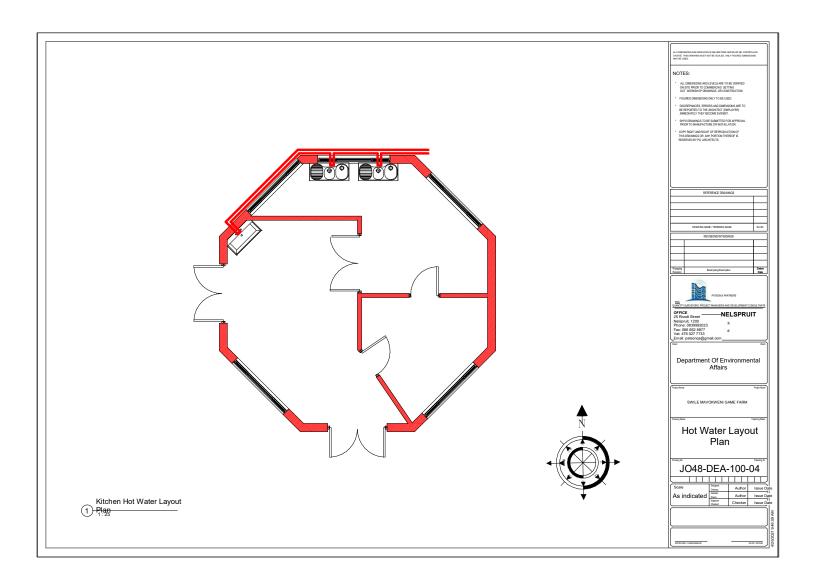

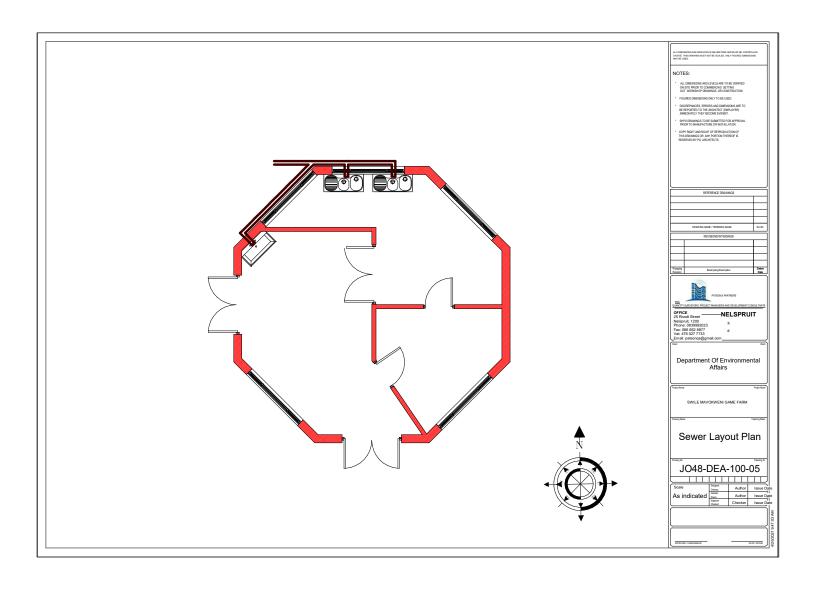


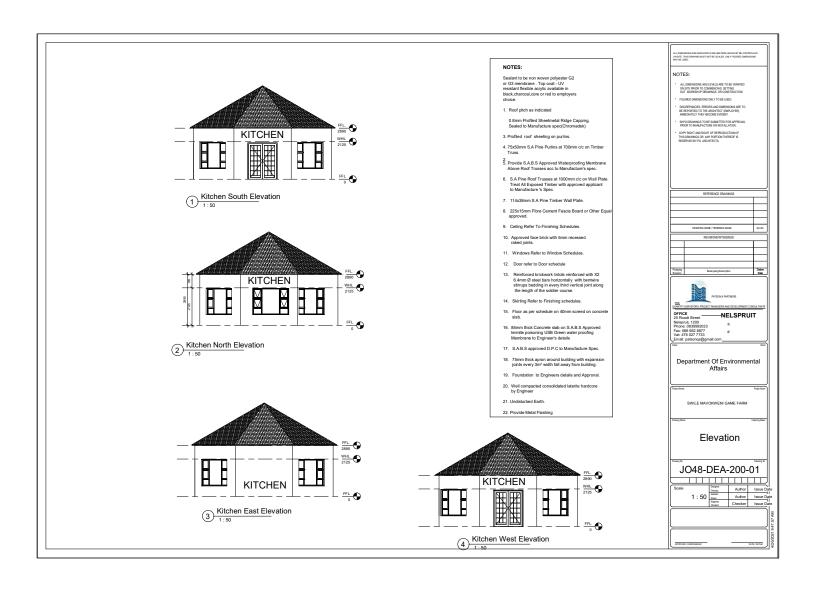


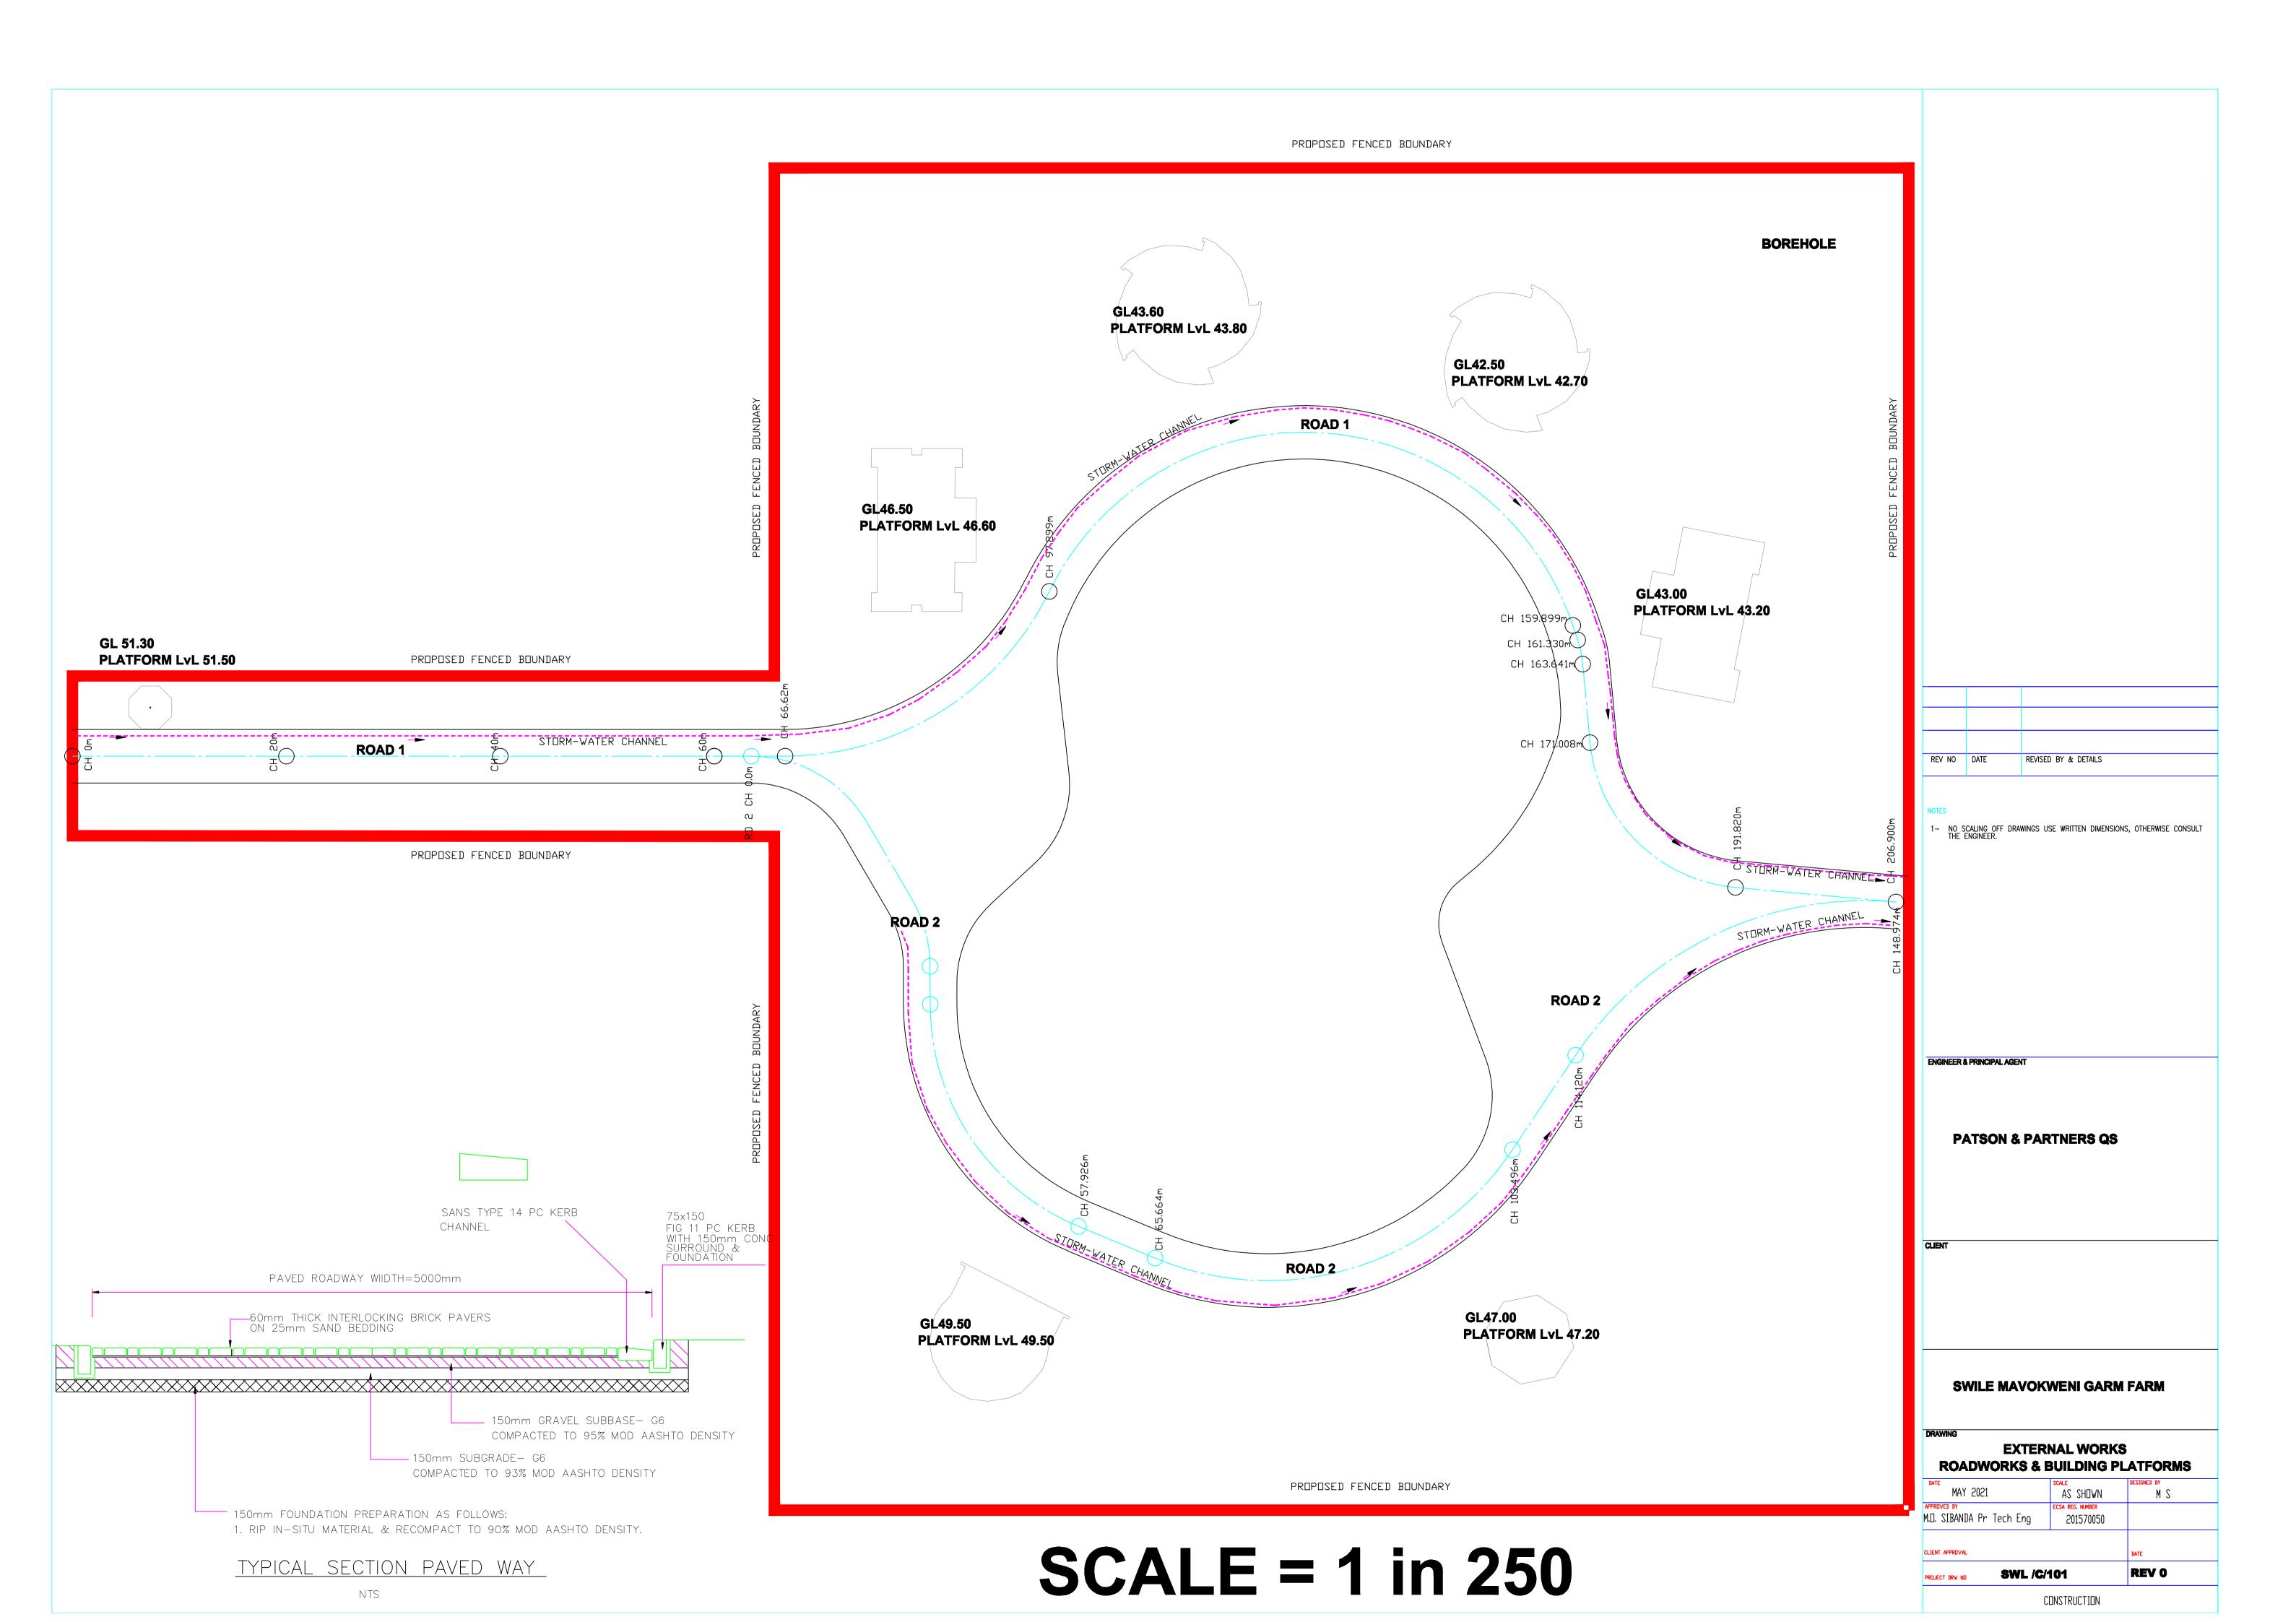


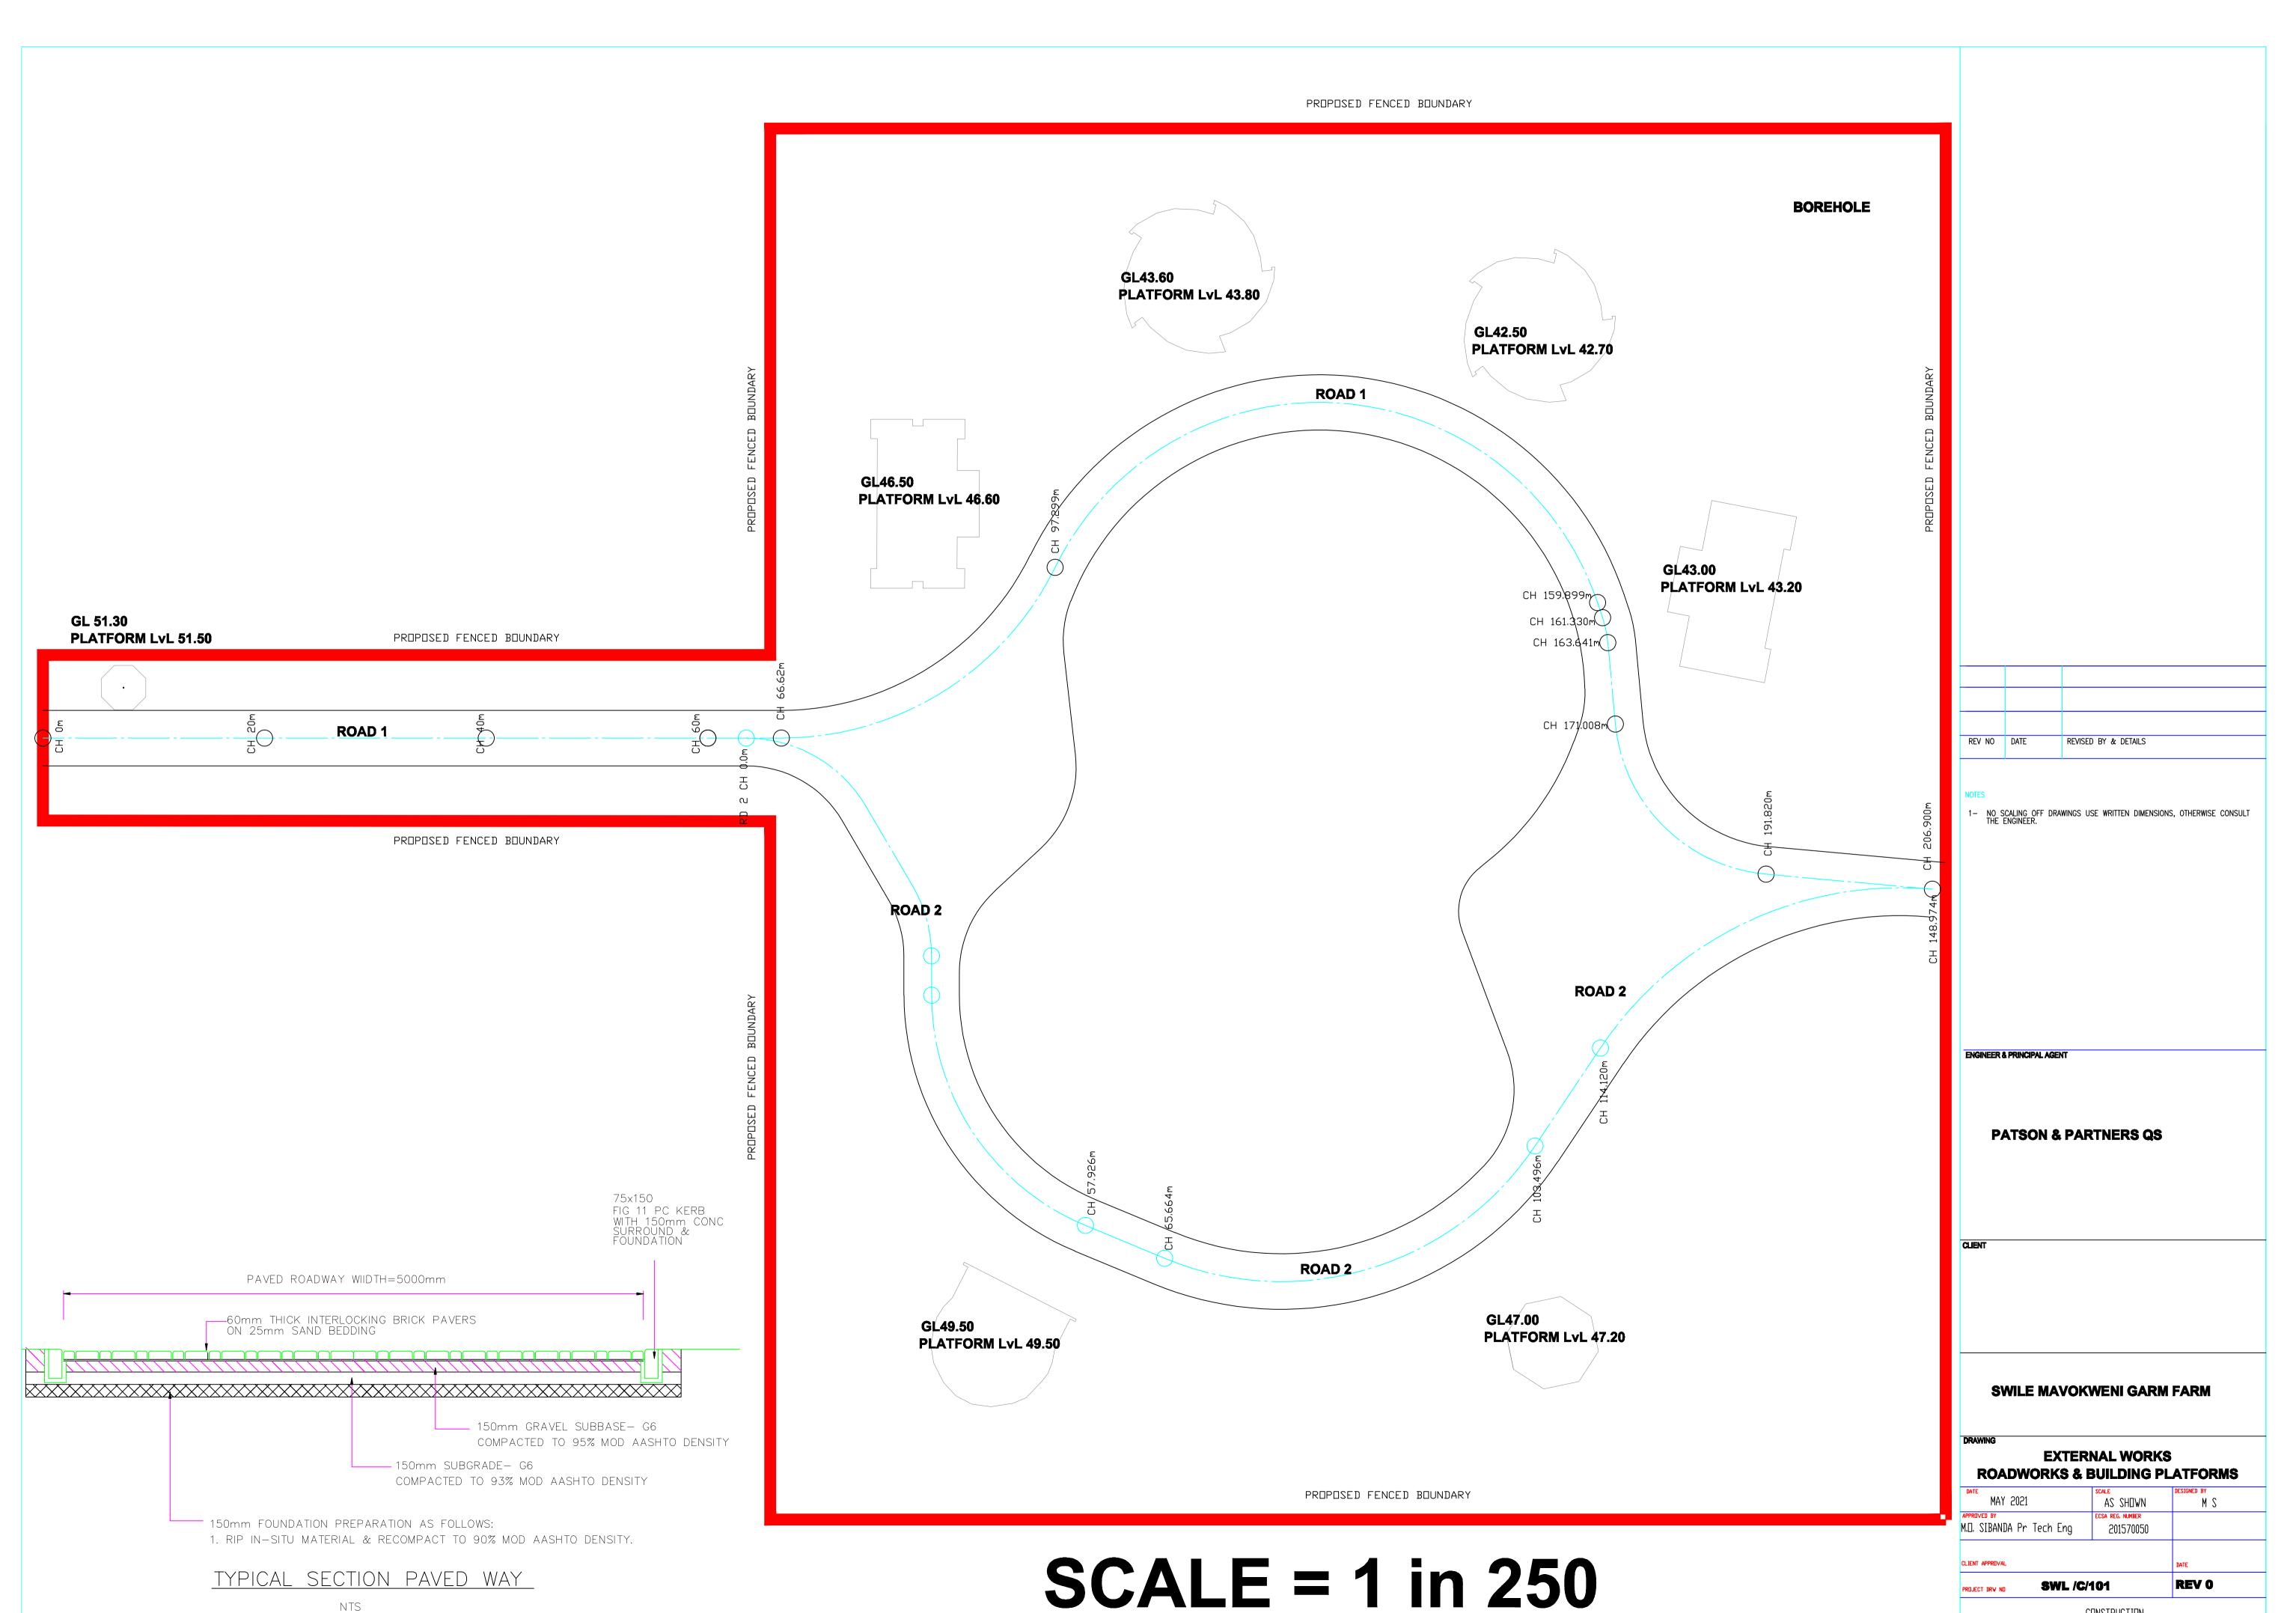



CONSTRUCTION

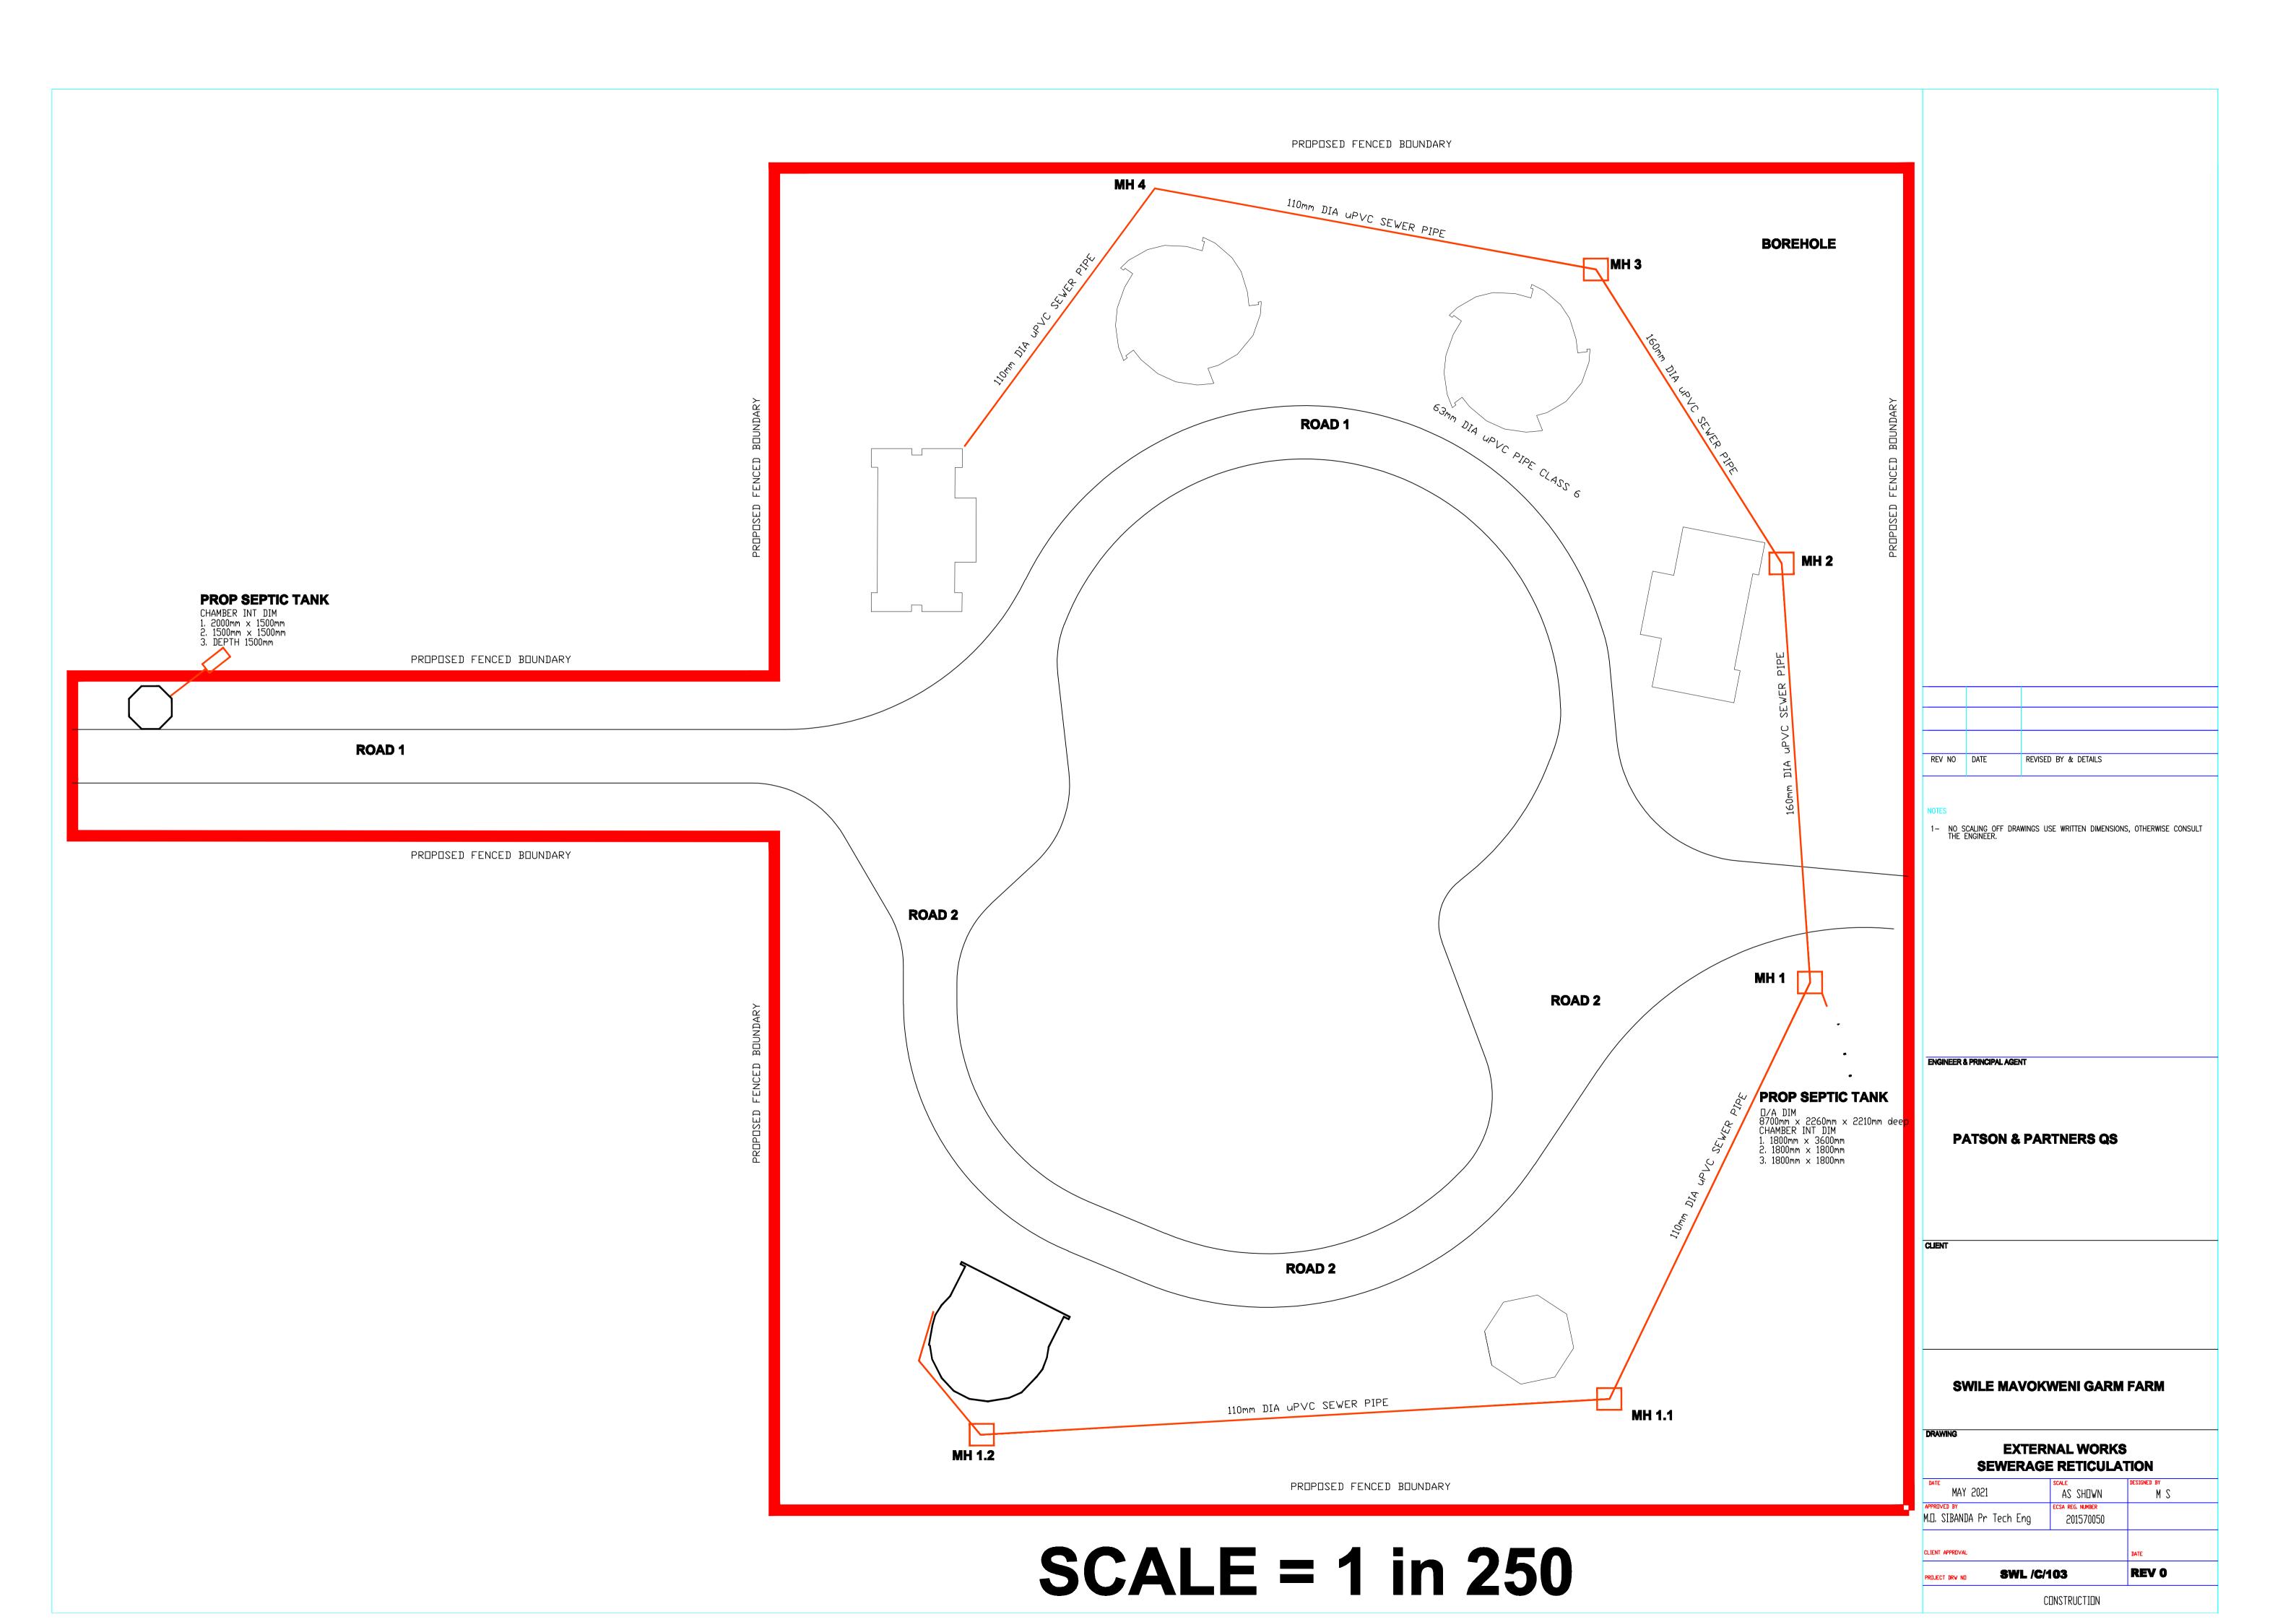


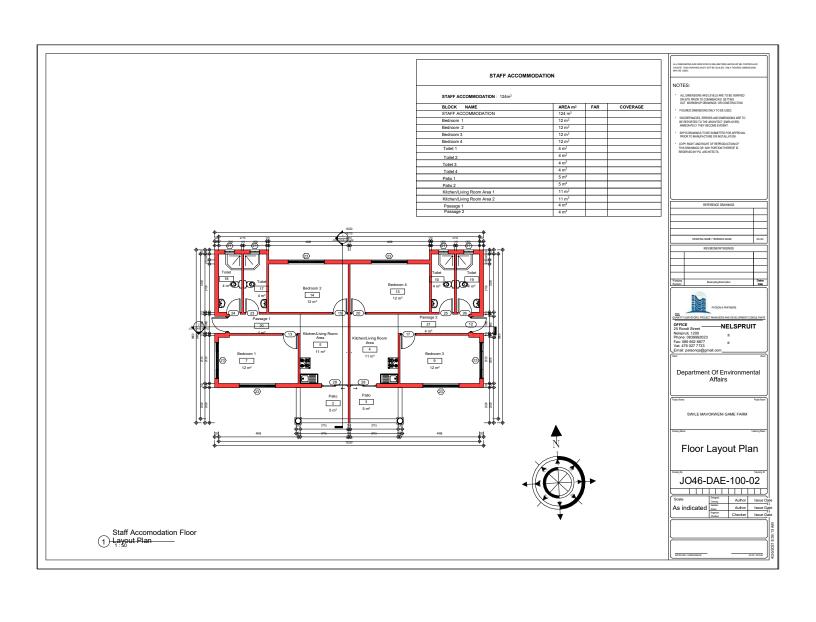


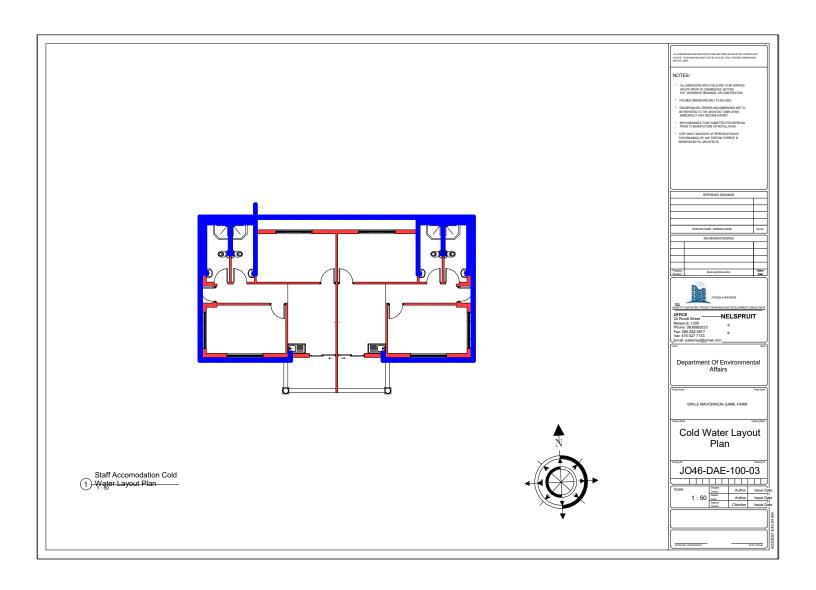

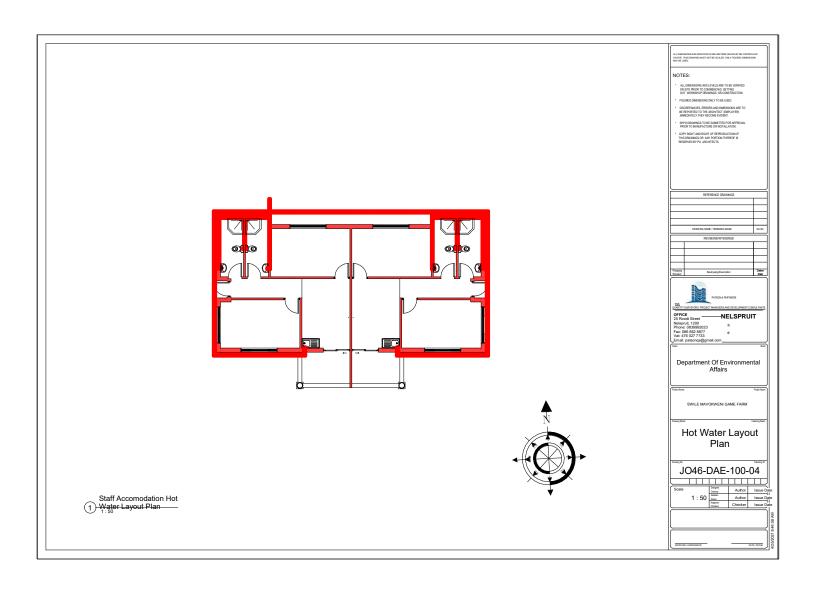


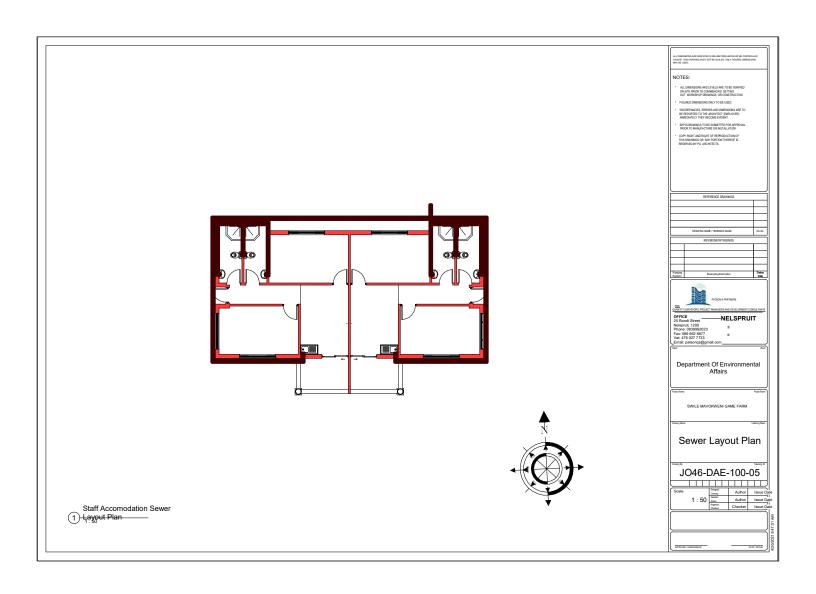

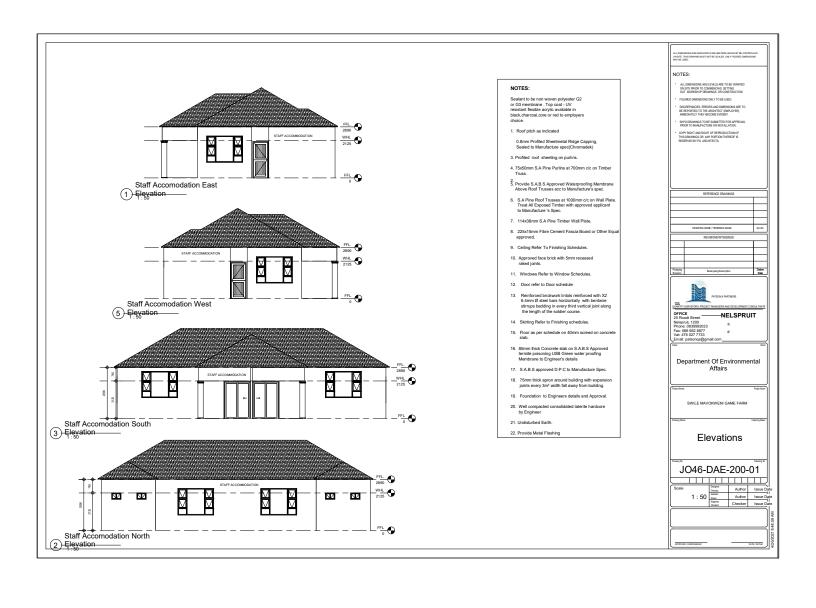


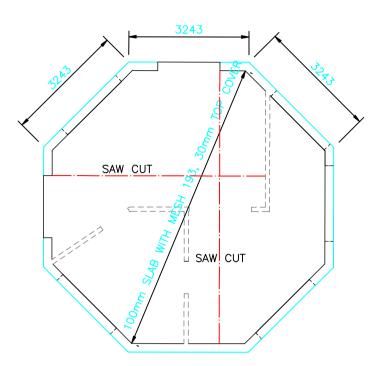

SLAB LAYOUT SCALE 1:100

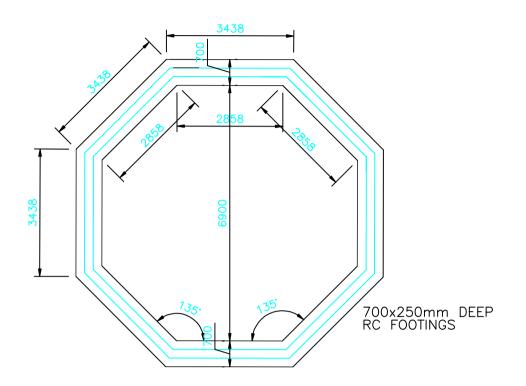



FOUNDATION LAYOUT SCALE 1:100

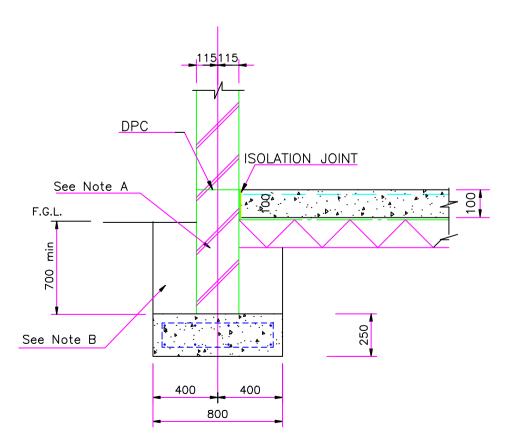



TYPICAL SECTION THROUGH 230 WALLS SCALE 1:20


A 14MPA FOUNDATION BRICKWORK WITH BRICKFORCE IN EACH COURSE UP TO DPC LEVEL B EXCAVATED MATERIAL RETURNED AND COMPACTED IN 150mm LAYERS TO 95% Mod AASHTO DENSITY

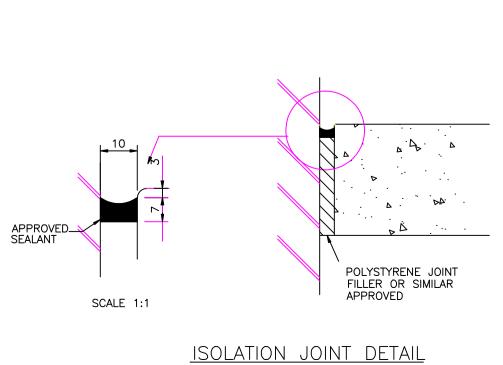

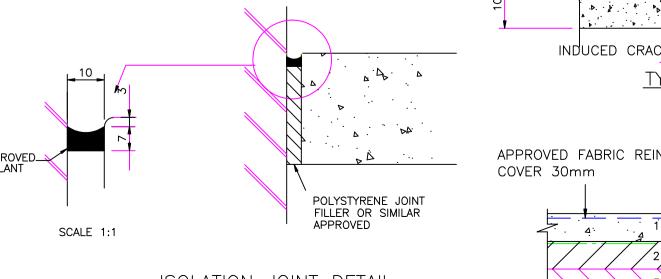


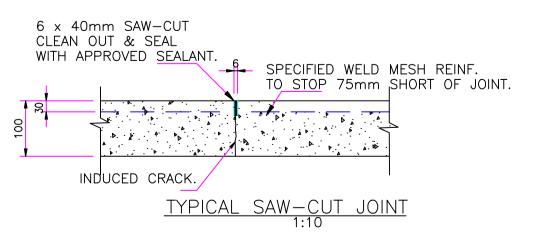

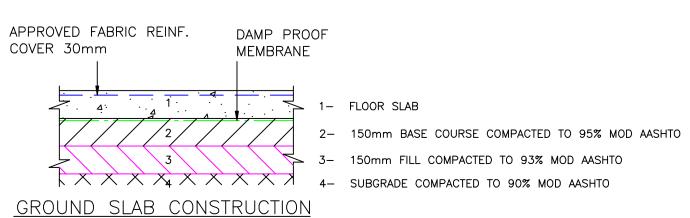

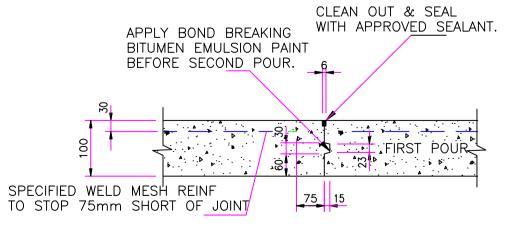

TYPICAL CONSTRUCTION JOINT 1:10

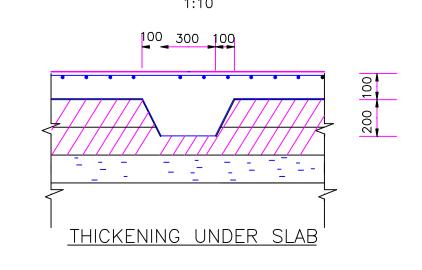

REVISED BY & DETAILS

1- NO SCALING OFF DRAWINGS USE WRITTEN DIMENSIONS, OTHERWISE CONSULT THE ENGINEER.
2- CONCRETE GRADE - FOOTINGS 25 MPa

3- ALL EXPOSED CONCRETE SURFACES TO BE SMOOTH OFF-SHUTTER. 4- ALL EXPOSED CONCRETE EDGES TO HAVE 20 x 20 CORNER CHAMFERS. 5- CHARACTERISTIC STRENGTH OF REINFORCEMENT: -HIGH TENSILE 460 MPa -MILD TENSILE 250 MPa

6- COVER TO REINFORCEMENT TO BE: -FLOORS 50mm -BEAMS/COLUMNS 30mm -BASES 50mm

BE APPROVED BY THE ENGINEER BEFORE CONCRETING.

PATSON & PARTNERS QS

ENGINEER & PRINCIPAL AGENT

7- ALL REINFORCEMENT TO BE APPROVED BY THE ENGINEER BEFORE CONCRETING.

8- THE ALLOWABLE BEARING CAPACITY UNDER FOUNDATIONS IS 150 KPg .THE CONTRACTOR IS TO ALLOW FOR TESTING IF REQUIRED & ALL EXCAVATIONS TO


9- Support of Reinforcement with Stools to be used by the contractor even where details are shown.

FOOTINGS 25 MPaSTRUCTURAL WALLS 30 MPaFIRST FLOORS 30 MPaBLINDING 15 MPa


-WELD MESH 460 MPa

SWILE MAVOKWENI GARM FARM KITCHEN FOUNDATION & SLAB DETAILS NWOH2 2A ΜS ECSA REG. NUMBER M.D. SIBANDA Pr Tech Eng 201570050 CLIENT APPROVAL REV 0 **SWL** 101

CONSTRUCTION

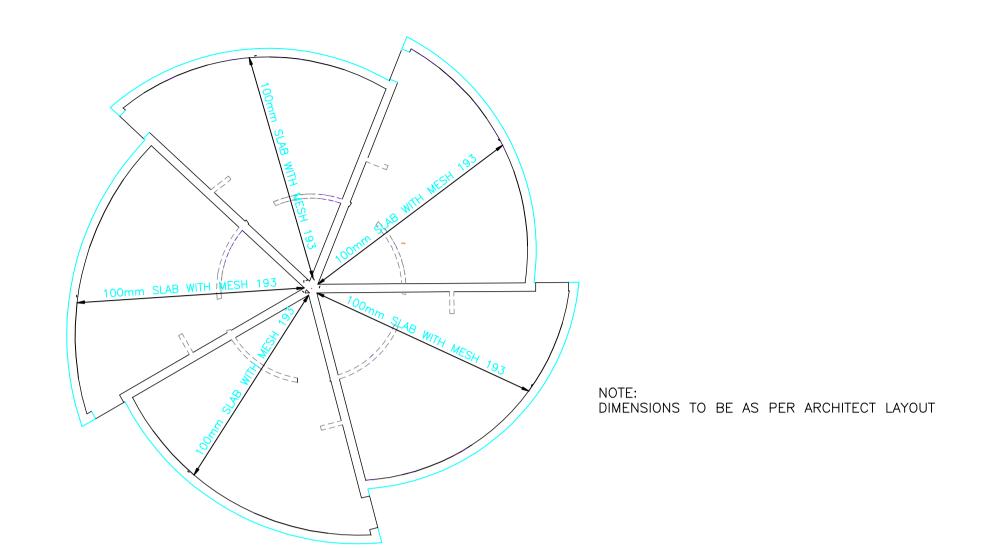



SLAB LAYOUT

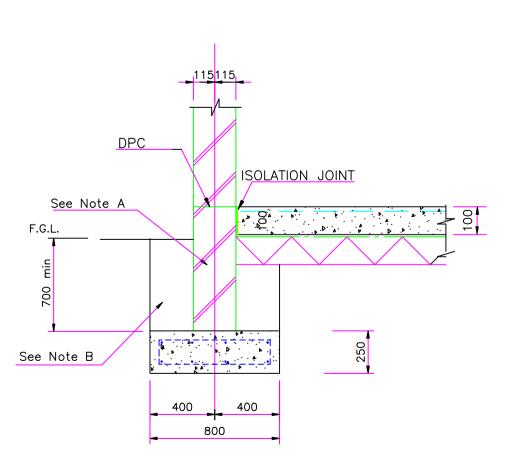

TYPICAL SECTION THROUGH 230 WALLS SCALE 1:20


A 14MPA FOUNDATION BRICKWORK WITH BRICKFORCE IN EACH COURSE UP TO DPC LEVEL B EXCAVATED MATERIAL RETURNED AND COMPACTED IN 150mm LAYERS TO 95% Mod AASHTO DENSITY

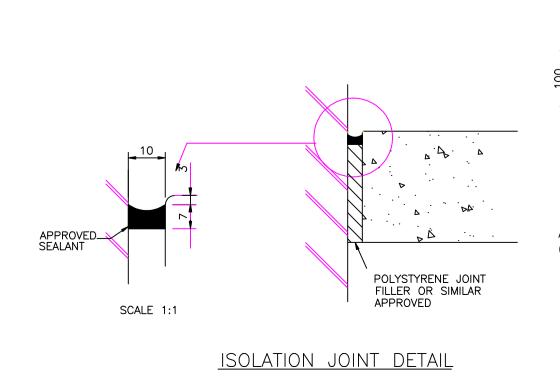

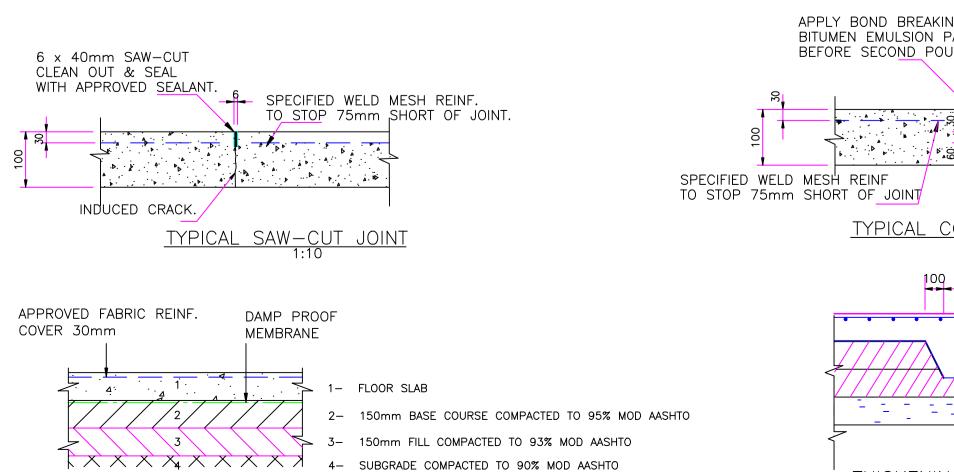

GROUND SLAB CONSTRUCTION

WITH APPROVED SEALANT. APPLY BOND BREAKING BITUMEN EMULSION PAINT BEFORE SECOND POUR. 6 FIRST POUR TYPICAL CONSTRUCTION JOINT 1:10

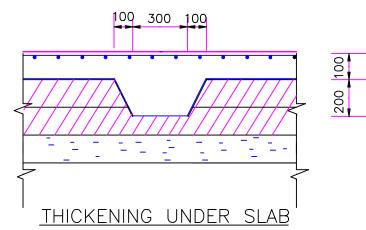

CLEAN OUT & SEAL

SWILE MAVOKWENI GARM FARM

REVISED BY & DETAILS

1- NO SCALING OFF DRAWINGS USE WRITTEN DIMENSIONS, OTHERWISE CONSULT THE ENGINEER.
2- CONCRETE GRADE - FOOTINGS 25 MPa

3- ALL EXPOSED CONCRETE SURFACES TO BE SMOOTH OFF-SHUTTER. 4- ALL EXPOSED CONCRETE EDGES TO HAVE 20 x 20 CORNER CHAMFERS. 5- CHARACTERISTIC STRENGTH OF REINFORCEMENT: -HIGH TENSILE 460 MPa -MILD TENSILE 250 MPa

6- COVER TO REINFORCEMENT TO BE: -FLOORS 50mm -BEAMS/COLUMNS 30mm -BASES 50mm

BE APPROVED BY THE ENGINEER BEFORE CONCRETING.

PATSON & PARTNERS QS

ENGINEER & PRINCIPAL AGENT

7- ALL REINFORCEMENT TO BE APPROVED BY THE ENGINEER BEFORE CONCRETING.

8- THE ALLOWABLE BEARING CAPACITY UNDER FOUNDATIONS IS 150 KPa .THE CONTRACTOR IS TO ALLOW FOR TESTING IF REQUIRED & ALL EXCAVATIONS TO

9- SUPPORT OF REINFORCEMENT WITH STOOLS TO BE USED BY THE CONTRACTOR EVEN WHERE DETAILS ARE SHOWN.

- FOOTINGS 25 MPa - STRUCTURAL WALLS 30 MPa - FIRST FLOORS 30 MPa - BLINDING 15 MPa

-WELD MESH 460 MPa

MAIN ACCOMMODATION

FOUNDATION & SLAB DETAILS NWOH2 2A ΜS ECSA REG. NUMBER M.D. SIBANDA Pr Tech Eng 201570050 CLIENT APPROVAL


CONSTRUCTION

REV 0

SWL 103


DIMENSIONS GIVEN ARE NOT FOR SETTING OUT SET OUT WITH COORDINATES SUPPLIED BY ENGINEER FOUNDATION LAYOUT

SCALE 1:100

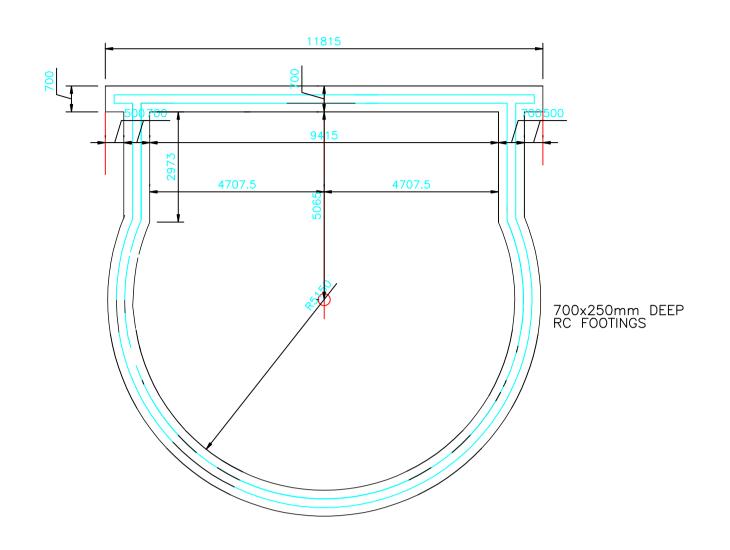


FOUNDATION LAYOUT

SCALE 1:100

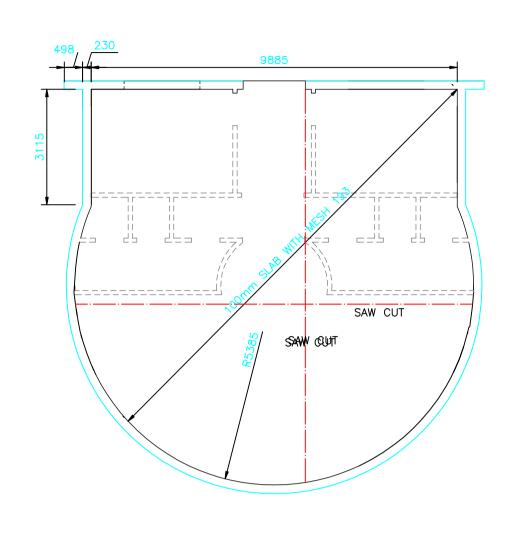



SLAB LAYOUT SCALE 1:100

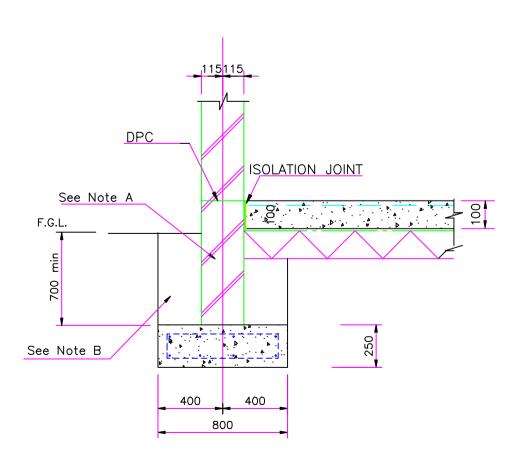



TYPICAL SECTION THROUGH 230 WALLS SCALE 1:20

A 14MPA FOUNDATION BRICKWORK WITH BRICKFORCE IN EACH COURSE UP TO DPC LEVEL B EXCAVATED MATERIAL RETURNED AND COMPACTED IN 150mm LAYERS TO 95% Mod AASHTO DENSITY

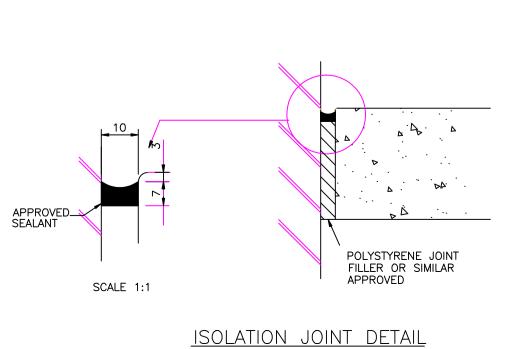


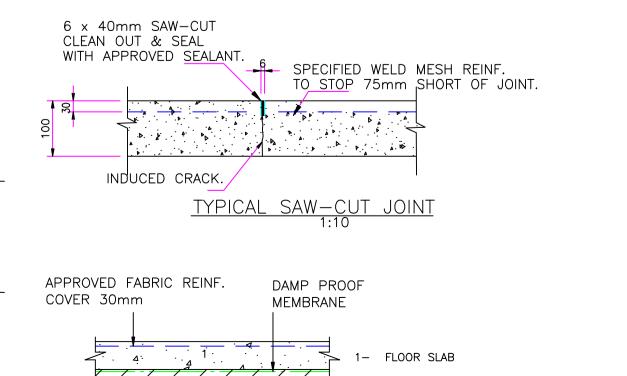


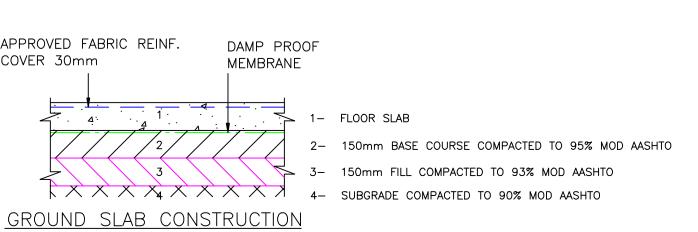

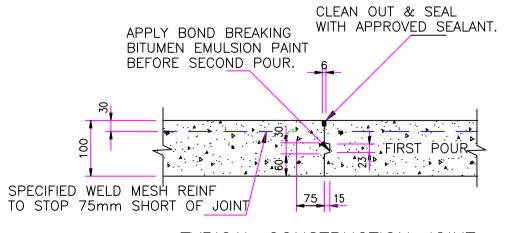

TYPICAL CONSTRUCTION JOINT 1:10

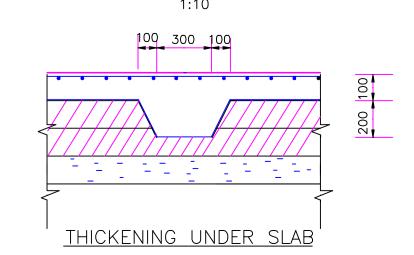

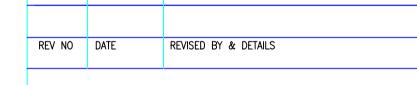

1- NO SCALING OFF DRAWINGS USE WRITTEN DIMENSIONS, OTHERWISE CONSULT THE ENGINEER.
2- CONCRETE GRADE - FOOTINGS 25 MPa

FOOTINGS 25 MPaSTRUCTURAL WALLS 30 MPaFIRST FLOORS 30 MPaBLINDING 15 MPa

3- ALL EXPOSED CONCRETE SURFACES TO BE SMOOTH OFF-SHUTTER. 4- ALL EXPOSED CONCRETE EDGES TO HAVE 20 x 20 CORNER CHAMFERS. 5- CHARACTERISTIC STRENGTH OF REINFORCEMENT: -HIGH TENSILE 460 MPa -MILD TENSILE 250 MPa -WELD MESH 460 MPa

6- COVER TO REINFORCEMENT TO BE: -FLOORS 50mm -BEAMS/COLUMNS 30mm -BASES 50mm 7- ALL REINFORCEMENT TO BE APPROVED BY THE ENGINEER BEFORE CONCRETING.

8- THE ALLOWABLE BEARING CAPACITY UNDER FOUNDATIONS IS 150 KPg .THE CONTRACTOR IS TO ALLOW FOR TESTING IF REQUIRED & ALL EXCAVATIONS TO BE APPROVED BY THE ENGINEER BEFORE CONCRETING.

9- Support of Reinforcement with Stools to be used by the contractor even where details are shown.

ENGINEER & PRINCIPAL AGENT

PATSON & PARTNERS QS

SWILE MAVOKWENI GARM FARM


OFFICE/BOARD ROOM FOUNDATION & SLAB DETAILS

DATE	SCALE	DESIGNED BY
MAY 2021	NWDH2 2A	R S
APPROVED BY	ECSA REG. NUMBER	
M.D. SIBANDA Pr Tech Eng	201570050	
CLIENT APPROVAL		DATE


REV 0

CONSTRUCTION

SWL 100

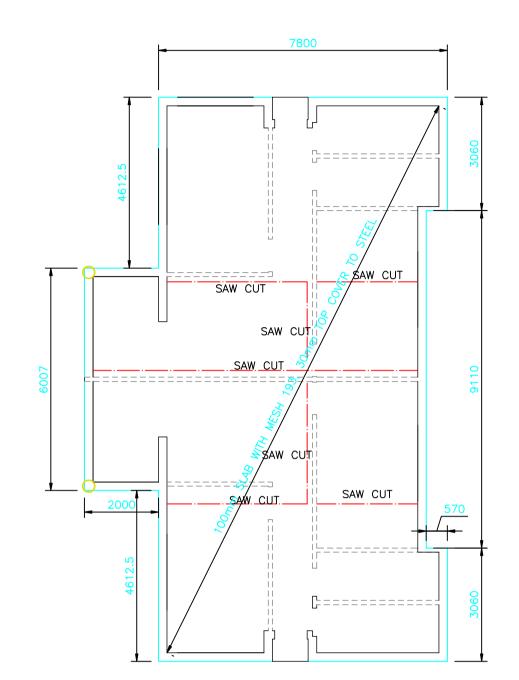


SLAB LAYOUT SCALE 1:100

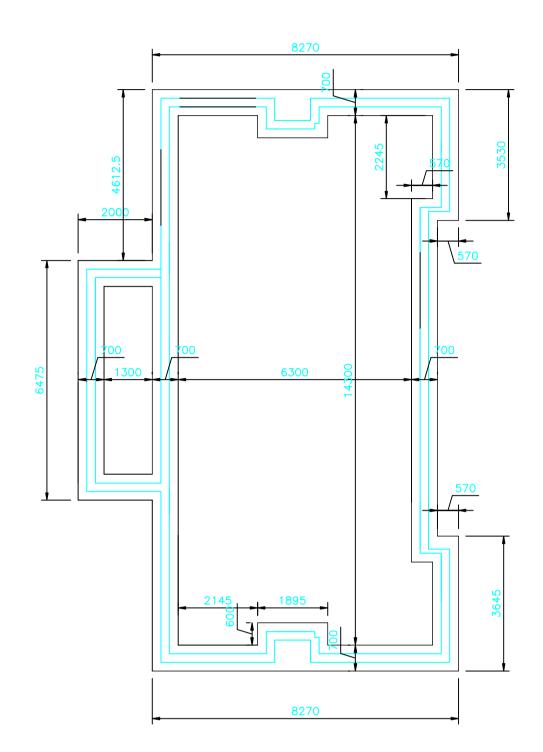


700x250mm DEEP RC FOOTINGS


FOUNDATION LAYOUT

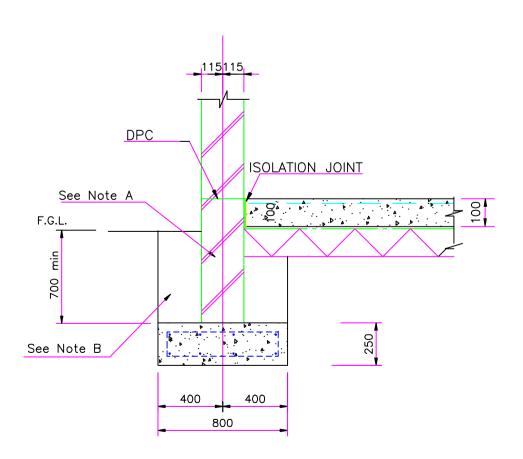


TYPICAL SECTION THROUGH 230 WALLS SCALE 1:20

A 14MPA FOUNDATION BRICKWORK WITH BRICKFORCE IN EACH COURSE UP TO DPC LEVEL B EXCAVATED MATERIAL RETURNED AND COMPACTED IN 150mm LAYERS TO 95% Mod AASHTO DENSITY

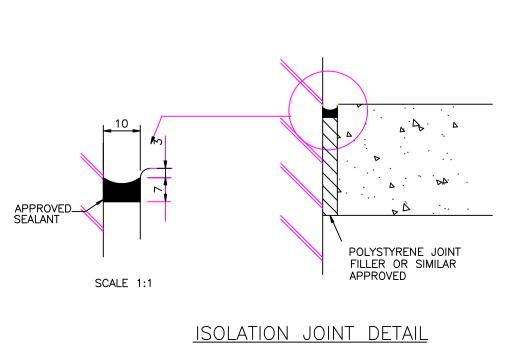


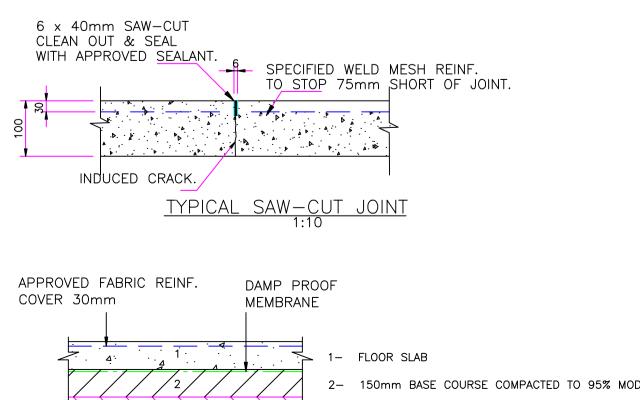

2- 150mm BASE COURSE COMPACTED TO 95% MOD AASHTO 3- 150mm FILL COMPACTED TO 93% MOD AASHTO 4- SUBGRADE COMPACTED TO 90% MOD AASHTO GROUND SLAB CONSTRUCTION

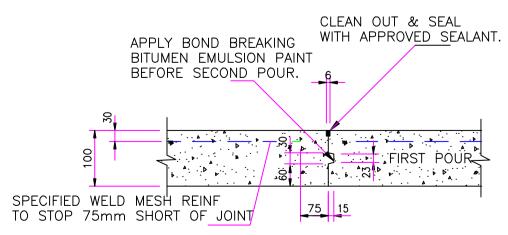

TYPICAL CONSTRUCTION JOINT 1:10

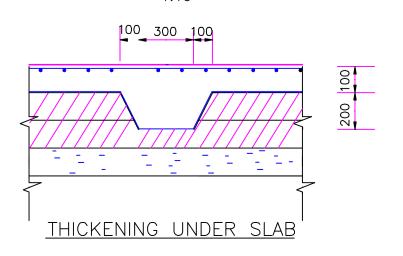

REVISED BY & DETAILS

1- NO SCALING OFF DRAWINGS USE WRITTEN DIMENSIONS, OTHERWISE CONSULT THE ENGINEER.
2- CONCRETE GRADE - FOOTINGS 25 MPa

FOOTINGS 25 MPaSTRUCTURAL WALLS 30 MPaFIRST FLOORS 30 MPaBLINDING 15 MPa

3- ALL EXPOSED CONCRETE SURFACES TO BE SMOOTH OFF-SHUTTER. 4- ALL EXPOSED CONCRETE EDGES TO HAVE 20 x 20 CORNER CHAMFERS. 5- CHARACTERISTIC STRENGTH OF REINFORCEMENT: -HIGH TENSILE 460 MPa -MILD TENSILE 250 MPa -WELD MESH 460 MPa

6- COVER TO REINFORCEMENT TO BE: -FLOORS 50mm -BEAMS/COLUMNS 30mm -BASES 50mm

7- ALL REINFORCEMENT TO BE APPROVED BY THE ENGINEER BEFORE CONCRETING. 8- THE ALLOWABLE BEARING CAPACITY UNDER FOUNDATIONS IS 150 KPg. .THE CONTRACTOR IS TO ALLOW FOR TESTING IF REQUIRED & ALL EXCAVATIONS TO BE APPROVED BY THE ENGINEER BEFORE CONCRETING.

9- SUPPORT OF REINFORCEMENT WITH STOOLS TO BE USED BY THE CONTRACTOR EVEN WHERE DETAILS ARE SHOWN.

ENGINEER & PRINCIPAL AGENT

PATSON & PARTNERS QS


SWILE MAVOKWENI GARM FARM

STAFF ACCOMMODATION **FOUNDATION & SLAB DETAILS**

NWOH2 2A ΜS ECSA REG. NUMBER M.D. SIBANDA Pr Tech Eng 201570050

CLIENT APPROVAL REV 0 **SWL 102**

CONSTRUCTION

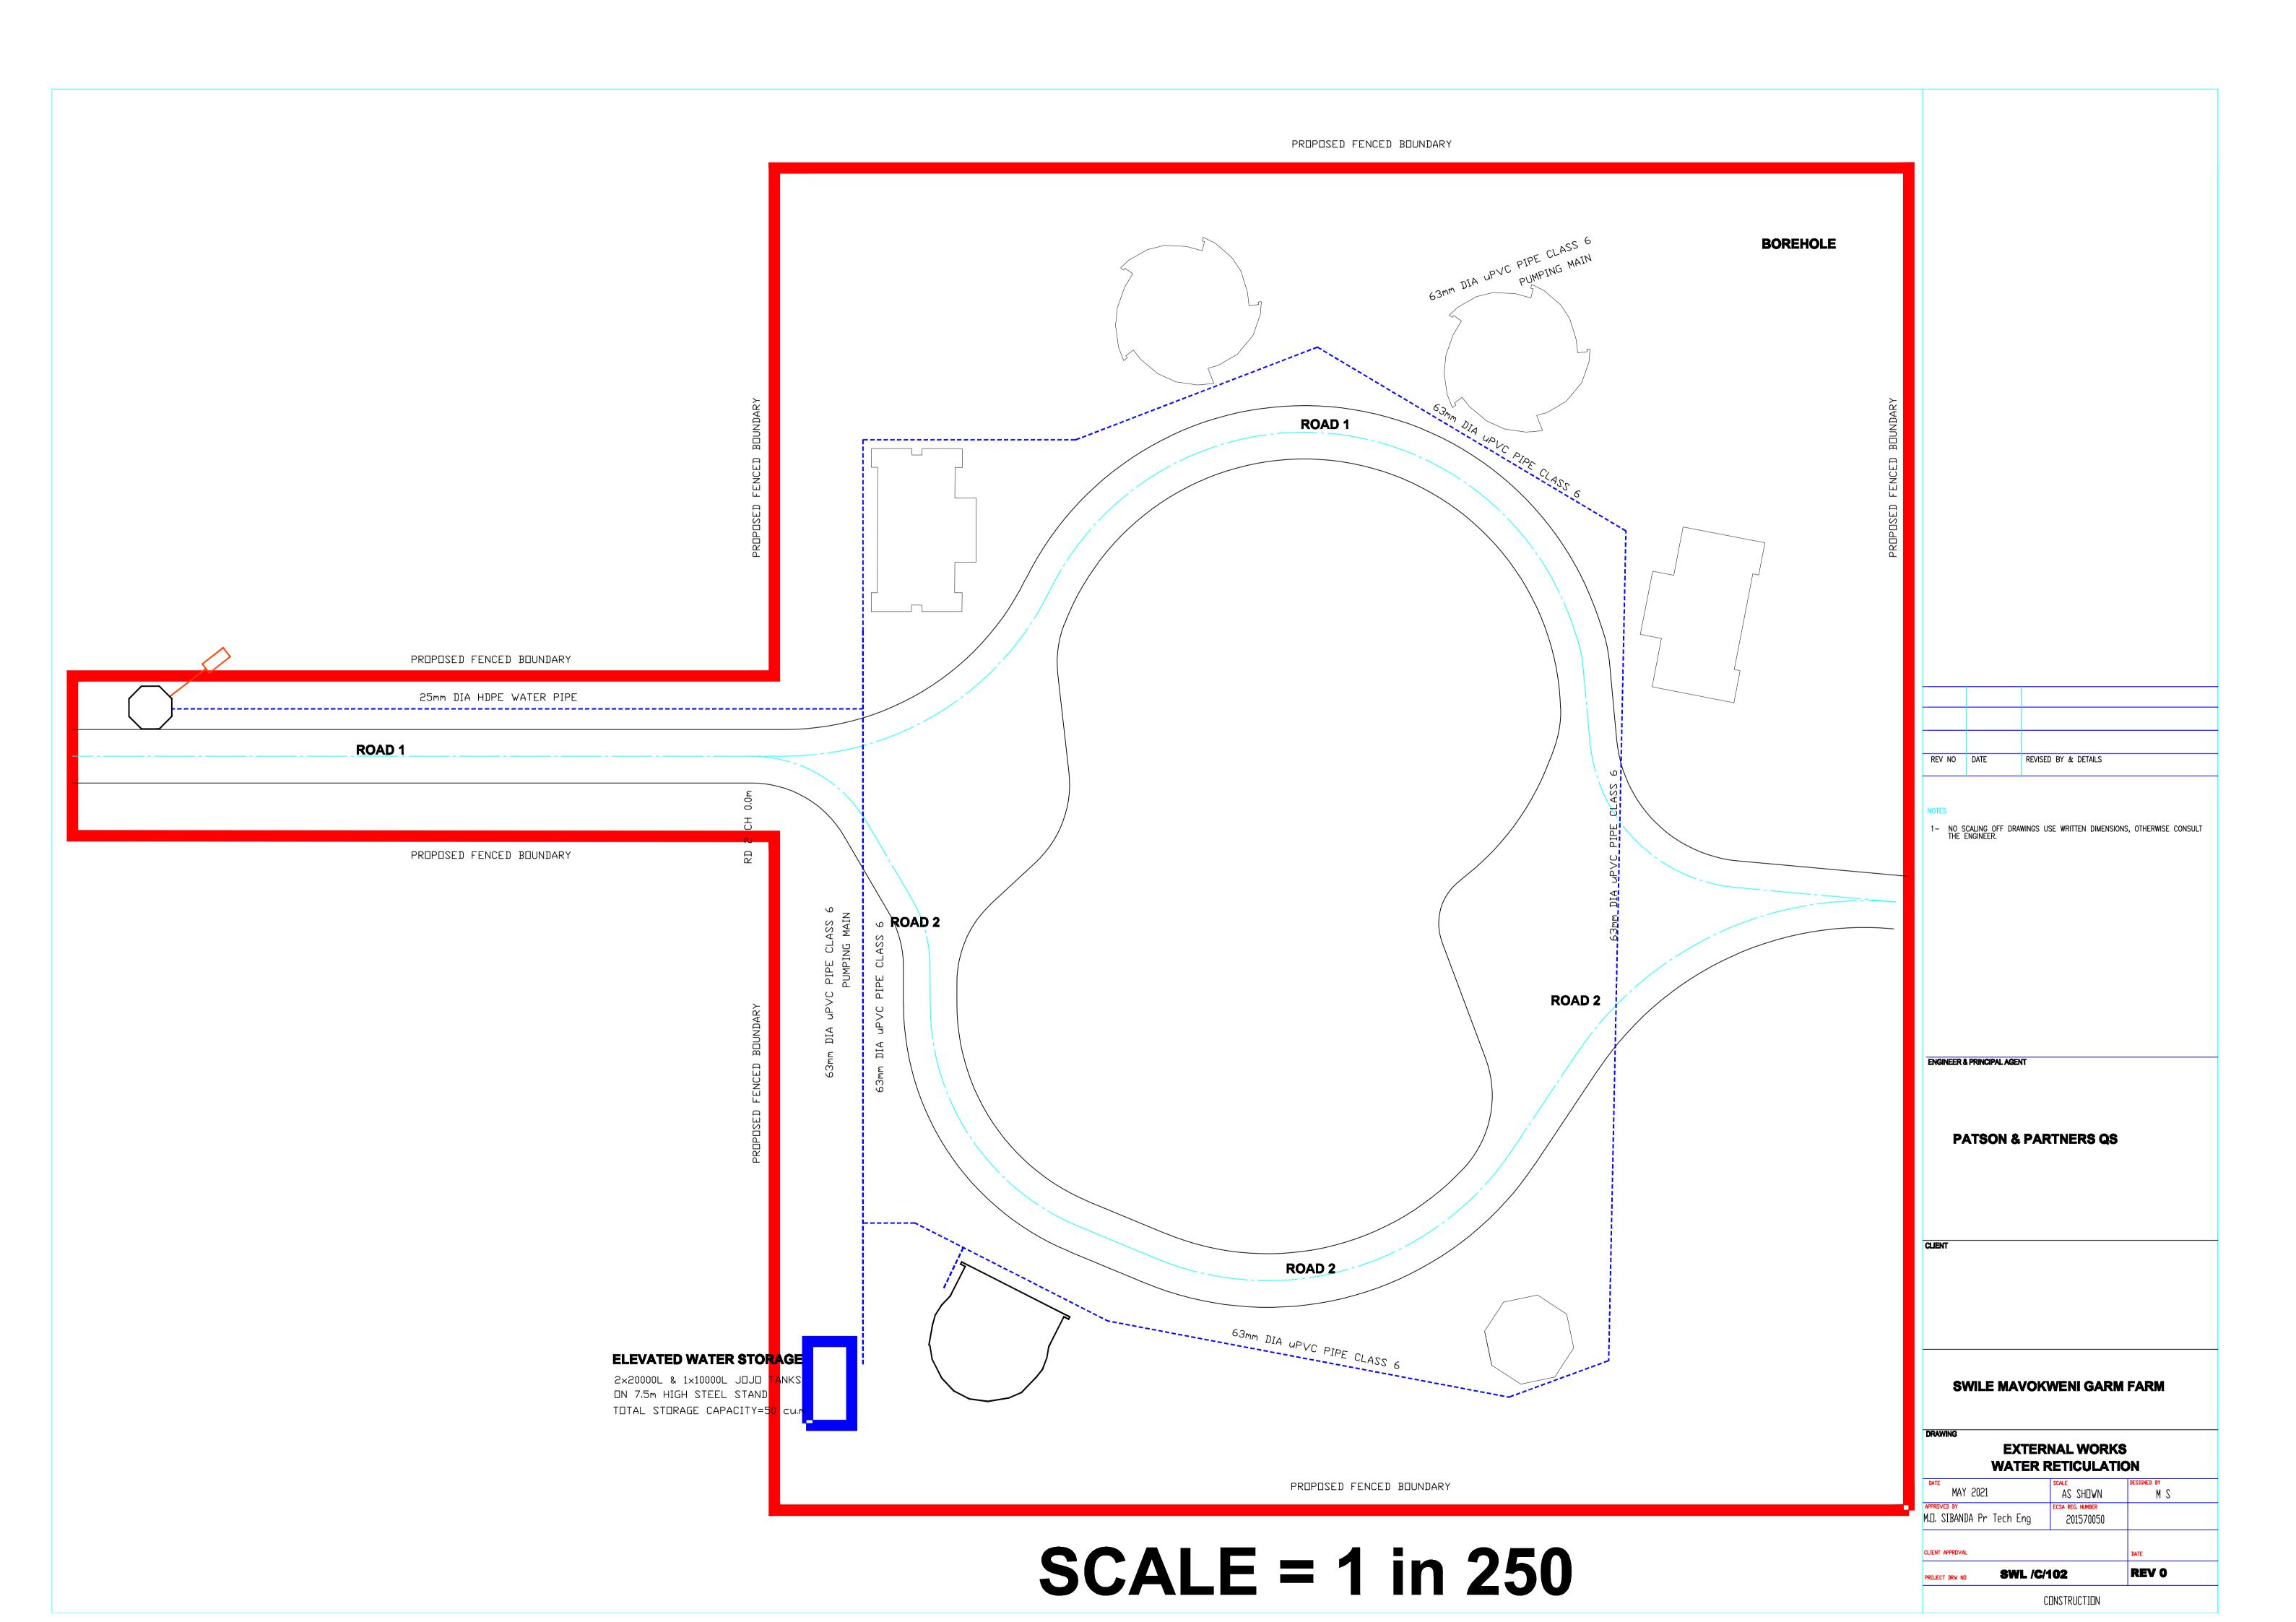

AGREEMENT WITH MANDATARY - SECTION 37 (1) & (2)

OCCUPATIONAL HEALTH AND SAFETY ACT AND REGULATIONS 85 OF 1993 AGREEMENT ENTERED INTO BETWEEN TWO PARTIES

DEPARTMENT OF FORESTRY, FISHERIES AND THE ENVIRONMENT

CLIENT (DFFE)

AND

NAME OF THE CONTRACTOR OR AGENT

In respect of Project:

PROJECT NAME:

TENDER No.:

It is hereby agreed that the Agent or Contractor shall be responsible for ensuring that the provisions of OHSA and Regulations 85 of 1993 promulgated hereunder are fully complied with:

ACTS or OMMISSIONS BY EMPLOYEES or MANDATARIES -

SITE ADDRESS:

- (1) Whenever an employee does or omits to do any act which it would be an offence in terms of this Act for the employer of such employee or a user to do or omit to do, then, unless it is proved that -
 - (a) in doing or omitting to do that act the employee was acting without the connivance or permission of the employer or any such user;

- (b) it was not under any condition or in any circumstance within the scope of the authority of the employee to do or omit to do an act, whether lawful or unlawful, of the character of the act or omission charged and
- (c) all reasonable steps were taken by the employer or any such user to prevent any act or omission of the kind in question,

The employer or any such user himself shall be presumed to have done or omitted to do act and shall be liable to be convicted and sentenced in respect thereof; and the fact that he issued instructions forbidding any act or omission of the kind in question shall not, in, itself, be accepted as sufficient proof that he took all reasonable steps to prevent the act or omission.

(2) The provisions of subsection (1) shall *mutatis mutandis* apply in the case of a mandatory of an employer or user, except if the parties have agreed I writing to the arrangements and procedures between them to ensure compliance by the mandatary with the provisions of this Act.

SIGNED AT:	ON THIS	DAY OF	20
NAME OF SIGNATORY (CONTRACTOR)	SIG	SNATURE	
NAME OF SIGNATORY (CLIENT DFFE)	SIG	GNATURE	

[<u>Please Note:</u> This document will only be considered and finalized with the appointed Contractor as it will be included in the project OHS File].

n)		Quantity	Rate	Amount
	SECTION 1			
	BILL NO. 1			
	PRELIMINARIES			
	BUILDING AGREEMENT AND PRELIMINARIES			
	The JBCC Series 2000 Principal Building Agreement (July 2007 edition 5.0 - reprint 1) prepared by the Joint Building Contracts Committee shall be the applicable building agreement, amended as hereinafter described			
	The JBCC Principal Building Agreement Contract Data EC and the JBCC Principal Building Agreement Contract Data CE form an integral part of this agreement			
	The ASAQS Preliminaries (November 2007 edition) published by the Association of South African Quantity Surveyors for use with the said JBCC Principal Building Agreement shall be deemed to be incorporated in these bills of quantities			
	Contractors are referred to the abovementioned documents for the intent and meaning of each clause thereof			
	These clauses are hereinafter referred to by clause number and heading only. Where standard clauses or alternatives are not entirely applicable to this agreement such modifications, corrections or supplements as will apply are given under each relevant clause heading and such modifications, corrections or supplements shall take precedence notwithstanding anything contrary contained in the abovementioned documents			
	Where any item is not relevant to this specific agreement such item is marked N/A (signifying "not applicable")			
	PREAMBLES FOR TRADES			
	The Model Preambles for Trades (2008 edition) as published by the Association of South African Quantity Surveyors shall be deemed to be incorporated in these bills of quantities and no claims arising from brevity of description of items fully described in the said Model Preambles will be entertained			
	Carried Forward		R	
	Section No. 1 Bill No. 1 Preliminaries			

	Brought Forward		R	
	Supplementary preambles are incorporated in these bills of quantities to satisfy the requirements of this project. Such supplementary preambles shall take precedence over the provisions of the said Model Preambles			
	The contractor's prices for all items throughout these bills of quantities must take account of and include for all of the obligations, requirements and specifications given in the said Model Preambles and in any supplementary preambles			
	PRICING OF PRELIMINARIES			
	Should the contractor select Option A in terms of subclause 3.2.1 in the Contract Data - Contractor to Employer (CE) for the purpose of adjustment of these preliminaries , the amount entered into the amount column in these preliminaries is to be divided into one or more of the three categories provided namely Fixed (F), Value Related (V) and Time Related (T)			
	SECTION A: PRINCIPAL BUILDING AGREEMENT			
	Definitions (A1)			
ı	Clause 1.0 - Definitions and interpretation			
	The measuring system used for the preparation of the bills of quantities is the Standard System of Measuring Building Work (sixth edition, revised 1999) published by the Association of South African Quantity Surveyors [1.1]			
	F: T:	Item		
	Objective and preparation (A2 - A14)			
2	Clause 2.0 - Offer acceptance and performance obligations			
	F: T:			
	T	Item		
	Carried Forward		R	
	Section No. 1			
	Bill No. 1 Preliminaries			

	Brought Forward		R	
3	Clause 3.0 - Documents			
	Refer to Annexure A for a list of the contract drawings			
	Provision is made in the summary page of these bills of quantities for the inclusion of Value Added Tax (VAT) [3.5]			
	The principal agent shall decide which portion of the priced document may be used as a specification of materials and goods or methods, if any [3.9]			
	F: T:	Item		
4	Clause 4.0 - Design responsibility			
	F:V:	Itama		
_	Clause 5.0. Franksusada asserta	Item		
5	Clause 5.0 - Employer's agents F:V:			
	T:	Item		
6	Clause 6.0 - Contractor's site representative			
	F: T:	Item		
7	Clause 7.0 - Compliance with laws and regulations			
	Without limiting the generality of the provisions of clause 7.0, the contractor's attention is drawn to the provisions of the Construction Regulations, 2003 issued in terms of the Occupational Health and Safety Act, 1993. It is specifically stated that the employer shall prepare a documented health and safety specification for the works and that the employer shall ensure that the contractor has made provision for the cost of health and safety measures during the execution of the works . The contractor shall price opposite this item for compliance with the act and the regulations and the reasonable provisions of the aforementioned health and safety specification [7.1] F:	ltem		
	Carried Forward		R	
	Section No. 1 Bill No. 1 Preliminaries			

	Brought Forward		R	1
8	Clause 8.0 - Works risk			
	F: T:	Item		
9	Clause 9.0 - Indemnities			
	F: T:	Item		
10	Clause 10.0 - General insurances			1
	F: T:	Item		
11	Clause 11.0 - Special insurances			
	F: T:	Item		
12	Clause 12.0 - Effecting insurances			Ì
	F: T:	Item		
13	Clause 13.0 - Assignment			Ì
	F: T:	Item		
14	Clause 14.0 - Security			
	F: T:	Item		
	Execution (A15 - A23)			
15	Clause 15.0 - Preparation for and execution of the works			
	F: T:	Item		
				1
				1
	Carried Forward		R	
	Section No. 1 Bill No. 1 Preliminaries			
				l

	Brought Forward		R	ı
16	Clause 16.0 - Site and access			I
	Certain areas will be occupied during the construction period and the contractor must execute the works with as little noise and disturbance as possible to the occupants. [16.6]			
	F: T:	Item		ĺ
17	Clause 17.0 - Contract instructions			ı
	F: T:	Item		ľ
18	Clause 18.0 -Setting out of the works			ı
	The contractor shall notify the principal agent if any encroachment of adjoining foundations, buildings, structures, pavements, boundaries, etc. exist in order that the necessary arrangements may be made for the rectification of any such encroachments [18.1]			
	F: T:	Item		ı
19	Clause 19.0 - Temporary works and plant			I
	Clause 19.1.1 - Enclosure of the works			1
	F: V: T:	Item		
20	Clause 19.1.2 - Office accommodation - provide suitable office accomodation for site meetings with tables and chairs for ten people			
	F: T:	Item		
21	Clause 20.0 - Nominated subcontractors			ı
	Refer to the provisions on general attendance hereinafter			ĺ
	F: T:	Item		
	Carried Forward		R	Ì
	Section No. 1 Bill No. 1 Preliminaries			
				ı

	Brought Forward		R	1
22	Clause 21.0 - Selected subcontractors			ı
	General attendance of n/s subcontractors for pricing by the contractor shall be in accordance with the n/s agreement . Notwithstanding this provision, general attendance shall be deemed to include for the contractor to provide free of charge to any n/s subcontractor such scaffolding as may reasonably be required by such n/s subcontractor for the execution of the relevant subcontract work			
	F: T:	Item		
23	Clause 22.0 - Employer's direct contractors			ı
	F: T:	Item		
24	Clause 23.0 - Contractor's domestic subcontractors			1
	F: T:	Item		
	Completion (A24 - A30)			ı
25	Clause 24.0 - Practical completion			ı
	F: T:	Item		1
26	Clause 25.0 - Works completion			ı
	F: T:	Item		
27	Clause 26.0 - Final completion			ı
	F: T:	Item		1
28	Clause 27.0 - Latent defects liability period			ı
	F: T:	Item		1
29	Clause 28.0 - Sectional completion			ı
	F: T:	Item		
	Carried Forward		R	
	Section No. 1 Bill No. 1 Preliminaries			

	Brought Forward		R	
30	Clause 29.0 - Revision of date for practical completion			
	The removal and replacement of materials and/or workmanship which do not conform to the specification or the contract drawings shall not constitute grounds for the extension of the construction period nor for the adjustment of the contract value (Clause 29.3)			
	F: T:	Item		
31	Clause 30.0 - Penalty for late or non-completion: 0.05% of the Contract Amount inclusive of Value Added Tax per Calendar day			
	F: T:	Item		
	Payment (A31 - A35)			
32	Clause 31.0 - Interim payment			
	Materials and goods stored off site shall not be included in the amount authorised for payment [31.6.5]			
	F: T:	Item		
	Carried Forward		R	
	Section No. 1 Bill No. 1 Preliminaries			

	Brought Forward		R	
33	Clause 32.0 - Adjustment to the contract value - NOT APPLICABLE			
	All fluctuations in costs, with the exception of fluctuations in the rate of Value Added Tax, shall be for the account of the contractor [32.13]			
	Where prices are submitted by the contractor or n/s subcontractor during the progress of the works in respect of contract instructions or in regard to a claim under the terms of the agreement and notwithstanding the fact that such prices may be used in an interim payment certificate there is to be no presumption of acceptance. Should the principal agent wish to accept any such prices prior to the issue of the certificate of final completion , it shall be in writing			
	The contractor shall not receive any mark-up for overheads and profit on any omission of tenant installation work or tenant installation work by others. Claims for loss of profit shall not be entertained [32.2]			
	F: T:	N/A		
34	Clause 33.0 - Recovery of expense and loss			
	F: T:	Item		
35	Clause 34.0 - Final account and final payment			
	F: T:	Item		
36	Clause 35.0 - Payment to other parties			
	F: T:	Item		
	Termination (A36 - A39)			
37	Clause 36.0 - Termination by employer - contractor's default			
	F: T:	Item		
	Carried Forward		R	
	Section No. 1 Bill No. 1 Preliminaries			

	Brought Forward		R	i
38	Clause 37.0 - Termination by employer - loss and damage			1
	F: T:	Item		1
39	Clause 38.0 - Termination by contractor - employer's default			
	F: T:	Item		1
40	Clause 39.0 - Termination - cessation of the works			ı
	F: T:	Item		1
	Dispute (A40)			ı
41	Clause 40.0 - Settlement of disputes			1
	F: T:	Item		1
	Contract variables (A41 - A42)			1
42	Clause 41.0 - Post tender provisions			1
	The contractor is to complete and submit with his tender the JBCC Principal Building Agreement Contract Data CE			
	F: T:	Item		
43	Clause 42.0 - Contractual agreement			ı
	The required information of the parties and the amount of the contract sum shall be inserted in the agreement for signature of the agreement by the parties			
	F: T:			ı
	I	Item		ı
	SECTION B: PRELIMINARIES			İ
				1
	Carried Forward		R	
	Section No. 1 Bill No. 1 Preliminaries			

	Brought Forward		R	
	Definitions and interpretation (B1)			
44	Clause 1.0 - Definitions and interpretation			
	F: T:	Item		
	Documents (B2)			
45	Clause 2.1 - Checking of documents			
	F: T:	Item		
46	Clause 2.2 - Provisional bills of quantities			
	F: V: T:	Item		
47	Clause 2.3 - Availability of construction documentation			
	The budgetary allowances and selected subcontract amounts allocated for subsequent trades included in this agreement will be separately procured, based on multiple procurement of selected subcontractors during the construction period			
	F: T:	Item		
	Previous work and adjoining properties (B3)			
48	Clause 3.1 - Previous work - dimensional accuracy			
	F: T:	Item		
49	Clause 3.2 - Previous work - defects			
	F: T:	Item		
50	Clause 3.3 - Inspection of adjoining properties			
	F: T:	Item		
	Carried Forward		R	
	Section No. 1 Bill No. 1 Preliminaries			

	Brought Forward		R	
	Samples, shop drawings and manufacturer's instructions (B4)			
51	Clause 4.1 - Samples of materials			
	F: T:	Item		
52	Clause 4.2 - Workmanship samples			
	F: T:	Item		
53	Clause 4.3 - Shop drawings			
	F: T:	Item		
54	Clause 4.4 - Compliance with manufacturer's instructions			
	F: T:	Item		
	Deposits and fees (B5)			
55	Clause 5.1 - Deposits and fees			
	F: T:	Item		
	Temporary services (B6)			
56	Clause 6.1 - Water			
	F: T:	Item		
57	Clause 6.2 - Electricity			
	F: T:	Item		
58	Clause 6.3 - Telecommunication facilities			
	F: T:	Item		
	Carried Forward		R	
	Section No. 1 Bill No. 1 Preliminaries			

	Brought Forward		R	
59	Clause 6.4 - Ablution facilities			
	F: T:	Item		
	Prime cost amounts (B7)			
60	Clause 7.1 - Responsibility for prime cost amounts			
	F: T:	Item		
	Special attendance on n/s subcontractors (B8)			
61	Clause 8.1 - Special attendance			
	F: T:			
		Item		
	General (B9)			
62	Clause 9.1 - Protection of the works			
	F: T:	Item		
63	Clause 9.2 - Protection/isolation of existing/ occupied works			
	Certain areas of the sitewill be occupied during the construction period (see item 4 page 14)			
	F: T:	Item		
64	Clause 9.3 - Security of the works			
	F: T:	Item		
65	Clause 9.4 - Notice before covering work			
	F: T:	Item		
66	Clause 9.5 - Disturbance			
	F: T:	Item		
	Carried Forward		R	
	Section No. 1 Bill No. 1 Preliminaries			

Clause 9.6 - Environmental disturbance F:	ltem			
T: Clause 9.7 - Works cleaning and clearing F: T:				
F: T:	ltem			
T:	Item			
Clause 9.8 - Vermin				
F: T:	Item			
Caluse 9.9 - Overhand work				
F: T:	Item			
Schedule of variables (B10)				
Information necessary for elections and completion of those clauses contained in the schedule which are necessary for tender purposes is given hereunder. Where no information is given it shall mean that no specific requirements are expected or that the clause is not relevant to this specific contract				
10.1 - Provisional bills of quantities [2.2] The quantities are provisional No				
10.2 - Availability of construction documentation [2.3] Construction documentation is complete Yes				
10.3 - Previous work - dimensional accuracy [3.1]				
10.4 - Previous work - defects [3.2]				
10.5 - Inspection of adjoining properties [3.3]				
10.6 - Water [7.2]				
Option A (by contractor) Option B (by employer - free of charge) Option C (by employer - metered) No				
Carried Forward		R		
Section No. 1 Bill No. 1 Preliminaries				
	F:	Clause 9.8 - Vermin F:	Clause 9.8 - Vermin F:	Clause 9.8 - Vermin F:

Brought Forward	R		
10.7 - Electricity [7.3]			
Option A (by contractor)			
Yes Option B (by employer - free of charge) No			
Option C (by employer - metered) No			
10.8 - Telecommunications [7.4]			
Telephone Yes			
Facsimile Yes			
E-mail Yes			
10.9 - Ablution facilities [7.5]			
Option A (by contractor)			
Yes Option B (by employer) No			
10.10 - Protection of the works [9.1]			
10.11 - Protection/isolation of existing/sectionally occupied works [9.2]			
Protection/isolation is required No			
10.12 - Disturbance [9.5]			
10.13 - Environmental disturbance [9.6]			
SECTION C: SPECIFIC PRELIMINARIES			
Any special items to meet the particular circumstances of a specific project are embodied in this section. Where required for an aspect of the works to be executed according to a design by a consulting engineer, a recital of the headings to the individual clauses of the JBCC Engineering General Conditions			
are included			
			<u> </u>
Carried Forward	R		
Section No. 1 Bill No. 1			
Preliminaries			
			ı

	Brought Forward		R		
71	Black economic empowerment and training				
	F: T:				
	T	Item			
72	Proprietary branded products				
	F: T:				
		Item			
	The contractor shall take delivery of, handle, store, use, apply and/or fix all proprietary branded products in strict accordance with the manufacturers' instructions after consultation with the manufacturer's authorised representative				
73	Contract instructions				
	F: T:				
		Item			
	Contract instructions issued on site are to be recorded in triplicate in a contract instruction book which is to be supplied and maintained on site by the contractor				
74	Labour record				
	F: T:				
		Item			
	At the end of each week the contractor shall provide the principal agent with a written record, in schedule form, reflecting the number and descriptions of tradesmen and labourers employed by him and all subcontractors on the works each day of that week				
75	Plant record				
	F: T:				
		Item			
	Carried Forward		R		
	Section No. 1				
	Bill No. 1 Preliminaries				
				ı l	

	Brought Forward		R	
	At the end of each week the contractor shall provide the principal agent with a written record, in schedule form, reflecting the number, type and capacity of all plant, excluding hand tools used on the works each day of that week			
76	Guarantees			
	F: T:			
	T	Item		
	Where guarantees are called for, the contractor shall obtain a written guarantee, addressed to the employer, from the firm supplying the materials and/or doing the work and shall deliver same to the principal agent on the certified completion of the contract. The guarantee shall state that workmanship, materials and installation are guaranteed for a specified period from the date of certified completion of the contract, and that any defects that may arise during the specified period shall be made good at the expense of the firm supplying the materials and/or doing the work, upon written notice from the principal agent to do so. This guarantee will not be enforced if the work is damaged by defects in the construction of the building in which case the responsibility for replacement shall rest entirely with the contractor. The principal agent shall be the sole judge of the cause responsible for defects in the work and his decision shall be final and binding in terms of clause 40.2 of the agreement			
77	Overtime F:V:			
	I	Item		
	Should overtime be required to be worked for any reason whatsoever, the costs of such overtime are to be borne by the contractor unless the principal agent has specifically authorised, in writing, prior to execution thereof, that costs for such overtime are to be borne by the employer			
78	Co-operation of contractor for cost management			
	F:V: T:	Item		
		iteiii		
	Carried Forward		R	
	Section No. 1 Bill No. 1 Preliminaries			

	Brought Forward	I	R		
70	It is specifically agreed that the contractor accepts the obligation of assisting the professional consultants in implementing proper cost management. The contractor will be advised by the principal agent of all cost management procedures which will be implemented to ensure that the final building cost does not exceed the budget. The quantity surveyor undertakes to make available to the contractor all budgetary allowances and cost assessments/reports to enable the proper procedures to be implemented and the contractor will attend all cost plan review and cost management meetings. The contractor undertakes to extend these procedures in regard to all subcontractors				
79	Occupational Health and Safety Specification				
	F: T:				
		Item			
	The contractor shall comply with all the requirements set out in the Construction Regulations 2003 issued under the Occupational Health and Safety Act, 1993 (Act No 85 of 1993). It is required of the contractor to thoroughtly study the Health and Safety Specification that must be read together with and is deemed to be incorporated under this Section of the bills of quantities / lump sum document.				
	The contractor must take note that compliance with the Occupational Health and Safety Act, Construction Regulations and Health and Safety Specification is compulsory. In the event of parial or total noncompliance, the principal agent, notwithstanding the provisions of clause A31.0 of Section A or any other clause to the contrary, reserves the right to delay issuing any progress payment certificate until the contractor provides satifactory proof of compliance. The contractor shall not be entitled to any compensation of whatsoever nature, including extension of time or interest, due to such delay of payment.				
	Provisions for pricing of the Occupational Health and Safety Act, Construction Regulations and Health and Safety Specification is made under this clause and it is explicitly pointed out that all requirements of the aforementioned are deemed to be priced hereunder and no additional claims in this regard shall be entertained.				
	Carried Forward		R		
	Section No. 1 Bill No. 1				
	Preliminaries				

Ĵ	Brought Forward		R	
80	Allow for the compulsory equipment and clothing, ie hats, safety shoes, safety clothing, safety glasses, safety masks, harnesses, etc			
	F: T:	Item		
81	Allow for all compulsory health and safety posters, boards, etc			
	F: T:	Item		
82	Allow for all compulsory health and safety workshops, meetings, lectures, demonstrations, etc			
	F: V:	Item		
83	Allow for all compulsary health and safety pamphlets, cards, paperwork, etc to each worker, consultant, public individual, etc coming onto the site			
	F: T:	Item		
84	Allow for compulsory health and safety files that must be completed daily and must be handed to the employer on completion of the contract			
	F: T:	Item		
85	Scope of Application as per Act No 85 of 1993			
	F: T:	Item		
	Carried Forward		R	
	Section No. 1 Bill No. 1 Preliminaries			

	Brought Forward		R	1
86	Notification of Construction Work as per Act No 85 of 1993			Ì
	F: T:	Item		
87	Employer's responsibilities as per Act No 85 of 1993			
	F: T:	Item		
88	Principal Contractor's responsibility as per Act No 85 of 1993			
	F: T:	Item		
89	Supervision of construction work as per Act No 85 of 1993			
	F: T:	Item		Ĭ
90	Risk assessment as per Act No 85 of 1993			
	F: T:	Item		
91	Fall protection as per Act No 85 of 1993			
	F: T:	Item		
	Carried Forward		R	
	Section No. 1 Bill No. 1 Preliminaries			

	Brought Forward		R	
92	Structures Formwork and Support as per Act No 85 of 1993			
	F: T:			
93	Executation on per Act No. 95 of 1002	Item		
93	Excavation as per Act No 85 of 1993			
	F: T:			
		Item		
94	Demolotion work as per Act No 85 of 1993			
	F: T:			
		Item		
95	Tunnelling as per Act No 85 of 1993			
	F: T:			
		Item		
96	Scaffolding as per Act No 85 of 1993			
	F: T:			
		Item		
97	Suspended platforms as per Act No 85 of 1993			
	F: T:			
		Item		
				<u> </u>
	Carried Forward		R	
	Section No. 1 Bill No. 1 Preliminaries			

	Brought Forward		R	
98	Botswains chairs as per Act No 85 of 1993			
	F: T:	ltem		
99	Materials hoists as per Act No 85 of 1993			
	F: T:			
100	Batch plant as per Act No 85 of 1993	Item		
100				
	F: T:	Item		
101	Explosive powered tools as per Act No 85 of 1993			
	F: T:			
400	One was a see Ant No. 05 of 4000	Item		
102	Cranes as per Act No 85 of 1993			
	F: T:	14		
103	Construction vehicles and mobile plant as per Act No 85 of 1993	Item		
	F:V:			
	T:	Item		
	Carried Forward		R	
	Section No. 1 Bill No. 1 Preliminaries			

	Brought Forward		R	
104	Electrical installations and machinery on construction sites as per Act No 85 of 1993			
	F: T:	ltem		
105	Use and temporary storage of flammable liquids on construction sites as per Act No 85 of 1993			
	F: T:	ltem		
106	Water environments as per Act No 85 of 1993			
	F: T:	Item		
107	Housekeeping on construction sites as per Act No 85 of 1993			
	F: T:	Item		
108	Stacking and storage on construction sites as per Act No 85 of 1993			
	F: T:	Item		
109	Fire precautions as per Act No 85 of 1993			
	F: T:	Item		
	Counted Fourtrand		5	
	Section No. 1 Bill No. 1 Preliminaries		R	

	Brought Forward		R	
110	Construction welfare as per Act No 85 of 1993			
	F: T:			
111	Approved inspection Authorities as per Act No 85 of	Item		
	1993			
	F: T:			
		Item		
112	Offences and penalties as per Act No 85 of 1993			
	F: T:			
113	Repeal of regulations as per Act No 85 of 1993	Item		
110	F: V:			
	T:	Item		
114	Short title as per Act No 85 of 1993	item		
	F: T:			
		Item		
115	Obligatory Sub-contracting and Training F:V:			
	T:	Item		
	Carried Forward		R	
	Section No. 1 Bill No. 1 Preliminaries			
				l

	Brought Forward		R	
	The Contractor shall sub-contract 40% of the work to Domestic Sub-contractors as listed in the Schedule of Sub-Contractors in the Returnable Schedules			
	The Principal Agent and the Contractor shall at all times make sure that the work complies with the relevant specifications, standards and norms as contained in this tender.			
	The Principal Agent and the Contractor shall provide for the necessary skills transfer and assistance to complete the sub-contracted section of the works.			
	The Principal Agent and the Contractor shall provide the necessary documentation to the Domestic Sub-Contractor for upgrading of the rating by CIDB.			
	BEE Sub-Contractors must be 100% black owned and have offices in Mpumalanga Province			
116	Expanded Public Works Programme			
	F: T:			
	1	Item		
	The Contractor shall study the guidelines for the implimentation of labour-intensive infrastructure projects under the Expanded Public Works Programme (EPWP) attached to this document. The Contractor shall take note of the requirements and inform all selected and or other sub-contractors, as no claim afterwards will be entertained			
117	C11.1 Local and targeted labour			
	F: V: T:			
		Item		
118	Allow for regular submission of proof of employment of local skilled and unskilled labour to Employer's representative			
	F: T:			
		Item		
	Carried Forward		R	
	Section No. 1			
	Bill No. 1 Preliminaries			

	Brought Forward		R	
119	Training allowance paid to targeted labour in respect of formal training.			
	F:V:			
	T:	Item		
120	Extra over for the administration of payment of training allowances to targeted labour			
	F: T:			
	I	14		
		Item		
121	Transport and accommodation of workers for training where it is not possible to undertake the training in close proximity to the site			
	F: V:			
	T:			
		Item		
122	C12: Contract drawings			
	F: T:			
	1	Item		
	The drawings issued with the tender documents do not comprise the complete set but serve as a guide only for tendering purposes and for indicating the scope of the work to enable the tenderer to acquaint himself with the nature and extent of the works and the manner in which they are to be executed			
	Should any part of the drawings not be clearly understood by the tenderer he shall, before submitting his tender, obtain clarification in writing from the principal agent			
123	C13: General preambles			
	F:V:			
	T:	Item		
	Carried Forward		R	—
	Section No. 1			
	Bill No. 1			
	Preliminaries			

	Brought Forward		R	
124	C14: Trade names			
	F:V:			
	T:	Item		
	Wherever a trade name form any product has been described in the bills of quantities / lump sum document, the tenderer's attention is drawn to the fact that any other product of equal quality may be used subject to the written approval of the principal agent being obtained prior to the closing date for submission of tenders			
	If prior written approval for an alternative product is not obtained, the product described shall be deemed to have been tendered for			
125	C15: Community Liaison Officer			
	F: T:	ltom		
		Item		
126	Allow for a Community Liaison Officer (CLO) to be appointed			
	F:V:			
	T:			
		Item		
127	Allow for net extra cost involved in the emloyment of a Community Liaison Officer (CLO) in respect of the site office.			
	F:V:			
	T:			
		Item		
128	Allow for net extra cost involved in the employment of a Community Liaison Officer (CLO) in respect of the toilets.			
	F: T:			
	1			
		Item		
	Carried Forward		R	
	Section No. 1			
	Bill No. 1			
	Preliminaries			

	Brought Forward		R	
129	Allow for net extra cost involved in the employment of a Community Liaison Officer (CLO) in respect of the sheds.			
	F: T:	Item		
130	C16: SANS 1921-6: HIV/AIDS Awareness read in conjunction with the Associated Specification Data			
	F: T:	Item		
131	General requirements (Clause 4.1) F:V:			
400	T:	Item		
132	HIV/AIDS awareness programme (Clause 4.2) F:V:			
133	T:	Item		
133	Reporting (Clause 4.3) F:			
134	T: General requirements (Clause 4.1)	Item		
	F: V:			
		Item		
	Carried Forward		R	
	Section No. 1 Bill No. 1 Preliminaries			

	Brought Forward		R	
135	COVID-19 awareness programme			
	F:V:			
	T:	Item		
136	COVID-19 Compliance requirements			
	F: T:			
		Item		
	SUMMARY OF CATEGORIES			
	Category : Fixed R			
	Category : Value R			
	Category : Time R			
	Carried to Final Summary		R	
	Section No. 1 Bill No. 1			
	Preliminaries			
				ı

Item No			Quantity	Rate	Amount
	SECTION 3				
	MAIN ACCOMMODATION BLOCKS				
	BILL NO. 1				
	FOUNDATIONS (PROVISIONAL)				
	SUPPLEMENTARY PREAMBLES				
	Nature of ground				
	The nature of the ground is assumed to be loose sandy material, therefore "earth", but possibly interspersed with "hard rock" or "soft rock"				
	Carting away of excavated material				
	Descriptions of carting away of excavated material shall be deemed to include loading excavated material onto trucks directly from the excavations or, alternatively, from stock piles situated on the building site				
	<u>EARTHWORKS</u>				
	SITE CLEARANCE ETC				
	Site clearance				
1	Digging up and removing rubbish, debris, vegetation, hedges, shrubs and trees not exceeding 200mm girth, bush, etc	m2	329		
2	Stripping average 150mm thick layer of top soil and stockpiling on site	m2	329		
	EXCAVATION, FILLING, ETC				
	Excavation in earth not exceeding 2m deep				
3	Reduced levels under floors	m3	25		
4	Trenches	m3	110		
	Carried Forward			R	
	Section No. 2 Bill No. 1 Foundations (Provisional)				

	Brought Forward			R	
	Extra over trench and hole excavations in earth for excavation in				
5	Soft rock	m3	7		
6	Hard rock	m3	4		
	Extra over all excavations for carting away				
7	Surplus material from excavations and/or stock piles on site to a dumping site to be located by the contractor	m3	31		
	Risk of collapse of excavations				
8	Sides of trench and hole excavations not exceeding 1,5m deep	m2	367		
	Keeping excavations free of water				
9	Keeping excavations free of all water other than subterranean water		Item		
	Earth filling obtained from the excavations and/or prescribed stock piles on site compacted to 95% Mod AASHTO density				
10	Under floors, steps, pavings, etc	m3	25		
11	Backfilling to trenches, holes, etc	m3	54		
	Earth filling supplied by the contractor compacted to 95% Mod AASHTO density				
12	Under floors, steps, pavings, etc	m3	49		
	Coarse river sand filling supplied by the contractor				
13	Under floors etc	m3	8		
	SOIL POISONING				
	Soil insectiside				
14	Under floors etc including forming and poisoning shallow furrows against foundation walls etc, filling in furrows and ramming	m2	164		
15	To bottoms and sides of trenches	m2	412		
10	TO BOLLOTTO ATTA SIACO OF FIGURES	1112	712		
	Carried Forward			R	
	Section No. 2 Bill No. 1 Foundations (Provisional)				

	Brought Forward	ı		R	
	CONCRETE				
	UNREINFORCED CONCRETE CAST AGAINST EXCAVATED SURFACES				
	15MPa/19mm concrete				
16	Surface blinding under footings and bases	m3	6		
	REINFORCED CONCRETE				
	REINFORCED CONCRETE CAST AGAINST EXCAVATED SURFACES				
	25MPa/19mm concrete				
17	Strip footings	m3	28		
	REINFORCEMENT				
	(CPAP FORMULA WORK GROUP NO. 114)				
	High tensile steel reinforcement to structural concrete work				
18	10mm Diameter bars stirrups	t	0.46		
19	12mm Diameter bars	t	0.57		
	BRICKWORK				
	Brickwork of NFX bricks (14 MPa nominal compressive strength) in class I mortar				
20	One brick walls	m2	112		
21	Half brick walls	m2	16		
	Brickwork reinforcement				
22	150mm Wide reinforcement built in horizontally	m	560		
23	75mm Wide reinforcement built in horizontally	m	81		
	Carried Forward to Summary of Section No. 2			R	
	Section No. 2				
	Bill No. 1 Foundations (Provisional)				

BILL NO. 2 CONCRETE, FORMWORK AND REINFORCEMENT SUPPLEMENTARY PREAMBLES Cost of tests The costs of making, storing and testing of concrete test cubes as required under clause 7 "Tests" of SABS 1200 G shall include the cost of providing cube moulds necessary for the purpose, for testing costs and for submitting reports on the tests to the Principal Agent. The testing shall be undertaken by an independent firm or institution nominated by the contractor to the approval of the Principal Agent. (Test cubes are measured separately) Formwork Description of formwork shall be deemed to include use and waste only (except where described as "left in" or "permanent"), for fitting together in the required forms, wedging, plumbing and fixing to true angles and surfaces as necessary to ensure easy release during stripping and for reconditioning as necessary before re-	
REINFORCEMENT SUPPLEMENTARY PREAMBLES Cost of tests The costs of making, storing and testing of concrete test cubes as required under clause 7 "Tests" of SABS 1200 G shall include the cost of providing cube moulds necessary for the purpose, for testing costs and for submitting reports on the tests to the Principal Agent. The testing shall be undertaken by an independent firm or institution nominated by the contractor to the approval of the Principal Agent. (Test cubes are measured separately) Formwork Description of formwork shall be deemed to include use and waste only (except where described as "left in" or "permanent"), for fitting together in the required forms, wedging, plumbing and fixing to true angles and surfaces as necessary to ensure easy release during	
Cost of tests The costs of making, storing and testing of concrete test cubes as required under clause 7 "Tests" of SABS 1200 G shall include the cost of providing cube moulds necessary for the purpose, for testing costs and for submitting reports on the tests to the Principal Agent. The testing shall be undertaken by an independent firm or institution nominated by the contractor to the approval of the Principal Agent. (Test cubes are measured separately) Formwork Description of formwork shall be deemed to include use and waste only (except where described as "left in" or "permanent"), for fitting together in the required forms, wedging, plumbing and fixing to true angles and surfaces as necessary to ensure easy release during	
The costs of making, storing and testing of concrete test cubes as required under clause 7 "Tests" of SABS 1200 G shall include the cost of providing cube moulds necessary for the purpose, for testing costs and for submitting reports on the tests to the Principal Agent. The testing shall be undertaken by an independent firm or institution nominated by the contractor to the approval of the Principal Agent. (Test cubes are measured separately) Formwork Description of formwork shall be deemed to include use and waste only (except where described as "left in" or "permanent"), for fitting together in the required forms, wedging, plumbing and fixing to true angles and surfaces as necessary to ensure easy release during	
cubes as required under clause 7 "Tests" of SABS 1200 G shall include the cost of providing cube moulds necessary for the purpose, for testing costs and for submitting reports on the tests to the Principal Agent. The testing shall be undertaken by an independent firm or institution nominated by the contractor to the approval of the Principal Agent. (Test cubes are measured separately) Formwork Description of formwork shall be deemed to include use and waste only (except where described as "left in" or "permanent"), for fitting together in the required forms, wedging, plumbing and fixing to true angles and surfaces as necessary to ensure easy release during	
Description of formwork shall be deemed to include use and waste only (except where described as "left in" or "permanent"), for fitting together in the required forms, wedging, plumbing and fixing to true angles and surfaces as necessary to ensure easy release during	
and waste only (except where described as "left in" or "permanent"), for fitting together in the required forms, wedging, plumbing and fixing to true angles and surfaces as necessary to ensure easy release during	
use	
The vertical strutting shall be carried down to such construction as is sufficiently strong to afford the required support without damage and shall remain in position until the newly constructed work is able to support itself.	
Formworks to soffits of solid etc shall be deemed to be slabs not exceeding 250mm thick unless otherwise described	
Formwork to sides of bases, pile caps, ground beams, etc will only be measured where it is prescribed by the engineer for design reasons. Formwork necessitated by irregularity or collapse of excavated faces will not be measured and the cost thereof shall be deemed to be included in the allowance for taking the risk of collapse of the sides of the excavations, provision for which is made in "Earthworks"	
Carried Forward R	
Section No. 2 Bill No. 2	
Concrete, Formwork and Reinforcement	

	Brought Forward			R		
	REINFORCED CONCRETE					
	25MPa/19mm concrete					
1	Surface beds on waterproofing	m3	17			
	TEST BLOCKS					
2	Making and testing 150 x 150 x 150mm concrete strenght test cube (Provisional)	No	10			
	CONCRETE SUNDRIES					
	Finishing top surfaces of concrete smooth with a wood float					
3	Aprons, slabs, etc to falls	m2	164			
	ROUGH FORMWORK (DEGREE OF ACCURACY II)					
	Rough formwork to sides					
4	Edges, risers, ends and reveals not exceeding 300mm high or wide (Provisional)	m	36			
	MOVEMENT JOINTS ETC					
	Expansion joints with closed cell expanded polystirene joint filler between vertical concrete and/or brick surfaces					
5	10mm Joints not exceeding 300mm high	m	72			
	REINFORCEMENT (PROVISIONAL)					
	Fabric reinforcement					
6	Type 193 fabric reinforcement in concrete surface beds, slabs, etc	m2	164			
						_
	Carried Forward to Summary of Section No. 2			R		
	Section No. 2 Bill No. 2					
	Concrete, Formwork and Reinforcement					
		1			l	

Item No			Quantity	Rate	Amount
	BILL NO. 3	l			
	MASONRY				
	SUPPLEMENTARY PREAMBLES				
	BRICKWORK				
	Sizes in descriptions				
	Where sizes in descriptions are given in brick units, "one brick" shall represent the length and "half brick" the width of a brick				
	Face bricks				
	Bricks shall be ordered timeously to obtain uniformity in size and colour				
	<u>Pointing</u>				
	Descriptions of recessed pointing to fair face brickwork and face brickwork shall be deemed to include square recessed, hollow recessed, weathered pointing, etc.				
	SUPERSTRUCTURE				
	Brickwork of NFP bricks in class II mortar				
1	Half brick walls	m2	88		
2	Half brick walls in beamfilling	m2	21		
3	One brick walls	m2	372		
	BRICKWORK SUNDRIES				
	Brickwork reinforcement				
4	75mm Wide reinforcement built in horizontally	m	546		
5	150mm Wide reinforcement built in horizontally	m	1,863		
	Prestressed fabricated lintels				
6	110 x 75mm Lintels in lengths not exceeding 3m	m	31		
	Carried Forward			R	
	Section No. 2 Bill No. 3 Masonry				

	Brought Forward			R	
	Galvanised hoop iron cramps, ties, etc				
7	30 x 1,6mm Roof tie 1,5m long with one end fixed to timber and other end built into brickwork	No	110		
	NUTEC-CEMENT WINDOW SILLS				
	Natural grey sills in single lengths bedded in class I mortar including metal fixing lugs etc				
8	15 x 150mm Wide sills set flat and slightly projecting	m	25		
	PAVING (Provisional)				
	60mm Standard grey interlocking paving blocks laid with butt joints (Prime Cost Amount R 1 000.00/1000) on 25mm thick river sand bed with sand and cement mixture swept into joints and hosed down, including preparation of groung or filling				
9	Paving in herringbone bond in aprons	m2	61		
	Carried Forward to Summary of Section No. 2			R	
	Section No. 2 Bill No. 3 Masonry				

Item No			Quantity	Rate	Amount
	BILL NO. 4				
	WATERPROOFING				
	DAMP-PROOFING OF WALLS AND FLOORS				
	One layer of 375 micron "Consol Plastics Brikgrip DPC" embossed damp proof course				
1	In walls	m2	45		
	One layer of 250 micron "Consol Plastics Gunplas USB Green" waterproof sheeting sealed at laps with "Gunplas Pressure Sensitive Tape"				
2	Under surface beds	m2	164		
	JOINT SEALANTS, ETC				
	"Denbraven LM15" polysulphide sealing compound including backing cord, bond breaker, primer, etc				
3	10 x 10mm In expansion joints in floors	m	49		
	Carried Forward to Summary of Section No. 2			R	
	Section No. 2 Bill No. 4				
	Waterproofing				

Item No		Quantity	Rate	Amount
l	BILL NO. 5			
	ROOF COVERINGS ETC			
	PROFILED METAL SHEETING AND ACCESSORIES			
	0,6mm "IBR" Z275 spelter galvanised troughed sheet steel with "globalcoat" finish on one side in single lengths fixed to timber purlins and 0,6mm galvanised sheet steel accessories with "globalcoat" finish on one side			
1	Roof covering with pitch not exceeding 25 degrees m2	216		
2	Head wall flashings 308mm girth m	49		
	ROOF AND WALL INSULATION			
	"Sisalation 410" housing grade glass fibre reinforced aluminium foil bonded insulation			
3	Insulation laid taut over purlins (at approximately 1 100mm centres) and fixed concurrent with roof covering including galvanised steel straining wires m2	188		
	Carried Forward to Summary of Section No. 2		R	
	Section No. 2 Bill No. 5 Roof Covering			

Item No		Quantity	Rate	Amount	
	BILL NO. 6				
	CARPENTRY AND JOINERY				
	SUPPLEMENTARY PREAMBLES				
	Particle board:				
	Particle board shall comply with the following specifications:				
	a) SABS 1300 Particle board: exterior and flooring type				
	b) SABS 1301 Particle board: interior type				
	Joinery:				
	Descriptions of frames shall be deemed to include frames, transoms, mullions, rails, etc				
	Descriptions of hardwood joinery shall be deemed to include pelleting of bolt holes				
	<u>Fixing</u>				
	Items described as "nailed" shall be deemed to be fixed with hardened steel nails or shot pins to brickwork or concrete				
	Decorative laminate finish:				
	Laminate finish shall be glued under pressure. Edge strips shall be butt jointed at junctions with adjacent similar finish				
	Carried Forward		R		_
	Section No. 2 Bill No. 6 Carpentry and Joinery				

	Brought Forward	l		R	
	ROOFS, ETC				
	Plate nailed timber roof truss construction				
	The following is applicable in respect of roof trusses:				
	Trusses are at maximum 1,10m centres				
	Roof covering is galvanised "IBR" roof sheeting with "Globalcoat" finish on one side on 50 x 75mm purlins at 1,1m maximum centres.				
	Ceilings are generally 6,4mm gypsum plasterboard on 38 x 38mm brandering.				
	All timber to be sawn softwood in accordance with V4 or M4 as defined in SABS 563 or SABS 1245.				
	Metal connector plates shall have a minimum yield strength of 228 MPa and a minimum ultimate tensile strength of 330 Mpa with hot-dip galvanised finish.				
	All joints to be close fitted butt joints.				
	Trusses shall be designed by a registered supplier of prefabricated trusses who shall issue an Engineers Certificate upon completion of the installation.				
	The dimensions in the descriptions of the trusses are nominal and actual measurements are to be obtained on site before design or fabrication commences.				
	Tenderers must study the roof plan and sections as attached to the back of these bills of quantities (refer drawing No.'s CLASS-3 - 001 to 002) and must obtain prices from a qualified and registered roof truss supplier as no claims in this regard will be entertained.				
	Sawn softwood				
1	38 x 114mm Wall plates	m	62		
	Carried Forward			R	
	Section No. 2 Bill No. 6 Carpentry and Joinery				

	Brought Forward			R	
2	Design, manufacture and deliver on site, plate nailed roof truss construction to main accommodation Block, circular in form, size 15.46mm diameter overall on plan consisting of forty five mono pitched trusses, each truss 7 750 x 1 800mm high overall with 600mm eaves overhang projecting all sides, including all necessary purlins, runners, bracing and cross bracing (wall plates elsewhere)	No	1		
3	Design, manufacture and deliver on site, plate nailed roof truss construction to main accommodation Block, circular in form, size 4.886m diameter overall on plan consisting of sixteen mono pitched trusses, each truss 2 443 x 1 800mm high overall with 600mm eaves overhang projecting all sides, including all necessary purlins, runners, bracing and cross bracing (wall plates elsewhere)	No	1		
4	Take delivery, temporary store, hoist in position and erect plate nailed timber roof trusses, purlins, gangboarding, temporary and permanent bracing, etc (measured on slope of roof)	m2	188		
	Sundries				
5	Two coats creosote on sawn timbers	m2	9		
	EAVES, VERGES, ETC				
	"Everite" pressed nutec-cement				
6	12 x 225mm Fascias and barge boards including galvanised steel H-profile jointing strips	m	64		
	DOORS ETC				
	Wrought hardwood flushback doors with sapele veneer hung to steel frames				
7	44mm "TDM" Framed and ledged door 813 x 2 032mm high	No	5		
	Semi-solid flush doors with sapele veneer on both sides hung to steel frames				
8	44mm Door 813 x 2 032mm high	No	5		
					_
	Carried Forward to Summary of Section No. 2			R	
	Section No. 2 Bill No. 6 Corporate and Joiners				
	Carpentry and Joinery				

Item No			Quantity	Rate	Amount
	BILL NO. 7				
	CEILINGS, PARTITIONS AND ACCESS FLOORING				
	SUPPLEMENTARY PREAMBLES				
	Descriptions:				
	Items described as "nailed" shall be deemed to be fixed with hardened steel nails or pins or shot pinned to brickwork or concrete				
	Items described as "plugged" shall be deemed to include screwing to fibre, plastic or metal plugs at not exceeding 600mm centres, and where described as "bolted" the bolts have been given elsewhere				
	CEILINGS ETC				
	"Aerolite" insulation				
1	75mm Insulation closely fitted and laid on top of brandering between roof timbers etc	m2	164		
	NAILED UP CEILINGS				
	6,4mm "Rhino" gypsum plasterboard with H-type pressed steel jointing strips				
2	Ceilings including 38 x 38mm sawn softwood brandering at 400mm centres	m2	164		
3	Extra over ceiling for 650 x 650mm trap door of 38 x 50mm wrought softwood rebated framing with one 38 x 50mm sawn softwood cross brander covered with ceiling board and fitted flush in opening	No	2		
	"Rhino" gypsum plasterboard cornices				
4	75mm Coved cornices	m	138		
	Carried Forward to Summary of Section No. 2			R	
	Section No. 2 Bill No. 7 Ceilings, Partitions and Access Flooring				
	5 ,				

Item No		Quantity	Rate	Amount
	BILL NO. 8			
	FLOOR COVERINGS, PLASTIC LININGS, ETC			
	FLOOR COVERINGS			
	300 x 300 x 2,5mm "Marley" or other equal and approved semi-flexible vinyl tiles			
1	On floors m2			
	POLISH, SEALERS, ETC			
	Two coats wax polish			
2	On vinyl floors m2			
	Carried Forward to Summary of Section No. 2		R	
	Section No. 2			
	Bill No. 8 Floor Coverings, Wall Linings, etc			

Item No		Quantity	Rate	Amount
	BILL NO. 9			
	IRONMONGERY			
	SUPPLEMENTARY PREAMBLES			
	Finishes to ironmongery			
	Where applicable finishes to ironmongery are indicated by suffixes in accordance with the following list: BS Satin bronze lacquered CH Chromium plated SC Satin chromium plated SE Silver enamelled GE Grey enamelled AS Anodised silver AB Anodised bronze AG Anodised gold ABL Anodised black PB Polished brass PL Polished and lacquered PT Epoxy coated SD Sanded NP Nickle plated			
	HINGES, BOLTS, ETC.			
1	200mm Brass barrel bolt with keep fixed to metal	10		
	"Union"			
2	"CZ80941SC" WC indicator bolt with keep fixed to metal N	5		
	LOCKS			
	<u>"Union"</u>			
3	"CZ682-24/2247-78" or other similar and approved four lever lockset with striking plate fixed to metal or timber N	5		
	"Mazac Tarpon"			
4	"952/2L" or other equal and approved two lever lockset with chrome plated finish with striking plate fixed to metal N	5		
	<u>HANDLES</u>			
	Carried Forward		R	
	Section No. 2 Bill No. 9 Ironmongery			

	Brought Forward			R	
	"Dorma"				
5	32 x 515mm Stainless steel "D" straight back-to-back pull handles	No	10		
	"BATHROOM FITTINGS"				
6	19mm Diameter chromium plated towel rail 600mm long including end brackets plugged	No	5		
	"Stiebel Eltron"				
7	"SDSS" Soap dispenser plugged	No	5		
	"Nampak"				
8	"TR2" lockable toilet roll holder plugged	No	5		
	LETTERS, NAMEPLATES, ETC				
9	60 x 3mm Thick perspex plate with two 40mm high engraved and painted numerals	No	1		
	<u>"Union"</u>				
10	"AL5066-06ASE06" 152 x 152mm anodised aluminium plate with fire extinguisher pictogram	No	1		
	SUNDRIES				
	"Union"				
11	"AL8730AS" door stop plugged	No	10		
	Carried Forward to Summary of Section No. 2			R	
	Section No. 2				
	Bill No. 9 Ironmongery				

Item No		ĺ	Quantity	Rate	Amount	
	BILL NO. 10	I.				
	METALWORK					
	SUPPLEMENTARY PREAMBLES					
	<u>Descriptions</u>					
	Descriptions of bolts shall be deemed to include nuts and washers					
	Descriptions of expansion anchors and bolts and chemical anchors and bolts shall be deemed to include nuts, washers and mortices in brickwork or concrete					
	Metalwork described as "holed for bolt(s)" shall be deemed to exclude the bolts unless otherwise described					
	WELDED SCREENS, GATES, ETC					
	Steel gates and frames					
1	Single gate and frame 965 x 2 067mm high overall, the outer frame of 45 x 45 x 3mm hollow section bolted to wall with and including eight 70mm M80 expansion bolts and the gate 813 x 2 032mm high of 40 x 60 x 2mm hollow section frame with two 40 x 6mm flat section horizontal rails filled in with 20mm diameter vertical rails at 110mm centres fitted with one and a half pairs of suitable pin hinges welded to hollow section steel frame, complete with and including 150mm barrelbolt and					
	padlock	No	5			
	PRESSED STEEL DOOR FRAMES					
	1,2mm Double rebated frames suitable for half brick walls					
2	Frame for door 813 x 2 032mm high	No	5			
	1,2mm Double rebated frames suitable for one brick walls					
3	Frame for door 813 x 2 032mm high	No	5			
	Carried Forward			R		_
	Section No. 2 Bill No. 10 Metalwork					

	Brought Forward	d		R	
	STEEL WINDOWS, DOORS, ETC				
	Standard steel type top hung residential open out windows with 12mm square steel rods at 100mm c/c between burgler bars				
4	Window type G1, 533 x 359mm high	No	5		
5	Window type SG4, 1 511 x 949mm high	No	5		
6	Window type E4H, 1 511 x 654mm high	No	4		
	Carried Forward to Summary of Section No. 2			R	
	Carried Forward to Summary of Section No. 2			Κ	
	Section No. 2 Bill No. 10				
	Metalwork				

Item No		Quantity	Rate	Amount
	BILL NO. 11			
	PLASTERING			
	<u>SCREEDS</u>			
	Screeds on concrete			
1	25mm Thick on floors and landings m2	164		
	INTERNAL PLASTER			
	Cement plaster on brickwork			
2	On walls m2	538		
3	On narrow widths m2	25		
	EXTERNAL PLASTER			
	Cement plaster on brickwork			
4	On walls m2	461		
5	On narrow widths m2	16		
	CORNER PROTECTORS, DIVIDING STRIPS, ETC			
6	3 x 32mm Flat section brass dividing strips between different floor finishes m	9		
	Carried Forward to Summary of Section No. 2		R	
	Section No. 2			
	Bill No. 11 Plastering			

Item No			Quantity	Rate	Amount	
	SECTION 2					
	BILL NO. 12					
	TILING					
	NOTE: Unless otherwise stated herein, all items in this bill shall be deemed to fall into Work Group No. 144 for CPAP formula purposes.					
	SUPPLEMENTARY PREAMBLES					
	<u>Descriptions</u>					
	Unless described as "fixed with adhesive to plaster (plaster elsewhere)" descriptions of tiling on brick or concrete walls, columns, etc shall be deemed to include 1:4 cement plaster backing and descriptions of tiling on concrete floors etc shall be deemed to include 1:3 plaster bedding					
	WALL TILING					
	200 x 200 x 6mm "Cercisa Tinte Unite" White glazed ceramic tiles fixed with adhesive to plaster (plaster elsewhere)					
1	On walls	m2	63			
	FLOOR TILING					
	300 x 300mm x 8mm Porcelain tiles (PC Amount R130.00/m2) fixed with adhesive to bedding (bedding elsewhere) and flush pointed with tinted waterproof jointing compound					
2	On floors and landings	m2	164			
3	Skirting 150mm high	m	122			
	Carried Forward to Summary of Section No. 2			R		_
	Section No. 2					_
	Bill No. 12 Tiling					

	Quantity	Rate	Amount
BILL NO. 12			
PLUMBING AND DRAINAGE			
PLUMBING AND DRAINAGE (PROVISIONAL)			
NOTE: Unless otherwise stated herein, all items in this bill shall be deemed to fall into Work Group No. 148 for CPAP formula purposes.			
"Polycop" polypropylene pipes:			
Polypropylene pipes 54mm diameter and under shall be seamless copper coloured class 16 pipes jointed with "Fast-fuse" heat welded thermoplastic or brass compression fittings as designed for use with copper pipes as stated			
Pipes shall be firmly fixed to walls etc with coloured nylon snap-in pipe clips with provision for accommodating thermal movement and jointed and fixed strictly in accordance with the manufacturer's instructions			
All pipe diameters are nominal external			
Concrete pipes:			
Pipes shall be jointed with ogee joints with rubber collars or socket and spigot joints with rubber rings			
uPVC pipes and fittings:			
Soil, waste and vent pipes and fittings shall be solvent weld jointed			
uPVC pressure pipes and fittings:			
Pipes for water supply shall be of the class stated			
Pipes of 40mm diameter and smaller shall be plain ended with solvent welded uPVC loose sockets and fittings			
Carried Forward		R	
Section No. 2 Bill No. 13			

Brought Forward	R	
Pipes of 50mm diameter and greater shall have sockets and spigots with push in type integral rubber ring joints. Bends shall be uPVC and all other fittings shall be cast iron, all with similar push-in type joints		
Copper pipes:		
Pipes shall be hard drawn and half-hard pipes of the class stated. Class 0 (thin walled hard drawn) pipes shall not be bent. Class 1 (thin walled half-hard), class 2 (half-hard) and class 3 (heavy walled half-hard) pipes shall only be bent with benders with inner and outer formers. Fittings to copper waste, vent and anti-syphon pipes, capillary solder fittings and compression fittings shall be "Cobra Watertech" type. Capillary solder fittings shall comply with ISO 2016. Only compression fittings shall be used in walls or in ground		
Fixing of pipes		
Unless specifically otherwise stated, descriptions of pipes shall be deemed to include fixing to walls etc, casting in, building in or suspending not exceeding 1m below suspension level		
Reducing fittings		
Where fittings have reducing ends or branches they are described as "reducing". In the case of pipes with diameters not exceeding 60mm only the largest end or branch size is given. Should the contractor wish to use other fittings and bushes or reducers he may do so on the understanding that no claim in this regard will be entertained. In the case of pipes with diameters exceeding 60mm all sizes are given and no claim for extra bushes, reducers, etc will be entertained		
Wire gratings		
Descriptions of gutter outlets etc shall be deemed to include wire balloon gratings		
Excavations		
No claim for rock excavation will be entertained unless the contractor has timeously notified the quantity surveyor thereof prior to backfilling		
"Soft rock" and "hard rock" shall be as defined in "Earthworks"		
Carried Forward	R	
Section No. 2 Bill No. 13 Plumbing and Drainage		

Broug	ght Forward		R	
Laying, backfilling, bedding, etc. of pipes				
Pipes shall be laid and bedded and trenches carefully backfilled in accordance with manufainstructions				
Where no manufacturers' instructions exist pip be laid in accordance with clauses 5.1 and 5.3 of the following: SABS 1200 L : Medium-pressippelines LD : Sewers LE : Stormwater drainal trenches etc shall be backfilled in accordance clauses 3, 5.5, 5.6, 5.7 and 7 of SABS 1200 Earthworks (Pipe trenches) Pipes shall be becaccordance with clauses 3.1 to 3.4.1, 5.1 to 5 SABS 1200 LB : Bedding (Pipes). Unless other described bedding of rigid pipes shall be class bedding	2 of each sure age Pipe with DB: dded in .3 and 7 of erwise			
Flush pans				
Flush pans shall have straight or side outlets "S" traps as necessary	and "P" or			
Stainless steelbasins, sinks, wash troughs etc.	s, urinals <u>,</u>			
Units shall have standard aprons on all expos and tiling keys against walls where applicable				
Waste unions				
Descriptions of waste unions shall be deemed rubber or vulcanite plugs and chains fixed to f				
RAINWATER DISPOSAL				
0.8mm seamless aluminium gutters and do	own pipes			
75 x 75mm eaves gutters	m	49		
Extra over 75 x 75mm eaves gutter for angle	No	5	;	
Extra over 75 x 75mm eaves gutter for outlet pipe	for 75mm No	5		
75mm Diameter rainwater pipes	m	15		
Carried	Forward		R	
Section No. 2 Bill No. 13 Plumbing and Drainage				

	Brought Forward			R	j
5	Extra over 75mm diameter rainwater pipe for shoe	No	5		
6	Extra over 75mm diameter rainwater pipe for bend	No	5		
7	Extra over 75mm diameter rainwater pipe for eaves or plinth offset 600mm projection	No	5		
	SANITARY FITTINGS				
	"Plumbcrazy" Grade 304 stainless steel				
8	"DEB Code 304-11A" Double bowl sink and drainer 1 350 x 535mm wide including fixing complete to walls with (Code 7880) mild steel brackets bolted with expansion bolts	No	5		
	<u>"Vaal"</u>				
9	530 x 430mm "Orbit" self-rimming drop-in vanity basin	No	5		
10	"Klip" low level wc suite comprising pan with double flap heavy duty plastic seat and matching 9 litre cistern with flush pipe	No	5		
	WASTE UNIONS, ETC				
	"Cobra Watertech"				
11	32mm "301CP" Basin waste union	No	5		
12	40mm "316CP" Bath or sink waste union	No	5		
	TRAPS, ETC				
	"Marley"				
13	32 x 50mm Deep seal "P" or "S" trap	No	5		
	"Cobra Watertech"				
14	32mm "345/50CP" bottle trap	No	5		
15	40mm "365/50CP" bottle trap	No	5		
16	40 x 300mm Sink combination for double bowl with deepseal "P" trap	No	5		
	Carried Forward			R	_
	Section No. 2 Bill No. 13 Plumbing and Drainage				

	Brought Forward			R	
	"Cobra Watertech"				
17	40mm "373CP" Shower trap including grating	No	5		
	TAPS, VALVES, ETC				
	<u>Brass</u>				
18	15mm Fullway gate valve	No	2		
19	22mm Fullway gate valve	No	3		
20	22mm Bibcock with hose union	No	2		
	"Cobra Watertech"				
21	15mm "059CP" Extension piece with sliding wall flange	No	3		
22	15mm "128CP Carina" underwall pattern stopcock	No	5		
23	15mm "166/041CP Carina" wall type sink mixer	No	5		
24	15mm "505-21CP" elbow action pillarcock	No	5		
25	15mm 111CP Pillartap	No	5		
26	15mm "065" Prestex shower head with ball joint connector	No	5		
27	PB1.10RB vacuum breaker	No	5		
	SANITARY PLUMBING				
	uPVC pipes				
28	50mm Pipes	m	75		
29	110mm Pipes	m	10		
	Extra over uPVC pipes for fittings				
30	50mm Bend	No	5		
31	50mm Junction	No	5		
32	110mm Pan connector	No	5		
33	50mm Access bend	No	5		
	Carried Forward			R	
	Section No. 2 Bill No. 13 Plumbing and Drainage				

	Brought Forward	ı		R	
34	110mm Access bend	No	5		
35	50mm Access junction	No	5		
36	110mm Access Junction	No	5		
37	110mm Access bend with anti-syphon horn	No	5		
38	50mm "GI Two-way" vent valve	No	5		
	<u>Sundries</u>				
39	Testing waste pipe system		Item		
	WATER SUPPLIES				
	Class 0 copper pipes				
40	15mm Pipes	m	15		
41	15mm Pipes chased into brick walls	m	55		
42	22mm Pipes	m	46		
43	22mm Pipes chased into brick walls	m	55		
	Extra over class 0 copper pipes for capillary fittings				
44	15mm Fittings	No	35		
45	22mm Fittings	No	20		
	Copper overflow and service pipes				
46	15mm Service pipe 500mm girth	No	15		
	ELECTRIC WATER HEATERS				
	"Kwikot"				
47	150 Litre horizontal electric water heater in roof including standard galvanised sheet iron drip tray with overflow pipe to external wall	No	1		
	TESTING				
48	Testing water pipe system		Item		
	Carried Forward			R	
	Section No. 2 Bill No. 13 Plumbing and Drainage				

	Brought Forward		R	
	FIRE APPLIANCES ETC		ı	
	"Chubb"			
49	4,5kg Carbon dioxide fire extinguisher complete with 520 x 115 x 22mm thick timber backboard plugged to wall and varnished No	1		
	Carried Forward to Summary of Section No. 2		R	
	Section No. 2 Bill No. 13 Plumbing and Drainage			

Item No		Quantity	Rate	Amount
	BILL NO. 13			
	<u>GLAZING</u>			
	GLAZING TO STEEL WITH PUTTY			
	6,38mm Normal strength clear laminated safety glass			
1	Panes not exceeding 0,1 m2 m3	2 5		
2	Panes exceeding 0,1 and not exceeding 0,5m2	2 7		
	TOPS, SHELVES, DOORS, MIRRORS, ETC			
	6mm Silvered float glass copper backed mirrors with polished edges holed for and fixed with chromium plated dome capped mirror screws with rubber buffers to plugs in brickwork or concrete			
3	Mirror 600 x 1200mm high with four screws	1		
4	Mirror 1800 x 900mm high with four screws	1		
	Carried Forward to Summary of Section No. 2		R	
	Section No. 2 Bill No. 14 Glazing			

Item No			Quantity	Rate	Amount
	BILL NO. 14	Ï			
	<u>PAINTWORK</u>				
	ON FLOATED PLASTER				
	One coat alkali resistant primer, one undercoat and two coats eggshell enamel paint				
1	On internal walls	m2	563		
	One coat alkali resistant primer, one undercoat and two coats eggshell enamel paint				
2	On external walls	m2	477		
	ON PLASTERBOARD				
	One coat primer and two coats interior quality PVA emulsion paint				
3	On ceilings and cornices	m2	164		
	ON FIBRE-CEMENT				
	One coat primer and two coats interior quality acrylic PVA paint				
4	On internal window sills not exceeding 300mm wide or girth	m	25		
	One coat primer and two coats exterior quality PVA emulsion paint				
5	On fascias and barge boards	m2	15		
	ON METAL				
	Spot priming defects in pre primed surfaces with zinc chromate primer and applying one undercoat and two coat high gloss enamel paint on steel				
6	On door frames	m2	11		
7	On windows with burglar bars	m2	24		
8	On gates, grilles, burglar screens, balustrades, etc (both sides measured over the full flat area)	m2	20		
	Carried Forward			R	
	Section No. 2 Bill No. 15 Paintwork				

	Brought Forward			R		
	ON WOOD					
	One coat wood primer, one coat undercoat and one coat polyurethane gloss enamel paint					
9	On doors	m2	17			
	Three coats polyurethane semi-gloss varnish					
10	On doors	m2	17			
	Carried Forward to Summary of Section No. 2			R		
	Section No. 2 Bill No. 15					
	Paintwork					
					1	1

Bill No	SECTION SUMMARY - Main accommodation	Page No		Amount
1	Foundations (Provisional)	31		
2	Concrete, Formwork and Reinforcement	33		
3	Masonry	35		
4	Waterproofing	36		
5	Roof Covering	37		
6	Carpentry and Joinery	40		
7	Ceilings, Partitions and Access Flooring	41		
8	Floor Coverings, Wall Linings, etc	42		
9	Ironmongery	44		
10	Metalwork	46		
11	Plastering	47		
12	Tiling	48		
13	Plumbing and Drainage	55		
14	Glazing	56		
15	Paintwork	58		
	Carried to Final Summary		R	
	Section No. 2			

Item No			Quantity	Rate	Amount	
	SECTION 7					
	Administration block					
	BILL NO. 1					
	EARTHWORKS (PROVISIONAL)					
	NOTE: Unless otherwise stated herein, all items in this bill shall be deemed to fall into Work Group No. 104 for CPAP formula purposes.					
	SUPPLEMENTARY PREAMBLES					
	Nature of ground					
	The nature of the ground is assumed to be loose sandy material, therefore "earth", but possibly interspersed with "hard rock" or "soft rock".					
	Carting away of excavated material					
	Descriptions of carting away of excavated material shall be deemed to include loading excavated material onto trucks directly from the excavations or, alternatively, from stock piles situated on the building site.					
	SITE CLEARANCE ETC					
	Site clearance					
1	Digging up and removing rubbish, debris, vegetation, hedges, shrubs and trees not exceeding 200mm girth, bush, etc	m2	162			
2	Stripping average 150mm thick layer of top soil and stockpiling on site	m2	162			
	EXCAVATION, FILLING, ETC					
	Excavation in earth not exceeding 2m deep					
3	Reduced levels under floors	m3	49			
4	Trenches	m3	83			
	Carried Forward			R		_
	Section No. 3 Bill No. 1 Foundations (Provisional)					

	Brought Forward			R	
	Extra over trench and hole excavations in earth for excavation in				
5	Soft rock	m3	4		
6	Hard rock	m3	2		
	Extra over all excavations for carting away				
7	Surplus material from excavations and/or stock piles on site to a dumping site to be located by the contractor	m3	49		
	Risk of collapse of excavations				
8	Sides of trench and hole excavations not exceeding 1,5m deep	m2	226		
	Keeping excavations free of water				
9	Keeping excavations free of all water other than subterranean water		Item		
	Earth filling obtained from the excavations and/or prescribed stock piles on site compacted to 93% Mod AASHTO density				
10	Backfilling to trenches, holes, etc	m3	41		
11	Under floors, steps, pavings, etc	m3	42		
	Earth filling supplied by the contractor compacted to 93% Mod AASHTO density				
12	Under floors, steps, pavings, etc	m3	49		
	Coarse river sand filling supplied by the contractor				
13	Under floors etc	m3	5		
	SOIL POISONING				
	Soil insectiside				
14	Under floors etc including forming and poisoning shallow furrows against foundation walls etc, filling in furrows and ramming	m2	108		
15	To bottoms and sides of trenches	m2	278		
	Carried Forward			R	_
	Section No. 3 Bill No. 1 Foundations (Provisional)				

Brought Forward	R	
Carried Forward	R	—
Section No. 3 Bill No. 1		
Foundations (Provisional)		

	Brought Forward			R	
	CONCRETE				
	(CPAP formula work group no. 110)				
	UNREINFORCED CONCRETE CAST AGAINST EXCAVATED SURFACES				
	15MPa/19mm concrete				
16	Surface blinding under footings and bases	m3	5		
	REINFORCED CONCRETE CAST AGAINST EXCAVATED SURFACES				
	25MPa/19mm concrete				
17	Strip footings	m3	18		
	REINFORCEMENT				
	(CPAP formula work group no. 114)				
	High tensile steel reinforcement to structural concrete work				
18	10mm Diameter bars	t	0.37		
19	12mm Diameter bars	t	0.43		
	MOVEMENT JOINTS, ETC				
	Expansion joints with softboard between vertical concrete surfaces				
20	12mm Joints not exceeding 300mm high	m	126		
	BRICKWORK				
	(CPAP formula work group no. 116)				
	Brickwork of NFX bricks (14 MPa nominal compressive strength) in class I mortar				
21	One brick walls	m2	40		
22	Half brick walls	m2	47		
	Carried Forward			R	
	Section No. 3 Bill No. 1 Foundations (Provisional)				

	Brought Forwar	d		R	
	Brickwork reinforcement				
23	150mm Wide reinforcement built in horizontally	m	211		
24	75mm Wide reinforcement built in horizontally	m	235		
					<u> </u>
	Carried Forward to Summary of Section No. 3			R	
	Section No. 3 Bill No. 1 Foundations (Provisional)				
	·				

	Quantity	Rate	Amount
BILL NO. 2			
CONCRETE, FORMWORK AND REINFORCEMENT			
NOTE: Unless otherwise stated herein, all items in this bill shall be deemed to fall into Work Group No. 110 for CPAP formula purposes.			
SUPPLEMENTARY PREAMBLES			
Cost of tests			
The costs of making, storing and testing of concrete test cubes as required under clause 7 "Tests" of SABS 1200 G shall include the cost of providing cube moulds necessary for the purpose, for testing costs and for submitting reports on the tests to the architect. The testing shall be undertaken by an independent firm or institution nominated by the contractor to the approval of the architect. (Test cubes are measured separately).			
<u>Formwork</u>			
Descriptions of formwork shall be deemed to include use and waste only (except where described as "left in" or "permanent"), for fitting together in the required forms, wedging, plumbing and fixing to true angles and surfaces as necessary to ensure easy release during stripping and for reconditioning as necessary before reuse.			
The vertical strutting shall be carried down to such construction as is sufficiently strong to afford the required support without damage and shall remain in position until the newly constructed work is able to support itself.			
Carried Forward		R	
Section No. 3			
Bill No. 2 Concrete, Formwork and Reinforcement			

	Brought Forward			R	
ļ	Formwork to soffits of solid slabs etc shall be deemed to be to slabs not exceeding 250mm thick unless otherwise described				
	Formwork to sides of bases, pile caps, ground beams, etc will only be measured where it is prescribed by the engineer for design reasons.				
	Formwork necessitated by irregularity or collapse of excavated faces will not be measured and the cost thereof shall be deemed to be included in the allowance for taking the risk of collapse of the sides of the excavations, provision for which is made in "Earthworks"				
	REINFORCED CONCRETE				
	25MPa/19mm concrete				
1	Surface beds on waterproofing	m3	11		
2	Ramps	m3	1		
3	Vanity slabs, cupboard slabs, cover slabs, etc	m3	1		
	TEST BLOCKS				
4	Making and testing 150 x 150 x 150mm concrete strength test cube (Provisional)	No	5		
	CONCRETE SUNDRIES				
	Finishing top surfaces of concrete smooth with a steel trowel including rounding edges to form a bullnose finish				
5	Vanity slabs, cupboard slabs, cover slabs, etc	m2	12		
	SMOOTH FORMWORK (DEGREE OF ACCURACY II)				
	(CPAP formula work group no. 111)				
	Smooth formwork to sides				
6	Edges, risers, ends and reveals not exceeding 300mm high or wide	m	15		
	Carried Forward			R	
	Section No. 3 Bill No. 2				
	Concrete, Formwork and Reinforcement				

	Brought Forward	i		R	
	Smooth formwork to soffits				
7	Vanity slabs, cupboard slabs, cover slabs, etc. propped up not exceeding 150mm high	m2	12		
	REINFORCEMENT (PROVISIONAL)				
	(CPAP formula work group no. 114)				
	Fabric reinforcement				
8	Type 193 fabric reinforcement in concrete surface beds, slabs, etc	m2	120		
	Carried Forward to Summary of Section No. 3			R	
	Section No. 3 Bill No. 2				
	Concrete, Formwork and Reinforcement				

Item No			Quantity	Rate	Amount	
NO	BILL NO. 3					
	MASONRY					
	NOTE: Unless otherwise stated herein, all items in this bill shall be deemed to fall into Work Group No. 116 for CPAP formula purposes.					
	SUPPLEMENTARY PREAMBLES					
	<u>Brickwork</u>					
	Sizes in descriptions					
	Where sizes in descriptions are given in brick units, "one brick" shall represent the length and "half brick" the width of a brick.					
	Face bricks					
	Bricks shall be ordered timeously to obtain uniformity in size and colour					
	Pointing					
	Descriptions of recessed pointing to fair face brickwork and face brickwork shall be deemed to include square recessed, hollow recessed, weathered pointing, etc					
	SUPERSTRUCTURE					
	Brickwork of NFP bricks in class II mortar					
1	Half brick walls	m2	115			
2	Half brick walls in beamfilling	m2	19			
3	One brick walls	m2	116			
	Brickwork reinforcement					
4	75mm Wide reinforcement built in horizontally	m	671			
5	150mm Wide reinforcement built in horizontally	m	505			
						_
	Carried Forward			R		
	Section No. 3 Bill No. 3 Masonry					

	Brought Forward			R		
	Prestressed fabricated lintels					
6	110 x 75mm Lintels in lengths not exceeding 3m	m	38			
7	110 x 75mm Lintels in lengths exceeding 4,5m and not exceeding 6m	m	5			
	Galvanised hoop iron cramps, ties, etc					
8	30 x 1,6mm Roof tie 1,5m long with one end fixed to timber and other end built into brickwork	No	24			
	NUTEC-CEMENT WINDOW SILLS					
	Natural grey sills in single lengths bedded in class I mortar including metal fixing lugs etc					
9	15 x 175mm Wide window sills set sloping and slightly projected	m	16			
	PAVING (Provisional)					
	60mm Standard grey interlocking paving blocks laid with butt joints on 25mm thick river sand bed with sand swept into joints					
10	Paving in herringbone bond in aprons	m2	55			
	Carried Forward to Summary of Section No. 3			R		
	Section No. 3 Bill No. 3 Masonry					
		I	I		ıı I	

Item No			Quantity	Rate	Amount
	BILL NO. 4				
	WATERPROOFING				
	NOTE: Unless otherwise stated herein, all items in this bill shall be deemed to fall into Work Group No. 120 for CPAP formula purposes.				
	DAMP-PROOFING OF WALLS AND FLOORS				
	One layer of 375 micron "Consol Plastics Brikgrip DPC" embossed damp proof course				
1	In walls	m2	20		
	One layer of 250 micron "Consol Plastics Gunplas USB Green" waterproof sheeting sealed at laps with "Gunplas Pressure Sensitive Tape"				
2	Under surface beds	m2	108		
	Carried Forward to Summary of Section No. 3			R	
	Section No. 3				
	Bill No. 4 Waterproofing				

Item No			Quantity	Rate	Amount	
	BILL NO. 5					
	ROOF COVERINGS ETC					
	NOTE: Unless otherwise stated herein, all items in this bill shall be deemed to fall into Work Group No. 124 for CPAP formula purposes.					
	PROFILED METAL SHEETING AND ACCESSORIES					
	0,6mm "IBR" Z275 spelter galvanised troughed sheet steel with "globalcoat" finish on one side in single lengths fixed to timber purlins and 0,6mm galvanised sheet steel accessories with "globalcoat" finish on one side					
1	Roof covering with pitch not exceeding 25 degrees	m2	156			
2	Ridge capping 462mm girth	m	7			
3	Hip flashings 308mm girth	m	21			
4	Cover flashing 154mm girth	m	7			
	ROOF AND WALL INSULATION					
	"Sisalation FR430" fire retardant aluminium foil insulation					
5	Insulation laid taut over purlins (at approximately 1 200mm centres) and fixed concurrent with roof covering including galvanised steel straining wires	m2	146			
	Carried Forward to Summary of Section No. 3			R		_
	Section No. 3					=
	Bill No. 5 Roof Coverings, etc					

	Quantity	Rate	Amoui
BILL NO. 6			
CARPENTRY AND JOINERY			
NOTE: Unless otherwise stated herein, all items in this bill shall be deemed to fall into Work Group No. 126 for CPAP formula purposes.			
SUPPLEMENTARY PREAMBLES			
Particle board:			
Particle board shall comply with the following specifications:			
a) SABS 1300 Particle board: exterior and flooring type			
b) SABS 1301 Particle board: interior type			
Joinery:			
Descriptions of frames shall be deemed to include frames, transomes, mullions, rails, etc			
Descriptions of hardwood joinery shall be deemed to include pelleting of bolt holes			
<u>Fixing</u>			
Items described as "nailed" shall be deemed to be fixed with hardened steel nails or shot pins to brickwork or concrete			
Decorative laminate finish:			
Laminate finish shall be glued under pressure. Edge strips shall be butt jointed at junctions with adjacent similar finish			
Carried Forward		R	
Section No. 3			
Bill No. 6 Carpentry and Joinery			

Brought Forward			R	
ROOFS, ETC				
Plate nailed timber roof truss construction				
The following is applicable in respect of roof trusses:				
Trusses are at maximum 1,10m centres				
Roof covering is galvanised "IBR" roof sheeting with "Globalcoat" finish on one side on 50 x 75mm purlins at 1,1m maximum centres.				
Ceilings are generally 6,4mm gypsum plasterboard on 38 x 38mm brandering.				
All timber to be sawn softwood in accordance with V4 or M4 as defined in SABS 563 or SABS 1245.				
Metal connector plates shall have a minimum yield strength of 228 MPa and a minimum ultimate tensile strength of 330 Mpa with hot-dip galvanised finish.				
All joints to be close fitted butt joints.				
Trusses shall be designed by a registered supplier of prefabricated trusses who shall issue an Engineers Certificate upon completion of the installation.				
The dimensions in the descriptions of the trusses are nominal and actual measurements are to be obtained on site before design or fabricaton commences.				
Tenderers must study the roof plan and sections as attached to the back of these bills of quantities (refer drawing No.'s ADMIN 001 to 004) and must obtain prices from a qualified and registered roof truss supplier as no claims in this regard will be entertained.				
Sawn softwood				
38 x 114mm Wall plates	m	51		
				_
Carried Forward			R	
Section No. 3 Bill No. 6 Carpentry and Joinery				

	Brought Forward			R	
2	Design, manufacture and deliver on site, plate nailed roof truss construction to Office Block, size 11 350 x 11 150mm overall on plan consisting of eleven mono pitched trusses, each truss 5 385 x 1800mm high overall with 600mm eaves overhang projecting one side, including all necessary purlins, runners, bracing and cross bracing (wall plates elsewhere)	No	1		
3	Design, manufacture and deliver on site, plate nailed roof truss construction to Office Block, size 11 350 x 11 150mm overall on plan consisting of six double pitched trusses, each truss 11 350 x 1800mm high overall with 600mm eaves overhang projecting both sides, including all necessary purlins, runners, bracing and cross bracing (wall plates elsewhere)	No	1		
4	Take delivery, temporary store, hoist in position and				
	erect plate nailed timber roof trusses, purlins, gangboarding, temporary and permanent bracing, etc (measured on slope of roof)	m2	146		
	Sundries				
5	Two coats creosote on sawn timbers	m2	27		
	Carried Forward			R	
	Section No. 3 Bill No. 6 Carpentry and Joinery				

	Brought Forward			R	
	EAVES, VERGES, ETC				
	"Everite Flexit" pressed nutec-cement				
6	12 x 225mm Fascias and barge boards including galvanised steel H-profile jointing strips	m	56		
	DOORS ETC				
	Wrought hardwood flushback doors with sapele veneer hung to steel frames				
7	44mm "TDM" Framed and ledged double door 1 678 x 2 032mm high with rebated meeting stiles and 500 x 1 395mm high glass panel in each leaf rebated all round including glazing beads on one side	No	3		
8	44mm "TDM" Framed and ledged door 813 x 2 032mm high	No	1		
	Semi-solid flush doors with sapele veneer on both sides hung to steel frames				
9	44mm Door 813 x 2 032mm high	No	9		
	<u>FITTINGS</u>				
	<u>General</u>				
	The following cupboard fittings have been measured as complete units i.e. the components of the units have not been separately measured. The descriptions, therefore, of such units shall be deemed to include all components, assembling, housing, notching, glueing, blocking, planting on and screwing with countersunk screws, edge strips, decorative plastic finish, glass, ironmongery, metalwork, paint or varnish finishes, etc (refer Architect's drawings as attached to the back of these Bills of Quantities)				
	Fittings to Administration Building				
10	Reception counter cupboard 3 921 maximum on centre line x 600mm wide x 900mm high overall comprising tops, bottoms, sides, divisions, shelves, backs, filler panels, doors, ironmongery, finishes, etc all as per architect drawing No. ADMIN 006 (Reception)	No	1		
	Carried Forward			R	
	Section No. 3 Bill No. 6 Carpentry and Joinery				

	Brought Forward	ı [R	
11	Floor cupboard 2 400 x 551 x 2 010mm high overall comprising tops, bottoms, sides, divisions, shelves, backs, filler panels, doors, ironmongery, finishes, etc all as per architect drawing No. ADMIN 007 (Office 2 and Principal Office)	No	1		
12	L-shaped cashier's work station 2 640 x 600 x 900mm high overall comprising tops, bottoms, sides, divisions, shelves, backs, filler panels, brackets, ironmongery, finishes, etc all as per architect specification and drawing No. ADMIN 008 (Cashier)	No	1		
		NO	'		
13	Sink floor cupboard 2 700 x 600 x 902mm high with 1 350 x 535mm sink basin comprising, bottoms, sides, divisions, shelves, backs, doors, etc (concrete slab and sink elsewhere measured)as per architect drawings No. ADMIN 010 (Kitchenette)	No	1		
14	Wall cupboard size 2 700 x 332 x 540mm high overall comprising tops, bottoms, sides, divisions, shelves, backs, doors, etc as per architect drawings No. ADMIN 010 (Kitchenette)				
		No	1		
15	Shelving 350mm wide made up of 25mm thick hardwood top and 250 x 250mm high triangular mild steel brackets bolted to wall complete with paint and varnish as per architect drawing No. ADMIN 011				
	(Stores)	m	20		
	Carried Forward to Summary of Section No. 3			R	
	Section No. 3				
	Bill No. 6 Carpentry and Joinery				

Item No			Quantity	Rate	Amount	
	BILL NO. 7			is a second of the second of t		
	CEILINGS, PARTITIONS AND ACCESS FLOORING					
	NOTE: Unless otherwise stated herein, all items in this bill shall be deemed to fall into Work Group No. 129 for CPAP formula purposes.					
	SUPPLEMENTARY PREAMBLES					
	<u>Descriptions</u>					
	Items described as "nailed" shall be deemed to be fixed with hardened steel nails or pins or shot pinned to brickwork or concrete.					
	Items described as "plugged" shall be deemed to include screwing to fibre, plastic or metal plugs at not exceeding 600mm centres, and where described as "bolted" the bolts have been given elsewhere.					
	CEILINGS ETC					
	"Aerolite" insulation					
1	75mm Insulation closely fitted and laid on top of brandering between roof timbers etc	m2	108			
	NAILED UP CEILINGS					
	6,4mm "Rhino" gypsum plasterboard with H-type pressed steel jointing strips					
2	Ceilings including 38 x 38mm sawn softwood brandering at 400mm centres	m2	108			
3	Extra over ceiling for 650 x 650mm trap door of 38 x 50mm wrought softwood rebated framing with one 38 x 50mm sawn softwood cross brander covered with ceiling board and fitted flush in opening	No	2			
	"Rhino" gypsum plasterboard cornices					
4	75mm Coved cornices	m	127			
	Carried Forward to Summary of Section No. 3			R		
	Section No. 3 Bill No. 7 Ceilings, Partitions and Access Flooring					

Item No		Quantity	Rate	Amount
	BILL NO. 8			
	FLOOR COVERINGS, PLASTIC LININGS, ETC			
	NOTE: Unless otherwise stated herein, all items in this bill shall be deemed to fall into Work Group No. 130 for CPAP formula purposes.			
	FLOOR COVERINGS			
	300 x 300 x 2,5mm "Marley" or other equal and approved semi-flexible vinyl tiles			
1	On floors m2			
	POLISH, SEALERS, ETC			
	Two coats wax polish			
2	On vinyl floors m2			
	Carried Forward to Summary of Section No. 3		R	
	Section No. 3			
	Bill No. 8 Floor Coverings			

Item No		Quantity	Rate	Amount
	BILL NO. 9			
	IRONMONGERY			
	NOTE: Unless otherwise stated herein, all items in this bill shall be deemed to fall into Work Group No. 132 for CPAP formula purposes.			
	SUPPLEMENTARY PREAMBLES			
	Finishes to ironmongery			
	Where applicable finishes to ironmongery are indicated by suffixes in accordance with the following list:			
	BS Satin bronze lacquered CH Chromium plated SC Satin chromium plated SE Silver enamelled GE Grey enamelled AS Anodised silver AB Anodised bronze AG Anodised gold ABL Anodised black PB Polished brass PL Polished and lacquered PT Epoxy coated SD Sanded			
	HINGES, BOLTS, ETC.			
1	200mm Brass barrel bolt with keep fixed to metal N	o 15		
	<u>"Union"</u>			
2	"CZ80941SC" WC indicator bolt with keep fixed to metal N	o 4		
	LOCKS			
	"Union"			
3	"CZ682-24/2247-78" or other similar and approved four lever lockset with striking plate fixed to metal or timber N	o 4		
	Carried Forward		R	
	Section No. 3 Bill No. 9 Ironmongery			

	Brought Forward			R		
	"Mazac Tarpon"					
4	"952/2L" or other equal and approved two lever lockset with chrome plated finish with striking plate fixed to metal	No	4			
	<u>HANDLES</u>					
	"Dorma"					
5	32 x 515mm Stainless steel "D" straight back-to-back pull handles	No	12			
	DOOR CLOSERS					
	"Dorma"					
6	"TS83DC BC/BC/EN2-6" door closer with bracket fixed to metal	No	3			
	LETTERS, NAMEPLATES, ETC					
7	60 x 3mm Thick perspex plate with two 40mm high engraved and painted numerals	No	3			
	<u>"Union"</u>					
8	"AL5066-06ASE06" 152 x 152mm anodised aluminium plate with fire extinguisher pictogram	No	1			
	PUSH PLATES AND KICKING PLATES					
	"Dorma"					
9	2mm Satin finished stainless steel kickplate plate size 800 x 300 high fixed to timber	No	1			
	"BATHROOM FITTINGS"					
10	19mm Diameter chromium plated towel rail 600mm long including end brackets plugged	No	3			
	"Stiebel Eltron"					
11	"PTFS-S" Paper towel dispenser plugged	No	2			
12	"SDSS" Soap dispenser plugged	No	2			
	Carried Forward			R		
	Section No. 3 Bill No. 9					
	Ironmongery					
		l				l

	Brought Forward	i		R	
	"Nampak"				
13	"TR2" lockable toilet roll holder plugged	No	4		
	SUNDRIES				
	<u>"Union"</u>				
14	"AL8730AS" door stop plugged	No	4		
	Carried Forward to Summary of Section No. 3			R	
	Section No. 3				
	Bill No. 9 Ironmongery				

Item No			Quantity	Rate	Amount	
	BILL NO. 10					
	METALWORK					
	NOTE: Unless otherwise stated herein, all items in this bill shall be deemed to fall into Work Group No. 136 for CPAP formula purposes.					
	SUPPLEMENTARY PREAMBLES					
	<u>Descriptions</u>					
	Descriptions of bolts shall be deemed to include nuts and washers.					
	Descriptions of expansion anchors and bolts and chemical anchors and bolts shall be deemed to include nuts, washers and mortices in brickwork or concrete.					
	Metalwork described as "holed for bolt(s)" shall be deemed to exclude the bolts unless otherwise described.					
	WELDED SCREENS, GATES, ETC					
	Steel gates and frames					
1	Single gate and frame for opening 1 626 x 2 032mm high overall, the outer frame of 45 x 45 x 3mm hollow section bolted to wall with and including eight 70mm M80 expansion bolts and the gate 1 626 x 2 032mm high of 40 x 60 x 2mm hollow section frame with two 40 x 6mm flat section horizontal rails filled in with 20mm diameter vertical rails at 110mm centres fitted with one and a half pairs of suitable pin hinges welded to hollow section steel frame, complete with and including three lever lock	No	1			
	PRESSED STEEL DOOR FRAMES					
	1,2mm Double rebated frames suitable for half brick walls					
2	Frame for door 1 678 x 2 032mm high	No	2			
	Carried Forward			R		
	Section No. 3					
	Bill No. 10 Metalwork					

	Brought Forward			R	
	1,2mm Double rebated frames suitable for one brick walls				
3	Frame for door 813 x 2 032mm high	No	9		
4	Frame for double door 1 678 x 2 032mm high	No	1		
	STEEL WINDOWS, DOORS, ETC				
	Standard steel type top hung residential open out windows with 12mm square steel rods at 100mm c/c between burgler bars				
5	Window type G1, 533 x 359mm high	No	4		
6	Window type SG4, 1 511 x 949mm high	No	8		
7	Window type ES12H, 2 489 x 654mm high	No	1		
	Carried Forward to Summary of Section No. 3			R	
	Section No. 3			-	
	Bill No. 10 Metalwork				

Item No		Quantity	Rate	Amount
	BILL NO. 11			
	PLASTERING			
	NOTE: Unless otherwise stated herein, all items in this bill shall be deemed to fall into Work Group No. 142 for CPAP formula purposes.			
	<u>SCREEDS</u>			
	1:4 Cement plaster screeds wood floated on concrete			
1	35mm Thick on floors and landings m2	108		
	INTERNAL PLASTER			
	Cement plaster on brickwork			
2	On walls m2	352		
3	On narrow widths m2	35		
	EXTERNAL PLASTER			
	Cement plaster on brickwork			
4	On walls m2	101		
5	On narrow widths m2	10		
	CORNER PROTECTORS, DIVIDING STRIPS, ETC			
6	3 x 32mm Flat section brass dividing strips between different floor finishes	6		
	Carried Forward to Summary of Section No. 3		R	
	Section No. 3 Bill No. 11 Plastering			

Item No			Quantity	Rate	Amount
	BILL NO. 12				
	<u>TILING</u>				
	NOTE: Unless otherwise stated herein, all items in this bill shall be deemed to fall into Work Group No. 144 for CPAP formula purposes.				
	SUPPLEMENTARY PREAMBLES				
	<u>Descriptions</u>				
	Unless described as "fixed with adhesive to plaster (plaster elsewhere)" descriptions of tiling on brick or concrete walls, columns, etc shall be deemed to include 1:4 cement plaster backing and descriptions of tiling on concrete floors etc shall be deemed to include 1:3 plaster bedding.				
	WALL TILING				
	200 x 200 x 6mm "Cercisa Tinte Unite" White glazed ceramic tiles fixed with adhesive to plaster (plaster elsewhere)				
1	On walls	m2	114		
2	On walls in isolated panels, splashbacks, etc	m2	3		
	FLOOR TILING				
	300 x 300mm x 10mm Ceramic tiles (PC Amount R100.00/m2) fixed with adhesive to bedding (bedding elsewhere) and flush pointed with tinted waterproof jointing compound				
3	On floors and landings	m2	108		
4	Skirting 150mm high	m	115		
	Carried Forward to Summary of Section No. 3			R	
	Section No. 3				
	Bill No. 12 Tiling				

	Quantity	Rate	Amount
BILL NO. 13			
PLUMBING AND DRAINAGE (PROVISIONAL)			
NOTE: Unless otherwise stated herein, all items in this bill shall be deemed to fall into Work Group No. 148 for CPAP formula purposes.			
"Polycop" polypropylene pipes:			
Polypropylene pipes 54mm diameter and under shall be seamless copper coloured class 16 pipes jointed with "Fast-fuse" heat welded thermoplastic or brass compression fittings as designed for use with copper pipes as stated			
Pipes shall be firmly fixed to walls etc with coloured nylon snap-in pipe clips with provision for accommodating thermal movement and jointed and fixed strictly in accordance with the manufacturer's instructions			
All pipe diameters are nominal external			
Concrete pipes:			
Pipes shall be jointed with ogee joints with rubber collars or socket and spigot joints with rubber rings			
uPVC pipes and fittings:			
Soil, waste and vent pipes and fittings shall be solvent weld jointed			
uPVC pressure pipes and fittings:			
Pipes for water supply shall be of the class stated			
Pipes of 40mm diameter and smaller shall be plain ended with solvent welded uPVC loose sockets and fittings			
Pipes of 50mm diameter and greater shall have sockets and spigots with push in type integral rubber ring joints. Bends shall be uPVC and all other fittings shall be cast iron, all with similar push-in type joints			
Carried Forward		R	
Section No. 3 Bill No. 13 Blumbing and Prainage (Provisional)			
Plumbing and Drainage (Provisional)			

1	Brought Forward	R	
Copper pipes:		1	
Pipes shall be hard drawn and half-had class stated. Class 0 (thin walled hard shall not be bent. Class 1 (thin walled 2 (half-hard) and class 3 (heavy walled shall only be bent with benders with it formers. Fittings to copper waste, ver pipes, capillary solder fittings and common shall be "Cobra Watertech" type. Cap shall comply with ISO 2016. Only cor shall be used in walls or in ground	d drawn) pipes d half-hard), class d half-hard) pipes nner and outer nt and anti-syphon npression fittings billary solder fittings		
Fixing of pipes			
Unless specifically otherwise stated, or pipes shall be deemed to include fixin casting in, building in or suspending no below suspension level	g to walls etc,		
Reducing fittings			
Where fittings have reducing ends or described as "reducing". In the case diameters not exceeding 60mm only the branch size is given. Should the controther fittings and bushes or reducers the understanding that no claim in this entertained. In the case of pipes with exceeding 60mm all sizes are given a extra bushes, reducers, etc will be entertained.	of pipes with he largest end or actor wish to use he may do so on s regard will be diameters nd no claim for		
Wire gratings			
Descriptions of gutter outlets etc shall include wire balloon gratings	be deemed to		
Excavations			
No claim for rock excavation will be en the contractor has timeously notified the surveyor thereof prior to backfilling			
"Soft rock" and "hard rock" shall be as "Earthworks"	s defined in		
	Carried Forward	R	
Section No. 3 Bill No. 13 Plumbing and Drainage (Provisional)	Callida i Ciwalu		

Brought Forward			R	
Laying, backfilling, bedding, etc. of pipes				
Pipes shall be laid and bedded and trenches shall be carefully backfilled in accordance with manufacturers' instructions				
Where no manufacturers' instructions exist pipes shall be laid in accordance with clauses 5.1 and 5.2 of each of the following: SABS 1200 L: Medium-pressure pipelines LD: Sewers LE: Stormwater drainage Pipe trenches etc shall be backfilled in accordance with clauses 3, 5.5, 5.6, 5.7 and 7 of SABS 1200 DB: Earthworks (Pipe trenches) Pipes shall be bedded in accordance with clauses 3.1 to 3.4.1, 5.1 to 5.3 and 7 of SABS 1200 LB: Bedding (Pipes). Unless otherwise described bedding of rigid pipes shall be class B bedding				
Flush pans				
Flush pans shall have straight or side outlets and "P" or "S" traps as necessary				
Stainless steelbasins, sinks, wash troughs, urinals, etc.				
Units shall have standard aprons on all exposed edges and tiling keys against walls where applicable				
Waste unions				
Descriptions of waste unions shall be deemed to include rubber or vulcanite plugs and chains fixed to fittings				
RAINWATER DISPOSAL				
0.8mm seamless aluminium gutters and down pipes				
75 x 75mm Eaves gutters	m	46		
Extra over 200 x 150mm eaves gutter for angle	No	6		
Extra over 200 x 150mm eaves gutter for outlet for 125mm pipe	No	6		
75mm Diameter rainwater pipes	m	18		
Carried Forward			R	
Section No. 3 Bill No. 13				
Plumbing and Drainage (Provisional)				

	Brought Forward			R	1
5	Extra over 125mm diameter rainwater pipe for shoe	No	6		
6	Extra over 125mm diameter rainwater pipe for bend	No	6		
7	Extra over 125mm diameter rainwater pipe for eaves or plinth offset 600mm projection	No	6		
	SANITARY FITTINGS				
	"Plumbcrazy" Grade 304 stainless steel				
8	"DEB Code 304-11A" Double bowl sink and drainer 1 350 x 535mm wide including fixing complete to walls with (Code 7880) mild steel brackets bolted with expansion bolts	No	1		
	<u>"Vaal"</u>				
9	455 x 290mm "Bantam" cloakroom hand basin	No	5		
10	"Klip" low level wc suite comprising pan with double flap heavy duty plastic seat and matching 9 litre cistern with flush pipe	No	4		
11	415 x 315 x 275mm "Flatback" wall hung bowl urinal with spreader (flushing valve elsewhere)	No	4		
	WASTE UNIONS, ETC				
	"Cobra Watertech"				
12	32mm "301CP" Basin waste union	No	5		
13	40mm "316CP" Bath or sink waste union	No	1		
	TRAPS, ETC				
	"Marley"				
14	32 x 50mm Deep seal "P" or "S" trap	No	5		
	"Cobra Watertech"				
15	32mm "345/50CP" bottle trap	No	5		
16	40mm "365/50CP" bottle trap	No	1		
	Carried Forward			R	
	Section No. 3 Bill No. 13 Plumbing and Drainage (Provisional)				

	Brought Forward			R	
17	40 x 300mm Sink combination for double bowl with deepseal "P" trap	No	1		
	TAPS, VALVES, ETC				
	Brass				
18	15mm Fullway gate valve	No	1		
19	22mm Fullway gate valve	No	1		
20	22mm Bibcock with hose union	No	1		
	"Cobra Watertech"				
21	15mm "059CP" Extension piece with sliding wall flange	No	2		
22	15mm "128CP Carina" underwall pattern stopcock	No	2		
23	15mm "166/041CP Carina" wall type sink mixer	No	1		
24	15mm "505-21CP" elbow action pillarcock	No	2		
25	15mm 111CP Pillartap	No	2		
26	FJ6.000 "Flushmaster Junior" urinal flush valve	No	4		
27	15mm "232/350CP" angle regulating valve with no service connection	No	4		
28	PB1.10RB vacuum breaker	No	4		
29	PA1.1RB "Kwikflo" 400 kPa pressure reducing valve	No	2		
	SANITARY PLUMBING				
	uPVC pipes				
30	50mm Pipes	m	27		
31	110mm Pipes	m	12		
	Extra over uPVC pipes for fittings				
32	50mm Bend	No	12		
33	50mm Junction	No	5		
	Carried Forward			R	
	Section No. 3 Bill No. 13 Plumbing and Drainage (Provisional)				

	Brought Forwar	rd		R	
34	110mm Pan connector	No	4		
35	50mm Access bend	No	9		
36	110mm Access bend	No	4		
37	50mm Access junction	No	5		
38	110mm Access Junction	No	4		
39	110mm Access bend with anti-syphon horn	No	2		
40	50mm Access reducing junction	No	2		
41	50mm "GI Two-way" vent valve	No	2		
	<u>Sundries</u>				
42	Testing waste pipe system		Item		
	WATER SUPPLIES				
	Class 0 copper pipes				
43	15mm Pipes	m	13		
44	15mm Pipes chased into brick walls	m	15		
45	22mm Pipes	m	13		
46	22mm Pipes chased into brick walls	m	15		
	Extra over class 0 copper pipes for capillary fittings				
47	15mm Fittings	No	20		
48	22mm Fittings	No	15		
	Copper overflow and service pipes				
49	15mm Service pipe 500mm girth	No	5		
	ELECTRIC WATER HEATERS				
	Carried Forward			R	
	Section No. 3 Bill No. 13				
	Plumbing and Drainage (Provisional)				
	g and Dramago (Froviolonal)				

	Brought Forward			R	
	"Kwikot"				
50	150 Litre horizontal electric water heater in roof including standard galvanised sheet iron drip tray with overflow pipe to external wall	No	1		
	TESTING				
51	Testing water pipe system		Item		
	FIRE APPLIANCES ETC				
	"Chubb"				
52	4,5kg Carbon dioxide fire extinguisher complete with 520 x 115 x 22mm thick timber backboard plugged to wall and varnished	No	1		
	Carried Forward to Summary of Section No. 3			R	
	Section No. 3 Bill No. 13 Plumbing and Drainage (Provisional)				

Item No		Quantity	Rate	Amount
	BILL NO. 14			
	GLAZING			
	NOTE: Unless otherwise stated herein, all items in this bill shall be deemed to fall into Work Group No. 150 for CPAP formula purposes.			
	GLAZING TO STEEL WITH PUTTY			
	6,38mm Normal strength clear laminated safety glass			
1	Panes exceeding 0,1 and not exceeding 0,5m2 m2	1		
	8,38mm Normal strength clear laminated safety glass			
2	Panes exceeding 0,5m2 and not exceeding 2m2 m2	13		
	TOPS, SHELVES, DOORS, MIRRORS, ETC			
	6mm Silvered float glass copper backed mirrors with polished edges holed for and fixed with chromium plated dome capped mirror screws with rubber buffers to plugs in brickwork or concrete			
3	Mirror 600 x 900mm high with four screws No	1		
4	Mirror 1 383 x 780mm high with four screws No	1		
	Carried Forward to Summary of Section No. 3		R	
	Section No. 3 Bill No. 14 Glazing			

Item No			Quantity	Rate	Amount
	BILL NO. 15				
	<u>PAINTWORK</u>				
	NOTE: Unless otherwise stated herein, all items in this bill shall be deemed to fall into Work Group No. 152 for CPAP formula purposes.				
	ON FLOATED PLASTER				
	One coat alkali resistant primer, one undercoat and two coats eggshell enamel paint				
1	On internal walls	m2	387		
	One coat alkali resistant primer, one undercoat and two coats interior quality PVA emulsion paint				
2	On external walls	m2	111		
	ON PLASTERBOARD				
	One coat primer and two coats interior quality PVA emulsion paint				
3	On ceilings and cornices	m2	108		
	ON FIBRE-CEMENT				
	One coat primer and two coats interior quality acrylic PVA paint				
4	On internal window sills not exceeding 300mm wide or girth	m	16		
	One coat primer and two coats exterior quality PVA emulsion paint				
5	On external window sills not exceeding 300mm wide or girth	m	16		
6	On fascias and bargeboards	m2	13		
	ON METAL				
	Carried Forward			R	
	Section No. 3 Bill No. 15 Paintwork				

	Brought Forward			R	1
	Spot priming defects in pre primed surfaces with zinc chromate primer and applying one undercoat and two coat high gloss enamel paint on steel				
7	On door frames	m2	14		
8	On windows with burglar bars	m2	28		
9	On gates, grilles, burglar screens, balustrades, etc (both sides measured over the full flat area)	m2	7		
	ON WOOD				
	One coat wood primer, one coat undercoat and one coat polyurethane gloss enamel paint				
10	On doors	m2	30		
	Three coats polyurethane semi-gloss varnish				
11	On doors	m2	20		
	Carried Forward to Summary of Section No. 3			R	
	Section No. 3				
	Bill No. 15 Paintwork				

	SECTION SUMMARY - Administration block			
Bill No		Page No		Amount
1	Foundations (Provisional)	64		
2	Concrete, Formwork and Reinforcement	67		
3	Masonry	69		
4	Waterproofing	70		
5	Roof Coverings, etc	71		
6	Carpentry and Joinery	76		
7	Ceilings, Partitions and Access Flooring	77		
8	Floor Coverings	78		
9	Ironmongery	81		
10	Metalwork	83		
11	Plastering	84		
12	Tiling	85		
13	Plumbing and Drainage (Provisional)	92		
14	Glazing	93		
15	Paintwork	95		
	Carried to Final Summary		R	
	Section No. 3			
	Codion No. O			

Item No			Quantity	Rate	Amount	
	SECTION 12					
	GUARD HOUSE/REFUSE					
	BILL NO. 1					
	FOUNDATIONS (PROVISIONAL)					
	NOTE: Unless otherwise stated herein, all items in this bill shall be deemed to fall into Work Group No. 104 for CPAP formula purposes					
	SUPPLEMENTARY PREAMBLES					
	Nature of ground					
	The nature of the ground is assumed to be loose sandy material, therefore "earth", but possibly interspersed with "hard rock" or "soft rock"					
	Carting away of excavated material					
	Descriptions of carting away of excavated material shall be deemed to include loading excavated material onto trucks directly from the excavations or, alternatively, from stock piles situated on the building site					
	<u>EARTHWORKS</u>					
	SITE CLEARANCE ETC					
	Site clearance					
1	Digging up and removing rubbish, debris, vegetation, hedges, shrubs and trees not exceeding 200mm girth, bush, etc	m2	36			
2	Stripping average 150mm thick layer of top soil and stockpiling on site	m2	36			
	EXCAVATION, FILLING, ETC					
	Excavation in earth not exceeding 2m deep					
3	Reduced levels under floors	m3	11			
						_
	Carried Forward			R		
	Section No. 4 Bill No. 1 Foundations (Provisional)					

	Brought Forward			R	
4	Trenches	m3	15		
	Extra over trench and hole excavations in earth for excavation in				
5	Soft rock	m3	1		
6	Hard rock	m3	1		
	Extra over all excavations for carting away				
7	Surplus material from excavations and/or stock piles on site to a dumping site to be located by the contractor	m3	11		
	Risk of collapse of excavations				
8	Sides of trench and hole excavations not exceeding 1,5m deep	m2	35		
	Keeping excavations free of water				
9	Keeping excavations free of all water other than subterranean water		Item		
	Earth filling obtained from the excavations and/or prescribed stock piles on site compacted to 95% Mod AASHTO density				
10	Under floors, steps, pavings, etc	m3	8		
11	Backfilling to trenches, holes, etc	m3	7		
	Earth filling supplied by the contractor compacted to 95% Mod AASHTO density				
12	Under floors, steps, pavings, etc	m3	11		
	Coarse river sand filling supplied by the contractor				
13	Under floors etc	m3	2		
	SOIL POISONING				
	Soil insectiside				
14	Under floors etc including forming and poisoning shallow furrows against foundation walls etc, filling in furrows and ramming	m2	11		
	Carried Forward			R	
	Section No. 4 Bill No. 1 Foundations (Provisional)				

	Brought	Forward		R	
15	To bottoms and sides of trenches	m2	49		
	Carried Fo	nuord			—
		waru		R	
	Section No. 4 Bill No. 1				
	Foundations (Provisional)				

	Brought Forward	d		R	
	CONCRETE				
	(CPAP FORMULA WORK GROUP NO. 110)				
	UNREINFORCED CONCRETE CAST AGAINST EXCAVATED SURFACES				
	15MPa/19mm concrete				
16	Surface blinding under footings and bases	m3	1		
	25MPa/19mm concrete				
17	Strip footings	m3	4		
	REINFORCEMENT				
	(CPAP FORMULA WORK GROUP NO. 114)				
	High tensile steel reinforcement to structural concrete work				
18	10mm Diameter bars stirrups	t	0.05		
19	12mm Diameter bars	t	0.07		
	BRICKWORK				
	(CPAP FORMULA WORK GROUP NO. 116)				
	Brickwork of NFX bricks (14 MPa nominal compressive strength) in class I mortar				
20	One brick walls	m2	14		
21	Half brick walls	m2	4		
	Brickwork reinforcement				
22	75mm Wide reinforcement built in horizontally	m	18		
23	150mm Wide reinforcement built in horizontally	m	63		
	Carried Forward to Summary of Section No. 4			R	
	Section No. 4				=
	Bill No. 1 Foundations (Provisional)				

	Quantity	Rate	Amount	
ILL NO. 2				
ONCRETE, FORMWORK AND EINFORCEMENT				
OTE : nless otherwise stated herein, all items in this bill shall e deemed to fall into Work Group No. 110 for CPAP rmula purposes				
UPPLEMENTARY PREAMBLES				
ost of tests				
the costs of making, storing and testing of concrete test labes as required under clause 7 "Tests" of SABS 1200 shall include the cost of providing cube moulds ecessary for the purpose, for testing costs and for abmitting reports on the tests to the Principal Agent. The testing shall be undertaken by an independent firm a institution nominated by the contractor to the approval of the Principal Agent. (Test cubes are measured eparately)				
<u>ormwork</u>				
escription of formwork shall be deemed to include use and waste only (except where described as "left in" or permanent"), for fitting together in the required forms, edging, plumbing and fixing to true angles and surfaces as necessary to ensure easy release during ripping and for reconditioning as necessary before resee				
ne vertical strutting shall be carried down to such construction as is sufficiently strong to afford the equired support without damage and shall remain in osition until the newly constructed work is able to upport itself.				
ormworks to soffits of solid etc shall be deemed to be abs not exceeding 250mm thick unless otherwise escribed				
Carried Forward		R		
ection No. 4 Il No. 2				
oncrete, Formwork and Reinforcement				
Cher L C na ean e c en ears no coa cee	Concrete, Formwork and EINFORCEMENT DTE: Illess otherwise stated herein, all items in this bill shall a deemed to fall into Work Group No. 110 for CPAP mula purposes JPPLEMENTARY PREAMBLES Dest of tests The costs of making, storing and testing of concrete test bes as required under clause 7 "Tests" of SABS 1200 shall include the cost of providing cube moulds cossary for the purpose, for testing costs and for briting reports on the tests to the Principal Agent, the testing shall be undertaken by an independent firm institution nominated by the contractor to the approval the Principal Agent. (Test cubes are measured parately) Dommork The secription of formwork shall be deemed to include use and waste only (except where described as "left in" or ermanent"), for fitting together in the required forms, adding, plumbing and fixing to true angles and rfaces as necessary to ensure easy release during ripping and for reconditioning as necessary before release to evertical strutting shall be carried down to such instruction as is sufficiently strong to afford the quired support without damage and shall remain in sistion until the newly constructed work is able to proport itself. Dommorks to soffits of solid etc shall be deemed to be absenced as solid as solid etc shall be deemed to be absenced as solid as solid etc shall be deemed to be absenced as solid etc shall be deemed to be absenced as solid etc shall be deemed to be absenced as solid etc shall be deemed to be absenced as solid etc shall be deemed to be absenced as solid etc shall be deemed to be absenced as solid etc shall be deemed to be absenced as solid etc shall be deemed to be absenced as solid etc.	CONCRETE, FORMWORK AND EINFORCEMENT DIE: Illess otherwise stated herein, all items in this bill shall is deemed to fall into Work Group No. 110 for CPAP mula purposes JPPLEMENTARY PREAMBLES Det of tests In e costs of making, storing and testing of concrete test bees as required under clause 7 "Tests" of SABS 1200 shall include the cost of providing cube moulds coessary for the purpose, for testing costs and for britting reports on the tests to the Principal Agent. The testing shall be undertaken by an independent firm institution nominated by the contractor to the approval the Principal Agent. (Test cubes are measured parately) Drimwork Description of formwork shall be deemed to include use and waste only (except where described as "left in" or remanent"), for fitting together in the required forms, dediging, plumbing and fixing to true angles and rifaces as necessary to ensure easy release during ripping and for reconditioning as necessary before re- e The vertical strutting shall be carried down to such instruction as is sufficiently strong to afford the quired support without damage and shall remain in sistion until the newly constructed work is able to proport itself. Dermworks to sofflits of solid etc shall be deemed to be abs not exceeding 250mm thick unless otherwise socribed Carried Forward Particular Parket Agent Carried Forward	Carried Forward ONCRETE, FORMWORK AND EINFORCEMENT DTE: Iless otherwise stated herein, all items in this bill shall deemed to fall into Work Group No. 110 for CPAP mula purposes JPPLEMENTARY PREAMBLES Dest of tests The costs of making, storing and testing of concrete test bes as required under clause? "Tests" of SABS 1200 shall include the cost of providing cube moulds coessary for the purpose, for testing costs and for brinting reports on the tests to the Principal Agent. The testing shall be undertaken by an independent firm institution nominated by the contractor to the approval the Principal Agent. (Test cubes are measured parately) Formwork The providing cube as "left in" or emmanent", for fitting together in the required forms, adding, plumbing and fixing to true angles and draces as necessary to ensure easy release during ipping and for reconditioning as necessary before relevence to the contractor of the statistic of the structure of the providing cube to the providing cube to the structure of the providing cube to the provi	ONCRETE, FORMWORK AND EINFORCEMENT DTE: less otherwise stated herein, all items in this bill shall dedemed to fall into Work Group No. 110 for CPAP mula purposes JPPLEMENTARY PREAMBLES Dest of tests le costs of making, storing and testing of concrete test bes as required under clause 7 "Tests" of SABS 1200 shall include the cost of providing cube moulds cossary for the purpose, for testing costs and for brinting reports on the tests to the Principal Agent. le testing shall be undertaken by an independent firm institution nominated by the contractor to the approval the Principal Agent. (Test cubes are measured parately) primwork escription of formwork shall be deemed to include use down the state of the s

Brought Forward	R	
Formwork to sides of bases, pile caps, ground beams, etc will only be measured where it is prescribed by the engineer for design reasons. Formwork necessitated by irregularity or collapse of excavated faces will not be measured and the cost thereof shall be deemed to be included in the allowance for taking the risk of collapse of the sides of the excavations, provision for which is made in "Earthworks"		
Carried Forward Section No. 4 Bill No. 2 Concrete, Formwork and Reinforcement	R	

	Brought Forward	1		R	
	REINFORCED CONCRETE				
	25MPa/19mm concrete				
1	Surface beds on waterproofing	m3	1		
2	Vanity slabs, cupboard slabs, cover slabs, etc	m3	1		
	TEST BLOCKS				
3	Making and testing 150 x 150 x 150mm concrete strenght test cube (Provisional)	No	5		
	CONCRETE SUNDRIES				
	Finishing top surfaces of concrete smooth with a steel trowel including rounding edges to form a bullnose finish				
4	Vanity slabs, cupboard slabs, cover slabs, etc	m2	4		
	MOVEMENT JOINTS ETC				
	(CPAP FORMULA WORK GROUP NO. 111)				
	Expansion joints with closed cell expanded polystirene joint filler between vertical concrete and/or brick surfaces				
5	10mm Joints not exceeding 300mm high	m	16		
	SMOOTH FORMWORK (DEGREE OF ACCURACY II)				
	(CPAP FORMULA WORK GROUP NO. 111)				
	Smooth formwork to				
6	Vanity slabs, cupboard slabs, cover slabs, etc. propped up not exceeding 1500mm high	m2	4		
	Smooth formwork to sides				
7	Edges, risers, ends and reveals not exceeding 300mm high	m	16		
	REINFORCEMENT (PROVISIONAL)				
	Carried Forward			R	\vdash
	Section No. 4 Bill No. 2 Concrete, Formwork and Reinforcement				

	Brought Forward		R	
	(CPAP FORMULA WORK GROUP NO. 114)			
	Fabric reinforcement			
8	Type 193 fabric reinforcement in concrete surface beds, slabs, etc m2	11		
	Carried Forward to Summary of Section No. 4		R	
	Section No. 4 Bill No. 2			
	Concrete, Formwork and Reinforcement			

Item No			Quantity	Rate	Amount	
	BILL NO. 3					
	MASONRY					
	NOTE: Unless otherwise stated herein, all items in this bill shall be deemed to fall into Work Group No. 116 for CPAP formula purposes					
	SUPPLEMENTARY PREAMBLES					
	BRICKWORK					
	Sizes in descriptions					
	Where sizes in descriptions are given in brick units, "one brick" shall represent the length and "half brick" the width of a brick					
	Face bricks					
	Bricks shall be ordered timeously to obtain uniformity in size and colour					
	<u>Pointing</u>					
	Descriptions of recessed pointing to fair face brickwork and face brickwork shall be deemed to include square recessed, hollow recessed, weathered pointing, etc.					
	SUPERSTRUCTURE					
	Brickwork of NFP bricks in class II mortar					
1	Half brick walls in beamfilling	m2	7			
2	Half brick walls	m2	9			
3	One brick walls	m2	37			
	BRICKWORK SUNDRIES					
	Brickwork reinforcement					
4	75 mm Brick reinforcement built-in horizontally	m	32			
5	150mm Wide reinforcement built in horizontally	m	167			
	Carried Forward			R		
	Section No. 4 Bill No. 3 Masonry					

	Brought Forward			R	
	Prestressed fabricated lintels				
6	110 x 75mm Lintels in lengths not exceeding 3m	m	6		
	Galvanised hoop iron cramps, ties, etc				
7	30 x 1,6mm Roof tie 1,5m long with one end fixed to timber and other end built into brickwork	No	8		
	NUTEC-CEMENT WINDOW SILLS				
	Natural grey sills in single lengths bedded in class I mortar including metal fixing lugs etc				
8	15 x 150mm Wide sills set flat and slightly projecting	m	3		
	Carried Forward to Summary of Section No. 4			R	
	Section No. 4 Bill No. 3				
	Masonry				

Item No			Quantity	Rate	Amount
\ !	BILL NO. 4				
	WATERPROOFING				
	NOTE: Unless otherwise stated herein, all items in this bill shall be deemed to fall into Work Group No. 120 for CPAP formula purposes				
	DAMP-PROOFING OF WALLS AND FLOORS				
	One layer of 375 micron "Consol Plastics Brikgrip DPC" embossed damp proof course				
1	In walls	m2	4		
	One layer of 250 micron "Consol Plastics Gunplas USB Green" waterproof sheeting sealed at laps with "Gunplas Pressure Sensitive Tape"				
2	Under surface beds	m2	11		
	JOINT SEALANTS, ETC				
	"Denbraven LM15" polysulphide sealing compound including backing cord, bond breaker, primer, etc				
3	10 x 10mm In expansion joints in floors	m	16		
	Carried Forward to Summary of Section No. 4			R	
	Section No. 4 Bill No. 4 Waterpressing				
	Waterproofing				

Item No			Quantity	Rate	Amount
1	BILL NO. 5				
	ROOF COVERINGS ETC				
	NOTE: Unless otherwise stated herein, all items in this bill shall be deemed to fall into Work Group No. 124 for CPAP formula purposes				
	PROFILED METAL SHEETING AND ACCESSORIES				
	0,6mm "IBR" Z275 spelter galvanised troughed sheet steel with "globalcoat" finish on one side in single lengths fixed to timber purlins and 0,6mm galvanised sheet steel accessories with "globalcoat" finish on one side				
1	Roof covering with pitch not exceeding 25 degrees	m2	26		
2	Hip flashings 308mm girth	m	20		
	ROOF AND WALL INSULATION				
3	"Sisalation 410" housing grade glass fibre reinforced aluminium foil bonded insulation Insulation laid taut over purlins (at approximately 1 000mm centres) and fixed concurrent with roof covering including galvanised steel straining wires	m2	21		
	Carried Forward to Summary of Section No. 4 Section No. 4 Bill No. 5 Roof Coverings, etc			R	

	Quantity	Rate	Amour
BILL NO. 6			
CARPENTRY AND JOINERY			
NOTE: Unless otherwise stated herein, all items in this bill shall be deemed to fall into Work Group No.126 for CPAP formula purposes			
SUPPLEMENTARY PREAMBLES			
Particle board:			
Particle board shall comply with the following specifications:			
a) SABS 1300 Particle board: exterior and flooring type			
b) SABS 1301 Particle board: interior type			
Joinery:			
Descriptions of frames shall be deemed to include frames, transoms, mullions, rails, etc			
Descriptions of hardwood joinery shall be deemed to include pelleting of bolt holes			
<u>Fixing</u>			
Items described as "nailed" shall be deemed to be fixed with hardened steel nails or shot pins to brickwork or concrete			
Decorative laminate finish:			
Laminate finish shall be glued under pressure. Edge strips shall be butt jointed at junctions with adjacent similar finish			
Carried Forward		R	
Section No. 4 Bill No. 6 Carpontry and Jainery			
Carpentry and Joinery			

	Brought Forward			R	
	ROOFS, ETC				
	Plate nailed timber roof truss construction				
	The following is applicable in respect of roof trusses:				
	Trusses are at maximum 1,10m centres				
	Roof covering is galvanised "IBR" roof sheeting with "Globalcoat" finish on one side on 50 x 75mm purlins at 1,0m maximum centres.				
	Ceilings are generally 6,4mm gypsum plasterboard on 38 x 38mm brandering.				
	All timber to be sawn softwood in accordance with V4 or M4 as defined in SABS 563 or SABS 1245.				
	Metal connector plates shall have a minimum yield strength of 228 MPa and a minimum ultimate tensile strength of 330 Mpa with hot-dip galvanised finish.				
	All joints to be close fitted butt joints.				
	Trusses shall be designed by a registered supplier of prefabricated trusses who shall issue an Engineers Certificate upon completion of the installation.				
	The dimensions in the descriptions of the trusses are nominal and actual measurements are to be obtained on site before design or fabrication commences.				
	Tenderers must study the roof plan and sections as attached to the back of these bills of quantities (refer drawing No.'s GUARD HOUSE - 001 and 002) and must obtain prices from a qualified and registered roof truss supplier as no claims in this regard will be entertained				
	Sawn softwood				
1	38 x 114mm Wall plates	m	16		
	Carried Forward			R	
	Section No. 4 Bill No. 6 Carpentry and Joinery				

	Brought Forward			R	
2	Design, manufacture and deliver to site, plate nailed roof truss construction to Gate House, size 4 000 x 4 000mm overall on plan consisting of twenty four mono pitched trusses, each truss 4 000 x 1800mm high overall with 600mm eaves overhang projecting both sides, including all necessary purlins, runners, bracing and cross bracing (wall plates elsewhere)	No	1		
3	Take delivery, temporary store, hoist in position and erect plate nailed timber roof trusses, purlins, gangboarding, temporary and permanent bracing, etc (measured on slope of roof)	m2	21		
	<u>Sundries</u>				
4	Two coats creosote on sawn timbers	m2	5		
	EAVES, VERGES, ETC				
	"Everite" pressed nutec-cement				
5	12 x 225mm Fascias and barge boards including galvanised steel H-profile jointing strips	m	24		
	DOORS ETC				
	Wrought hardwood flushback doors with sapele veneer hung to steel frames				
6	44mm "TDM" Framed and ledged door 813 x 2 $$ 032mm high	No	1		
	Semi-solid flush doors with sapele veneer on both sides hung to steel frames				
7	44mm Door 813 x 2 032mm high	No	1		
	Carried Forward to Summary of Section No. 4			R	
	Section No. 4 Bill No. 6 Carpentry and Joinery				
		I	I	II	

Item No			Quantity	Rate	Amount	
	BILL NO. 7	l				
	CEILINGS, PARTITIONS AND ACCESS FLOORING					
	NOTE: Unless otherwise stated herein, all items in this bill shall be deemed to fall into Work Group No. 129 for CPAP formula purposes					
	SUPPLEMENTARY PREAMBLES					
	Descriptions:					
	Items described as "nailed" shall be deemed to be fixed with hardened steel nails or pins or shot pinned to brickwork or concrete					
	Items described as "plugged" shall be deemed to include screwing to fibre, plastic or metal plugs at not exceeding 600mm centres, and where described as "bolted" the bolts have been given elsewhere					
	CEILINGS ETC					
	"Aerolite" insulation					
1	75mm Insulation closely fitted and laid on top of brandering between roof timbers etc	m2	11			
	NAILED UP CEILINGS					
	6,4mm "Rhino" gypsum plasterboard with H-type pressed steel jointing strips					
2	Ceilings including 38 x 38mm sawn softwood brandering at 400mm centres	m2	11			
3	Extra over ceiling for 650 x 650mm trap door of 38 x 50mm wrought softwood rebated framing with one 38 x 50mm sawn softwood cross brander covered with ceiling board and fitted flush in opening	No	1			
	"Rhino" gypsum plasterboard cornices					
4	75mm Coved cornices	m	19			
						_
	Carried Forward to Summary of Section No. 4			R		_
	Section No. 4 Bill No. 7 Ceilings, Partitions and Access Flooring					=

Item No		Quantity	Rate	Amount	
	BILL NO. 8				
	IRONMONGERY				
	NOTE : Unless otherwise stated herein, all items in this bill shall be deemed to fall into Work Group No. 132 for CPAP formula purposes				
	SUPPLEMENTARY PREAMBLES				
	<u>Finishes to ironmongery</u>				
	Where applicable finishes to ironmongery are indicated by suffixes in accordance with the following list: BS Satin bronze lacquered CH Chromium plated SC Satin chromium plated SE Silver enamelled GE Grey enamelled AS Anodised silver AB Anodised bronze AG Anodised gold ABL Anodised black PB Polished brass PL Polished and lacquered PT Epoxy coated SD Sanded NP Nickle plated				
	HINGES, BOLTS, ETC.				
1	200mm Brass barrel bolt with keep fixed to metal No	4			
	<u>"Union"</u>				
2	"CZ80941SC" WC indicator bolt with keep fixed to metal No	1			
	LOCKS				
	<u>"Union"</u>				
3	"CZ682-24/2247-78" or other similar and approved four lever lockset with striking plate fixed to metal or timber No	1			
	<u>HANDLES</u>				
					_
	Carried Forward		R		
	Section No. 4 Bill No. 8 Ironmongery				

	Brought Forward			R	ļ
	"Dorma"				
4	32 x 515mm Stainless steel "D" straight back-to-back pull handles	No	2		
	"BATHROOM FITTINGS"				
5	19mm Diameter chromium plated towel rail 600mm long including end brackets plugged	No	1		
	"Nampak"				
6	"TR2" lockable toilet roll holder plugged	No	1		
	SUNDRIES				
	<u>"Union"</u>				
7	"AL8730AS" door stop plugged	No	1		
	Carried Forward to Summary of Section No. 4			R	
	Section No. 4				
	Bill No. 8 Ironmongery				
					l

Item No			Quantity	Rate	Amount
	BILL NO. 9				
	METALWORK				
	NOTE : Unless otherwise stated herein, all items in this bill shall be deemed to fall into Work Group No. 136 for CPAP formula purposes				
	SUPPLEMENTARY PREAMBLES				
	<u>Descriptions</u>				
	Descriptions of bolts shall be deemed to include nuts and washers				
	Descriptions of expansion anchors and bolts and chemical anchors and bolts shall be deemed to include nuts, washers and mortices in brickwork or concrete				
	Metalwork described as "holed for bolt(s)" shall be deemed to exclude the bolts unless otherwise described				
	WELDED SCREENS, GATES, ETC				
	Steel gates and frames				
1	Single gate and frame 965 x 2 067mm high overall, the outer frame of 45 x 45 x 3mm hollow section bolted to wall with and including eight 70mm M80 expansion bolts and the gate 813 x 2 032mm high of 40 x 60 x 2mm hollow section frame with two 40 x 6mm flat section horizontal rails filled in with 20mm diameter vertical rails at 110mm centres fitted with one and a half pairs of suitable pin hinges welded to hollow section steel frame, complete with and including 150mm barrelbolt and padlock	No	1		
	PRESSED STEEL DOOR FRAMES				
	1,2mm Double rebated frames suitable for half brick walls				
2	Frame for door 813 x 2 032mm high	No	1		
	1,2mm Double rebated frames suitable for one brick walls				
3	Frame for door 813 x 2 032mm high	No	1		
	Carried Forward			R	
	Section No. 4 Bill No. 9 Metalwork				

	Brought Forward			R	
	STEEL WINDOWS, DOORS, ETC				
	Standard steel type top hung residential open out windows with 12mm square steel rods at 100mm c/c between burgler bars				
4	Window type G1, 533 x 359mm high	No	1		
5	Window type 14BH, 889 x 854mm high	No	2		
	Carried Forward to Summary of Section No. 4			R	
	Section No. 4 Bill No. 9				
	Metalwork				
		1	I	ll ll	1

Item No		Quantity	Rate	Amount
	BILL NO. 10			
	PLASTERING			
	NOTE: Unless otherwise stated herein, all items in this bill shall be deemed to fall into Work Group No. 142 for CPAP formula purposes.			
	INTERNAL PLASTER			
	Cement plaster on brickwork			
1	On walls m2	46		
2	On narrow widths m2	5		
	EXTERNAL PLASTER			
	Cement plaster on brickwork			
3	On walls m2	37		
4	On narrow widths m2	4		
	IIIZ			
	Carried Forward to Summary of Section No. 4		R	
	Section No. 4			
	Bill No. 10 Plastering			

Item No			Quantity	Rate	Amount	
	BILL NO. 11					
	TILING					
	NOTE: Unless otherwise stated herein, all items in this bill shall be deemed to fall into Work Group No. 144 for CPAP formula purposes.					
	SUPPLEMENTARY PREAMBLES					
	<u>Descriptions</u>					
	Unless described as "fixed with adhesive to plaster (plaster elsewhere)" descriptions of tiling on brick or concrete walls, columns, etc shall be deemed to include 1:4 cement plaster backing and descriptions of tiling on concrete floors etc shall be deemed to include 1:3 plaster bedding					
	WALL TILING					
	200 x 200 x 6mm Ceramic tiles(PC Amount R100.00/m2) fixed with adhesive to plaster (plaster elsewhere)					
1	On walls	m2	12			
	FLOOR TILING					
	300 x 300mm x 8mm Ceramic tiles (PC Amount R140.00/m2) fixed with adhesive to bedding (bedding elsewhere) and flush pointed with tinted waterproof jointing compound					
2	On floors laid to falls	m2	11			
3	Skirting 75mm high	m	15			
	Carried Forward to Summary of Section No. 4			R		
	Section No. 4					_
	Bill No. 11 Tiling					

Item No		Quantity	Rate	Amount
	BILL NO. 12			
	PLUMBING AND DRAINAGE (PROVISIONAL)			
	NOTE: Unless otherwise stated herein, all items in this bill shall be deemed to fall into Work Group No. 146 for CPAP formula purposes.			
	SUPPLEMENTARY PREAMBLES			
	uPVC pipes and fittings:			
	Soil, waste and vent pipes and fittings shall be solvent weld jointed			
	uPVC pressure pipes and fittings:			
	Pipes for water supply shall be of the class stated			
	Pipes of 40mm diameter and smaller shall be plain ended with solvent welded uPVC loose sockets and fittings			
	Pipes of 50mm diameter and greater shall have sockets and spigots with push in type integral rubber ring joints. Bends shall be uPVC and all other fittings shall be cast iron, all with similar push-in type joints			
	Copper pipes:			
	Pipes shall be hard drawn and half-hard pipes of the class stated. Class 0 (thin walled hard drawn) pipes shall not be bent. Class 1 (thin walled half-hard), class 2 (half-hard) and class 3 (heavy walled half-hard) pipes shall only be bent with benders with inner and outer formers. Fittings to copper waste, vent and anti-syphon pipes, capillary solder fittings and compression fittings shall be "Cobra Watertech" type. Capillary solder fittings shall comply with ISO 2016. Only compression fittings shall be used in walls or in ground			
	Fixing of pipes			
	Unless specifically otherwise stated, descriptions of pipes shall be deemed to include fixing to walls etc, casting in, building in or suspending not exceeding 1m below suspension level			
	Carried Forward		R	
	Section No. 4 Bill No. 12 Plumbing and Drainage (Provisional)			

Brought Forward	R	
Reducing fittings		
Where fittings have reducing ends or branches they are described as "reducing". In the case of pipes with diameters not exceeding 60mm only the largest end or branch size is given. Should the contractor wish to use other fittings and bushes or reducers he may do so on the understanding that no claim in this regard will be entertained. In the case of pipes with diameters exceeding 60mm all sizes are given and no claim for extra bushes, reducers, etc will be entertained		
Exposed concrete surfaces		
Exposed surfaces of concrete stormwater channels, cover slabs, inspection eye marker slabs, gulley tops, cleaning eye tops, catchpits, inspection chambers, etc shall be finished smooth with plaster		
<u>Excavations</u>		
No claim for rock excavation will be entertained unless the contractor has timeously notified the quantity surveyor thereof prior to backfilling		
"Soft rock" and "hard rock" shall be as defined in "Earthworks"		
Laying, backfilling, bedding, etc. of pipes		
Pipes shall be laid and bedded and trenches shall be carefully backfilled in accordance with manufacturers' instructions		
Where no manufacturers' instructions exist pipes shall be laid in accordance with clauses 5.1 and 5.2 of each of the following: SABS 1200 L : Medium-pressure pipelines LD : Sewers LE : Stormwater drainage Pipe trenches etc shall be backfilled in accordance with clauses 3, 5.5, 5.6, 5.7 and 7 of SABS 1200 DB : Earthworks (Pipe trenches) Pipes shall be bedded in accordance with clauses 3.1 to 3.4.1, 5.1 to 5.3 and 7 of SABS 1200 LB : Bedding (Pipes). Unless otherwise described bedding of rigid pipes shall be class B bedding		
Flush pans		
Flush pans shall have straight or side outlets and "P" or "S" traps as necessary		
Carried Forward	R	—
Section No. 4 Bill No. 12 Plumbing and Drainage (Provisional)		

Brought Forward	R	
Stainless steel basins, sinks, wash troughs, urinals, etc.		
Units shall have standard aprons on all exposed edges and tiling keys against walls where applicable		
Waste unions		
Descriptions of waste unions shall be deemed to include rubber or vulcanite plugs and chains fixed to fittings		
Carried Forward	R	
Section No. 4 Bill No. 12 Plumbing and Drainage (Provisional)		

	Brought Forward	1		R	
	SANITARY FITTINGS				
	<u>"Vaal"</u>				
1	420 x 420 mm "Iceberg" self-rimming drop-in vanity basin	No	1		
2	"Klip" low level wc suite comprising pan with double flap heavy duty plastic seat and matching 9 litre cistern with flush pipe	No	1		
	WASTE UNIONS, ETC				
	"Cobra Watertech"				
3	32mm "301CP" Basin waste union	No	1		
	TRAPS, ETC				
	"Marley"				
4	32 x 50mm Deep seal "P" or "S" trap	No	1		
	TAPS, VALVES, ETC				
	<u>Brass</u>				
5	22mm Stopcock	No	1		
6	22mm Bibcock with hose union	No	1		
	"Cobra Watertech"				
7	15mm "111CP" Pillartap	No	1		
	SANITARY PLUMBING				
	uPVC pipes				
8	50mm Pipes	m	2		
9	110mm Pipes	m	2		
	Extra over uPVC pipes for fittings				
10	50mm Bend	No	1		
11	110mm Bend	No	1		
	Carried Forward			R	
	Section No. 4 Bill No. 12 Plumbing and Drainage (Provisional)				

	Brought Forward	d		R	
12	110mm Pan connector	No	1		
13	110mm Access bend with anti-syphon horn	No	1		
14	50mm "GI Two-way" vent valve	No	1		
	<u>Sundries</u>				
15	Testing waste pipe system		Item		
	WATER SUPPLIES				
	Class 0 copper pipes				
16	15mm Pipes	m	1		
17	22mm Pipes	m	1		
18	15mm Pipes chased into brick walls	m	2		
19	22mm Pipes chased into brick walls	m	2		
	Extra over class 0 copper pipes for capillary fittings				
20	15mm Fittings	No	10		
21	22mm Fittings	No	10		
	Copper overflow and service pipes				
22	15mm Service pipe 500mm girth	No	5		
	TESTING				
23	Testing water pipe system		Item		
	FIRE APPLIANCES ETC				
	"Chubb"				
24	4,5kg Carbon dioxide fire extinguisher complete with 520 x 115 x 22mm thick timber backboard plugged to wall and varnished	No	1		
	Carried Forward to Summary of Section No. 4			R	
	Section No. 4 Bill No. 12 Plumbing and Drainage (Provisional)				

Item No			Quantity	Rate	Amount
	BILL NO. 13				
	<u>GLAZING</u>				
	NOTE: Unless otherwise stated herein, all items in this bill shall be deemed to fall into Work Group No. 150 for CPAP formula purposes				
	GLAZING TO STEEL WITH PUTTY				
	6,38mm Normal strength clear laminated safety glass				
1	Panes exceeding 0,1 and not exceeding 0,5m2	n2	2		
	TOPS, SHELVES, DOORS, MIRRORS, ETC				
	6mm Silvered float glass copper backed mirrors with polished edges holed for and fixed with chromium plated dome capped mirror screws with rubber buffers to plugs in brickwork or concrete				
2	Mirror 400 x 600mm high with four screws	No	1		
	Carried Forward to Summary of Section No. 4 Section No. 4 Bill No. 13			R	
	Glazing				

Item No			Quantity	Rate	Amount
ı	BILL NO. 14	l			
	<u>PAINTWORK</u>				
	NOTE: Unless otherwise stated herein, all items in this bill shall be deemed to fall into Work Group No. 152 for CPAP formula purposes				
	ON FLOATED PLASTER				
	One coat alkali resistant primer, one undercoat and two coats eggshell enamel paint				
1	On internal walls	m2	51		
	One coat alkali resistant primer, one undercoat and two coats eggshell enamel paint				
2	On external walls	m2	41		
	ON PLASTERBOARD				
	One coat primer and two coats interior quality PVA emulsion paint				
3	On ceilings and cornices	m2	11		
	ON FIBRE-CEMENT				
	One coat primer and two coats interior quality acrylic PVA paint				
4	On internal window sills not exceeding 300mm wide or girth	m	3		
	One coat primer and two coats exterior quality PVA emulsion paint				
5	On fascias and bargeboards	m2	6		
	ON METAL				
	Spot priming defects in pre primed surfaces with zinc chromate primer and applying one undercoat and two coat high gloss enamel paint on steel				
6	On door frames	m2	2		
	Carried Forward			R	
	Section No. 4 Bill No. 14 Paintwork				

	Brought Forward			R	
7	On windows with burglar bars	m2	4		
8	On gates, grilles, burglar screens, balustrades, etc (both sides measured over the full flat area)	m2	4		
	ON WOOD				
	One coat wood primer, one coat undercoat and one coat polyurethane gloss enamel paint				
9	On doors	m2	3		
	Three coats polyurethane semi-gloss varnish				
10	On doors	m2	3		
	Carried Forward to Summary of Section No. 4			R	
	Carried Forward to Summary of Section No. 4 Section No. 4			ĸ	
	Bill No. 14 Paintwork				
	I AIIILWOIN				

	SECTION SUMMARY - Guard House			
Bill No		Page No		Amount
1	Foundations (Provisional)	100		
2	Concrete, Formwork and Reinforcement	104		
3	Masonry	106		
4	Waterproofing	107		
5	Roof Coverings, etc	108		
6	Carpentry and Joinery	111		
7	Ceilings, Partitions and Access Flooring	112		
8	Ironmongery	114		
9	Metalwork	116		
10	Plastering	117		
11	Tiling	118		
12	Plumbing and Drainage (Provisional)	123		
13	Glazing	124		
14	Paintwork	126		
	Couried to Final Summany		R	
	Carried to Final Summary Section No. 4			
	Section NO. 4			

	Quantity	Rate	Amount
SECTION 13			
BILL NO. 1			
EARTHWORKS, ETC (PROVISIONAL)			
Refer to 'The Preambles to Trades' as issued by the Office of the Chief Director, Department of Public Works, Roads and Transport			
NOTE:			
EPWP: All the work in this trade shall be executed in accordance with the principles of Expanded Public Works Programme, that is, labour intensive methods shall be used (www.epwp.gov.za)			
SUPPLEMENTARY PREAMBLES			
Nature of ground			
A soils investigation has been carried out on site by the Engineers and the report is available for inspection at their offices			
Descriptions of excavations shall be deemed to include all ground conditions classifiable as "earth" described in the above report and where conditions of a more difficult character are indicated these are separately measured			
Carting away of excavated material			
Descriptions of carting away of excavated material shall be deemed to include loading excavated material onto trucks directly from the excavations or, alternatively, from stock piles situated on the building site			
SITE CLEARANCE ETC			
Carried Forward		R	
Section No. 5 Bill No. 1 Earthworks, etc			

	Brought Forward			R	
	Site clearance				
1	Digging up and removing rubbish, debris, vegetation, hedges, shrubs and trees not exceeding 200mm girth, bush, etc	m2	7,662		
2	Stripping average 150mm thick layer of top soil and stockpiling on site	m2	7,662		
	Compaction of surfaces				
3	Compaction of ground surface under floors etc including scarifying for a depth of 150mm, breaking down oversize material, adding suitable material where necessary and compacting to 90% Mod AASHTO density	m2	7,662		
	Prescribed density tests on filling				
4	"Field Density" test including "Optimum Moisture Content" (four readings per test)	No	30		
	Carried Forward to Summary of Section No. 5 Section No. 5 Bill No. 1 Earthworks, etc			R	

Item No			Quantity	Rate	Amount	
	BILL NO. 2					
	PARKING, WALKWAYS, ETC (PROVISIONAL)					
	Refer to 'The Preambles to Trades' as issued by the Office of the Chief Director, Department of Public Works, Roads and Transport					
	NOTE:					
	EPWP : All the work in this trade shall be executed in accordance with the principles of Expanded Public Works Programme , that is, labour intensive methods shall be used (www.epwp.gov.za)					
	ROADWORKS					
	SITE CLEARANCE ETC					
	Site clearance					
1	Digging up and removing rubbish, debris, vegetation, hedges, shrubs and trees not exceeding 200mm girth, bush, etc	m2	2,422			
2	Stripping average 150mm thick layer of top soil and stockpiling on site	m2	2,422			
	Excavation in earth not exceeding 2m deep					
3	Reduced levels under roads and paving	m3	521			
	Extra over all excavations for carting away					
4	Surplus material from excavations and/or stock piles on site to a dumping site to be located by the Contractor	m3	521			
	Keeping excavations free of water					
5	Keeping excavations free of water other than subterranean water		ltem			
	Carried Forward			R		_
	Section No. 5 Bill No. 2 Parking, Walkways, etc					

	Brought Forward			R	
	Compaction of surfaces				
6	Compaction of ground surface under floors etc including scarifying for a depth of 150mm, breaking down oversize material, adding suitable material where necessary and compacting to 90% Mod AASHTO density	m2	2,422		
	Approved filling material supplied by the contractor				
7	G6 material under road islands, pedestals, etc compacted to 95% Mod AASHTO density	m3	206		
	Prescribed density tests on filling				
8	Modified AASHTO density test	No	20		
	Precast concrete, finished smooth on exposed surfaces including bedding, jointing and pointing				
9	Barrier kerb (fig 11) with 75 x 150 x 300mm unreinforced concrete haunching at back of each joint including excavation, backfilling, etc	m	147		
	80mm paving blocks on 25mm thick river sand bed with sand and cement mixture swept into joints and hosed down including preparation of ground or filling				
10	Paving in stretcher bond to parking areas, etc	m2	900		
	Carried Forward to Summary of Section No. 5			R	
	Section No. 5 Bill No. 2 Parking, Walkways, etc				=

	Quantity	Rate	Amount
BILL NO. 3			
WATER RETICULATION (PROVISIONAL)			
Refer to 'The Preambles to Trades' as issued by the Office of the Chief Director, Department of Public Works, Roads and Transport			
NOTE:			
EPWP : All the work in this trade shall be executed in accordance with the principles of Expanded Public Works Programme , that is, labour intensive methods shall be used (www.epwp.gov.za)			
SUPPLEMENTARY PREAMBLES			
uPVC pressure pipes and fittings:			
Pipes for water supply shall be of the class stated			
Pipes of 40mm diameter and smaller shall be plain ended with solvent welded uPVC loose sockets and fittings			
Pipes of 50mm diameter and greater shall have sockets and spigots with push in type integral rubber ring joints. Bends shall be uPVC and all other fittings shall be cast iron, all with similar push-in type joints			
Fixing of pipes			
Unless specifically otherwise stated, descriptions of pipes shall be deemed to include fixing to walls etc, casting in, building in or suspending not exceeding 1m below suspension level			
Carried Forward		R	
Section No. 5			
Bill No. 3 Water Reticulation, etc			
vvalei Neliculation, etc			

Brought Forward				R		j
Reducing fittings						
Where fittings have reducing ends or branches they are described as "reducing". In the case of pipes with diameters not exceeding 60mm only the largest end or branch size is given. Should the contractor wish to use other fittings and bushes or reducers he may do so on the understanding that no claim in this regard will be entertained. In the case of pipes with diameters exceeding 60mm all sizes are given and no claim for extra bushes, reducers, etc will be entertained						
<u>Excavations</u>						
No claim for rock excavation will be entertained unless the contractor has timeously notified the quantity surveyor thereof prior to backfilling						
Laying, backfilling, bedding, etc. of pipes						
Pipes shall be laid and bedded and trenches shall be carefully backfilled in layers with specified granular and selected materials and in accordance with manufacturers' instructions						
Where no manufacturers' instructions exist pipes shall be laid in accordance with clauses 5.1 and 5.2 of each of the following: SABS 1200 L: Medium-pressure pipelines LD: Sewers LE: Stormwater drainage Pipe trenches etc shall be backfilled in accordance with clauses 3, 5.5, 5.6, 5.7 and 7 of SABS 1200 DB: Earthworks (Pipe trenches) Pipes shall be bedded in accordance with clauses 3.1 to 3.4.1, 5.1 to 5.3 and 7 of SABS 1200 LB: Bedding (Pipes)						
Unless otherwise described bedding of rigid pipes shall be class B bedding						
<u>EARTHWORKS</u>						
Backfilling to trenches compacted to 93% Mod AASHTO density	m3	20	00			
Selected granular filling in bedding under and around pipes	m3	:	23			
15mm diameter crushed stone bedding under pipes	m3	2	23			
Carried Forward				R		
Section No. 5 Bill No. 3 Water Reticulation, etc						

	Brought Forward			R	
	Unreinforced concrete Mpa15				
4	Bedding under pipes	m3	2		
	HDPE Pipes				
5	25mm pipes laid in and including trenches not exceeding 1m deep	m	62		
	Class 6 uPVC pressure pipes				
6	63mm pipes laid in and including trenches not exceeding 1m deep	m	107		
7	63mm pipes laid in and including trenches exceeding 1m but not exceeding 2m deep	m	200		
	Extra over uPVC pipes for fittings				
8	63mm equal tee	No	3		
9	63mm bends	No	8		
10	63 x 25mm reducer	No	1		
	Extra over HDPE pipes for plasson compression fittings				
11	25mm bend	No	1		
	Sundries				
12	SENSUS-AGB 800 or approved equal 15mm diameter water meter complete with meter, valves and fittings	No	1		
13	DN63 Class 16 flanged ball check valve (AVK Series 53 ductile iron or approved equal)	No	1		
14	80mm diameter hydrant as per drawing	No	1		
15	DN75 fire hydrant connection as per drawing	No	1		
16	DN 75 fire booster connection	No	1		
17	DN 90 fire booster pump	No	1		
18	DN 90 fire reels	No	1		
	Carried Forward			R	
	Section No. 5 Bill No. 3 Water Reticulation, etc				

	Brought Forward			R	
	STORAGE WATER TANK				
	Water Tank etc.				
19	Supply and install SABS approved 10000L Polyethylene Water storage tank complete with all necessary fittings, pipes etc as per Engineers specifications	No	1		
20	Supply and install SABS approved 20000L Polyethylene Water storage tank complete with all necessary fittings, pipes etc as per Engineers specifications	No	2		
21	Submersible Pump for 10 000L Polyethylene Tank (elsewhere) complete with Water level Control and Tank alert system	No	1		
	BOREHOLE EQUIPPING				
22	Allow a provisional Amount of R200 000.00 for Borehole equipping		Item		
23	Unreinforced concrete Mpa15 in thrust blocks in trenches at bend s, trees,etc including extra excavation, formwork,etc	m3	1		
24	1785 x 115mm cast iron valve/meter box including brick chamber below 800mm deep internally	No	1		
25	450 x 450mm brick valve chamber 800mm deep internally including concrete kerb, excavations,etc	No	1		
26	450 x 450mm x 45kg cast iron single seal cover and frame	No	1		
27	262 x 105mm x 5.5kg cast iron single seal cover and frame	No	1		
28	7.5m high steel stand complete with all necessary fittings	No	1		
	Carried Forward to Summary of Section No. 5			R	
	Section No. 5 Bill No. 3 Water Reticulation, etc				

Item No		Quantity	Rate	Amount
	BILL NO. 4			
	SEWER RETICULATION (PROVISIONAL)			
	Refer to 'The Preambles to Trades' as issued by the Office of the Chief Director, Department of Public Works, Roads and Transport			
	NOTE: EPWP: All the work in this trade shall be executed in accordance with the principles of Expanded Public Works Programme, that is, labour intensive methods			
	Works Programme, that is, labour intensive methods shall be used (www.epwp.gov.za)			
	SUPPLEMENTARY PREAMBLES			
	uPVC pipes and fittings:			
	Soil, waste and vent pipes and fittings shall be solvent weld jointed			
	Fixing of pipes			
	Unless specifically otherwise stated, descriptions of pipes shall be deemed to include fixing to walls etc, casting in, building in or suspending not exceeding 1m below suspension level			
	Reducing fittings			
	Where fittings have reducing ends or branches they are described as "reducing". In the case of pipes with diameters not exceeding 60mm only the largest end or branch size is given. Should the contractor wish to use other fittings and bushes or reducers he may do so on the understanding that no claim in this regard will be entertained. In the case of pipes with diameters exceeding 60mm all sizes are given and no claim for extra bushes, reducers, etc will be entertained			
	Carried Forward		R	
	Section No. 5 Bill No. 4 Sewer Reticulation, etc			

	Brought Forward			R		
	Exposed concrete surfaces					
	Exposed surfaces of concrete stormwater channels, cover slabs, inspection eye marker slabs, gulley tops, cleaning eye tops, catchpits, inspection chambers, etc shall be finished smooth with plaster					
	Excavations					
	No claim for rock excavation will be entertained unless the contractor has timeously notified the quantity surveyor thereof prior to backfilling					
	Laying, backfilling, bedding, etc. of pipes					
	Pipes shall be laid and bedded and trenches shall be carefully backfilled in accordance with manufacturers' instructions					
	Where no manufacturers' instructions exist, pipes shall be laid in accordance with clauses 5.1 and 5.2 of each of the following: SABS 1200 L : Medium-pressure pipelines LD : Sewers LE : Stormwater drainage					
	Pipe trenches etc shall be backfilled in accordance with clauses 3, 5.5, 5.6, 5.7 and 7 of SABS 1200 DB : Earthworks (Pipe trenches)					
	Pipes shall be bedded in accordance with clauses 3.1 to 3.4.1, 5.1 to 5.3 and 7 of SABS 1200 LB : Bedding (Pipes).					
	Unless otherwise described bedding of rigid pipes shall be class B bedding					
	SOIL DRAINAGE					
	Class 34 uPVC pipes					
1	160mm Pipes laid in and including trenches not exceeding 1m deep	m	30			
2	160mm Pipes laid in and including trenches exceeding 1m and not exceeding 2m deep	m	45			
3	110mm Pipes laid in and including trenches not exceeding 1m deep	m	57			
	Carried Forward			R		_
	Section No. 5 Bill No. 4 Sewer Reticulation, etc					

	Brought Forward	1		R	
4	110mm Pipes laid in and including trenches exceeding 1m and not exceeding 2m deep	m	140		
	Extra over uPVC pipes for fittings				
5	160mm access bend	No	4		
6	110mm end cap	No	1		
7	100mm bend	No	1		
8	110mm access bend	No	8		
	MANHOLES, ETC				
	uPVC gulleys				
9	110mm Dished gulley not exceeding 750mm deep	No	3		
	'Rocla' or similar approved precast concrete circular inspection chambers with and including standard precast medium duty concrete frame and cover, step irons, etc				
10	Inspection chamber 1250mm diameter and exceeding 750mm and not exceeding 1000mm deep internally	No	2		
11	Inspection chamber 1500mm diameter exceeding 1000mm and not exceeding 2000mm deep internally	No	4		
	<u>Sundries</u>				
12	100mm Cast iron "ABC" cleaning eye	No	2		
	TESTING, CONNECTIONS, ETC				
	Testing				
13	Testing the whole of the soil drainage system		Item		
	SEPTIC TANK				
	EXCAVATION, FILLING, ETC OTHER THAN BULK				
	Excavation in earth not exceeding 2m deep				
14	Holes	m3			
	Carried Forward			R	-
	Section No. 5 Bill No. 4 Sewer Reticulation, etc				

	Brought Forward			R	
	Etra over excavation other than bulk in earth for excavation in:				
15	Soft rock	m3			
16	Hard rock	m3			
	Extra over all excavations for carting away				
17	Surplus material from excavations and / or stockpiles on site to a dumping site to be located by the contractor	m3			
	Risk of collapse of excavations other than bulk				
18	Sides of trench and hole excavations not exceeding 1,5m deep	m2			
	KEEPING EXCAVATION FREE OF WATER				
19	Keeping excavations free of all water other than subterranean water		Item		
	EARTH FILLING, ETC				
	Filling with material from excavations compacted to a density of at least 95% Mod AASHTO maximum density				
20	Backfilling to trenches, holes, etc	m3			
	SOIL POISONING				
	Approved brand of anti-termite soil poisoning applied by Registered Pest Control company and guaranteed against termite infestation for ten years:				
21	To bottoms and sides of trenches etc	m2			
	REINFORCED CONCRETE				
	20MPa/19mm concrete				
22	Surface beds	m3			
23	Slabs including beams and inverted beams	m3			
24	Walls	m3			
	Carried Forward			R	
	Section No. 5 Bill No. 4 Sewer Reticulation, etc				

	Brought Forward		R	j
	UNREINFORCED CONCRETE			
	15MPa/19mm concrete			
25	Benching	m3		
26	Blinding	m3		
	FINISHING TOP SURFACE OF CONCRETE			
	Finishing top surfaces of concrete smooth with a wood float			
27	Surface beds, slabs, etc	m2		
	PERMANENT FORMWORK TO SOFFITS (CPAP Work Group No 111)			
	Permenent formwork formed of 0.6mm thick corrugated sheeting supported by carbolenium treated gumpoles to the satisfaction of the Principal Agent to:			
28	Slabs propped up exceeding 1.5m not exceeding 3.5mm high.	m2		
29	Form 500mm radius opening in floor slab.	No		
	SMOOTH FORMWORK			
30	Sides of walls	m2		
	REINFORCEMENT (PROVISIONAL)			
	Mild steel reinforcing bars			
31	8mm diameter bars	t		
	High tensile steel reinforcement to structural concrete work (including spacers)			
32	12mm Diameter bars	t		
33	20mm Diameter bars	t		
	Carried Forward		R	
	Section No. 5 Bill No. 4 Sewer Reticulation, etc			

	Brought Forward		R	
	<u>Sundries</u>			
34	Cast iron lids type M2579 measuring 600 x 780mm	No		
35	200mm diameter Upvc with socket, 500mm away from the structure	No		
	Rigid PVC socketed Soil Piping (SABS791) with bedding and filling as laid out in SABS 1200 LB-Bedding flexible pipes. backfilling with excavated material.			
36	110mm Pipe and excavation exceeding 1000mm and not exceeding 2000mm deep	m		
37	110mm gulley trap with hopper head	No		
38	15Mpa cement concrete in encasing to 110mm diameter horizontal pipe of a minimum thickness of 150mm around pipe including all necessary casing	m		
39	Inspection chamber size 450 x 600 x average 1200mm internally fitted with type 8a castiron piece double a seal manhole cover and frame	No		
	French Drain			
	(All Trades)			
	EXCAVATION, FILLING, ETC OTHER THAN BULK			
	Excavation in earth not exceeding 2m deep			
40	Holes	m3		
	Etra over excavation other than bulk in earth for excavation in:			
41	Soft rock	m3		
42	Hard rock	m3		
	Extra over all excavations for carting away			
43	Surplus material from excavations and / or stockpiles on site to a dumping site to be located by the contractor	m3		
	Carried Forward		R	
	Section No. 5 Bill No. 4 Sewer Reticulation, etc			

	Brought Forward	d		R	
	Risk of collapse of excavations other than bulk				
44	Sides of trench and hole excavations not exceeding 1,5m deep	m2			
	KEEPING EXCAVATION FREE OF WATER				
45	Keeping excavations free of all water other than subterranean water		Item		
	EARTH FILLING, ETC				
	Filling with material from excavations compacted to a density of at least 95% Mod AASHTO maximum density				
46	Backfilling to trenches, holes, etc	m3			
	Coarse river sand filling compacted to 95% mod AASHTO maximum density:				
47	In french drain	m3			
	Gravel filling				
48	In french drain	m3			
	Stone filling of 150mm crushed stone (not compacted)				
49	In french drain	m3			
	0.6 Corrugated iron as permenent cover over:				
50	french drain	m2			
	SOIL DRAINAGE (CPAP Work Group No 146) uPVC:				
51	100mm pipes vertically or ramped to cleaning eyes (no excavation)	m			
	<u>Sundries</u>				
52	110mm cast iron `ABC` cleaning eyes	m			
	Carried Forward			R	
	Section No. 5 Bill No. 4 Sewer Reticulation, etc				

	Brought Forward	R	
	SOIL DRAINAGE (CPAP Work Group No 148) upvc		
53	150mm Perforated pipes laid in french drain.		
54	110mm Pipes laid in and icluding trenches not exceeding 1m deep.		
	Etra over uPVC pipes for fittings:		
55	110mm bend No		
	Carried Forward to Summary of Section No. 5	R	
	Section No. 5 Bill No. 4		
	Sewer Reticulation, etc		
			i

BILL NO. 5 STORMWATER RETICULATION (PROVISIONAL) Refer to 'The Preambles to Trades' as issued by the Office of the Chief Director, Department of Public Works, Roads and Transport NOTE: EPWP: All the work in this trade shall be executed in accordance with the principles of Expanded Public Works Programme, that is, labour intensive methods shall be used (www.epwp.gov.za) SUPPLEMENTARY PREAMBLES uPVC pipes and fittings: Soil, waste and vent pipes and fittings shall be solvent weld jointed Fixing of pipes Unless specifically otherwise stated, descriptions of pipes shall be deemed to include fixing to walls etc, casting in, building in or suspending not exceeding 1 m below suspension level Reducing fittings Where fittings have reducing ends or branches they are described as "reducing". In the case of pipes with diameters not exceeding 60mm only the largest end or branch size is given. Should the contractor wish to use other fittings and bushes or reducers he may do so on the understanding that no claim in this regard will be entertained. In the case of pipes with diameters exceeding 60mm all sizes are given and no claim for extra bushes, reducers, etc will be entertained		Quantity	Rate	Amoun
Refer to 'The Preambles to Trades' as issued by the Office of the Chief Director, Department of Public Works, Roads and Transport	<u>_L NO. 5</u>			
Office of the Chief Director, Department of Public Works, Roads and Transport NOTE: EPWP: All the work in this trade shall be executed in accordance with the principles of Expanded Public Works Programme, that is, labour intensive methods shall be used (www.epwp.gov.za) SUPPLEMENTARY PREAMBLES uPVC pipes and fittings: Soil, waste and vent pipes and fittings shall be solvent weld jointed Fixing of pipes Unless specifically otherwise stated, descriptions of pipes shall be deemed to include fixing to walls etc, casting in, building in or suspending not exceeding 1m below suspension level Reducing fittings Where fittings have reducing ends or branches they are described as "reducing". In the case of pipes with diameters not exceeding 60mm only the largest end or branch size is given. Should the contractor wish to use other fittings and bushes or reducers he may do so on the understanding that no claim in this regard will be entertained. In the case of pipes with diameters exceeding 60mm all sizes are given and no claim for extra bushes, reducers, etc will be entertained Carried Forward				
EPWP: All the work in this trade shall be executed in accordance with the principles of Expanded Public Works Programme, that is, labour intensive methods shall be used (www.epwp.gov.za) SUPPLEMENTARY PREAMBLES uPVC pipes and fittings: Soil, waste and vent pipes and fittings shall be solvent weld jointed Fixing of pipes Unless specifically otherwise stated, descriptions of pipes shall be deemed to include fixing to walls etc, casting in, building in or suspending not exceeding 1m below suspension level Reducing fittings Where fittings have reducing ends or branches they are described as "reducing". In the case of pipes with diameters not exceeding 60mm only the largest end or branch size is given. Should the contractor wish to use other fittings and bushes or reducers he may do so on the understanding that no claim in this regard will be entertained. In the case of pipes with diameters exceeding 60mm all sizes are given and no claim for extra bushes, reducers, etc will be entertained	ce of the Chief Director, Department of Public			
accordance with the principles of Expanded Public Works Programme, that is, labour intensive methods shall be used (www.epwp.gov.za) SUPPLEMENTARY PREAMBLES uPVC pipes and fittings: Soil, waste and vent pipes and fittings shall be solvent weld jointed Fixing of pipes Unless specifically otherwise stated, descriptions of pipes shall be deemed to include fixing to walls etc, casting in, building in or suspending not exceeding 1m below suspension level Reducing fittings Where fittings have reducing ends or branches they are described as "reducing." In the case of pipes with diameters not exceeding 60mm only the largest end or branch size is given. Should the contractor wish to use other fittings and bushes or reducers he may do so on the understanding that no claim in this regard will be entertained. In the case of pipes with diameters exceeding 60mm all sizes are given and no claim for extra bushes, reducers, etc will be entertained	TE:			
uPVC pipes and fittings: Soil, waste and vent pipes and fittings shall be solvent weld jointed Fixing of pipes Unless specifically otherwise stated, descriptions of pipes shall be deemed to include fixing to walls etc, casting in, building in or suspending not exceeding 1m below suspension level Reducing fittings Where fittings have reducing ends or branches they are described as "reducing". In the case of pipes with diameters not exceeding 60mm only the largest end or branch size is given. Should the contractor wish to use other fittings and bushes or reducers he may do so on the understanding that no claim in this regard will be entertained. In the case of pipes with diameters exceeding 60mm all sizes are given and no claim for extra bushes, reducers, etc will be entertained Carried Forward	ordance with the principles of Expanded Public rks Programme , that is, labour intensive methods			
Soil, waste and vent pipes and fittings shall be solvent weld jointed Fixing of pipes Unless specifically otherwise stated, descriptions of pipes shall be deemed to include fixing to walls etc, casting in, building in or suspending not exceeding 1m below suspension level Reducing fittings Where fittings have reducing ends or branches they are described as "reducing". In the case of pipes with diameters not exceeding 60mm only the largest end or branch size is given. Should the contractor wish to use other fittings and bushes or reducers he may do so on the understanding that no claim in this regard will be entertained. In the case of pipes with diameters exceeding 60mm all sizes are given and no claim for extra bushes, reducers, etc will be entertained	PPLEMENTARY PREAMBLES			
Fixing of pipes Unless specifically otherwise stated, descriptions of pipes shall be deemed to include fixing to walls etc, casting in, building in or suspending not exceeding 1m below suspension level Reducing fittings Where fittings have reducing ends or branches they are described as "reducing". In the case of pipes with diameters not exceeding 60mm only the largest end or branch size is given. Should the contractor wish to use other fittings and bushes or reducers he may do so on the understanding that no claim in this regard will be entertained. In the case of pipes with diameters exceeding 60mm all sizes are given and no claim for extra bushes, reducers, etc will be entertained Carried Forward	/C pipes and fittings:			
Unless specifically otherwise stated, descriptions of pipes shall be deemed to include fixing to walls etc, casting in, building in or suspending not exceeding 1m below suspension level Reducing fittings Where fittings have reducing ends or branches they are described as "reducing". In the case of pipes with diameters not exceeding 60mm only the largest end or branch size is given. Should the contractor wish to use other fittings and bushes or reducers he may do so on the understanding that no claim in this regard will be entertained. In the case of pipes with diameters exceeding 60mm all sizes are given and no claim for extra bushes, reducers, etc will be entertained Carried Forward				
pipes shall be deemed to include fixing to walls etc, casting in, building in or suspending not exceeding 1m below suspension level Reducing fittings Where fittings have reducing ends or branches they are described as "reducing". In the case of pipes with diameters not exceeding 60mm only the largest end or branch size is given. Should the contractor wish to use other fittings and bushes or reducers he may do so on the understanding that no claim in this regard will be entertained. In the case of pipes with diameters exceeding 60mm all sizes are given and no claim for extra bushes, reducers, etc will be entertained Carried Forward R	ing of pipes			
Where fittings have reducing ends or branches they are described as "reducing". In the case of pipes with diameters not exceeding 60mm only the largest end or branch size is given. Should the contractor wish to use other fittings and bushes or reducers he may do so on the understanding that no claim in this regard will be entertained. In the case of pipes with diameters exceeding 60mm all sizes are given and no claim for extra bushes, reducers, etc will be entertained Carried Forward	es shall be deemed to include fixing to walls etc, sting in, building in or suspending not exceeding			
described as "reducing". In the case of pipes with diameters not exceeding 60mm only the largest end or branch size is given. Should the contractor wish to use other fittings and bushes or reducers he may do so on the understanding that no claim in this regard will be entertained. In the case of pipes with diameters exceeding 60mm all sizes are given and no claim for extra bushes, reducers, etc will be entertained Carried Forward R	ducing fittings			
	cribed as "reducing". In the case of pipes with meters not exceeding 60mm only the largest end or nch size is given. Should the contractor wish to use er fittings and bushes or reducers he may do so on understanding that no claim in this regard will be ertained. In the case of pipes with diameters eeding 60mm all sizes are given and no claim for			
I Costion No. 5			R	
Section No. 5 Bill No. 5 Stormwater Reticulation, etc	No. 5			

	Brought Forward			R	ĺ
Exp	posed concrete surfaces				
cove	osed surfaces of concrete stormwater channels, er slabs, inspection eye marker slabs, gulley tops, aning eye tops, catchpits, inspection chambers, etc II be finished smooth with plaster				
Exc	cavations eavations				
the	claim for rock excavation will be entertained unless contractor has timeously notified the quantity veyor thereof prior to backfilling				
Lay	ring, backfilling, bedding, etc. of pipes				
care	es shall be laid and bedded and trenches shall be efully backfilled in accordance with manufacturers' ructions				
be la of th SAE LD :	ere no manufacturers' instructions exist, pipes shall aid in accordance with clauses 5.1 and 5.2 of each ne following: 3S 1200 L : Medium-pressure pipelines : Sewers : Stormwater drainage				
Pipe clau	e trenches etc shall be backfilled in accordance with uses 3, 5.5, 5.6, 5.7 and 7 of SABS 1200 : Earthworks (Pipe trenches)				
3.4.	es shall be bedded in accordance with clauses 3.1 to 1, 5.1 to 5.3 and 7 of SABS 1200 : Bedding (Pipes).				
1	ess otherwise described bedding of rigid pipes shall class B bedding				
COI	NRETE STORMWATER CHANNELS				
Exc	avation not exceeding 2m deep for channels	m3	62		
Sto	rm water channel				
	NS Type 14 PC Kerb channel laid in trenches not eeding 1m deep including all excavations, backfilling,	m	415		
	0 x 750mm concrete outlet structure, complete as drawingss	No	1		
	Carried Forward to Summary of Section No. 5			R	_
Bill I	tion No. 5 No. 5 rmwater Reticulation, etc				

	Quantity	Rate	Amount
BILL NO. 6			
FENCING (PROVISIONAL)			
Refer to 'The Preambles to Trades' as issued by the Office of the Chief Director, Department of Public Works, Roads and Transport			
NOTE:			
EPWP : All the work in this trade shall be executed in accordance with the principles of Expanded Public Works Programme , that is, labour intensive methods shall be used (www.epwp.gov.za)			
SUPPLEMENTARY PREAMBLES			
Work on site			
The boundary line shall be cleared of all vegetation, trees, rocks, rubble and rubbish for a width of 500mm on each side and the same removed from site.			
The one meter wide boundary line shall be graded to an even line so that the fencing mesh later described, shall have a 50mm gap at the bottom and a height of 1800mm above ground level.			
Allowance shall therefore be made as required to excavate areas that are to high and to fill depressions with approved clean filling, carted on where necessary and well compacted prior to erection of posts.			
SECURITY FENCING			
Carried Forward		R	
Section No. 5 Bill No. 6			

	Brought Forward			R	
	Steel palisade security fencing, gates, posts, etc.				
1	Standard palisade security fence 1 800mm high fixed to straining posts and/or gate and corner posts, the fence complete with and including two rows of flat wrap razor security wire in 700mm diameter vertical loops fixed at each intersection with barbed straining wires with and including 2.5mm galvanised binding wire.	m	574		
2	Gate 1,2 x 1,8m high including sliding lock and padlock	No	1		
			'		
3	Double gate 5 x 1,8m high including heavy duty hasp and staple, padlock and two barrel bolts with two keeps in and including concrete anchor blocks	No	1		
	Carried Forward to Summary of Section No. 5			R	
	Section No. 5				
	Bill No. 6 Fencing				

	SECTION SUMMARY - External Works			
Bill No		Page No		Amount
1	Earthworks, etc	129		
2	Parking, Walkways, etc	131		
3	Water Reticulation, etc	135		
4	Sewer Reticulation, etc	143		
5	Stormwater Reticulation, etc	145		
6	Fencing	147		
	Carried to Final Summary		R	
	Section No. 5			

Item No		Quantity	Rate	Amount
	SECTION 14			
	BILL NO. 1			
	PROVISIONAL SUMS			
	NOTES:			
	 The Contractor's attention is drawn specifically to the Principal Building Agreement Clause 20.0 (Nominated Sub-Contractors), Clause 21.0 (Selected Sub-Contractors) and Clause 22 (Work by Others) and to the related Clauses in Section 1, Bill No. 1 - Preliminaries 			
	 The Contractor's attention is drawn also to the definition of attendance on Nominated or Selected Sub-Contractors and of fuel, power and water for commissioning of mechanical and other specialised installations given in the JBCC Preliminaries 			
	 Where special attendance includes the provision of hoisting facilities for a Sub-Contractor then the Contractor shall:- 			
	* Ensure that the capacities of his hoisting equipment are sufficient to deal with the masses and the quantities of the items to be hoisted,			
	 Schedule the times of availability of the hoisting equipment for each Sub-Contractor, 			
	 Provide all necessary personnel to operate the hoisting equipment, 			
	all to enable the Sub-Contractor to execute the hoisting or lowering of his material, etc. using the facilities provided by the Contractor			
	PROVISIONAL SUMS			
	Electrical installations			
1	Provide the amount of R 1 310 000 (One million three hundred and ten thousand Rand) for Electrical installations to be used at the discretion of the Project Manager	Item		1,310,000.00
	Carried Forward		R	
	Section No. 6 Bill No. 1 Provisional Sums			

Profit Allow for general attendance	Item		
Allow for general attendance			
	Item		
Mechanical installations			
Provide the amount of Five hundred and eighty thousand rand (R580 000.00) for mechanical installations to be used at the discretion of the Project Manager	ltem		580,000,00
Profit			333,333
-	item		
french drains	Item		200,000.00
Furniture and furnishing			
Provide the amount of 372 000.00 for furniture and furnishing	Item		372,000,00
Community liaison officer			
Provide the amount of R90 000.00 (Ninty Thousand Five hundred Rand) for the appointment of community liaison officer			
	Item		90,000.00
Comind to Final Comment			
		K	
Section No. 6 Bill No. 1 Provisional Sums			
	Provide the amount of Five hundred and eighty thousand rand (R580 000.00) for mechanical installations to be used at the discretion of the Project Manager Profit Allow for general attendance Septic tanks and french drains Provide the amount of 200 000.00 for septic tanks and french drains Furniture and furnishing Provide the amount of 372 000.00 for furniture and furnishing Community liaison officer Provide the amount of R90 000.00 (Ninty Thousand Five hundred Rand) for the appointment of community liaison officer Carried to Final Summary Section No. 6 Bill No. 1	Provide the amount of Five hundred and eighty thousand rand (R580 000.00) for mechanical installations to be used at the discretion of the Project Manager Item Profit Item Allow for general attendance Item Septic tanks and french drains Provide the amount of 200 000.00 for septic tanks and french drains Item Furniture and furnishing Provide the amount of 372 000.00 for furniture and furnishing Item Community liaison officer Provide the amount of R90 000.00 (Ninty Thousand Five hundred Rand) for the appointment of community liaison officer Item Carried to Final Summary Section No. 6 Bill No. 1	Provide the amount of Five hundred and eighty thousand rand (R590 000.00) for mechanical installations to be used at the discretion of the Project Manager Item Profit Item Allow for general attendance Item Septic tanks and french drains Provide the amount of 200 000.00 for septic tanks and french drains Item Furniture and furnishing Provide the amount of 372 000.00 for furniture and furnishing Item Community liaison officer Provide the amount of R90 000.00 (Ninty Thousand Five hundred Rand) for the appointment of community liaison officer Item Carried to Final Summary R Section No. 6 Bill No. 1

	FINAL SUMMARY			
Section No		Page No		Amount
1	Preliminaries	28		
2	Main accommodation	59		
3	Administration block	96		
4	Guard House	127		
5	External Works	148		
6	Provisional Sums	150		
	Sub-Total		R	
	<u>Contingencies</u>		K	
	Provide 2.5% for contingencies to be used at the			
	discretion of the Principal Agent.		R	
	Sub Total		R	
	Add value added tax @ 15%		R	
	Carried to Form of Tender		R	