




TYPE 2 MANHOLE TYPE 1 MANHOLE - SILT TRAP NET 600x200mm HIGH OPENING CONCRETE SLAB FALLING TOWARDS _ THE INLET CHAMBER OPENING _ 220mm THICK MASONRY WALL 220mm THICK MASONRY WALL 200mm THICK 25MPa CONCRETE SLAB REINFORCED WITH 2 LAYERS OF MESH REF. 395 200mm THICK 25MPa CONCRETE SLAB REINFORCED WITH 2 LAYERS OF MESH REF. 395 SECTION B-B SECTION A-A SCALE 1:20 SCALE 1:20 FLOOR PLAN SCALE 1:20 FLOOR PLAN SCALE 1:20 1500x1250x100mm THICK 25MPa CONCRETE SLAB REINFORCED WITH — 1 LAYERS OF MESH REF. 395 1500x1250x100mm THICK 25MPa CONCRETE SLAB REINFORCED WITH — 1 LAYERS OF MESH REF. 395 SUPPLY AND INSTALL A STANDARD 595x495mm RAND WATER — SUPPLY AND INSTALL A STANDARD 595x495mm RAND WATER — MANHOLE COVER AND FRAME MANHOLE COVER AND FRAME

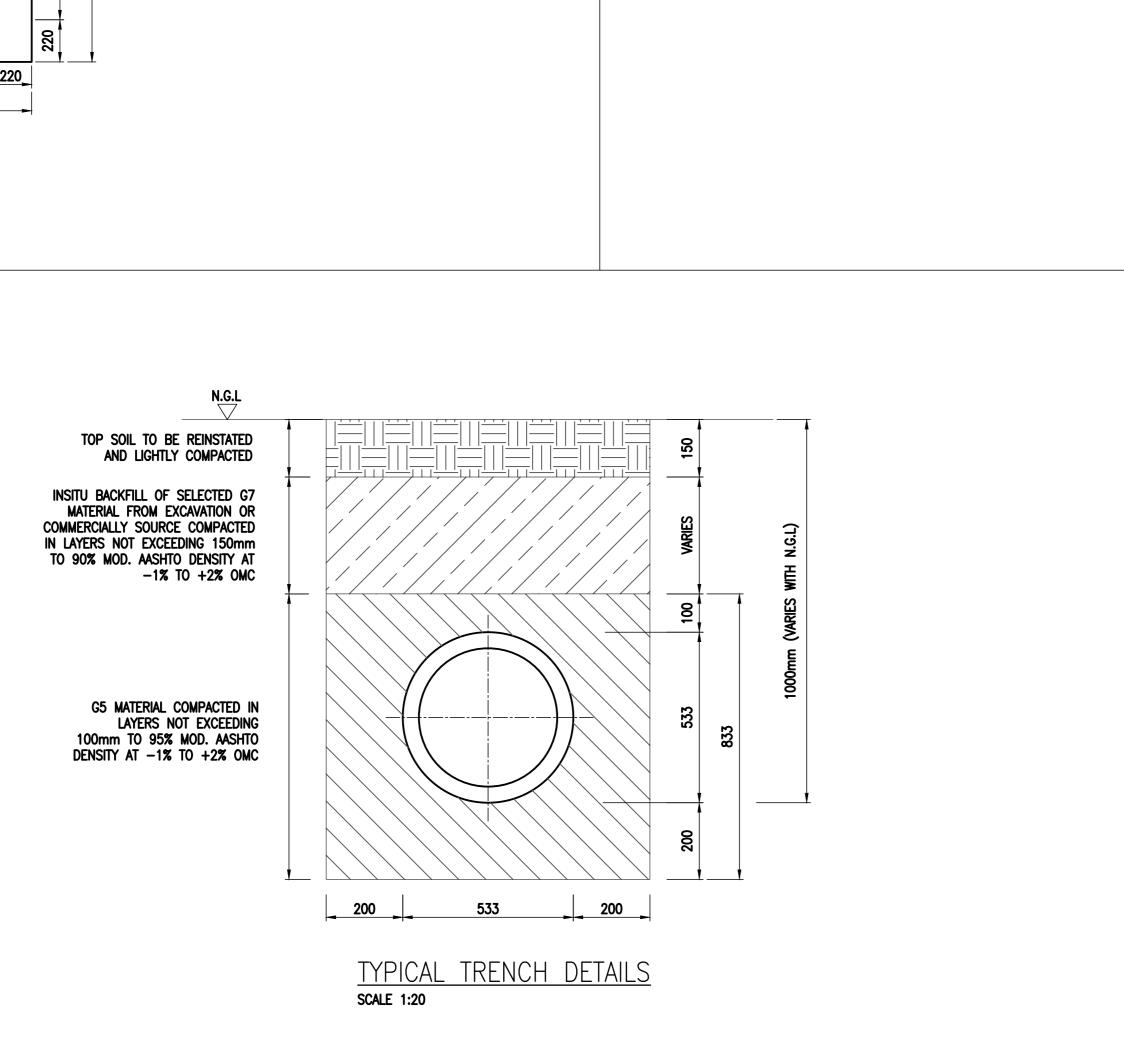

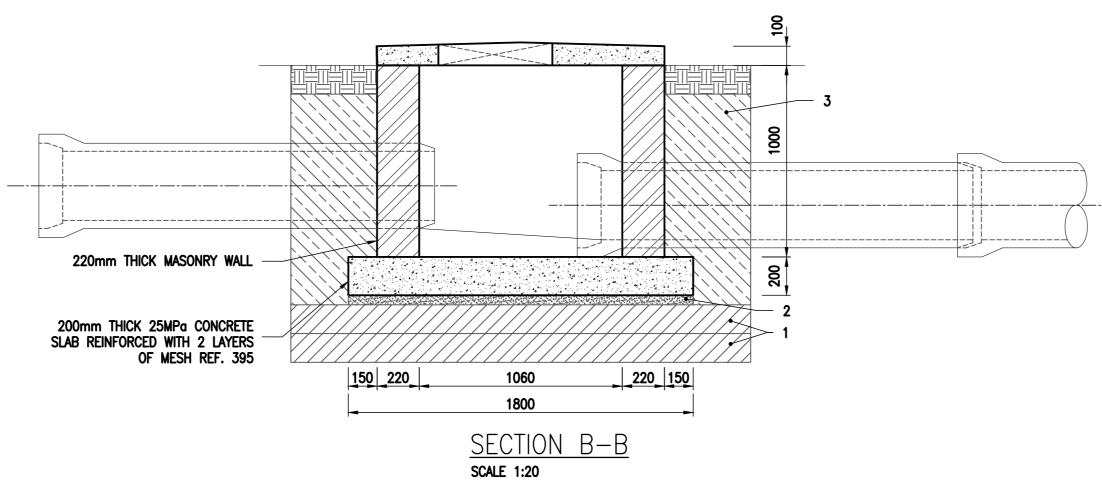

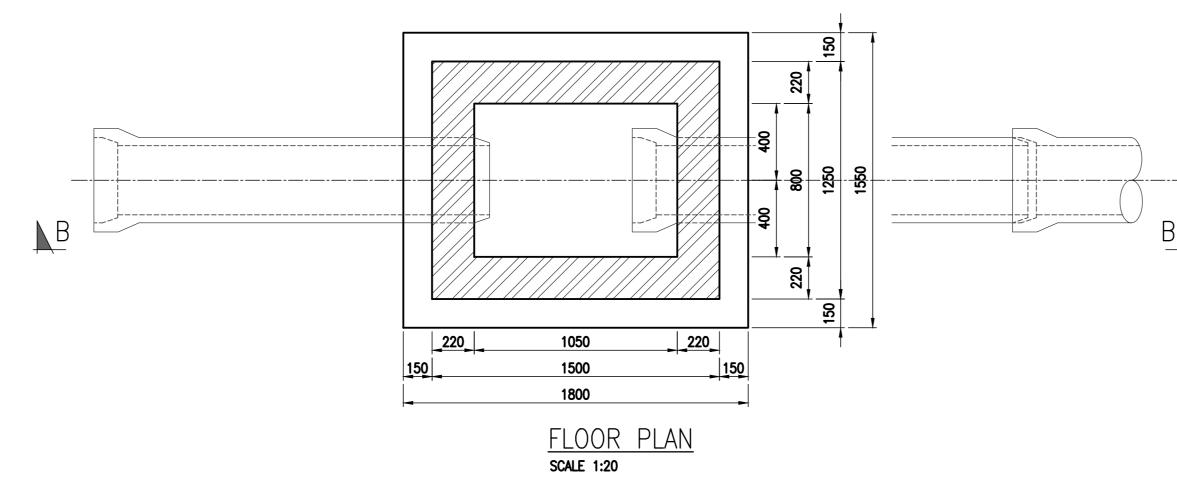

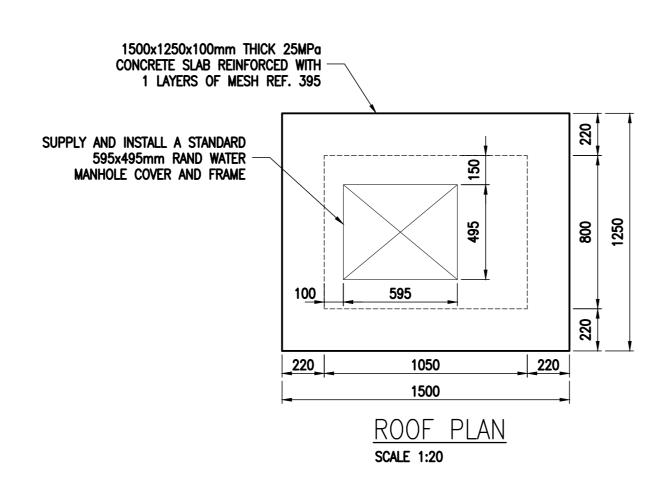

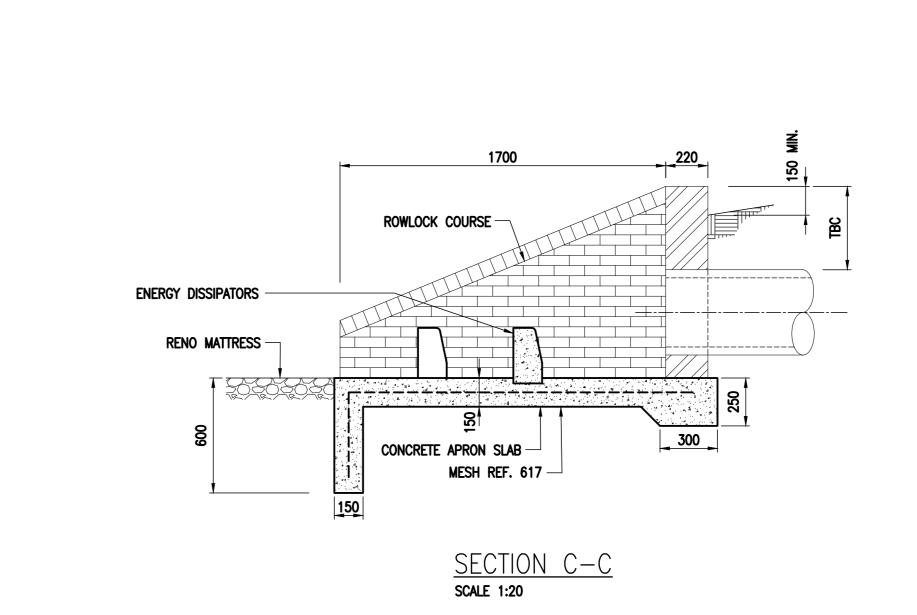

LAYER WORKS

(1) G5 MATERIAL COMPACTED IN LAYERS NOT EXCEEDING 150mm

3 IN-SITU BACKFILL OF SELECTED SUITABLE G7 MATERIAL FROM

4 150mm THICK TOP SOIL TO BE REINSTATED

EXCAVATION, COMPACTED IN LAYERS NOT EXCEEDING 150mm TO 93% MOD. AASHTO DENSITY AT -1% TO +2% OMC

TO 95% MOD. AASHTO DENSITY AT -1% TO +2% OMC

2 50mm BLINDING

ENERGY DISSIPATORS

WEEP HOLES © 0.5m CENTERS

LAYER DESCRIPTION

MASONRY NOTES

THICKNESS

300mm

DN450 CONCRETE SRORMWATER PIPE

APRON SLAB

OUTLET PLAN

FRONT ELEVATION

SCALE 1:20

SCALE 1:20

MASONRY END WALL

- 1. ALL BRICKS TO BE OF QUALITY FBSE30 TO SANS 227-2007 WITH WATER ABSORPTION < 14% AND EFFLORESCENCE < 10.
- 2. ALL BRICKWORK TO BE IN ENGLISH BOND.

5. ALL BRICKWORK TO BE OF HIGH STRENGTH WITH NOMINAL COMPRESSIVE STRENGTH OF 14MPa

- THIS DRAWING SHALL BE READ IN CONJUNCTION WITH ALL CONTRACT DRAWINGS. 3. NO PLASTERING OF BRICKWORK WILL BE ALLOWED. 4. BRICK SAMPLES SHALL BE SUBMITTED FOR TESTING.
 - STRUCTURE TO BE CONSTRUCTED IN ACCORDANCE WITH SANS SPECIFICATIONS AND RAND WATER SPECIFICATIONS.

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- ALL CONCRETE MIXES AND METHOD STATEMENTS TO BE APPROVED BY THE CIVIL DESIGN ENGINEER PRIOR TO COMMENCEMENT OF CONSTRUCTION.
- FOUNDATION EXCAVATIONS TO BE APPROVED BY THE CIVIL DESIGN ENGINEER PRIOR TO CASTING OF THE BLINDING LAYER.
- 5. ALL LEVELS AND DIMENSIONS WILL BE CHECKED ON SITE PRIOR TO CONSTRUCTION.

CONCRETE NOTES

GENERAL NOTES

- CONCRETE STRENGTH REQUIRE AT 28 DAYS:
 a) STRUCTURAL CONCRETE 25MPa
 b) BLINDING CLASS 15/19
- 2. MAXIMUM SIZE OF COARSE AGGREGATE TO BE 26.5mm.
- 3. CURING METHOD STATEMENT OF CONCRETE SHALL BE CARRIED OUT STRICTLY IN ACCORDANCE WITH SANS 2001-CC1.
- 4. ONLY CONCRETE COVER BLOCKS TO BE USED ON SITE AND THE CONCRETE COVER BLOCKS TO HAVE THE SAME STRENGTH AS THE CONCRETE BEING CAST.
- 5. STRIPPING TIMES OF SHUTTERING AND PROPPING SHALL BE IN ACCORDANCE WITH SANS 2001—CC1.

REINFORCEMENT NOTES

- CONCRETE COVER:
 a. FLOOR SLAB: 50mm
 b. FOOTING AND COLUMN STUB: 45mm
- MINIMUM LAP LENGTH TO BE 50 x DIAMETER OF THE SMALLER
- ALL REINFORCEMENT TO BE CHECKED AND APPROVED BY THE CIVIL DESIGN ENGINEER PRIOR TO CASTING OF ANY CONCRETE.
- B1 = FIRST LAYER FROM BOTTOM B2 = SECOND LAYER FROM BOTTOM

REINFORCEMENT ABBREVIATIONS:

BENDING OF REINFORCEMENT SHALL BE IN ACCORDANCE WITH

REINFORCEMENT DETAILING TO COMPLY WITH SANS 10144.

REINFORCEMENT SHALL BE FIXED TO COMPLY WITH TOLERANCES AS SPECIFIED IN SANS 2001 CC1.

FOUNDATION AND EARTHWORKS

- THE CIVIL ENGINEER SHALL INSPECT AND APPROVE ALL EXCAVATIONS AND BACK—FILLING PRIOR TO CASTING OF THE CONCRETE BLINDING LAYER
- 2. THE CONTRACTOR IS REFERED TO THE TECHNICAL SPECIFICATION WITH REGARDS TO DEALING WITH SERVICES
- TOP SOIL TO BE GRADED TO ENSURE THAT THE GROUND FOLLOWS THE ORIGINAL N.G.L..
- MAINTAINING THE SIDES OF THE EXCAVATIONS IN A SAFE CONDITION SHALL AT ALL TIMES BE THE SOLE RESPONSIBILITY OF THE CONTRACTOR. NO UNDER CUTTING OF THE SIDES WILL BE

		RE	VISIONS	
No	DATE	CHECKED	APPROVED	DESCRIPTION

REFERENCE DRAWINGS

NUMBER	TITLE		
RA_28432/001	SITE PLAN		
RA_28432/004	STORMWTER LAYOUT		
	I		



BOX 1127 JOHANNESBURG 2000 TEL: 011-682-0911

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CONTRACT No. RW D.O.M. C. TUMBARE DESIGNED BY MAMABOLO JM MAMABOLO JM REG. No. 20150256 MAY 2020 DATE

ZUIKERBOSCH PUMPING STATION WORKS AREA 2 (SYSTEM 4) FILTER SAND STORAGE FACILITY STORMWATER MANHOLES AND

 STATION
 WKS
 DOC. TYPE

 Z B
 2 4 U G X
 D C G

 SCALE AS SHOWN

DRG No. R028432/005

OUTLET STRUCTURES

FOR TENDER

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