



DRAWINGS




Architectural Drawings

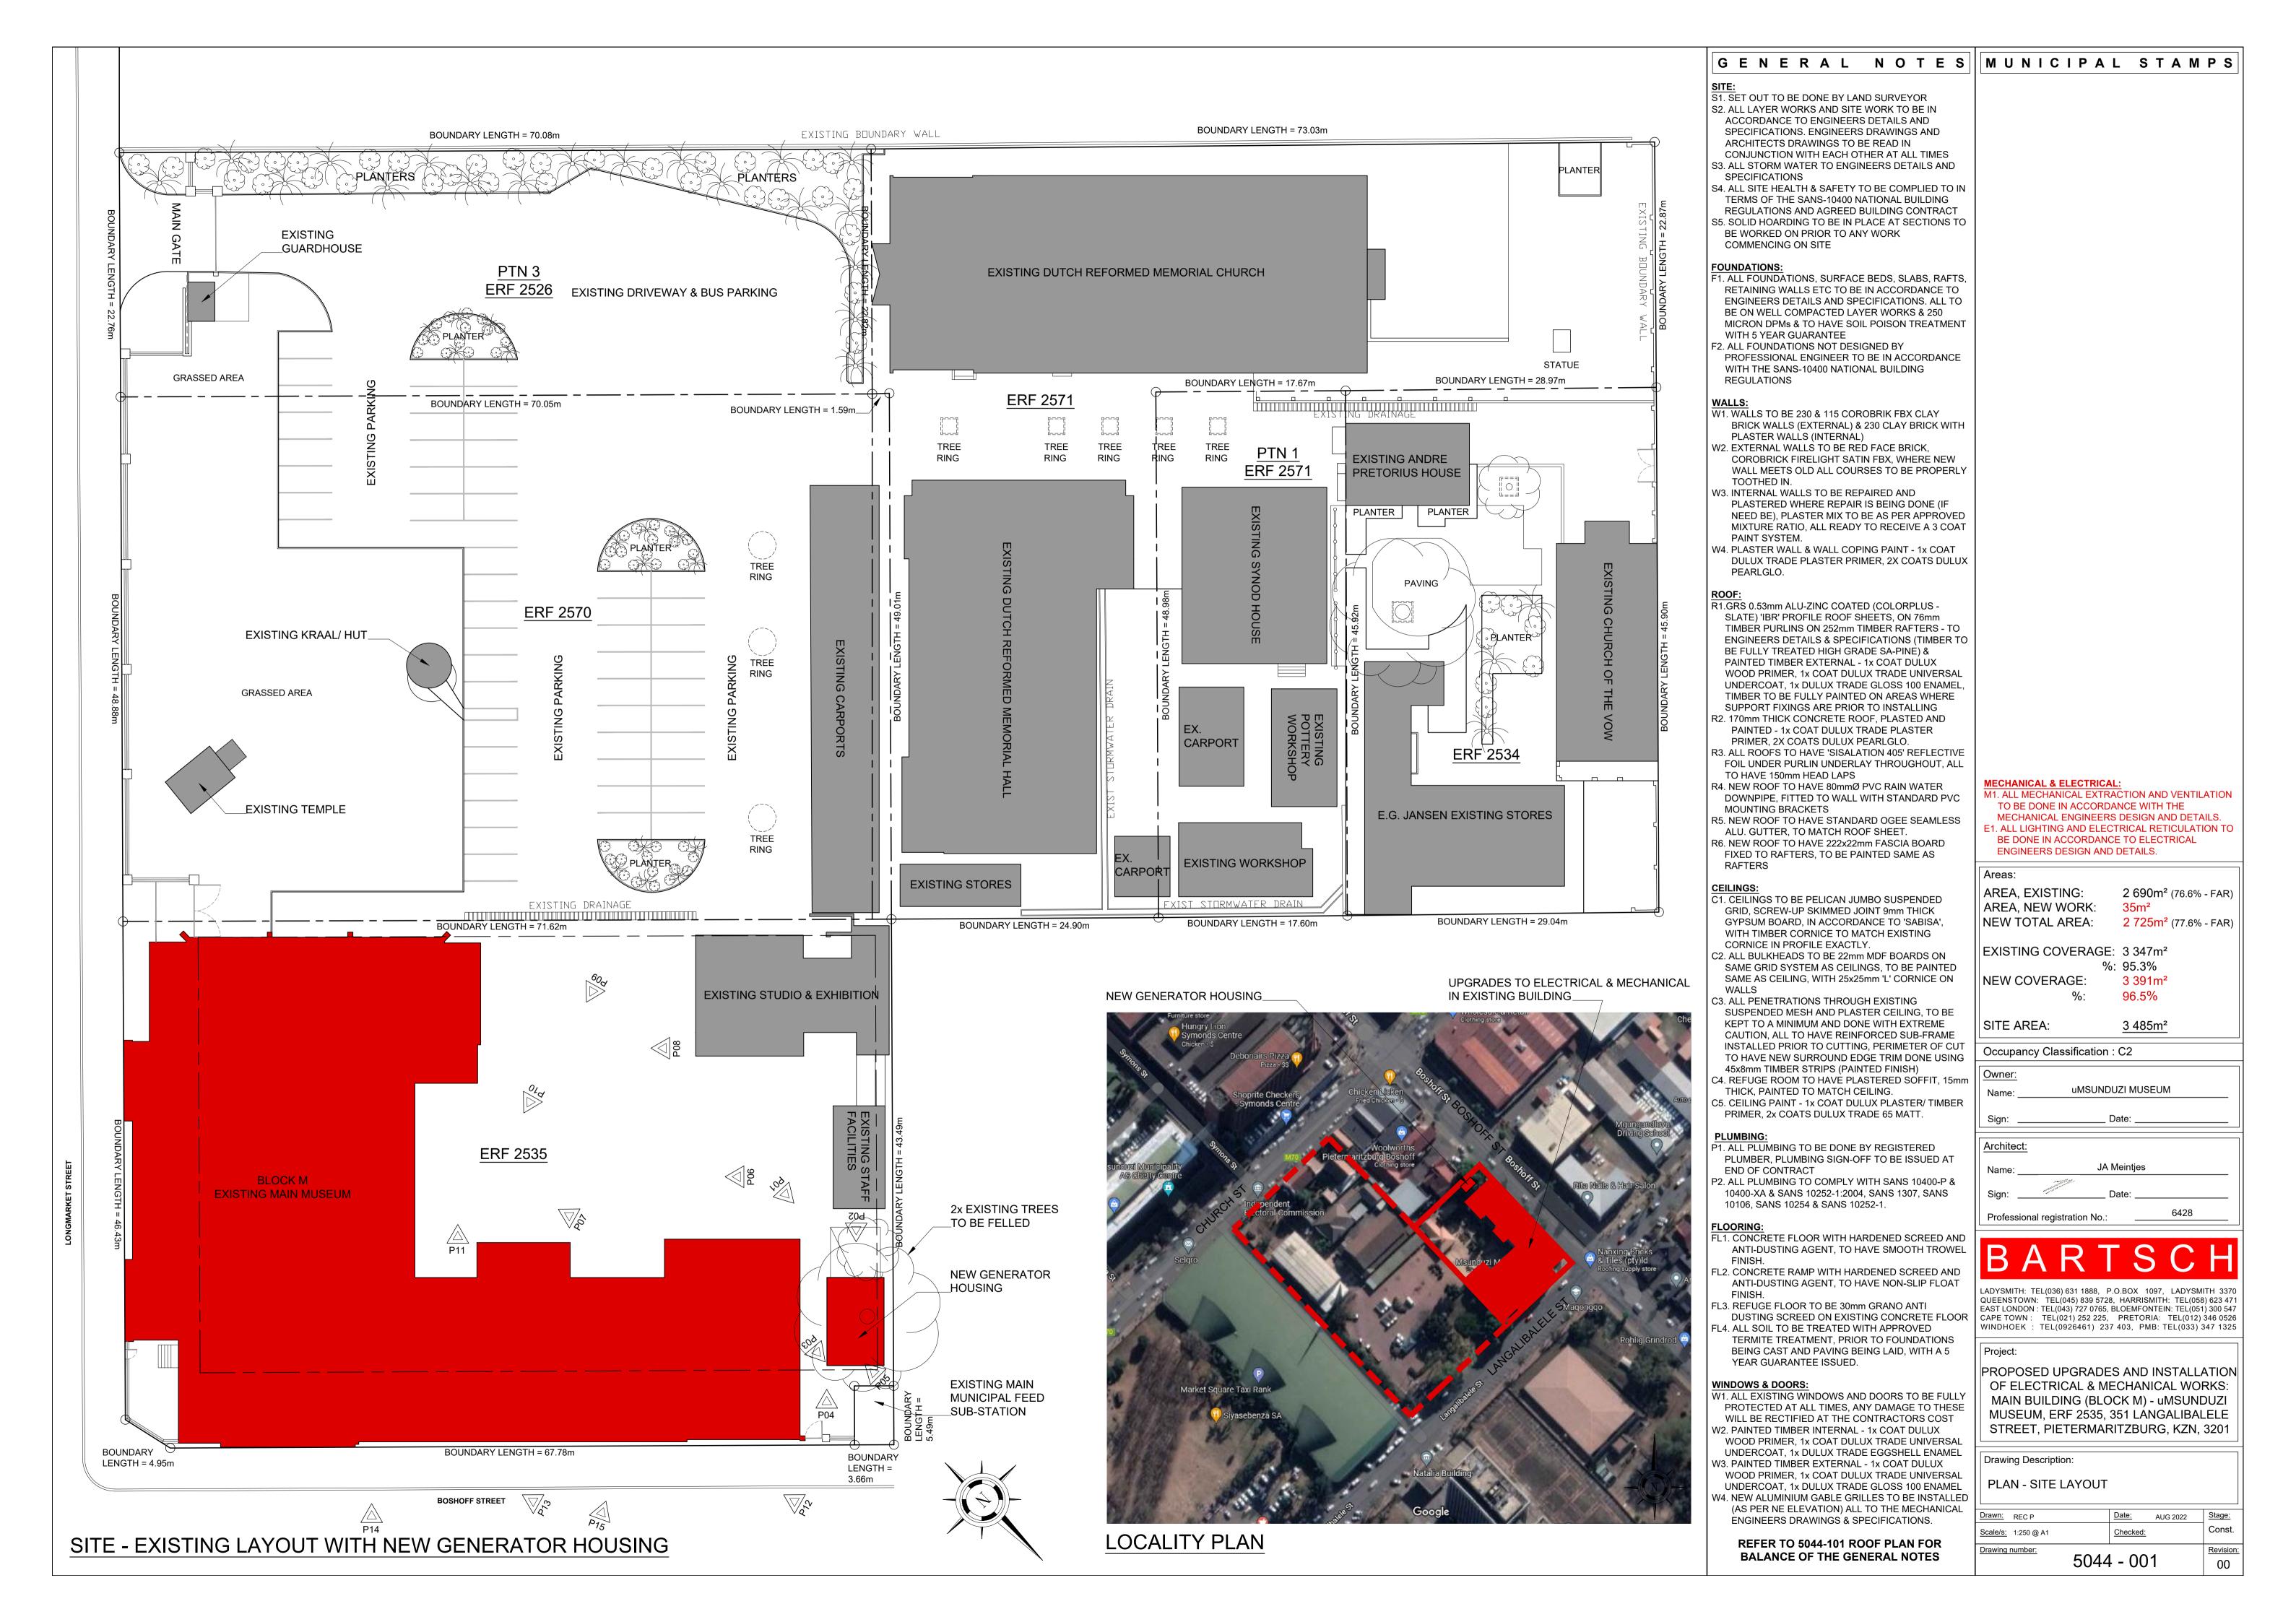

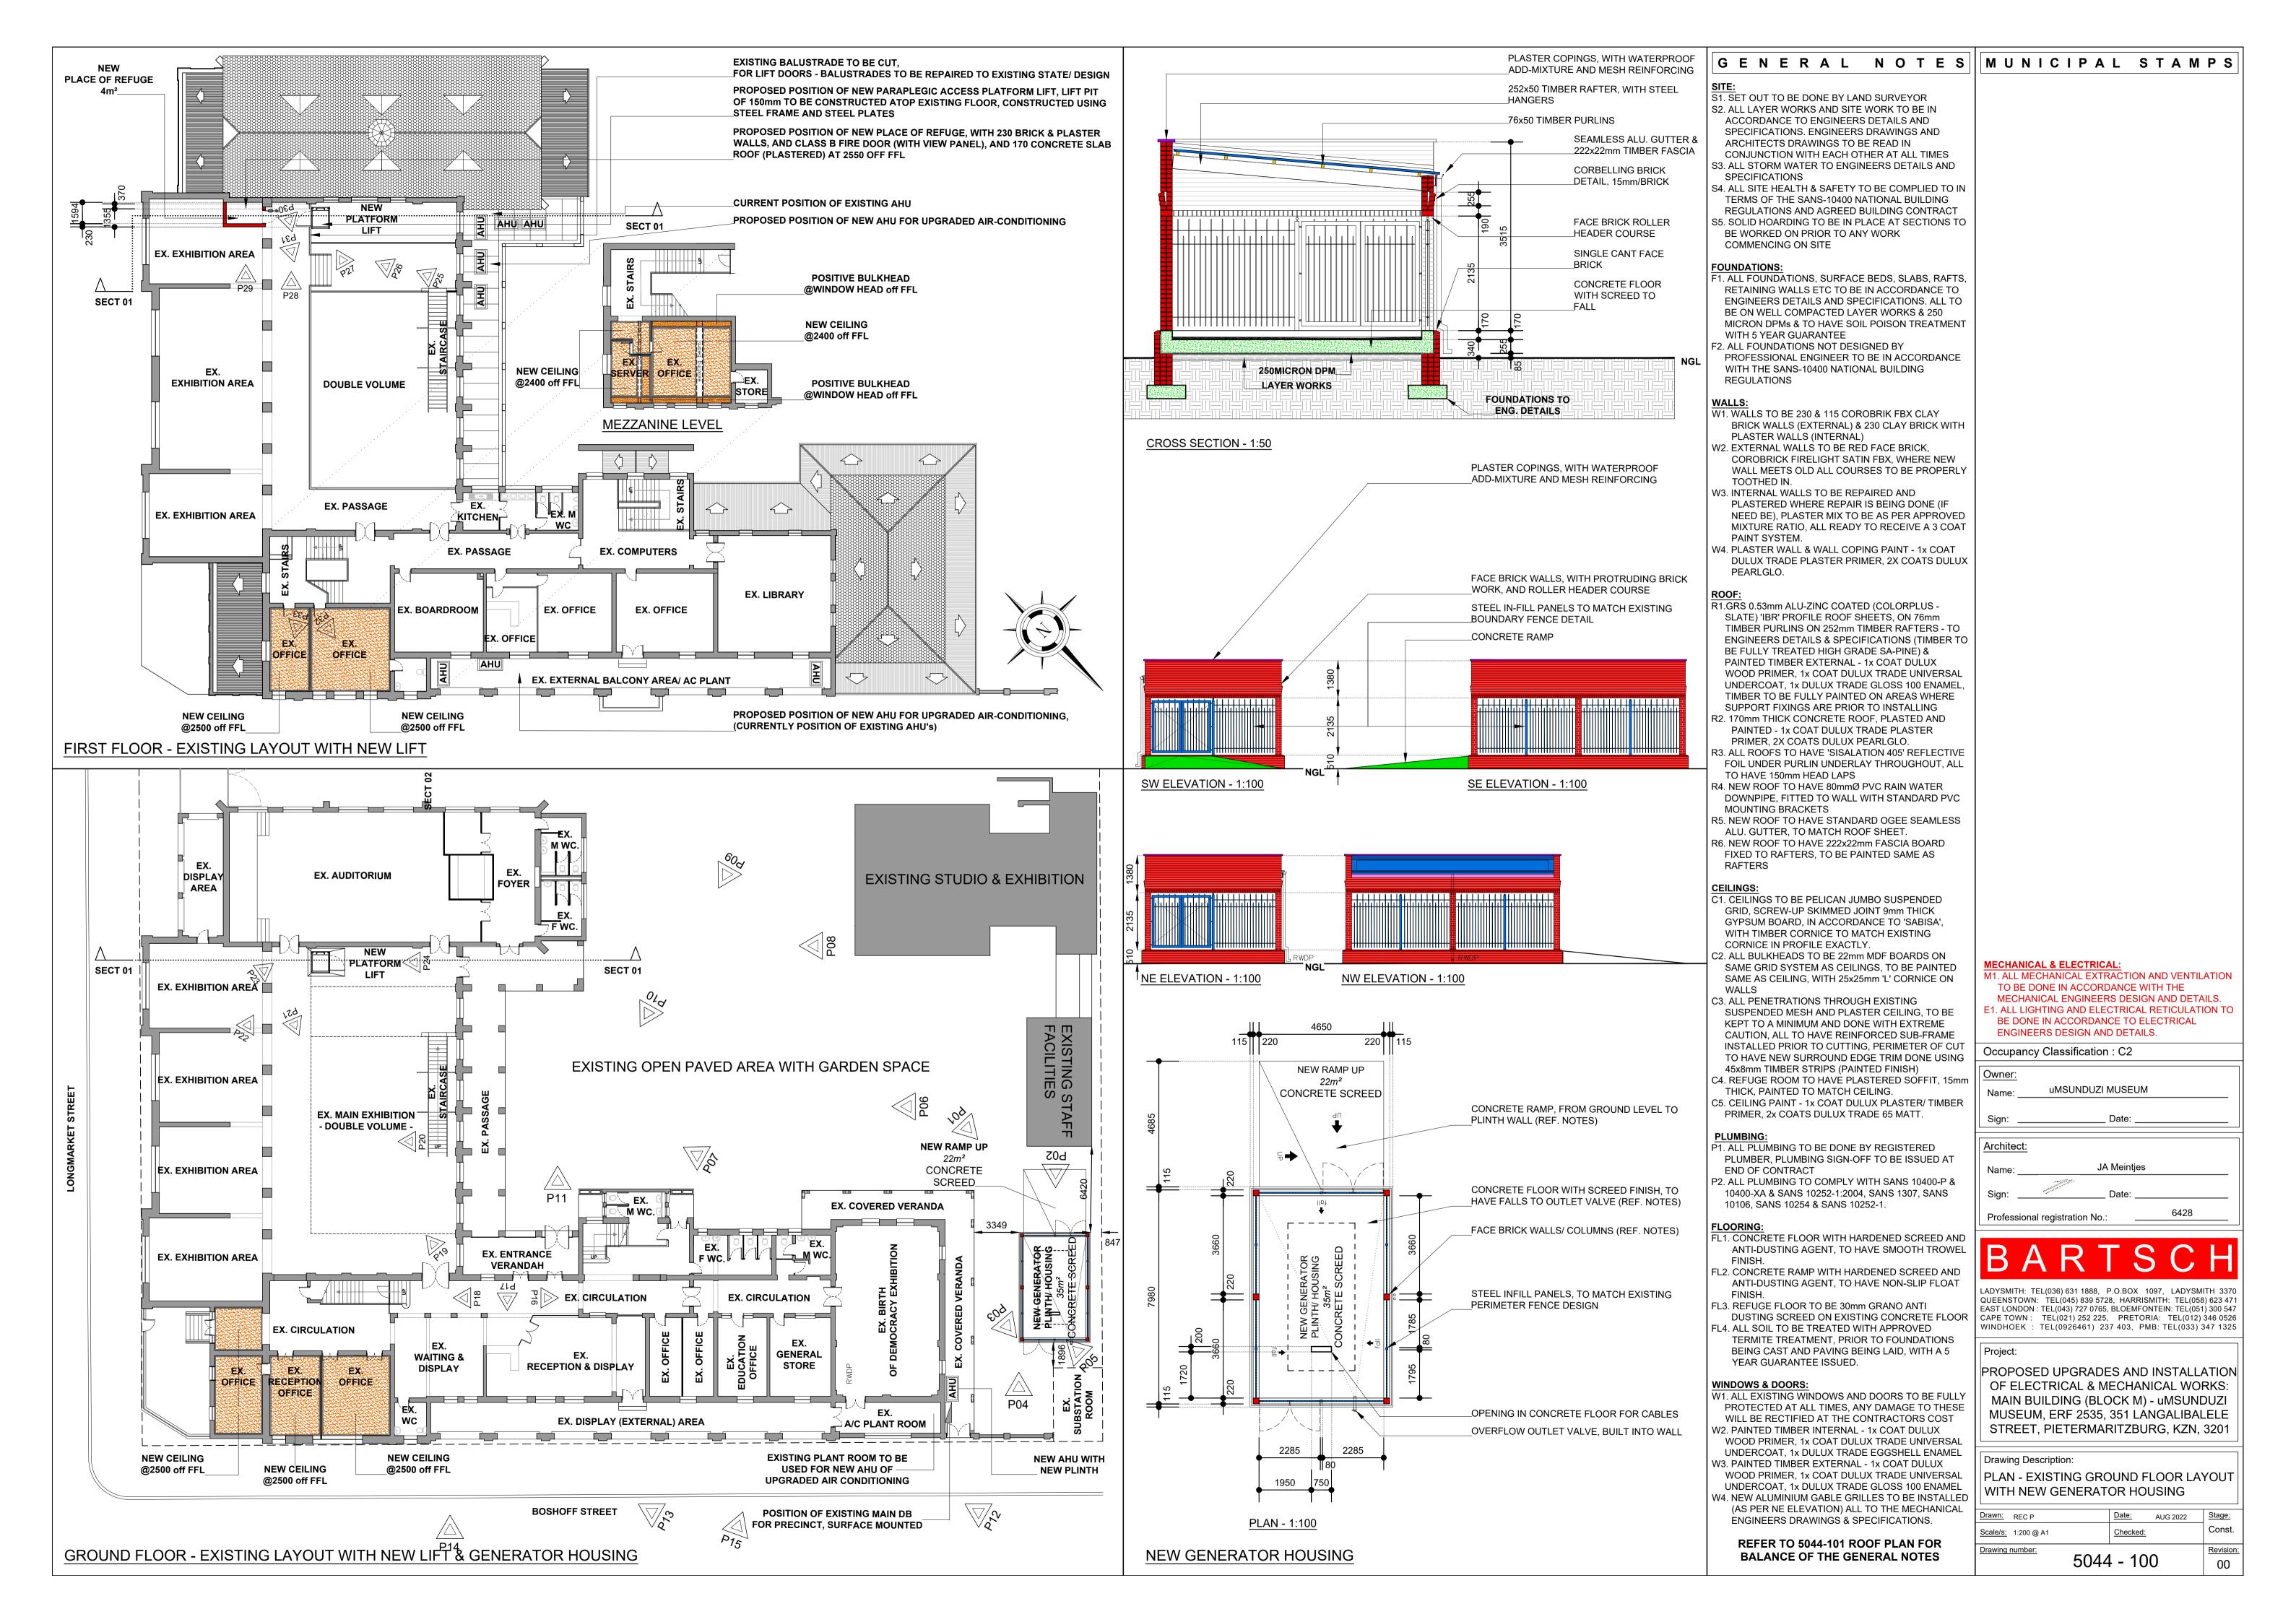



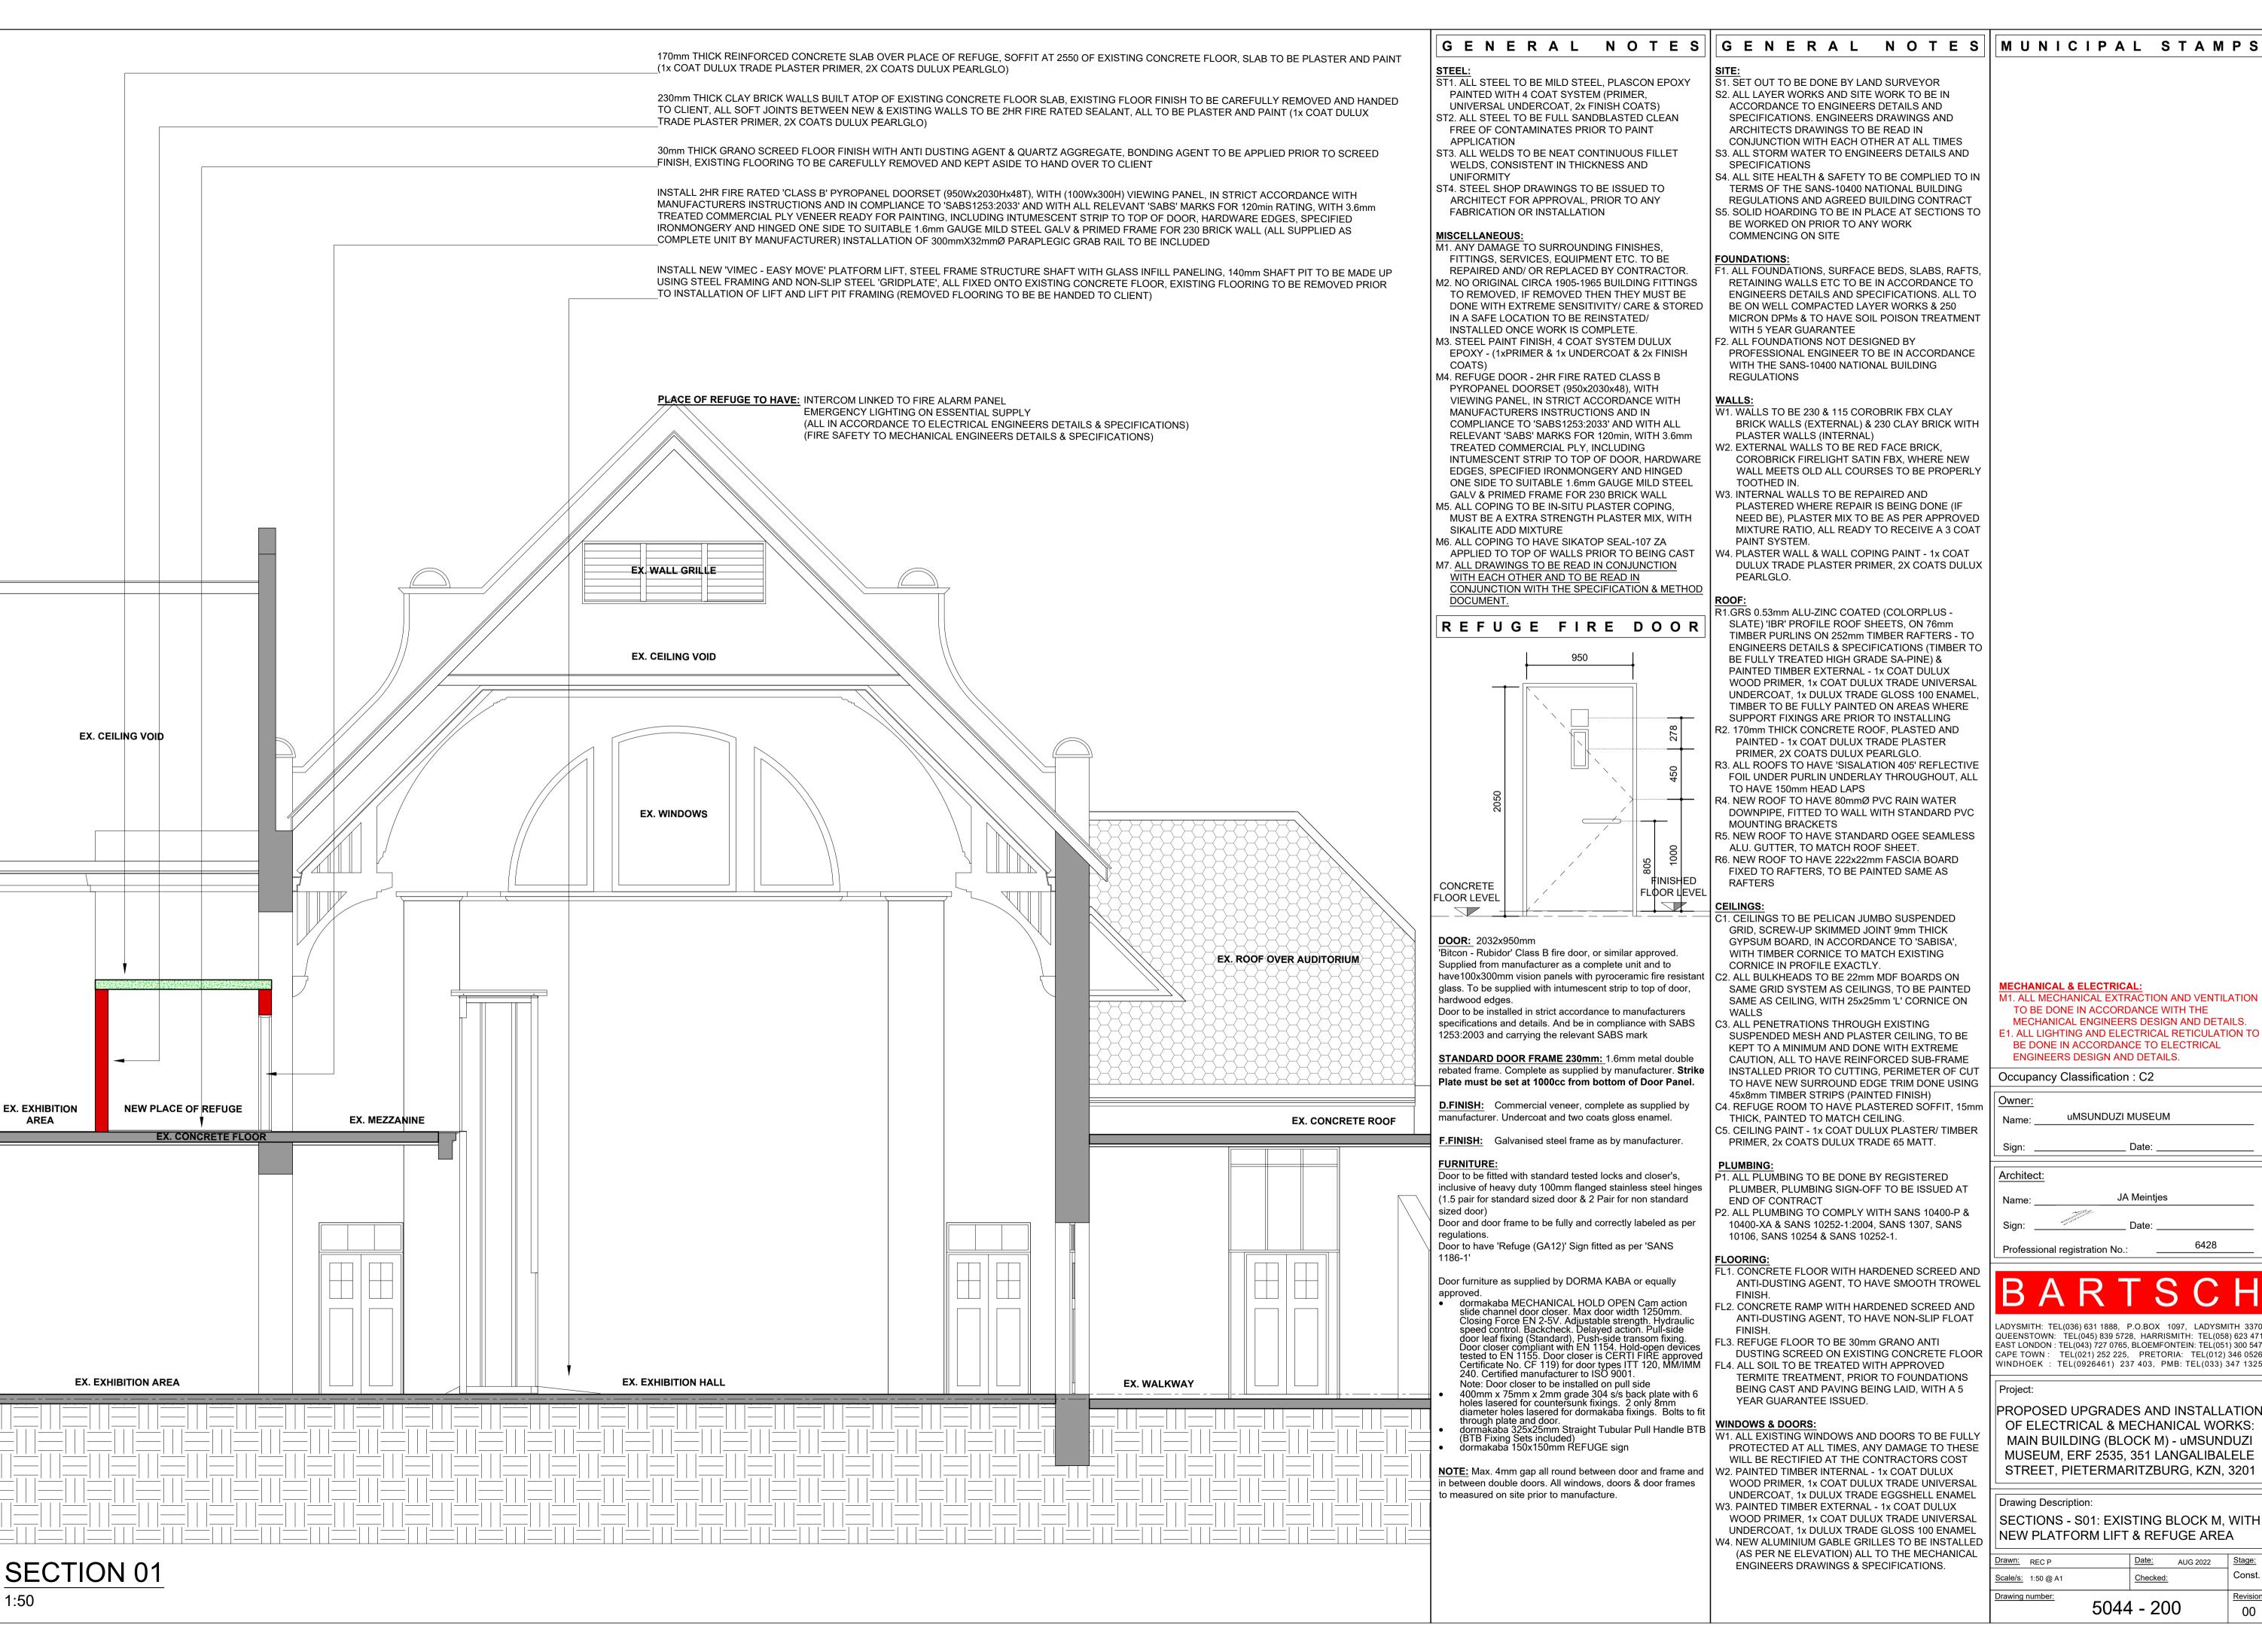

S2. ALL LAYER WORKS AND SITE WORK TO BE IN ACCORDANCE TO ENGINEERS DETAILS AND SPECIFICATIONS. ENGINEERS DRAWINGS AND CONJUNCTION WITH EACH OTHER AT ALL TIMES

S3. ALL STORM WATER TO ENGINEERS DETAILS AND S4. ALL SITE HEALTH & SAFETY TO BE COMPLIED TO IN

TERMS OF THE SANS-10400 NATIONAL BUILDING REGULATIONS AND AGREED BUILDING CONTRACT S5. SOLID HOARDING TO BE IN PLACE AT SECTIONS TO

RETAINING WALLS ETC TO BE IN ACCORDANCE TO ENGINEERS DETAILS AND SPECIFICATIONS. ALL TO BE ON WELL COMPACTED LAYER WORKS & 250 MICRON DPMs & TO HAVE SOIL POISON TREATMENT

PROFESSIONAL ENGINEER TO BE IN ACCORDANCE WITH THE SANS-10400 NATIONAL BUILDING

BRICK WALLS (EXTERNAL) & 230 CLAY BRICK WITH

COROBRICK FIRELIGHT SATIN FBX, WHERE NEW WALL MEETS OLD ALL COURSES TO BE PROPERLY

PLASTERED WHERE REPAIR IS BEING DONE (IF NEED BE), PLASTER MIX TO BE AS PER APPROVED MIXTURE RATIO, ALL READY TO RECEIVE A 3 COAT

DULUX TRADE PLASTER PRIMER, 2X COATS DULUX

SLATE) 'IBR' PROFILE ROOF SHEETS, ON 76mm TIMBER PURLINS ON 252mm TIMBER RAFTERS - TO **ENGINEERS DETAILS & SPECIFICATIONS (TIMBER TO** BE FULLY TREATED HIGH GRADE SA-PINE) & PAINTED TIMBER EXTERNAL - 1x COAT DULUX WOOD PRIMER, 1x COAT DULUX TRADE UNIVERSAL UNDERCOAT, 1x DULUX TRADE GLOSS 100 ENAMEL TIMBER TO BE FULLY PAINTED ON AREAS WHERE SUPPORT FIXINGS ARE PRIOR TO INSTALLING

R2. 170mm THICK CONCRETE ROOF, PLASTED AND PAINTED - 1x COAT DULUX TRADE PLASTER

R3. ALL ROOFS TO HAVE 'SISALATION 405' REFLECTIVE FOIL UNDER PURLIN UNDERLAY THROUGHOUT, ALL

DOWNPIPE, FITTED TO WALL WITH STANDARD PVC

R6. NEW ROOF TO HAVE 222x22mm FASCIA BOARD

C1. CEILINGS TO BE PELICAN JUMBO SUSPENDED GRID, SCREW-UP SKIMMED JOINT 9mm THICK GYPSUM BOARD, IN ACCORDANCE TO 'SABISA', WITH TIMBER CORNICE TO MATCH EXISTING

C2. ALL BULKHEADS TO BE 22mm MDF BOARDS ON SAME GRID SYSTEM AS CEILINGS, TO BE PAINTED SAME AS CEILING, WITH 25x25mm 'L' CORNICE ON

SUSPENDED MESH AND PLASTER CEILING, TO BE KEPT TO A MINIMUM AND DONE WITH EXTREME CAUTION, ALL TO HAVE REINFORCED SUB-FRAME INSTALLED PRIOR TO CUTTING, PERIMETER OF CUT TO HAVE NEW SURROUND EDGE TRIM DONE USING

C4. REFUGE ROOM TO HAVE PLASTERED SOFFIT, 15mm

PLUMBER, PLUMBING SIGN-OFF TO BE ISSUED AT

FL1. CONCRETE FLOOR WITH HARDENED SCREED AND ANTI-DUSTING AGENT, TO HAVE SMOOTH TROWEL

ANTI-DUSTING AGENT, TO HAVE NON-SLIP FLOAT L3. REFUGE FLOOR TO BE 30mm GRANO ANTI

DUSTING SCREED ON EXISTING CONCRETE FLOOR L4. ALL SOIL TO BE TREATED WITH APPROVED TERMITE TREATMENT, PRIOR TO FOUNDATIONS BEING CAST AND PAVING BEING LAID, WITH A 5

W1. ALL EXISTING WINDOWS AND DOORS TO BE FULLY PROTECTED AT ALL TIMES, ANY DAMAGE TO THESE WILL BE RECTIFIED AT THE CONTRACTORS COST W2. PAINTED TIMBER INTERNAL - 1x COAT DULUX WOOD PRIMER, 1x COAT DULUX TRADE UNIVERSAL

UNDERCOAT, 1x DULUX TRADE EGGSHELL ENAMEL W3. PAINTED TIMBER EXTERNAL - 1x COAT DULUX WOOD PRIMER, 1x COAT DULUX TRADE UNIVERSAL UNDERCOAT, 1x DULUX TRADE GLOSS 100 ENAMEL

(AS PER NE ELEVATION) ALL TO THE MECHANICAL **ENGINEERS DRAWINGS & SPECIFICATIONS.**

MECHANICAL & ELECTRICAL

M1. ALL MECHANICAL EXTRACTION AND VENTILATION TO BE DONE IN ACCORDANCE WITH THE

MECHANICAL ENGINEERS DESIGN AND DETAILS. E1. ALL LIGHTING AND ELECTRICAL RETICULATION TO BE DONE IN ACCORDANCE TO ELECTRICAL ENGINEERS DESIGN AND DETAILS.

Occupancy Classification : C2

Professional registration No.:


Owner:		
Name:	uMSUNDUZI MUSEUM	
Sign:	Date:	
Architect:		
Name:	JA Meintjes	


_ADYSMITH: TEL(036) 631 1888, P.O.BOX 1097, LADYSMITH 3370 QUEENSTOWN: TEL(045) 839 5728, HARRISMITH: TEL(058) 623 471 EAST LONDON : TEL(043) 727 0765, BLOEMFONTEIN: TEL(051) 300 547 CAPE TOWN: TEL(021) 252 225, PRETORIA: TEL(012) 346 0526 WINDHOEK: TEL(0926461) 237 403, PMB: TEL(033) 347 1325

PROPOSED UPGRADES AND INSTALLATION OF ELECTRICAL & MECHANICAL WORKS: MAIN BUILDING (BLOCK M) - uMSUNDUZI MUSEUM, ERF 2535, 351 LANGALIBALELE STREET, PIETERMARITZBURG, KZN, 3201

Drawing Description: SECTIONS - S01: EXISTING BLOCK M, WITH NEW PLATFORM LIFT & REFUGE AREA

<u>Drawn:</u> REC P <u>Scale/s:</u> 1:50 @ A1	Date: AUG 20 Checked:	Stage: Const.
Drawing number: 5044	l - 200	Revision: 00

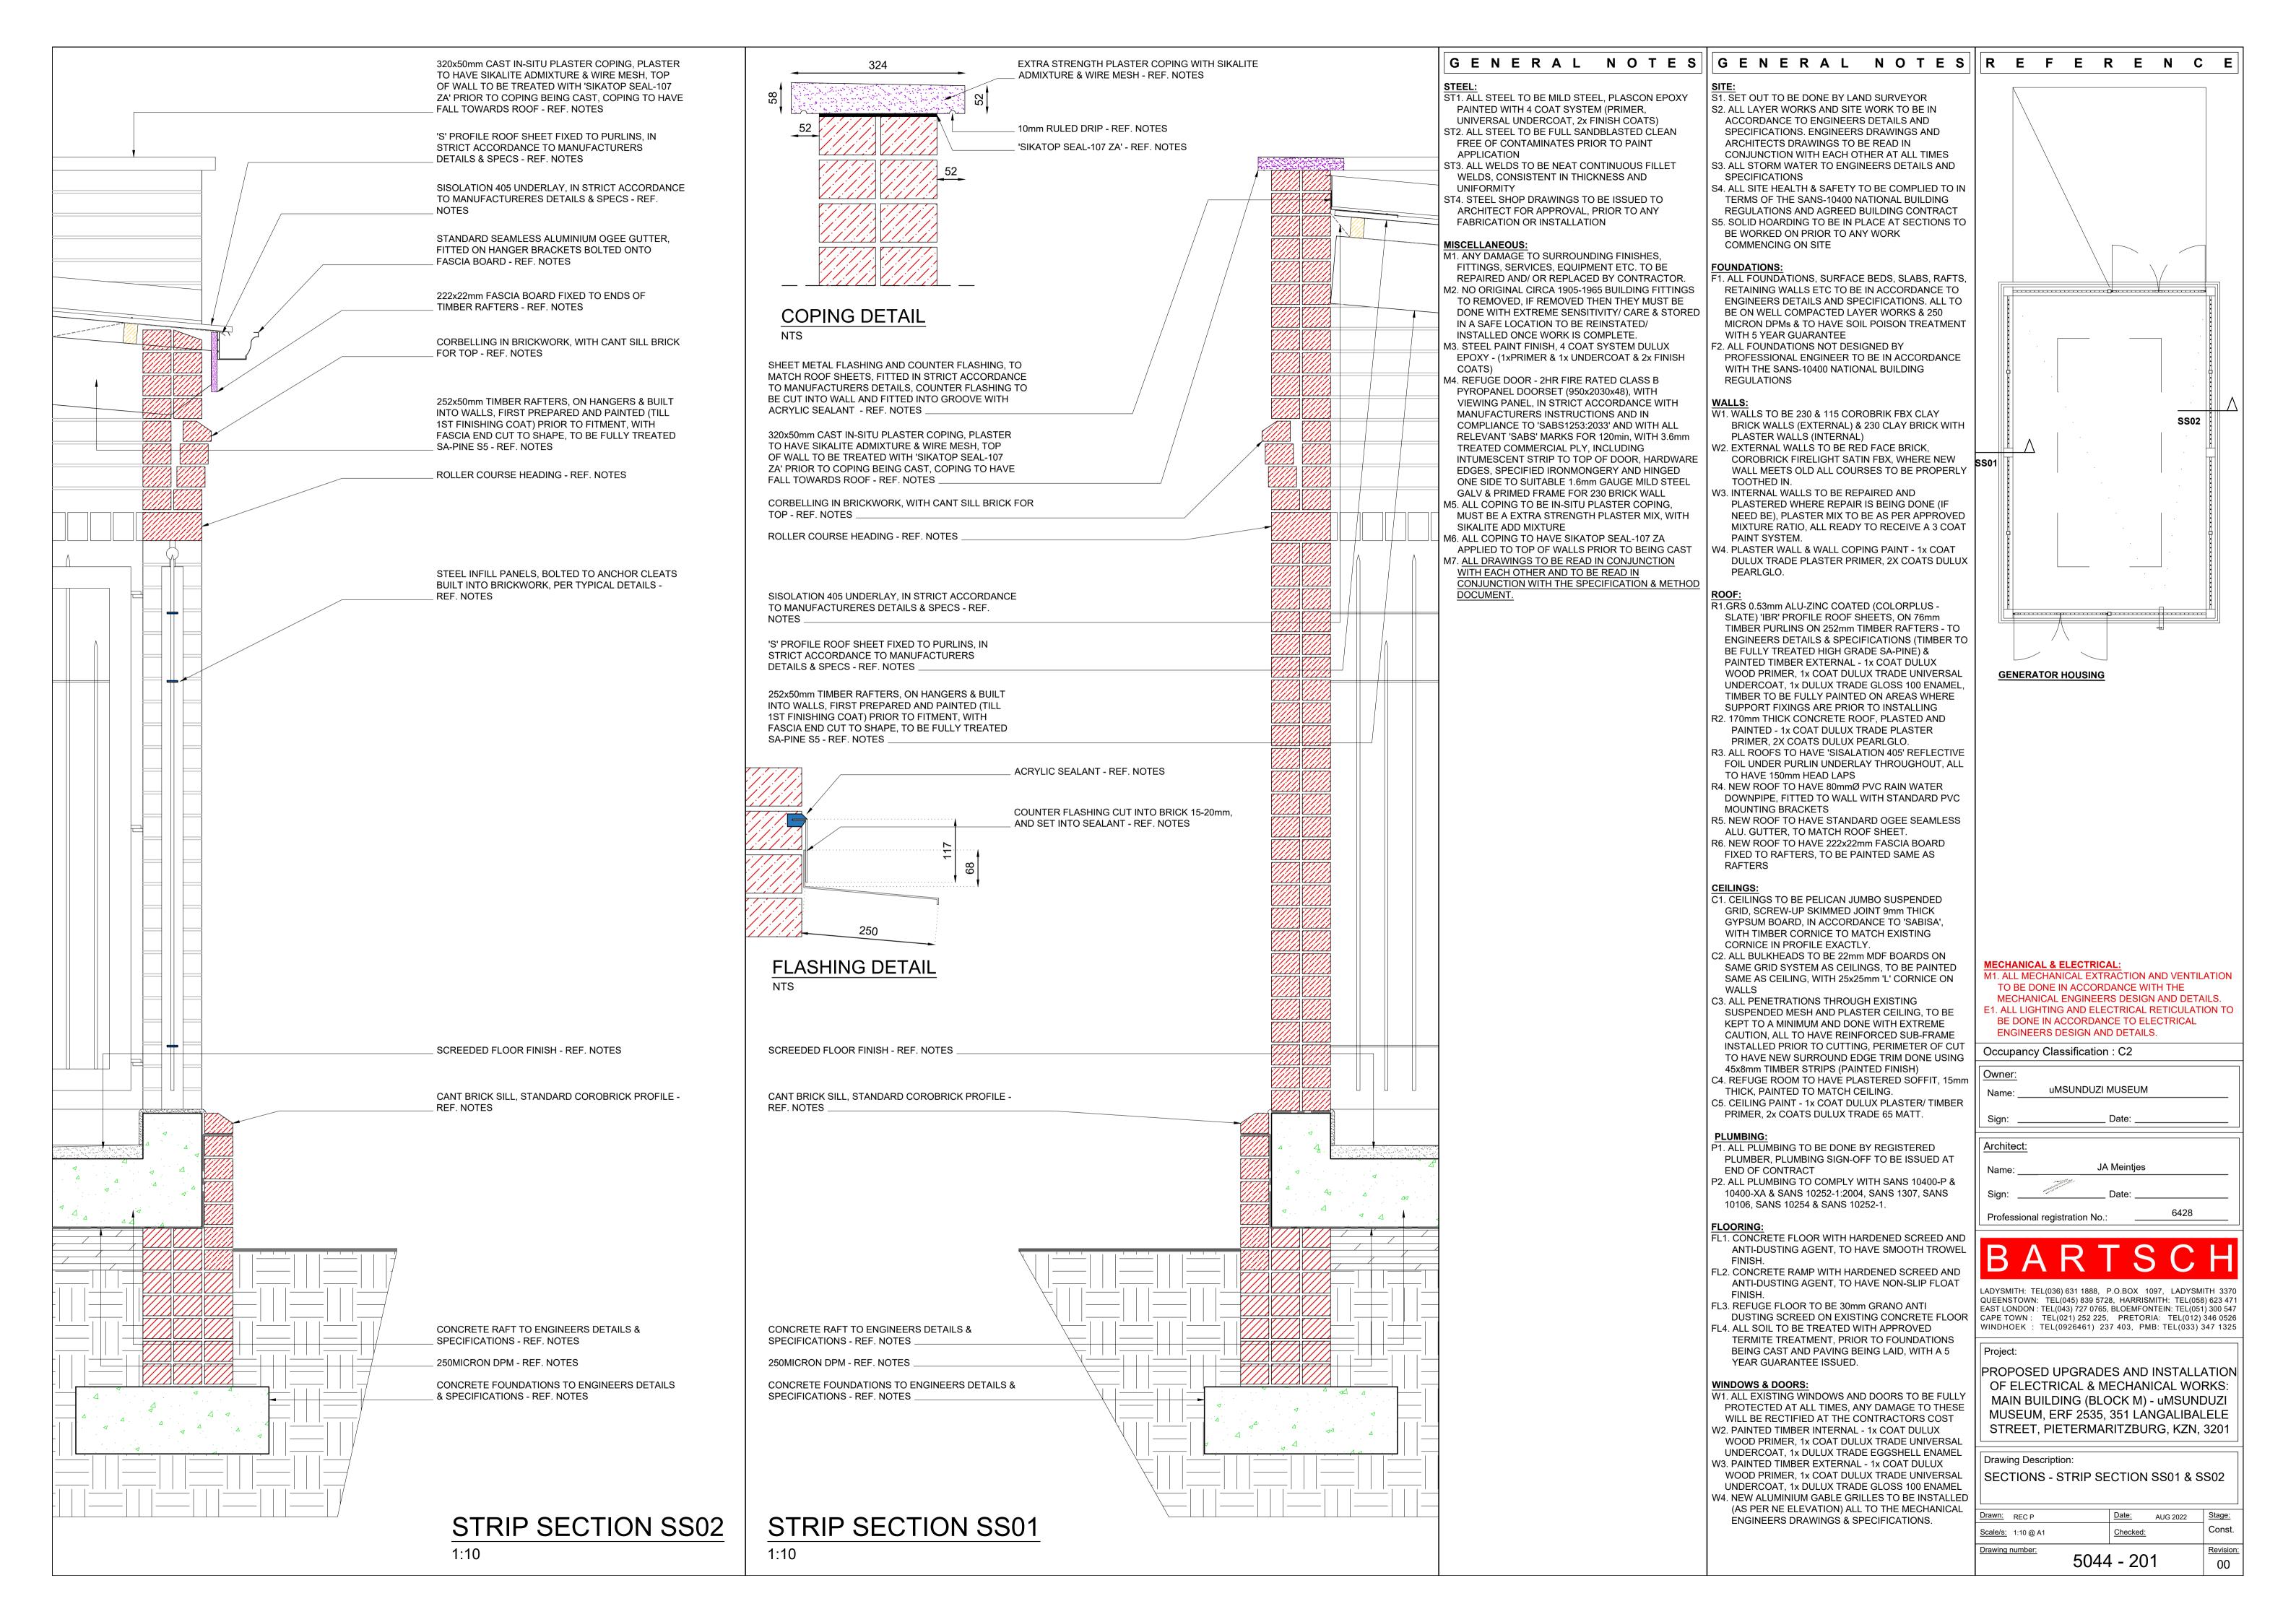

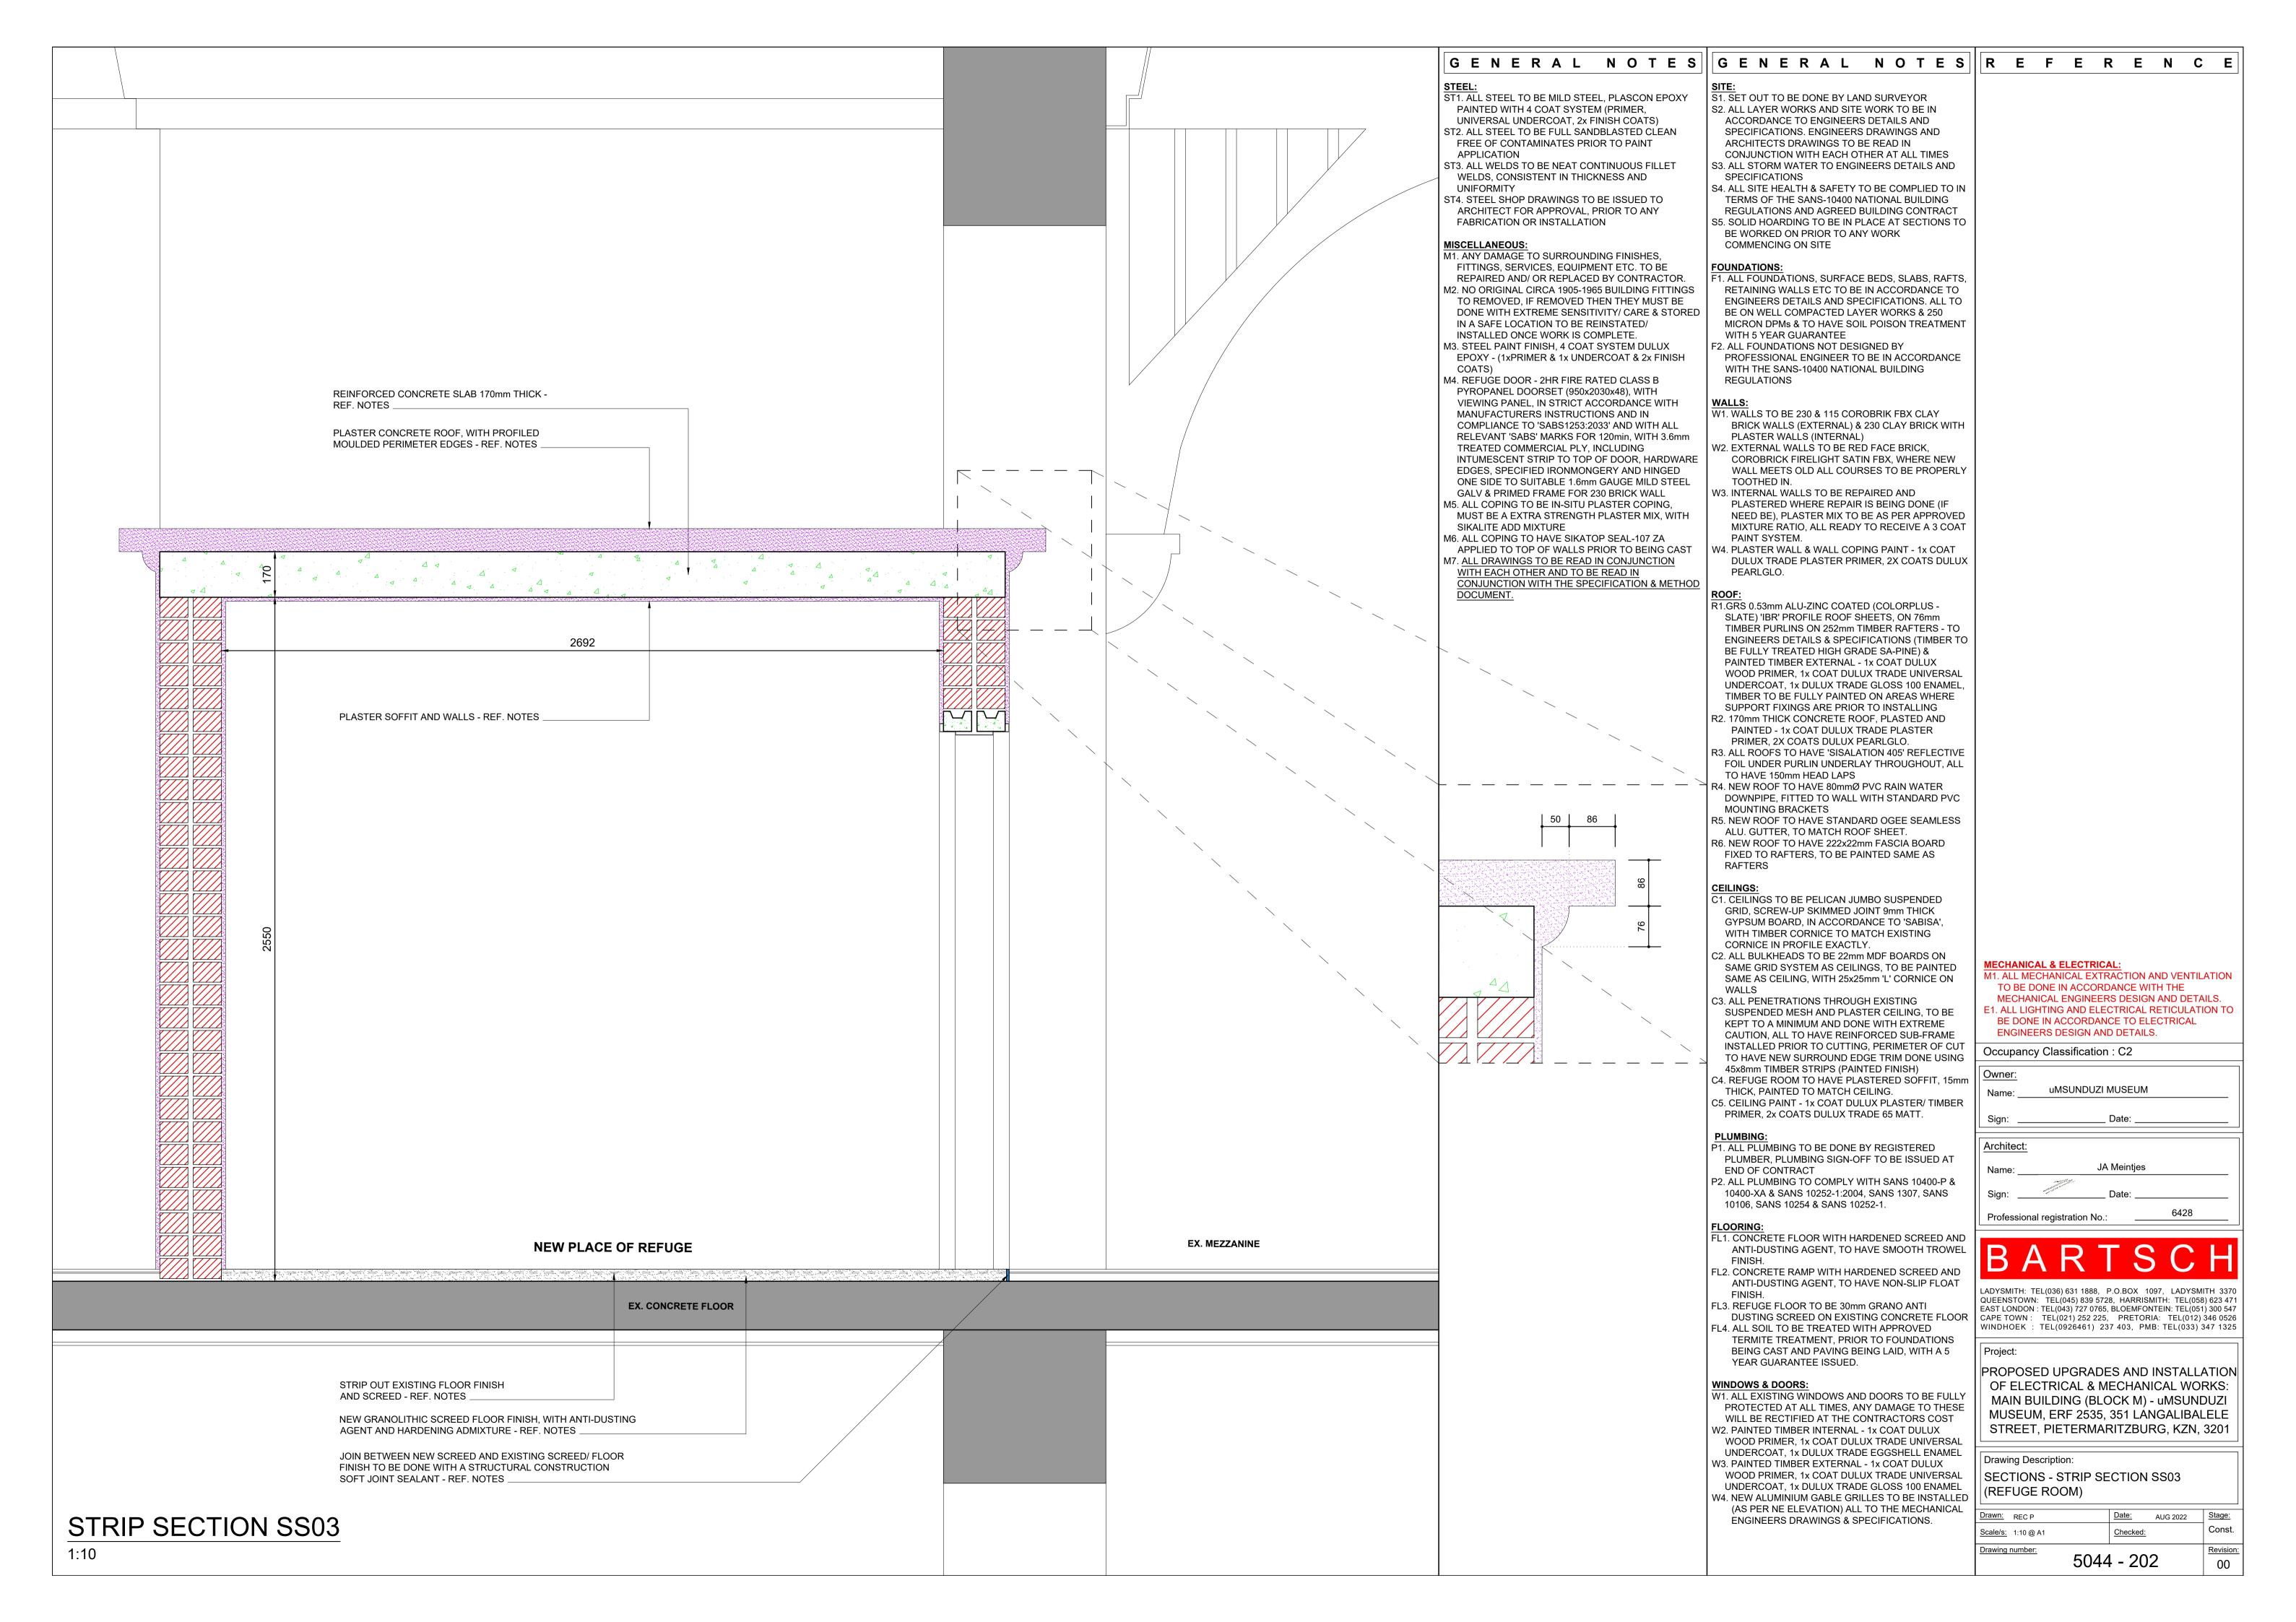

NO CHANGE TO EXISTING ELEVATION

NO CHANGE TO EXISTING ELEVATION

ST1. ALL STEEL TO BE MILD STEEL, PLASCON EPOXY PAINTED WITH 4 COAT SYSTEM (PRIMER.

GENERAL NOTES I

UNIVERSAL UNDERCOAT, 2x FINISH COATS) ST2. ALL STEEL TO BE FULL SANDBLASTED CLEAN FREE OF CONTAMINATES PRIOR TO PAINT APPLICATION

ST3. ALL WELDS TO BE NEAT CONTINUOUS FILLET WELDS, CONSISTENT IN THICKNESS AND UNIFORMITY

ST4. STEEL SHOP DRAWINGS TO BE ISSUED TO ARCHITECT FOR APPROVAL, PRIOR TO ANY FABRICATION OR INSTALLATION

MISCELLANEOUS:

M1. ANY DAMAGE TO SURROUNDING FINISHES, FITTINGS, SERVICES, EQUIPMENT ETC. TO BE REPAIRED AND/ OR REPLACED BY CONTRACTOR. M2. NO ORIGINAL CIRCA 1905-1965 BUILDING FITTINGS

TO REMOVED. IF REMOVED THEN THEY MUST BE DONE WITH EXTREME SENSITIVITY/ CARE & STORED IN A SAFE LOCATION TO BE REINSTATED/ INSTALLED ONCE WORK IS COMPLETE. M3. STEEL PAINT FINISH, 4 COAT SYSTEM DULUX

EPOXY - (1xPRIMER & 1x UNDERCOAT & 2x FINISH

M4. REFUGE DOOR - 2HR FIRE RATED CLASS B PYROPANEL DOORSET (950x2030x48), WITH VIEWING PANEL, IN STRICT ACCORDANCE WITH MANUFACTURERS INSTRUCTIONS AND IN COMPLIANCE TO 'SABS1253:2033' AND WITH ALL RELEVANT 'SABS' MARKS FOR 120min, WITH 3.6mm TREATED COMMERCIAL PLY, INCLUDING INTUMESCENT STRIP TO TOP OF DOOR, HARDWARE EDGES. SPECIFIED IRONMONGERY AND HINGED ONE SIDE TO SUITABLE 1.6mm GAUGE MILD STEEL GALV & PRIMED FRAME FOR 230 BRICK WALL

M5. ALL COPING TO BE IN-SITU PLASTER COPING, MUST BE A EXTRA STRENGTH PLASTER MIX, WITH SIKALITE ADD MIXTURE

M6. ALL COPING TO HAVE SIKATOP SEAL-107 ZA APPLIED TO TOP OF WALLS PRIOR TO BEING CAST M7. ALL DRAWINGS TO BE READ IN CONJUNCTION

WITH EACH OTHER AND TO BE READ IN CONJUNCTION WITH THE SPECIFICATION & METHOD DOCUMENT.

S1. SET OUT TO BE DONE BY LAND SURVEYOR S2. ALL LAYER WORKS AND SITE WORK TO BE IN ACCORDANCE TO ENGINEERS DETAILS AND SPECIFICATIONS. ENGINEERS DRAWINGS AND ARCHITECTS DRAWINGS TO BE READ IN CONJUNCTION WITH EACH OTHER AT ALL TIMES

S3. ALL STORM WATER TO ENGINEERS DETAILS AND **SPECIFICATIONS**

S4. ALL SITE HEALTH & SAFETY TO BE COMPLIED TO IN TERMS OF THE SANS-10400 NATIONAL BUILDING REGULATIONS AND AGREED BUILDING CONTRACT

GENERAL NOTES MUNICIPAL STAMPS

S5. SOLID HOARDING TO BE IN PLACE AT SECTIONS TO BE WORKED ON PRIOR TO ANY WORK COMMENCING ON SITE

FOUNDATIONS:

F1. ALL FOUNDATIONS, SURFACE BEDS, SLABS, RAFTS, RETAINING WALLS ETC TO BE IN ACCORDANCE TO ENGINEERS DETAILS AND SPECIFICATIONS. ALL TO BE ON WELL COMPACTED LAYER WORKS & 250 MICRON DPMs & TO HAVE SOIL POISON TREATMENT WITH 5 YEAR GUARANTEE

F2. ALL FOUNDATIONS NOT DESIGNED BY PROFESSIONAL ENGINEER TO BE IN ACCORDANCE WITH THE SANS-10400 NATIONAL BUILDING REGULATIONS

WALLS:

W1. WALLS TO BE 230 & 115 COROBRIK FBX CLAY BRICK WALLS (EXTERNAL) & 230 CLAY BRICK WITH PLASTER WALLS (INTERNAL)

W2. EXTERNAL WALLS TO BE RED FACE BRICK. COROBRICK FIRELIGHT SATIN FBX, WHERE NEW WALL MEETS OLD ALL COURSES TO BE PROPERLY TOOTHED IN.

W3. INTERNAL WALLS TO BE REPAIRED AND PLASTERED WHERE REPAIR IS BEING DONE (IF NEED BE), PLASTER MIX TO BE AS PER APPROVED MIXTURE RATIO, ALL READY TO RECEIVE A 3 COAT PAINT SYSTEM.

W4. PLASTER WALL & WALL COPING PAINT - 1x COAT DULUX TRADE PLASTER PRIMER, 2X COATS DULUX PEARLGLO.

R1.GRS 0.53mm ALU-ZINC COATED (COLORPLUS -SLATE) 'IBR' PROFILE ROOF SHEETS, ON 76mm TIMBER PURLINS ON 252mm TIMBER RAFTERS - TO ENGINEERS DETAILS & SPECIFICATIONS (TIMBER TO BE FULLY TREATED HIGH GRADE SA-PINE) & PAINTED TIMBER EXTERNAL - 1x COAT DULUX WOOD PRIMER, 1x COAT DULUX TRADE UNIVERSAL UNDERCOAT, 1x DULUX TRADE GLOSS 100 ENAMEL TIMBER TO BE FULLY PAINTED ON AREAS WHERE SUPPORT FIXINGS ARE PRIOR TO INSTALLING

R2. 170mm THICK CONCRETE ROOF, PLASTED AND PAINTED - 1x COAT DULUX TRADE PLASTER PRIMER, 2X COATS DULUX PEARLGLO.

R3. ALL ROOFS TO HAVE 'SISALATION 405' REFLECTIVE FOIL UNDER PURLIN UNDERLAY THROUGHOUT, ALL TO HAVE 150mm HEAD LAPS

R4. NEW ROOF TO HAVE 80mmØ PVC RAIN WATER DOWNPIPE, FITTED TO WALL WITH STANDARD PVC MOUNTING BRACKETS R5. NEW ROOF TO HAVE STANDARD OGEE SEAMLESS

ALU. GUTTER, TO MATCH ROOF SHEET. R6. NEW ROOF TO HAVE 222x22mm FASCIA BOARD FIXED TO RAFTERS, TO BE PAINTED SAME AS

CEILINGS:

C1. CEILINGS TO BE PELICAN JUMBO SUSPENDED GRID, SCREW-UP SKIMMED JOINT 9mm THICK GYPSUM BOARD, IN ACCORDANCE TO 'SABISA', WITH TIMBER CORNICE TO MATCH EXISTING CORNICE IN PROFILE EXACTLY.

C2. ALL BULKHEADS TO BE 22mm MDF BOARDS ON SAME GRID SYSTEM AS CEILINGS, TO BE PAINTED SAME AS CEILING, WITH 25x25mm 'L' CORNICE ON WALLS

C3. ALL PENETRATIONS THROUGH EXISTING SUSPENDED MESH AND PLASTER CEILING, TO BE KEPT TO A MINIMUM AND DONE WITH EXTREME CAUTION, ALL TO HAVE REINFORCED SUB-FRAME INSTALLED PRIOR TO CUTTING, PERIMETER OF CUT TO HAVE NEW SURROUND EDGE TRIM DONE USING 45x8mm TIMBER STRIPS (PAINTED FINISH)

C4. REFUGE ROOM TO HAVE PLASTERED SOFFIT, 15mm THICK, PAINTED TO MATCH CEILING.

C5. CEILING PAINT - 1x COAT DULUX PLASTER/ TIMBER PRIMER, 2x COATS DULUX TRADE 65 MATT.

P1. ALL PLUMBING TO BE DONE BY REGISTERED PLUMBER, PLUMBING SIGN-OFF TO BE ISSUED AT **END OF CONTRACT**

P2. ALL PLUMBING TO COMPLY WITH SANS 10400-P & 10400-XA & SANS 10252-1:2004, SANS 1307, SANS 10106, SANS 10254 & SANS 10252-1.

FL1. CONCRETE FLOOR WITH HARDENED SCREED AND ANTI-DUSTING AGENT, TO HAVE SMOOTH TROWEL

FL2. CONCRETE RAMP WITH HARDENED SCREED AND ANTI-DUSTING AGENT, TO HAVE NON-SLIP FLOAT

BEING CAST AND PAVING BEING LAID, WITH A 5

FL3. REFUGE FLOOR TO BE 30mm GRANO ANTI DUSTING SCREED ON EXISTING CONCRETE FLOOR FL4. ALL SOIL TO BE TREATED WITH APPROVED TERMITE TREATMENT, PRIOR TO FOUNDATIONS

WINDOWS & DOORS:

YEAR GUARANTEE ISSUED.

W1. ALL EXISTING WINDOWS AND DOORS TO BE FULLY PROTECTED AT ALL TIMES, ANY DAMAGE TO THESE

WILL BE RECTIFIED AT THE CONTRACTORS COST W2. PAINTED TIMBER INTERNAL - 1x COAT DULUX WOOD PRIMER, 1x COAT DULUX TRADE UNIVERSAL UNDERCOAT, 1x DULUX TRADE EGGSHELL ENAMEL W3. PAINTED TIMBER EXTERNAL - 1x COAT DULUX

WOOD PRIMER, 1x COAT DULUX TRADE UNIVERSAL UNDERCOAT, 1x DULUX TRADE GLOSS 100 ENAMEL W4. NEW ALUMINIUM GABLE GRILLES TO BE INSTALLED (AS PER NE ELEVATION) ALL TO THE MECHANICAL

ENGINEERS DRAWINGS & SPECIFICATIONS.

MECHANICAL & ELECTRICAL: M1. ALL MECHANICAL EXTRACTION AND VENTILATION

TO BE DONE IN ACCORDANCE WITH THE MECHANICAL ENGINEERS DESIGN AND DETAILS. E1. ALL LIGHTING AND ELECTRICAL RETICULATION TO BE DONE IN ACCORDANCE TO ELECTRICAL

Occupancy Classification : C2

Professional registration No.:

ENGINEERS DESIGN AND DETAILS.

Owner:		
Name:	uMSUNDUZI MUSEUM	
Sign:	Date:	
Architect:		
Name:	JA Meintjes	

_ADYSMITH: TEL(036) 631 1888, P.O.BOX 1097, LADYSMITH 3370 QUEENSTOWN: TEL(045) 839 5728, HARRISMITH: TEL(058) 623 471 EAST LONDON : TEL(043) 727 0765, BLOEMFONTEIN: TEL(051) 300 547 CAPE TOWN: TEL(021) 252 225, PRETORIA: TEL(012) 346 0526 WINDHOEK: TEL(0926461) 237 403, PMB: TEL(033) 347 1325

PROPOSED UPGRADES AND INSTALLATION OF ELECTRICAL & MECHANICAL WORKS: MAIN BUILDING (BLOCK M) - uMSUNDUZI MUSEUM, ERF 2535, 351 LANGALIBALELE STREET, PIETERMARITZBURG, KZN, 3201

Drawing Description:

ELEVATIONS - EXISTING ELEVATIONS FOR BLOCK M


Drawn: REC P		<u>Date:</u>	AUG 2022	Stage:
Scale/s: 1:200 @ A1		Checked	<u>l:</u>	Const.
Drawing number:	5044	1 - 30	00	Revision:



SOUTH EAST ELEVATION




NORTH WEST ELEVATION

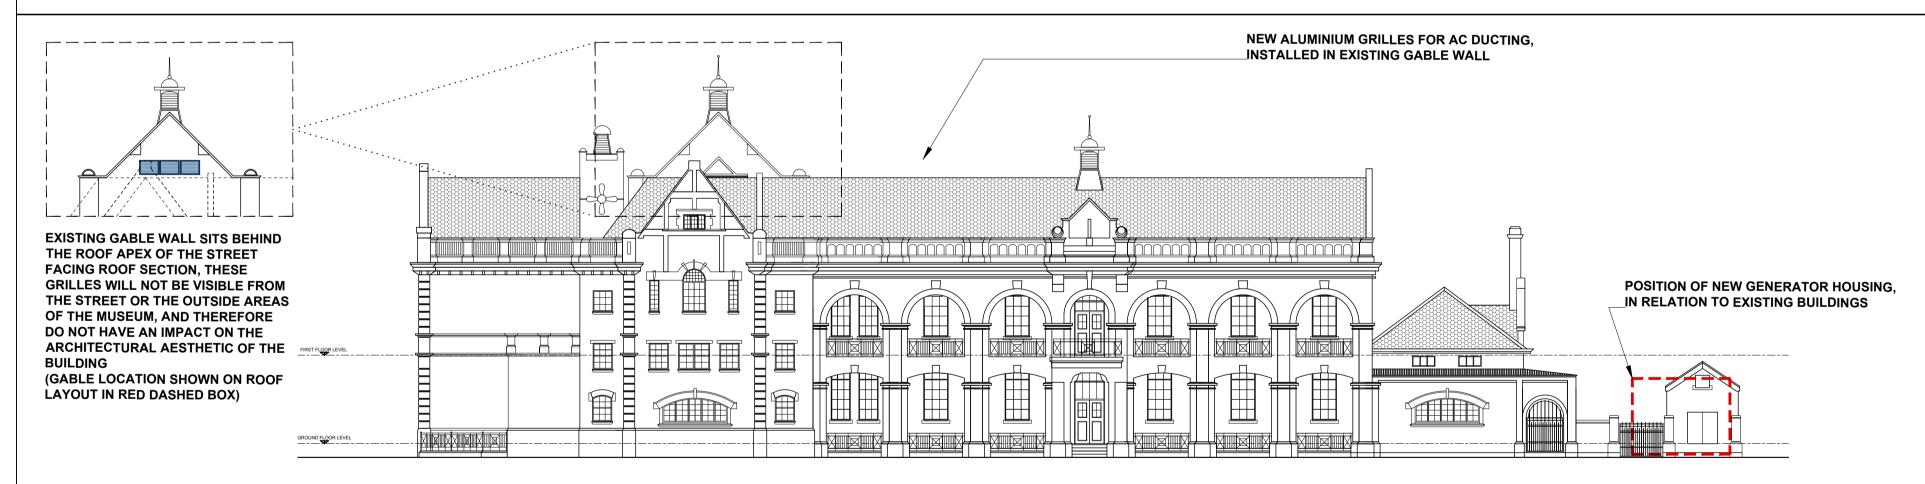

NORTH EAST ELEVATION



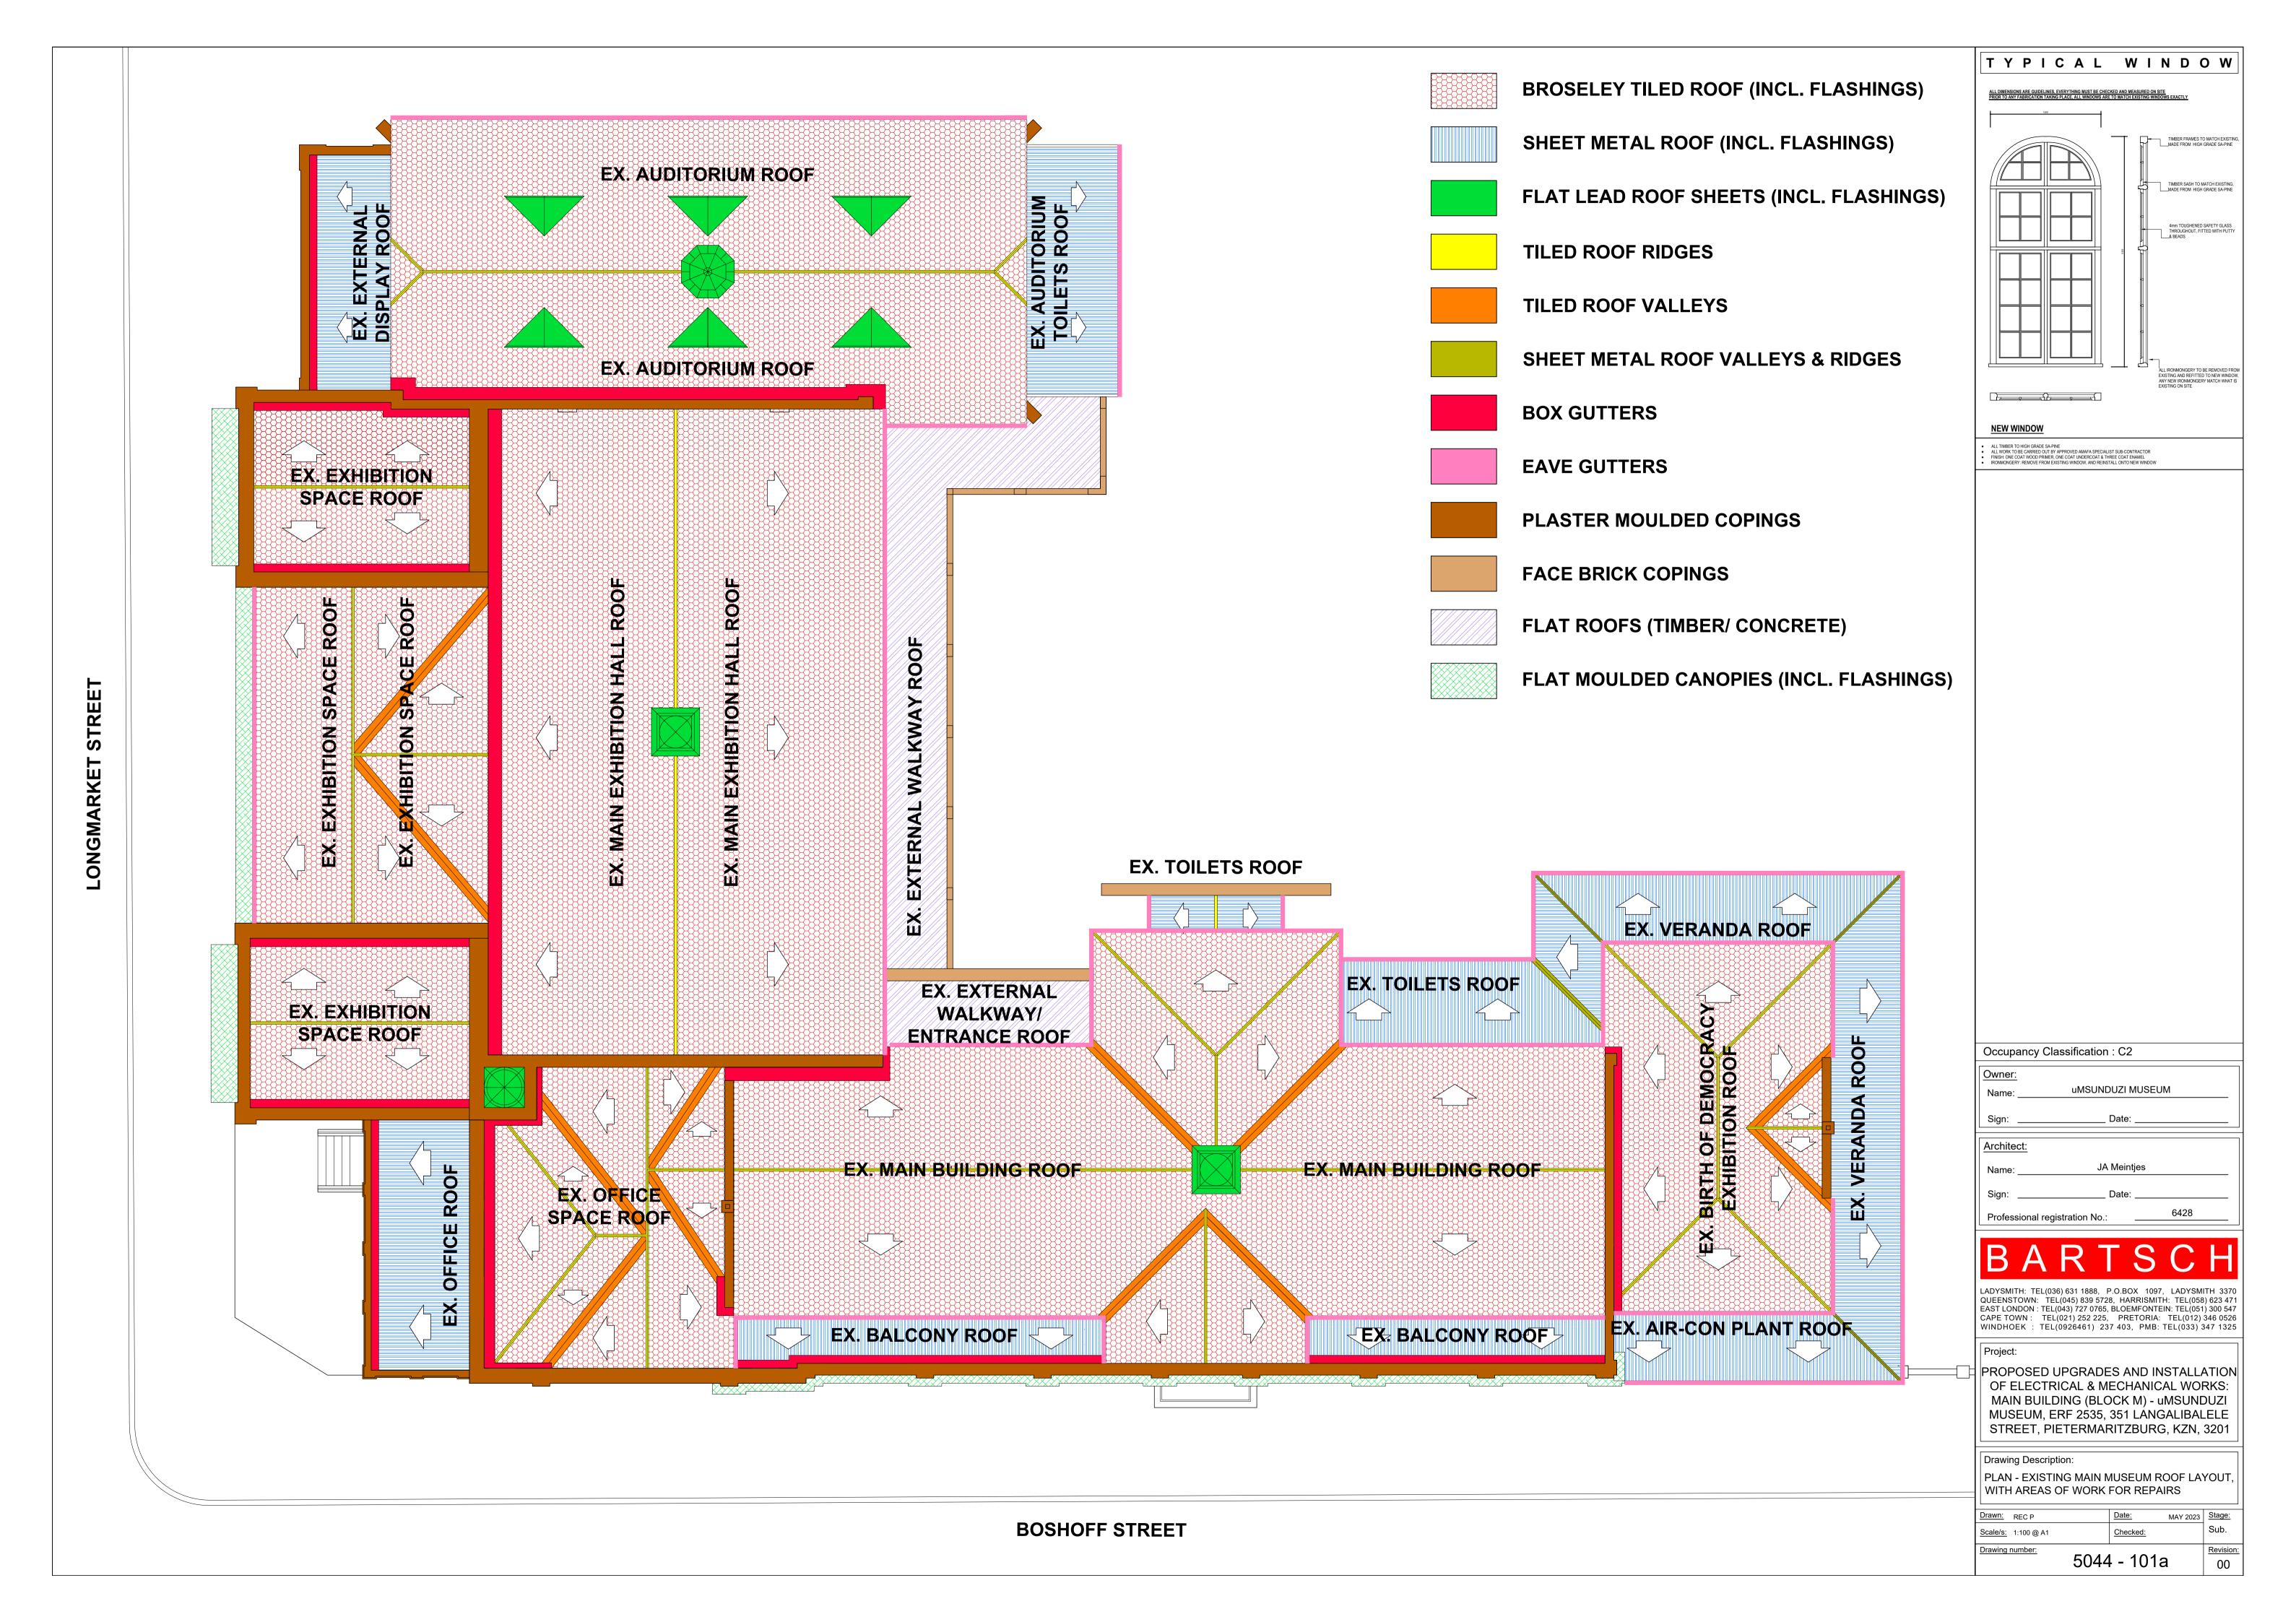



HVAC Drawings

CONTROLLER SCHEDULE (G)

REF. NO. DESCRIPTION


C1 12 LG STANDARD WALL CONTROLLER


C2 1 LG CENTRAL CONTROLLER - POWER SUPPLY WITH ISOLATOR REQUIRED. 1Ph, 0.1A


DUCT ACCESSORY SCHEDULE (G)				
REF	NO.	DESCRIPTION	SIZE	
ATT-3	1	RECTANGULAR SOUND ATTENUATOR	600x600x1500L	
ATT-4	1	RECTANGULAR SOUND ATTENUATOR	700x700x1500L	
ATT-5	1	RECTANGULAR SOUND ATTENUATOR	1000x400x1500L	
BD-2	3	BALANCING DAMPER	300x250 (TBC)	
BD-4	1	BALANCING DAMPER	400x400	
BD-5	1	BALANCING DAMPER	500x350	
BD-6	1	BALANCING DAMPER	1000x400	
BD-7	1	BALANCING DAMPER	1000x1000	

	AIR DISTRIBUTION EQUIPMENT SCHEDULE (G)					
REF	NO.	DESCRIPTION	SIZE	MODEL	COMMENTS	
SG-1	2	"TROX" SUPPLY, DOUBLE DEFLECTION GRILLE C/W PLENUM & O.B.D.	200x200	AT		
SG-3	2	"TROX" SUPPLY, DOUBLE DEFLECTION GRILLE C/W PLENUM & O.B.D.	400x250	AT		
SG-5	7	"TROX" SUPPLY, DOUBLE DEFLECTION GRILLE C/W PLENUM & O.B.D.	850x250	AT		
SD-1	4	"TROX" FRESH AIR DISC VALVE	200ø	Z-LVS-200	Ø200mm SPIGOT/DUCT/FLEX	
TG-1	2	DOUBLE SIDED AUCOUSTIC TRANSFER GRILLE	500x1000	-	SIZE TO BE CONFIRMED ON SITE	
WL-3	1	ALUMINIUM WEATHER LOUVRE C/W W.M.S	1000x1000	AWR		
ESG-1	12	EXISTING SUPPLY GRILLE. TO BE CLEANED AND RE-USED.	450x250	AT	Ø250mm SPIGOT/DUCT/FLEX	
ERG-1	6	EXISTING RETURN GRILLE. TO BE CLEANED AND RE-USED.	700x700	-	Ø560mm SPIGOT/DUCT/FLEX	
ERG-2	2	EXISTING RETURN GRILLE. TO BE CLEANED AND RE-USED.	500x1000	AT		
	SG-1 SG-3 SG-5 SD-1 TG-1 WL-3 ESG-1 ERG-1	SG-1 2 SG-3 2 SG-5 7 SD-1 4 TG-1 2 WL-3 1 ESG-1 12 ERG-1 6	REF NO. DESCRIPTION SG-1 2 "TROX" SUPPLY, DOUBLE DEFLECTION GRILLE C/W PLENUM & O.B.D. SG-3 2 "TROX" SUPPLY, DOUBLE DEFLECTION GRILLE C/W PLENUM & O.B.D. SG-5 7 "TROX" SUPPLY, DOUBLE DEFLECTION GRILLE C/W PLENUM & O.B.D. SD-1 4 "TROX" FRESH AIR DISC VALVE TG-1 2 DOUBLE SIDED AUCOUSTIC TRANSFER GRILLE WL-3 1 ALUMINIUM WEATHER LOUVRE C/W W.M.S ESG-1 12 EXISTING SUPPLY GRILLE. TO BE CLEANED AND RE-USED. ERG-1 6 EXISTING RETURN GRILLE. TO BE CLEANED AND RE-USED.	REF NO. DESCRIPTION SIZE SG-1 2 "TROX" SUPPLY, DOUBLE DEFLECTION GRILLE C/W PLENUM & O.B.D. 200x200 SG-3 2 "TROX" SUPPLY, DOUBLE DEFLECTION GRILLE C/W PLENUM & O.B.D. 400x250 SG-5 7 "TROX" SUPPLY, DOUBLE DEFLECTION GRILLE C/W PLENUM & O.B.D. 850x250 SD-1 4 "TROX" FRESH AIR DISC VALVE 200ø TG-1 2 DOUBLE SIDED AUCOUSTIC TRANSFER GRILLE 500x1000 WL-3 1 ALUMINIUM WEATHER LOUVRE C/W W.M.S 1000x1000 ESG-1 12 EXISTING SUPPLY GRILLE. TO BE CLEANED AND RE-USED. 450x250 ERG-1 6 EXISTING RETURN GRILLE. TO BE CLEANED AND RE-USED. 700x700	REF NO. DESCRIPTION SIZE MODEL SG-1 2 "TROX" SUPPLY, DOUBLE DEFLECTION GRILLE C/W PLENUM & O.B.D. 200x200 AT SG-3 2 "TROX" SUPPLY, DOUBLE DEFLECTION GRILLE C/W PLENUM & O.B.D. 400x250 AT SG-5 7 "TROX" SUPPLY, DOUBLE DEFLECTION GRILLE C/W PLENUM & O.B.D. 850x250 AT SD-1 4 "TROX" FRESH AIR DISC VALVE 200ø Z-LVS-200 TG-1 2 DOUBLE SIDED AUCOUSTIC TRANSFER GRILLE 500x1000 - WL-3 1 ALUMINIUM WEATHER LOUVRE C/W W.M.S 1000x1000 AWR ESG-1 12 EXISTING SUPPLY GRILLE. TO BE CLEANED AND RE-USED. 450x250 AT ERG-1 6 EXISTING RETURN GRILLE. TO BE CLEANED AND RE-USED. 700x700 -	

	AC & FAN SCHEDULE (G)								
REF	NO.	DESCRIPTION	MODEL	COOLING CAPACITY	AIR FLOW	ESP	WEIGHT	RATED CURRENT	MOUNTING POSITION
ODU-4	1	"LG MULTI V5" VRF OUTDOOR UNIT - HEAT PUMP	ARUM200LTE5	56 kW	-	-	330 kg	3Ph, 400V, 50Hz, 49A	ROOF - SUPPORT REQUIRED BALCONY - PLINTH REQUIREI
IDU-1	2	"LG MULTI V5" VRF INDOOR UNIT - MID-WALL	ARNU07GSJN4	2.2 kW	-	-	10 kg	1Ph, 230V, 50Hz, 0.1A	WALL
IDU-4	1	"LG MULTI V5" VRF INDOOR UNIT - MID-WALL	ARNU18GSKN4	5.6 kW	-	-	15 kg	1Ph, 230V, 50Hz, 0.2A	WALL
IDU-6	2	"LG MULTI V5" VRF INDOOR UNIT - MID-WALL	ARNU36GSVA4	10.4 kW	-	-	20 kg	1Ph, 230V, 50Hz, 0.4A	WALL
IDU-7	2	"LG MULTI V5" VRF INDOOR UNIT - CEILING CASSETTE	ARNU07GTRC4	2.2 kW	-	-	15 kg	1Ph, 230V, 50Hz, 0.1A	SOFFIT / TRUSS
IDU-8	1	"LG MULTI V5" VRF INDOOR UNIT - CEILING CASSETTE	ARNU09GTRC4	2.8 kW	-	-	15 kg	1Ph, 230V, 50Hz, 0.1A	SOFFIT / TRUSS
IDU-9	1	"LG MULTI V5" VRF INDOOR UNIT - CEILING CASSETTE	ARNU15GTQC4	4.5 kW	-	-	20 kg	1Ph, 230V, 50Hz, 0.2A	SOFFIT / TRUSS
AHU-1	1	AIR HANDLING UNIT - VERTICAL	-	56.2 kW	3320 l/s	250 Pa	800 kg	3Ph, 400V, 50Hz, 10A	GROUND - PLINTH REQUIRED
AHU-2	1	AIR HANDLING UNIT - HORIZONTAL	-	61.6 kW	3000 l/s	250 Pa	800 kg		CEILING VOID - SUPPORT REQUIRED
EEV-1	1	"LG MULTI V5" VRF ELECTRONIC EXPANSION VALVE	PRLK096A0	56.3 kW	-	-	10 kg	-	ON UNIT
EEV-2	1	"LG MULTI V5" VRF ELECTRONIC EXPANSION VALVE	PRLK396A0	112.5 kW	-	-	10 kg	-	ON UNIT
SU-2	1	SPLIT UNIT - MID-WALL	M38AKH	9.8 kW	-	-	75 kg (Out) + 20 kg (Ind)	1Ph, 230V, 50Hz, 17A	WALL / WALL
SF-1	1	"SYSTEMAIR" SUPPLY AIR FAN - CIRCULAR IN-LINE FAN	Prio Silent XP 150EC	-	90-145 l/s	200 Pa	5 kg	1Ph, 230V, 50Hz, 1A	SOFFIT / TRUSS
EF-1	4	"XPELAIR" CEILING MOUNTED EXTRACTOR FAN	PX9	-	333 l/s	-	5 kg	1Ph, 230V, 50Hz, 0.2A	CEILING
EF-2	1	"XPELAIR" WINDOW MOUNTED EXTRACTOR FAN	GX9C	-	145 l/s	-	5 kg	1Ph, 230V, 50Hz, 0.2A	WINDOW
EF-3	3	"XPELAIR" WINDOW MOUNTED EXTRACTOR FAN	GX9	-	171 l/s	-	5 kg	1Ph, 230V, 50Hz, 0.2A	WINDOW
EF-4	1	"XPELAIR" WINDOW MOUNTED EXTRACTOR FAN	GX12	-	303 l/s	-	10 kg	1Ph, 230V, 50Hz, 0.4A	WINDOW

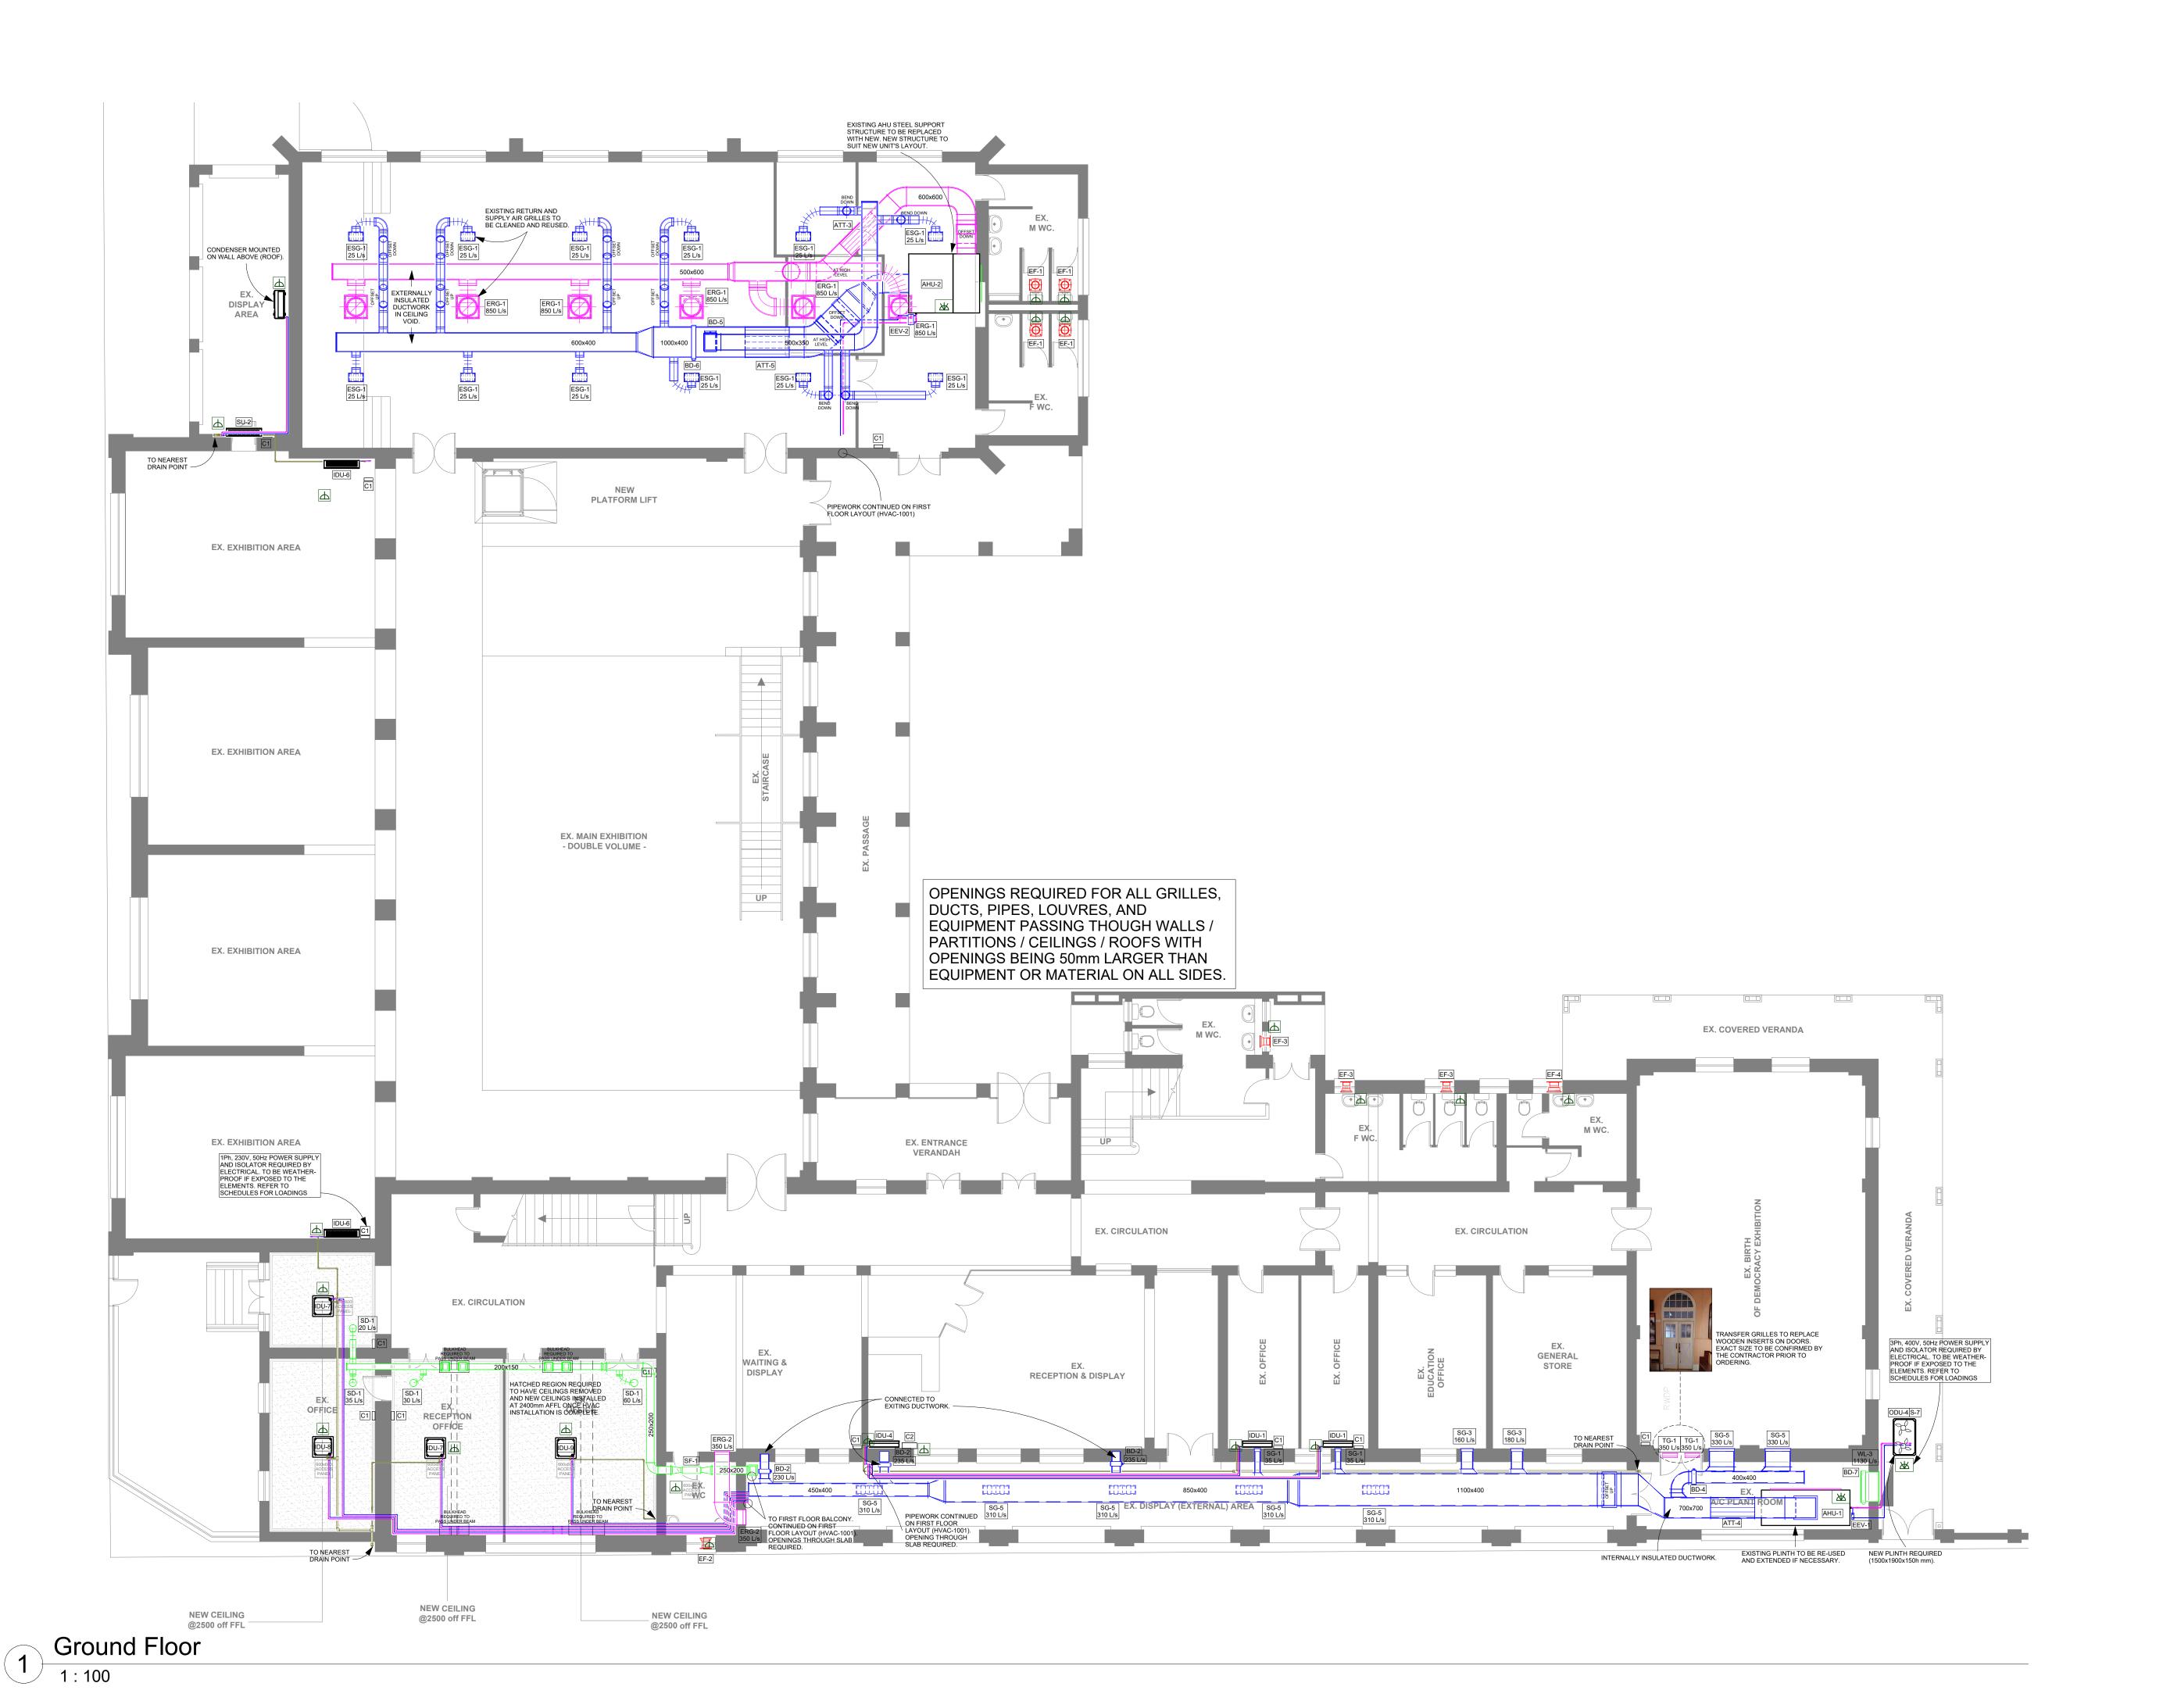

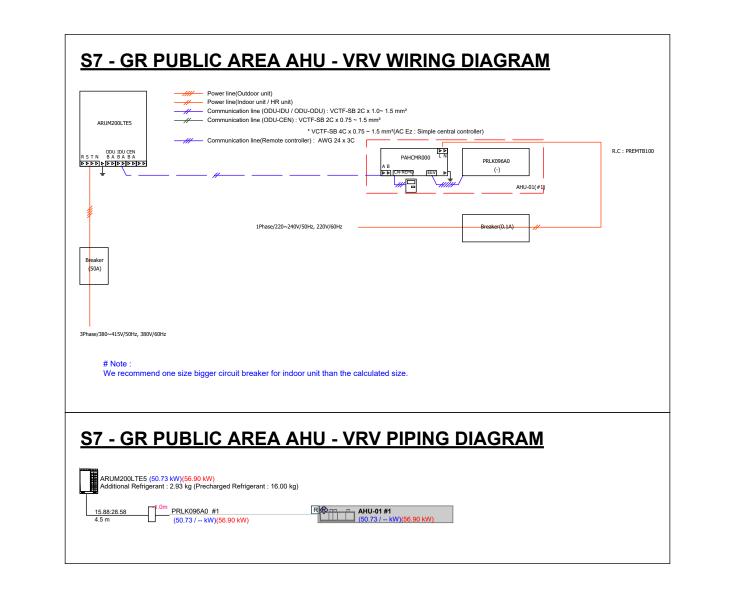

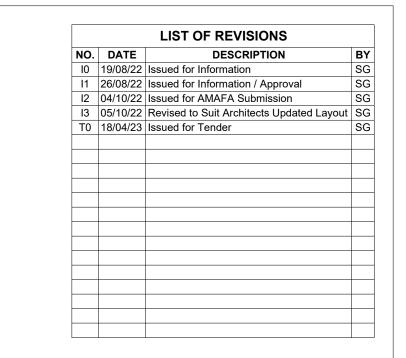

COLOUR LEGEND

AC SUPPLY AIR / LIQUID PIPING

RETURN AIR / GAS PIPING

EXTRACT AIR

FRESH AIR

CONDENSATE DRAINAGE

IPH POWER SUPPLY AND ISOLATOR. TO BE WEATHER PROOF IF EXPOSED TO THE ELEMENTS. REQUIREMENTS AS PER EQUIPMENT SCHEDULES.

3PH POWER SUPPLY AND ISOLATOR. TO BE WEATHER PROOF IF EXPOSED TO THE ELEMENTS. REQUIREMENTS AS PER

EQUIPMENT SCHEDULES.

NOTES:

1. ALL FRESH AIR & EXTRACTION, INCLUDING AIR HANDLING UNITS, TO BE CONNECTED TO THE FIRE SIGNAL AND AUTOMATICALLY SHUT DOWN IN THE EVENT OF A FIRE.

2. ALL INDEPENDENT VENTILATION FANS (EXTRACT AND FRESH AIR) TO BE CONNECTED VIA TIMERS. TIMES TO BE CONFIRMED BY ENGINEER PRIOR TO SETTING.

3. ALL DUCTING SIZES SHOWN ARE SHEET-METAL SIZES. DUCTING TO BE MANUFACTURED ACCORDING TO SMACNA, SABS & ISO STANDARDS.

4. ALL A/C DUCTWORK (SUPPLY & RETURN) TO BE EXTERNALLY INSULATED WITH 15MM THERMAFLEX (POLYETHYLENE FOAM) OR INTERNALLY INSULATED

WITH 15MM SONIC LINER (AS INDICATED). FRESH AIR
AND EXTRACT AIR DUCT WORK TO BE UNINSULATED.
ALL EXPOSED DUCTWORK AND DIFFUSION PRODUCTS
TO BE PAINTED TO ARCHITECTS APPROVAL.

5. ALL HANGERS AND BRACKETS TO BE GALVANISED.
6. ALL DUCTWORK TO BE HUNG ON 30x50x1.6 G.S.M
CHANNEL TRAPEZE HANGERS WITH 8 Ø RODS. RODS
ARE TO BE CUT SHORT BEYOND THE DUCT HANGER TO
PREVENT DAMAGE TO THE CEILING TILES WHEN
LISTED. THE ENDS ARE TO BE COLD GALVANISED.

PREVENT DAMAGE TO THE CEILING TILES WHEN
LIFTED. THE ENDS ARE TO BE COLD GALVANISED.

7. ALL GRILLES AND SUPPLY AIR DIFFUSERS ARE TO BE
SECRET FIXINGS.

8. ALL WEATHER LOUVRES SHALL HAVE COUNTERSUNK
FRAMES AND PHILLIPS HEAD COUNTERSUNK SCREWS.

9. THE MAXIMUM LENGTH OF FLEXIBLE DUCTING IS TO BE
1500MM.

10. ALL PIPFWORK CONNECTIONS TO FOLIPMENT MUST.

1500MM.
10. ALL PIPEWORK CONNECTIONS TO EQUIPMENT MUST BE WITH FLANGES.
11. REFRIGERANT PIPES MUST BE INSULATED WITH ARMAFLEX. INSULATION TAPE (LASSO TAPE) MUST BE OF THE ARMAFLEX TYPE, AS NO DUCT TAPE WILL BE ACCEPTED. ALL PIPEWORK BE RUN NEATLY IN CABLE TRAYS.
12. ALL A/C CONDENSATE DRAIN PIPES TO BE CONNECTED TO THE NEAREST DRAIN POINT MAIN PIPE LINE TO BE

TO THE NEAREST DRAIN POINT. MAIN PIPE LINE TO BE Ø50mm WITH Ø32mm CONNECTION TO THE INDIVIDUAL INDOOR UNITS. ALL PIPING TO HAVE A FALL OF 1:80. ALL DRAIN PIPING TO BE THERMAFLEX INSULATED TO PREVENT CONDENSATION. ALL DRAIN PIPES TO HAVE A TRAP BEFORE CONNECTING TO THE VENT/STACK PIPES. BY HVAC CONTRACTOR.

13. ALL ROUTING AND DIMENSIONS TO BE CONFIRMED ON SITE PRIOR TO INSTALLATION.

SITE PRIOR TO INSTALLATION.


14. ALL MECHANICAL EQUIPMENT TO HAVE POWER
SUPPLIES AND ISOLATORS NOT MORE THAN 1.5m AWAY
FROM EQUIPMENT'S ELECTRICAL TERMINAL BOX. ANY
ISOLATOR EXPOSED TO THE ELEMENTS MUST BE
WEATHERPROOF. REFER TO SCHEDULES FOR
RUNNING LOADS.


CONSULTANT INFORMATION LSG CONSULTING ENGINEERS INC.
Consulting Mechanical & Wet Services Engineers
 Head Office (KZN)
 Branch (PTA)

 Unit 7&8 Doncaster Park,
 239 Lange Street,


 10 Derby Place, Derby Downs Office Park,
 Nieuw Muckleneuk,
 Westville, 3630 Pretoria, 0181 Tel.: +27 (31) 205 2335 Tel.: +27 (12) 346 8676 DESIGN INFORMATION DRAWN: DESIGNED: CHECKED: DATE: PL SG GG 08/25/22 CLIENT INFORMATION CLIENT LOGO: CLIENT NAME: Msunduzi Museum an agency of the PROJECT INFORMATION PROJECT DESCRIPTION: Building / HVAC Upgrade PROJECT NAME: Msunduzi Complex Main Museum 351 Langalibalele St, Pietermaritzburg SITE DESCRIPTION: Museum DRAWING INFORMATION DRAWING TITLE: HVAC Layout - Ground Floor DRAWING SCALE: As indicated DRAWING NUMBER: LSG-2204-HVAC-100 T0 DATE: 08/02/2022 COPYRIGHT RESERVED

REFERENCE DRAWING: M100 / M101 / M200 / M201

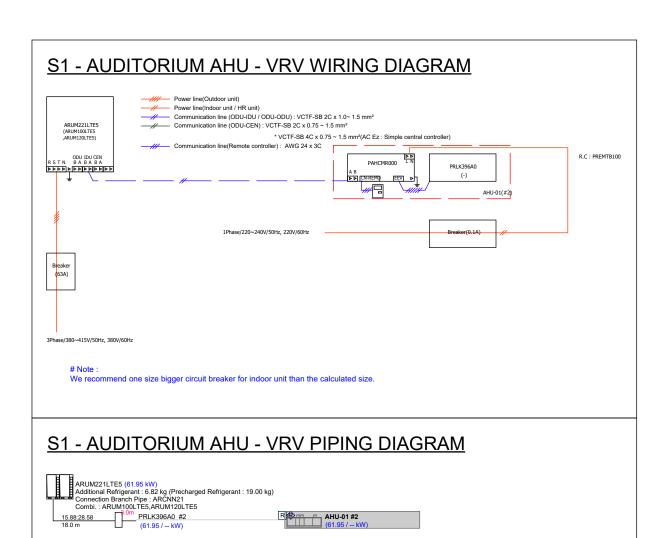

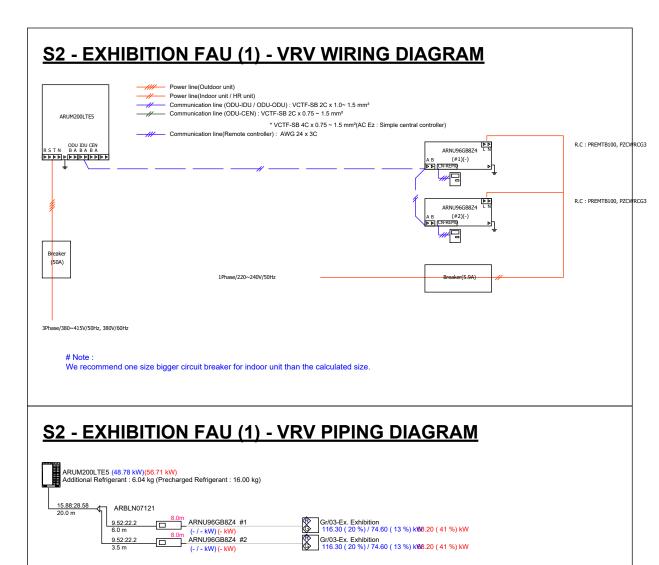

PIPEWORK CONTINUED ON GROHND

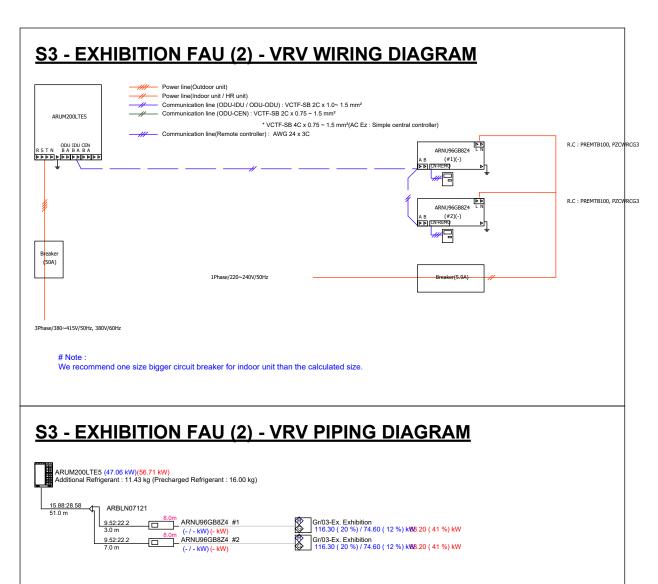

OPENINGS

WALLS /


REQUIRED FOR ALL


GRILLES, DUCTS,

PIPES, LOUVRES,

PASSING THOUGH

AND EQUIPMENT

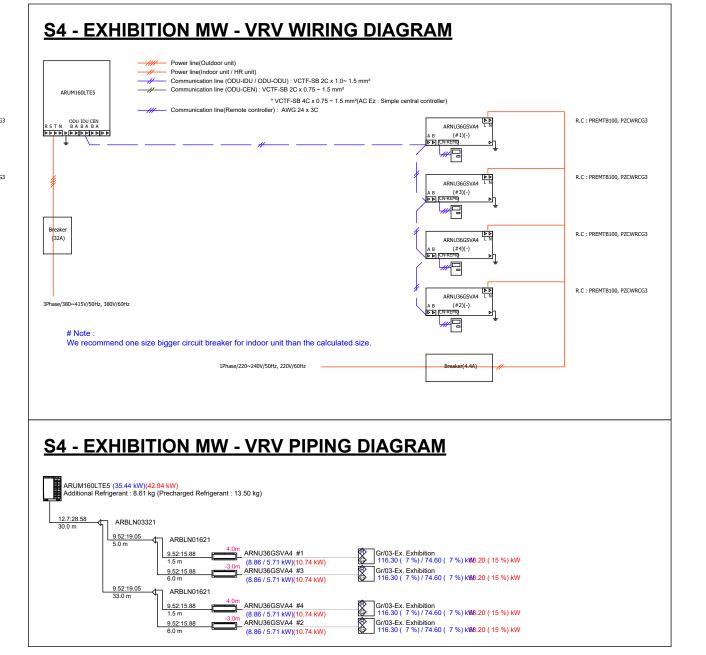

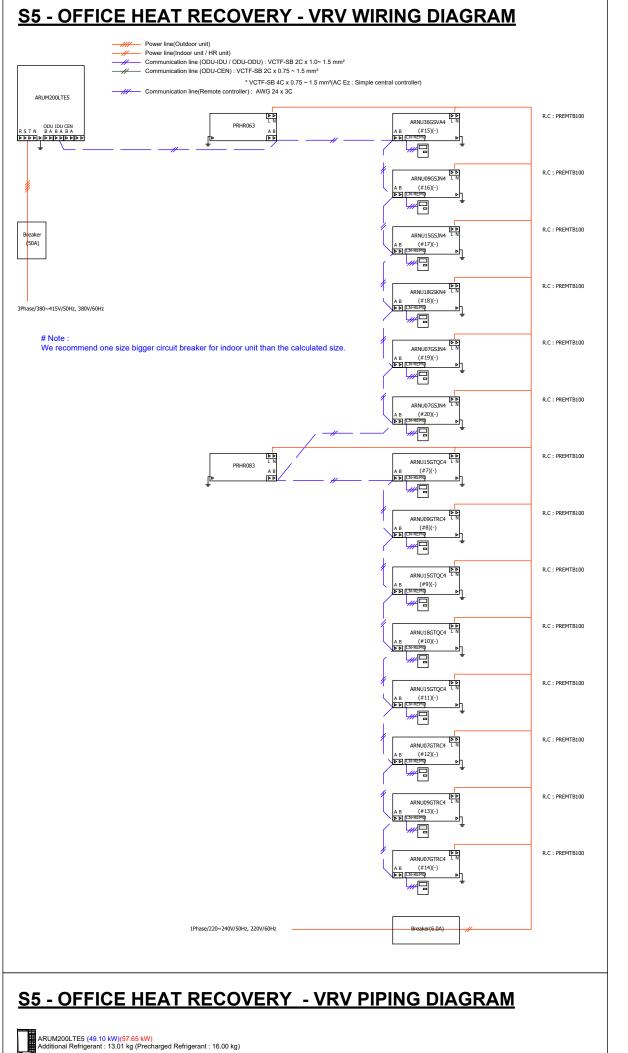

9.52:15.88 2.5m ARNU36GSVA4 #15

3.35:12.7 2.5m ARNU09GSJN4 #16

6.35:12.7 ARNU15GSJN4 #17

6.35:12.7 ARNU18GSKN4 #18

6.35:12.7 (4.82 / 3.15 kW)(5.66 k. ARNU07GSJN4 #19 22.0 m (1.90 / 1.41 kW)(2.23 kW)

6.35:12.7 ARNU07GSJN4 #20 25.0 m (1.90 / 1.44 MM/2.22 MM

4.10 (34 %) / 352 (1 1 1 1 2 50 (96 %) / 1.90 (84 %) kW.30 (217 %) kW

Mezz/16-Ex. Office (Mezz) 4.10 (94 %) / 3.10 (83 %) kW.50 (303 %) kW

Mezz/15-Server Room (Mezz) 5.40 (89 %) / 4.90 (62 %) kW.30 (435 %) kW

Gr/08-Ex. Tea Kitchen 3.90 (99 %) / 2.90 (88 %) kW.60 (284 %) kW Gr/06-Ex. Reception Office 1.90 (99 %) / 1.40 (90 %) kVIV.80 (278 %) kW 1.90 (99 %) / 1.90 (50 %), ... Gr/04-Ex. Office 2.70 (89 %) / 2.00 (80 %) kW.60 (176 %) kW

Gr/05-Ex. Circul (Office)
1.90 (99 %) / 1.50 (84 %) kW.00 (222 %) kW


6.35:12.7 4.0m ARNU15GTQC4 #7 (1.90 / 1.41 kW)(2.23 kW) 1.70 (
9.0 m 4.0m (3.88 / 2.58 kW)(4.55 kW) 4.10 (94%) / 3.00 (85%) kW.90 (239%) kW


6.35:12.7 ARNU09GTRC4 #8 (3.512.7 (2.41 / 1.61 kW)/2.93 kW)

6.35:12.7 ARNU15GTQC4 #9

6.35:12.7 ARNU18GTQC4 #10
20.0 m (4.82 / 3.08 \text{kW/F GC 14M})

-3.0m (1.90/1.26 kW)(2.25 kW)
6.35:12.7 ARNU09GTRC4 #13
28.0 m (2.41/1.61 kW)(2.83 kW)
6.35:12.7 -3.0m ARNU09GTRC4 #14
33.0 m (1.90/1.26 kW)(2.23 kW)

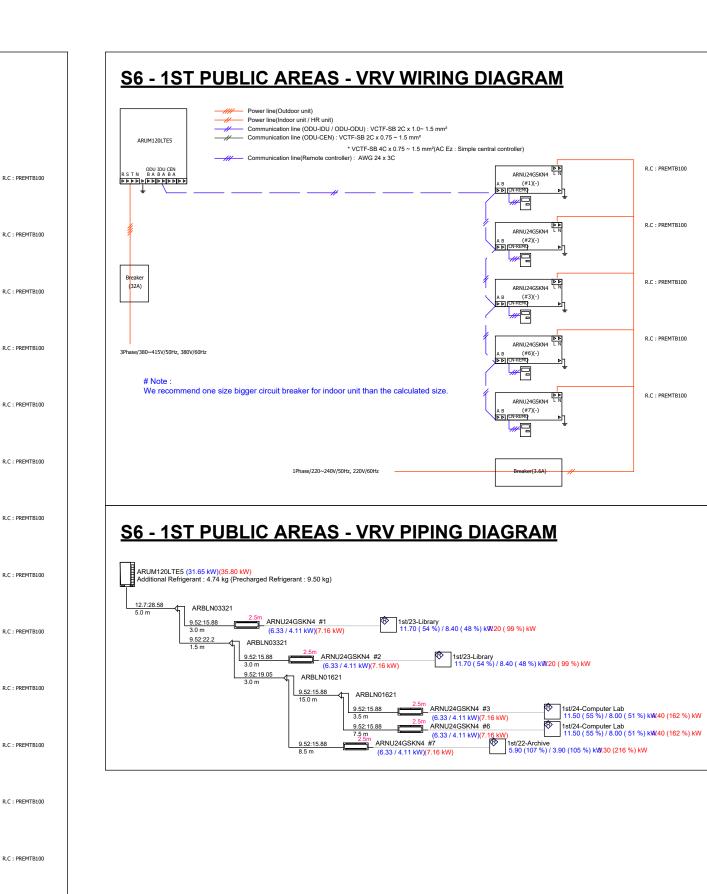

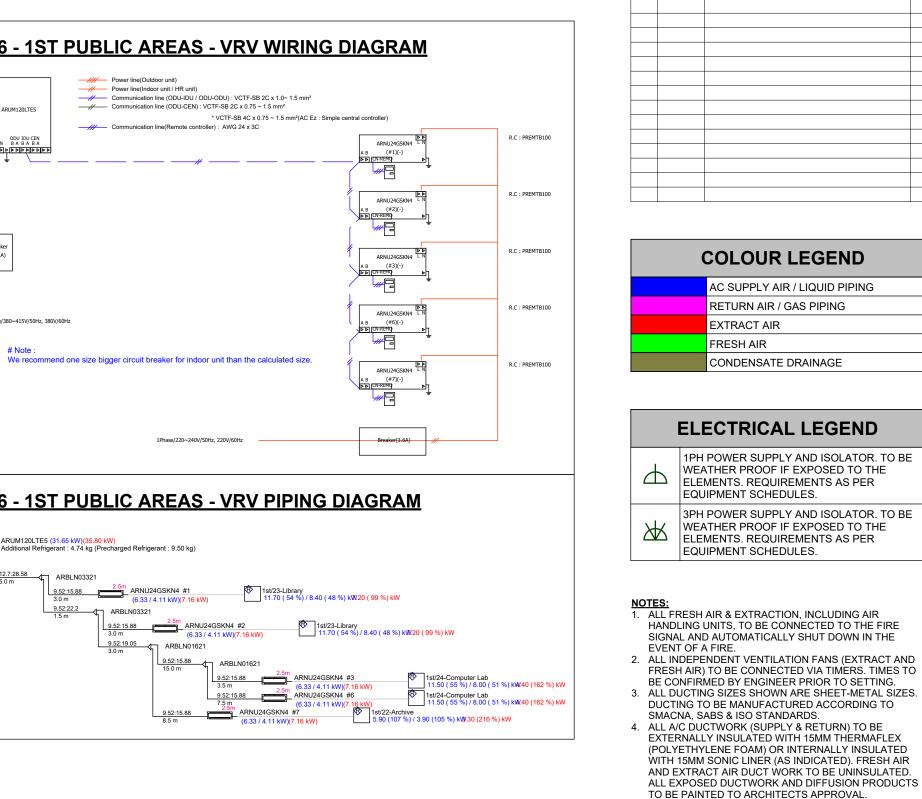

LIST OF REVISIONS

I3 05/10/22 Revised to Suit Architects Updated Layout SG

COLOUR LEGEND

AC SUPPLY AIR / LIQUID PIPING RETURN AIR / GAS PIPING

CONDENSATE DRAINAGE

5. ALL HANGERS AND BRACKETS TO BE GALVANISED. 6. ALL DUCTWORK TO BE HUNG ON 30x50x1.6 G.S.M

SECRET FIXINGS.

8. ALL WEATHER LOUVRES SHALL HAVE COUNTERSUNK FRAMES AND PHILLIPS HEAD COUNTERSUNK SCREWS. 9. THE MAXIMUM LENGTH OF FLEXIBLE DUCTING IS TO BE 10. ALL PIPEWORK CONNECTIONS TO EQUIPMENT MUST

11. REFRIGERANT PIPES MUST BE INSULATED WITH ARMAFLEX. INSULATION TAPE (LASSO TAPE) MUST BE OF THE ARMAFLEX TYPE, AS NO DUCT TAPE WILL BE ACCEPTED. ALL PIPEWORK BE RUN NEATLY IN CABLE

12. ALL A/C CONDENSATE DRAIN PIPES TO BE CONNECTED

DRAIN PIPING TO BE THERMAFLEX INSULATED TO

TRAP BEFORE CONNECTING TO THE VENT/STACK PIPES. BY HVAC CONTRACTOR.

13. ALL ROUTING AND DIMENSIONS TO BE CONFIRMED ON

14. ALL MECHANICAL EQUIPMENT TO HAVE POWER

WEATHERPROOF. REFER TO SCHEDULES FOR

SITE PRIOR TO INSTALLATION.

RUNNING LOADS.

TO THE NEAREST DRAIN POINT. MAIN PIPE LINE TO BE

Ø50mm WITH Ø32mm CONNECTION TO THE INDIVIDUAL INDOOR UNITS. ALL PIPING TO HAVE A FALL OF 1:80. ALL

PREVENT CONDENSATION. ALL DRAIN PIPES TO HAVE A

SUPPLIES AND ISOLATORS NOT MORE THAN 1.5m AWAY

FROM EQUIPMENT'S ELECTRICAL TERMINAL BOX. ANY ISOLATOR EXPOSED TO THE ELEMENTS MUST BE

BE WITH FLANGES.

CHANNEL TRAPEZE HANGERS WITH 8Ø RODS. RODS ARE TO BE CUT SHORT BEYOND THE DUCT HANGER TO PREVENT DAMAGE TO THE CEILING TILES WHEN LIFTED. THE ENDS ARE TO BE COLD GALVANISED. 7. ALL GRILLES AND SUPPLY AIR DIFFUSERS ARE TO BE

EXTRACT AIR

FRESH AIR

DESCRIPTION

NO. DATE

I0 19/08/22 Issued for Information

T0 18/04/23 Issued for Tender

11 26/08/22 Issued for Information / Approval I2 04/10/22 Issued for AMAFA Submission

	AC & FAN SCHEDULE (1)								
REF	NO.	DESCRIPTION	MODEL	COOLING CAPACITY	AIR FLOW	ESP	WEIGHT	RATED CURRENT	MOUNTING POSITION
ODU-1	1	"LG MULTI V5" VRF OUTDOOR UNIT - HEAT PUMP	ARUM100LTE5	28 kW	-	-	240 kg	3Ph, 400V, 50Hz, 28A	ROOF - SUPPORT REQUIRED
ODU-2	2	"LG MULTI V5" VRF OUTDOOR UNIT - HEAT PUMP	ARUM120LTE5	33.6 kW	-	-	240 kg	3Ph, 400V, 50Hz, 28A	ROOF - SUPPORT REQUIRED BALCONY - PLINTH REQUIRED
ODU-3	1	"LG MULTI V5" VRF OUTDOOR UNIT - HEAT PUMP	ARUM160LTE5	44.8 kW	-	-	260 kg	3Ph, 400V, 50Hz, 28A	ROOF - SUPPORT REQUIRED
ODU-4	2	"LG MULTI V5" VRF OUTDOOR UNIT - HEAT PUMP	ARUM200LTE5	56 kW	-	-	330 kg	3Ph, 400V, 50Hz, 49A	ROOF - SUPPORT REQUIRED BALCONY - PLINTH REQUIRED
ODU-5	1	"LG MULTI V5" VRF OUTDOOR UNIT - HEAT RECOVERY	ARUM200LTE5	56 kW	-	-	330 kg		BALCONY - PLINTH REQUIRED
IDU-2	1	"LG MULTI V5" VRF INDOOR UNIT - MID-WALL	ARNU09GSJN4	2.8 kW	-	-	10 kg	1Ph, 230V, 50Hz, 0.1A	WALL
IDU-3	1	"LG MULTI V5" VRF INDOOR UNIT - MID-WALL	ARNU15GSJN4	4.5 kW	-	-	10 kg	1Ph, 230V, 50Hz, 0.2A	WALL
IDU-5	5	"LG MULTI V5" VRF INDOOR UNIT - MID-WALL	ARNU24GSKN4	7.1 kW	-	-	15 kg	1Ph, 230V, 50Hz, 0.2A	WALL
IDU-6	3	"LG MULTI V5" VRF INDOOR UNIT - MID-WALL	ARNU36GSVA4	10.4 kW	-	-	20 kg	1Ph, 230V, 50Hz, 0.4A	WALL
IDU-8	1	"LG MULTI V5" VRF INDOOR UNIT - CEILING CASSETTE	ARNU09GTRC4	2.8 kW	-	-	15 kg	1Ph, 230V, 50Hz, 0.1A	SOFFIT / TRUSS
IDU-9	2	"LG MULTI V5" VRF INDOOR UNIT - CEILING CASSETTE	ARNU15GTQC4	4.5 kW	-	-	20 kg	1Ph, 230V, 50Hz, 0.2A	SOFFIT / TRUSS
IDU-10	1	"LG MULTI V5" VRF INDOOR UNIT - CEILING CASSETTE	ARNU18GTQC4	5.6 kW	-	-	20 kg	1Ph, 230V, 50Hz, 0.2A	SOFFIT / TRUSS
IDU-11	4	"LG MULTI V5" VRF INDOOR UNIT - FRESH AIR INTAKE	ARNU96GB8Z4	28 kW	595 l/s	216 Pa	80 kg	1Ph, 230V, 50Hz, 1.6A	TRUSS
HRU-1	1	"LG MULTI V5" VRF HEAT RECOVERY BOX - 6 PORT	PRHR063A	-	-	-	35 kg	1Ph, 230V, 50Hz, 0.4A	TRUSS
HRU-2	1	"LG MULTI V5" VRF HEAT RECOVERY BOX - 8 PORT	PRHR083A	-	-	-	35 kg	1Ph, 230V, 50Hz, 0.4A	TRUSS
SU-1	1	SPLIT UNIT - MID-WALL	M24AKH	6.45 kW	-	-	45 kg(Out) + 15 kg (Ind)	1Ph, 230V, 50Hz, 10A	WALL / WALL
SF-1	2	"SYSTEMAIR" SUPPLY AIR FAN - CIRCULAR IN-LINE FAN	Prio Silent XP 150EC	-	90-145 l/s	200 Pa	5 kg	1Ph, 230V, 50Hz, 1A	SOFFIT / TRUSS
SF-2	1	"SYSTEMAIR" SUPPLY AIR FAN - CIRCULAR IN-LINE FAN	Prio 315 EC	-	885 l/s	200 Pa	10 kg	1Ph, 230V, 50Hz, 2.5A	SOFFIT
EF-2	2	"XPELAIR" WINDOW MOUNTED EXTRACTOR FAN	GX9C	-	145 l/s	-	5 kg	1Ph, 230V, 50Hz, 0.2A	WINDOW
EF-3	3	"XPELAIR" WINDOW MOUNTED EXTRACTOR FAN	GX9	-	171 l/s	-	5 kg	1Ph, 230V, 50Hz, 0.2A	WINDOW

1st/19-Ex. Boardroom q 10 (100 %) / 5.90 (99 %) kW/.50 (238 %) kW

9.10 (100 %), 3.2. 1st/20-Ex. Office 3 2.70 (89 %) / 1.90 (88 %) kW.50 (188 %) kW


1st/21-Ex. Office 4 4.40 (88 %) / 3.00 (85 %) k\(\mathbb{2}\).30 (197 %) kW

Gr/11-Ex. Receptionists (1) 1 70 /111 %) / 1.20 (117 %) kW/60 (370 %) kW


Gr/11-Ex. Receptionists (2)
1.70 (111 %) / 1.20 (117 %) kW/60 (370 %) kW

Gr/10-Ex. Reception 17.80 (27 %) / 10.90 (28 %) kW/80 (72 %) kW

		AIR DISTRIBUTION EQUIPMEN	NT SCHE	EDULE (1)
REF	NO.	DESCRIPTION	SIZE	MODEL	COMMENTS
SG-1	1	"TROX" SUPPLY, DOUBLE DEFLECTION GRILLE C/W PLENUM & O.B.D.	200x200	AT	
SG-2	2	"TROX" SUPPLY, DOUBLE DEFLECTION GRILLE C/W PLENUM & O.B.D.	300x250	AT	
SG-4	3	"TROX" SUPPLY, DOUBLE DEFLECTION GRILLE C/W PLENUM & O.B.D.	550x250	AT	
JD-1	8	"TROX" JET DIFFUSER, ADJUSTABLE C/W EXTERNAL ELECTRIC ACTUATOR & CONTROLS	400ø	DUK-4-A-E1-4 00-P0	
SD-1	4	"TROX" FRESH AIR DISC VALVE	200ø	Z-LVS-200	Ø200mm SPIGOT/DUCT/FLEX
RAFF-1	1	"TROX" RETURN AIR GRILLE CW HINGED FRAME, PLENUM, FILTER AND O.B.D	1200x600	-	
WL-1	1	ALUMINIUM WEATHER LOUVRE C/W W.M.S	200x550	AWR	
WL-2	2	ALUMINIUM WEATHER LOUVRE C/W W.M.S	250x250	AWR	
WL-3	5	ALUMINIUM WEATHER LOUVRE C/W W.M.S	1000x1000	AWR	
ELD-1	1	EXISTING LOUVRE DOOR TO BE REFURBISHED.	3000x1500	-	PAINTED TO MATCH ARCHITECT APPROVAL

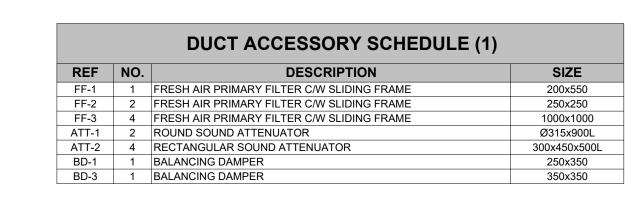


CONTROLLER SCHEDULE (1) DESCRIPTION LG STANDARD WALL CONTROLLER

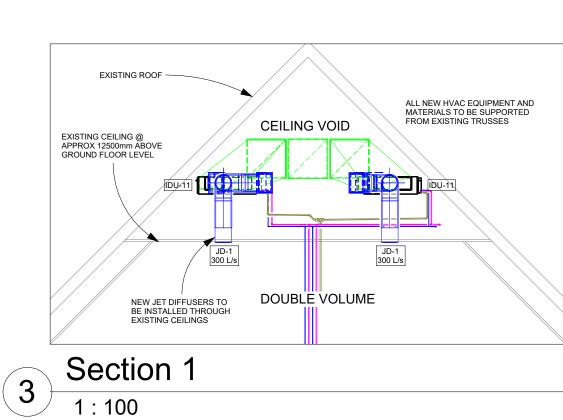

CONSULTANT INFORMATION ENGINEERS INC.
Consulting Mechanical & Wet Services E Consulting Mechanical & Wet Services Engineers 10 Derby Place, Derby Downs Office Park, Nieuw Muckleneuk, Westville, 3630 Tel.: +27 (31) 205 2335 DESIGN INFORMATION DRAWN: DESIGNED: CHECKED: DATE: PL SG GG 08/25/22 CLIENT INFORMATION CLIENT NAME: CLIENT LOGO: Msunduzi Museum an agency of the PROJECT INFORMATION PROJECT DESCRIPTION: Building / HVAC Upgrade PROJECT NAME: Msunduzi Complex Main Museum 351 Langalibalele St, Pietermaritzburg SITE DESCRIPTION: Museum DRAWING INFORMATION DRAWING TITLE: HVAC Layouts - First & Mezzanine DRAWING SCALE: As indicated DRAWING NUMBER: LSG-2204-HVAC-101


Pretoria, 0181

Tel.: +27 (12) 346 8676

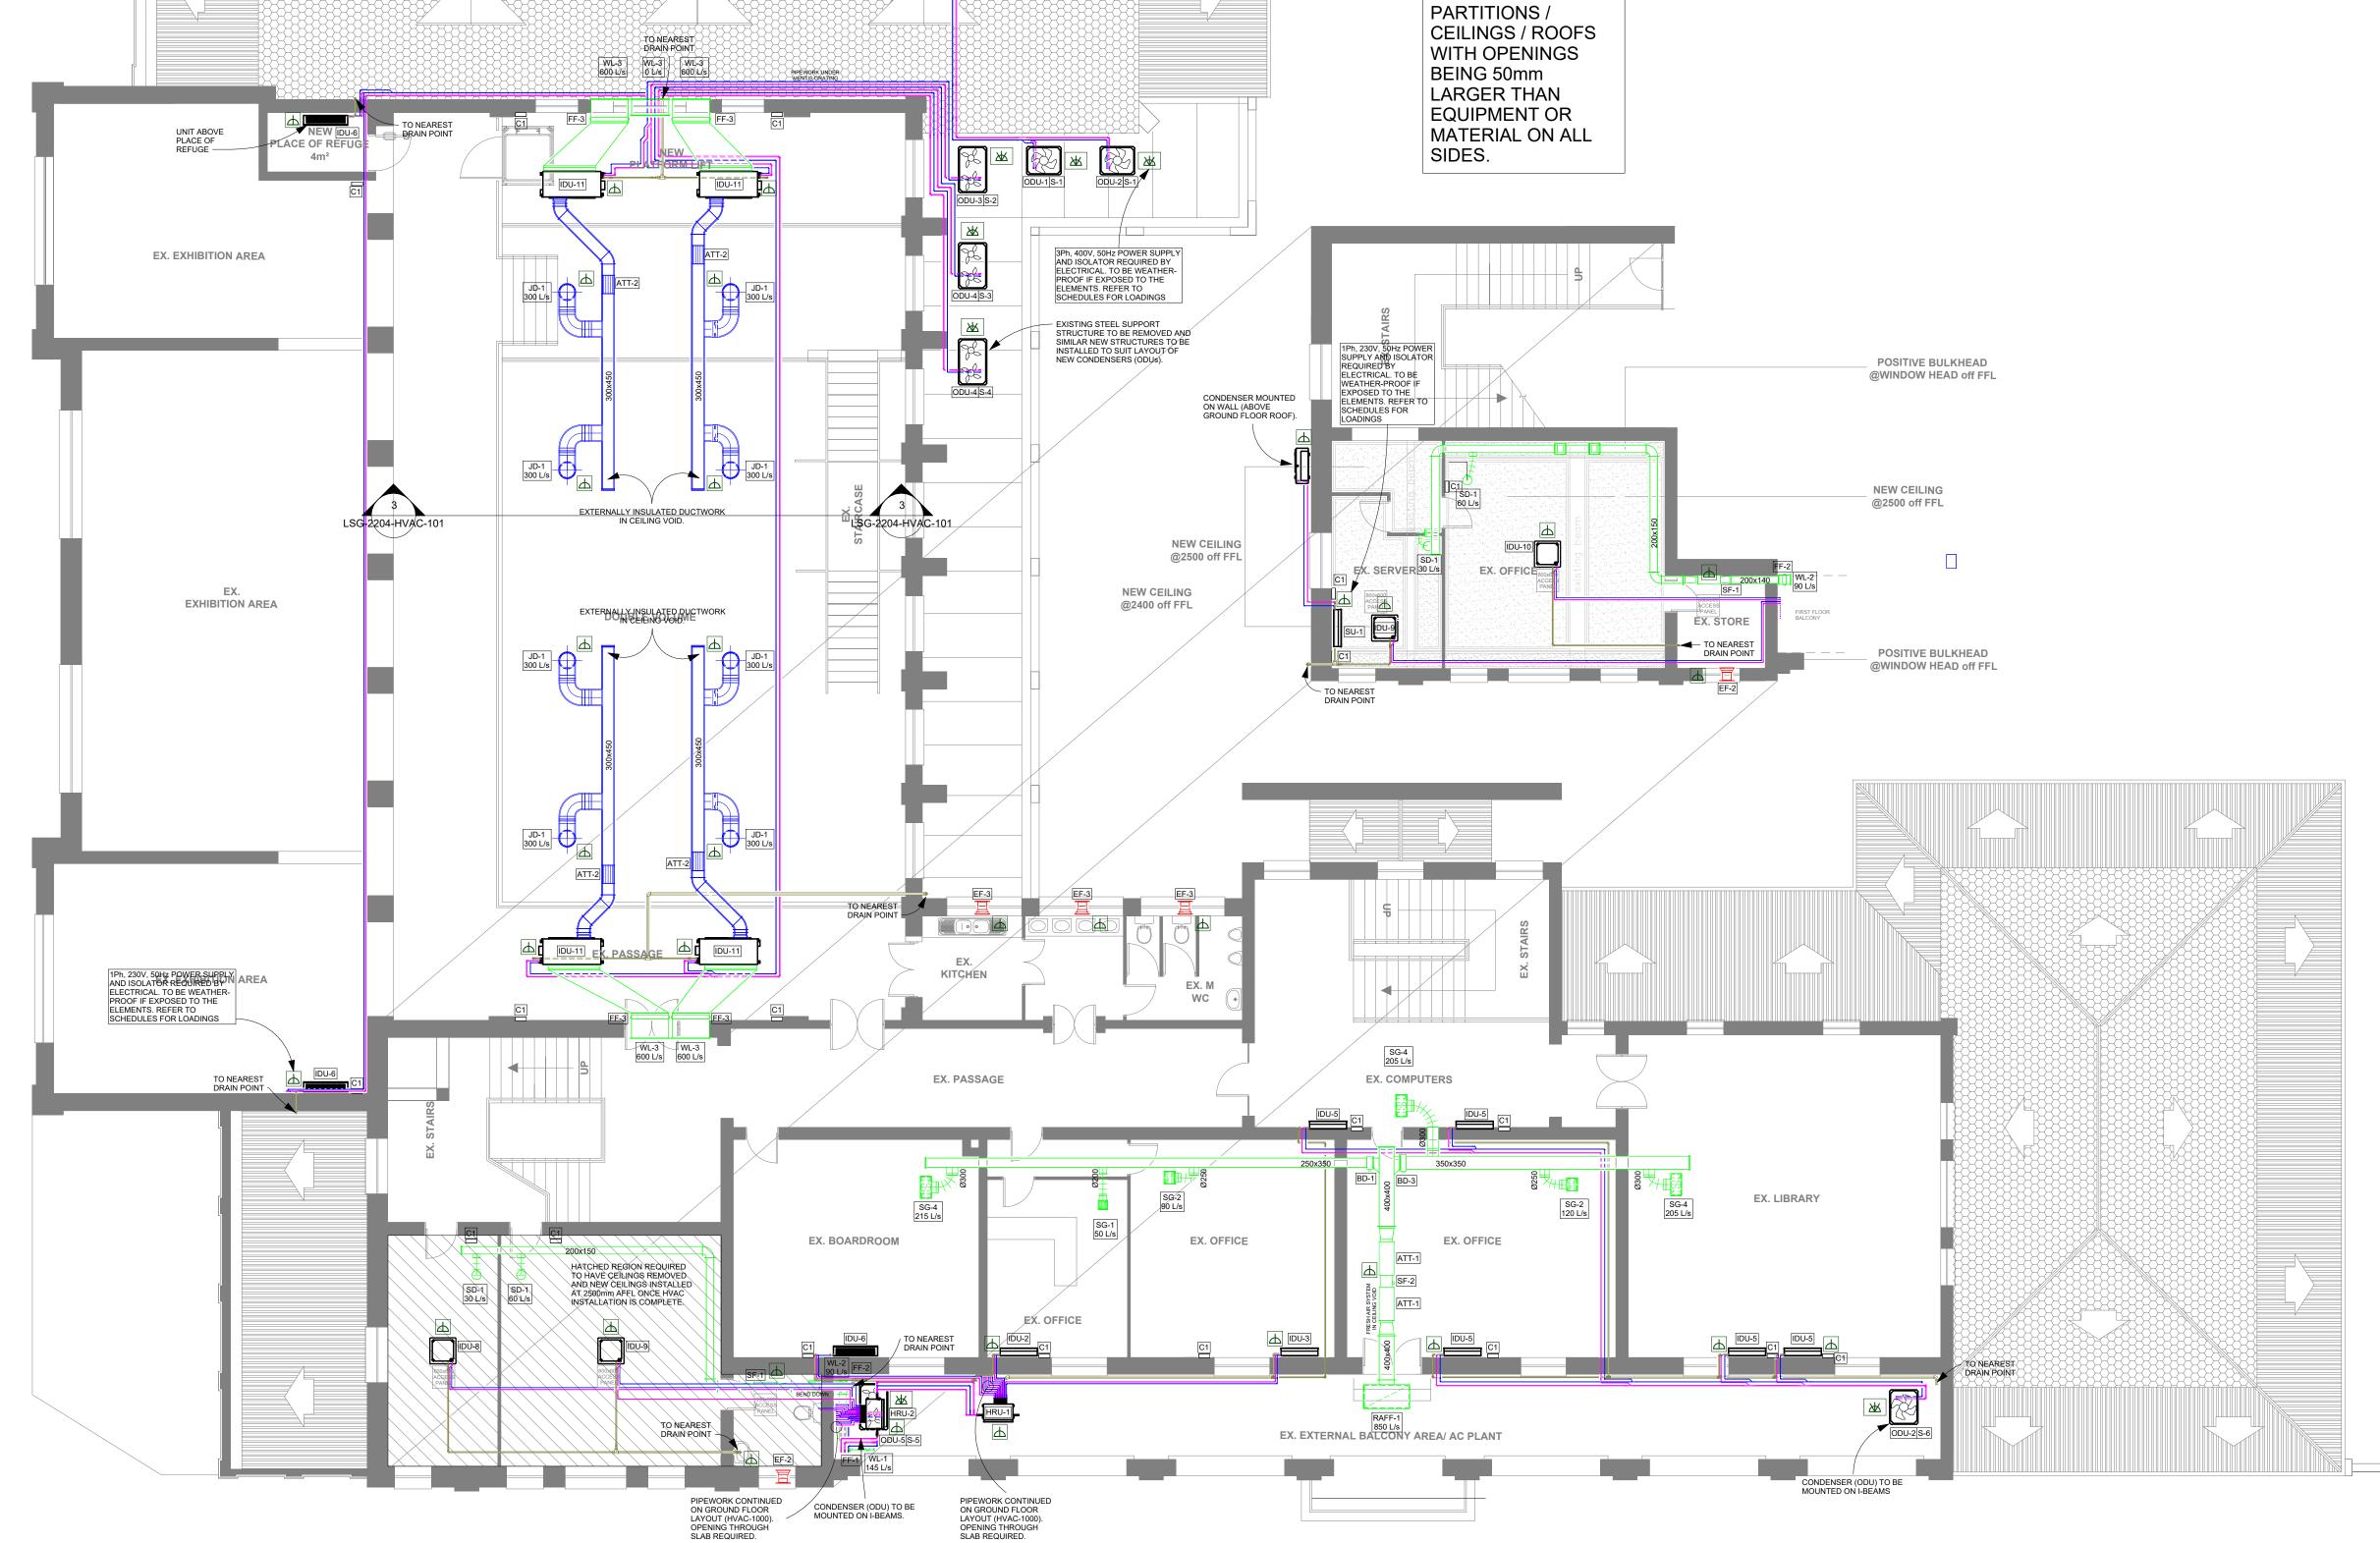

REFERENCE DRAWING: M100 / M101 / M200 / M201 DATE: 08/02/2022 COPYRIGHT RESERVED



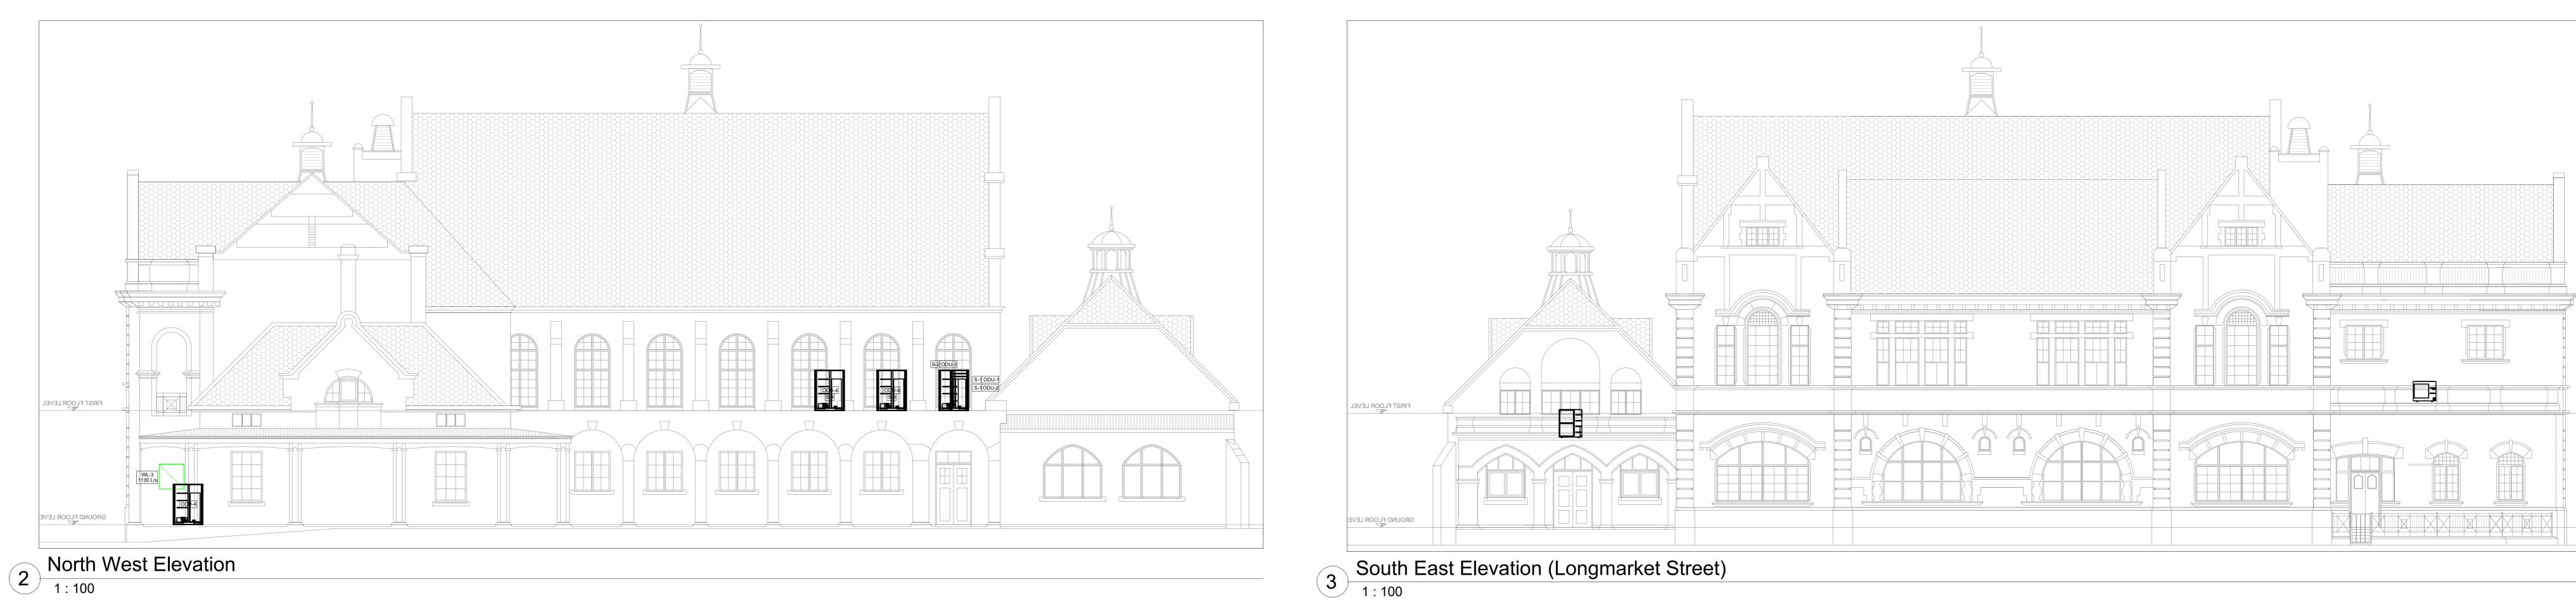





REFERENCE DRAWING: M100 / M101 / M200 / M201

LIST OF REVISIONS

 NO.
 DATE
 DESCRIPTION
 B


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 04/10/22
 Issued for AMAFA Submission
 SC

 I1
 05/10/22
 Revised to Suit Architects Updated Layout
 SC


 T0
 18/04/23
 Issued for Tender
 SG



Lift Drawings

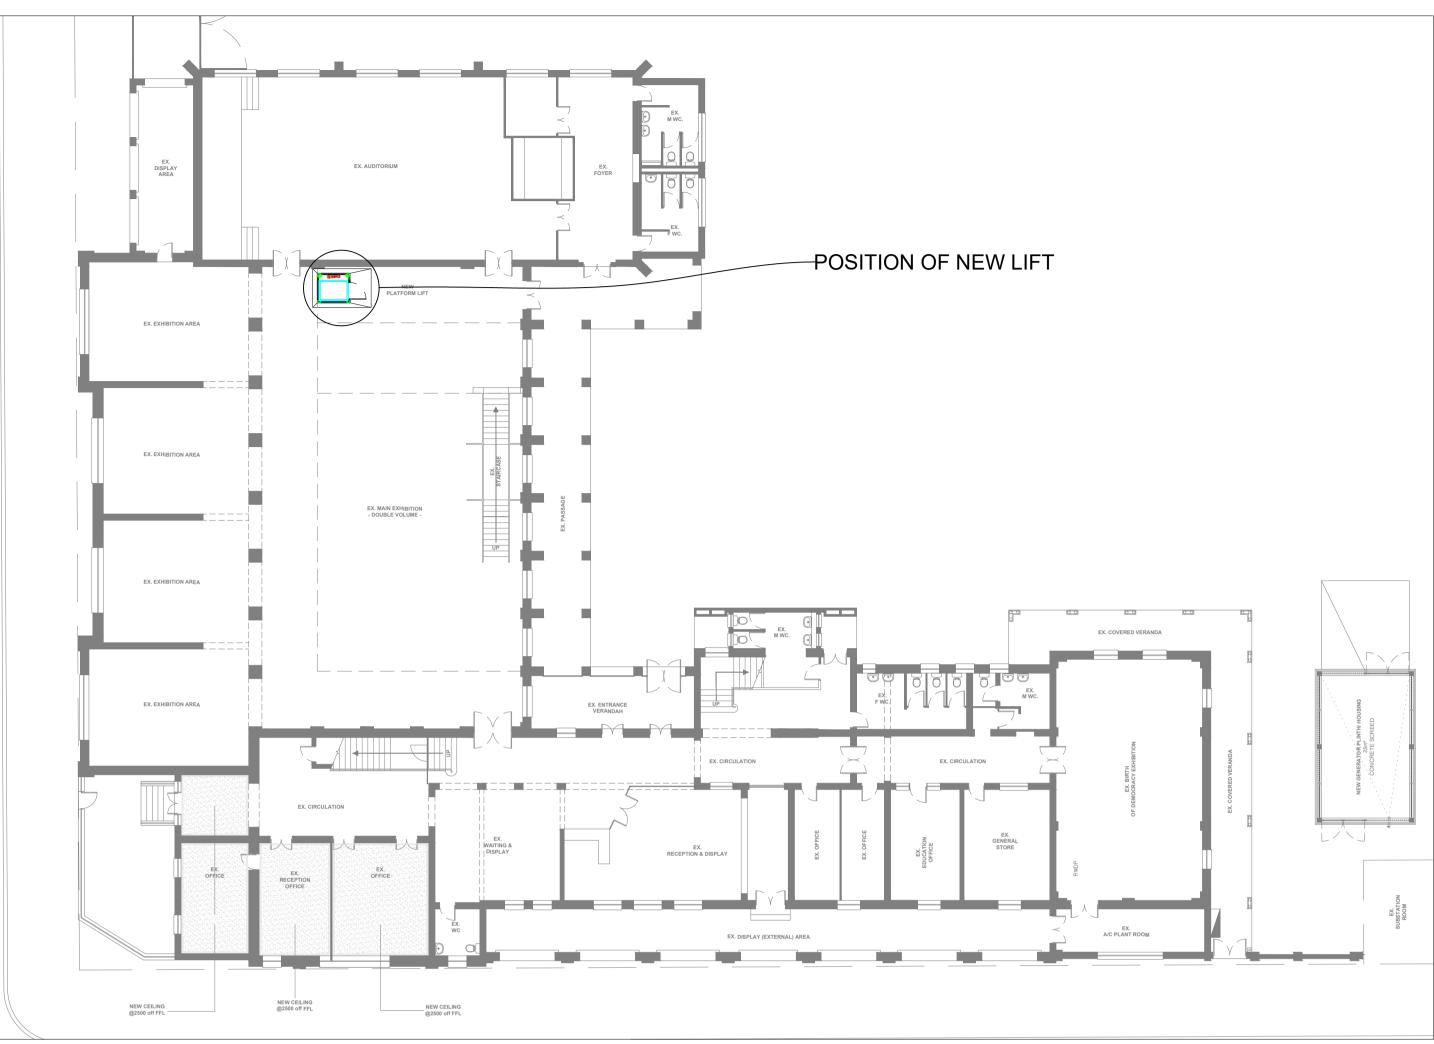


Ground Floor Layout - Showing Lift A Position in Building

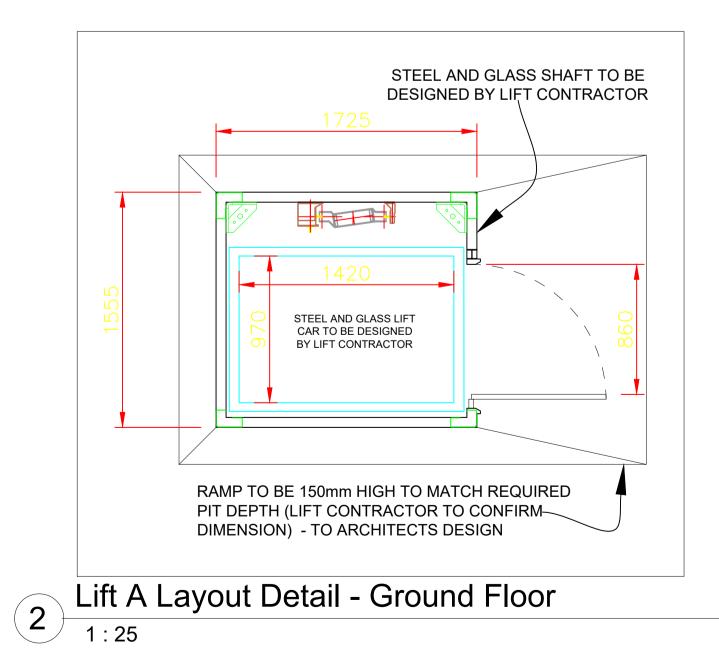

STEEL AND GLASS SHAFT TO BE DESIGNED BY LIFT CONTRACTOR STEEL AND GLASS LIFT CAR TO BE DESIGNED BY LIFT CONTRACTOR Lift A Layout Detail - First Floor

DRAWING FOR INFORMATION AND TENDER PRICING PURPOSES ONLY. LIFT CONTRACTOR IS TO FULLY DESIGN THE LIFT AND SHAFT. INSTALLATION MUST BE BASED ON APPROVED SHOP DRAWINGS.

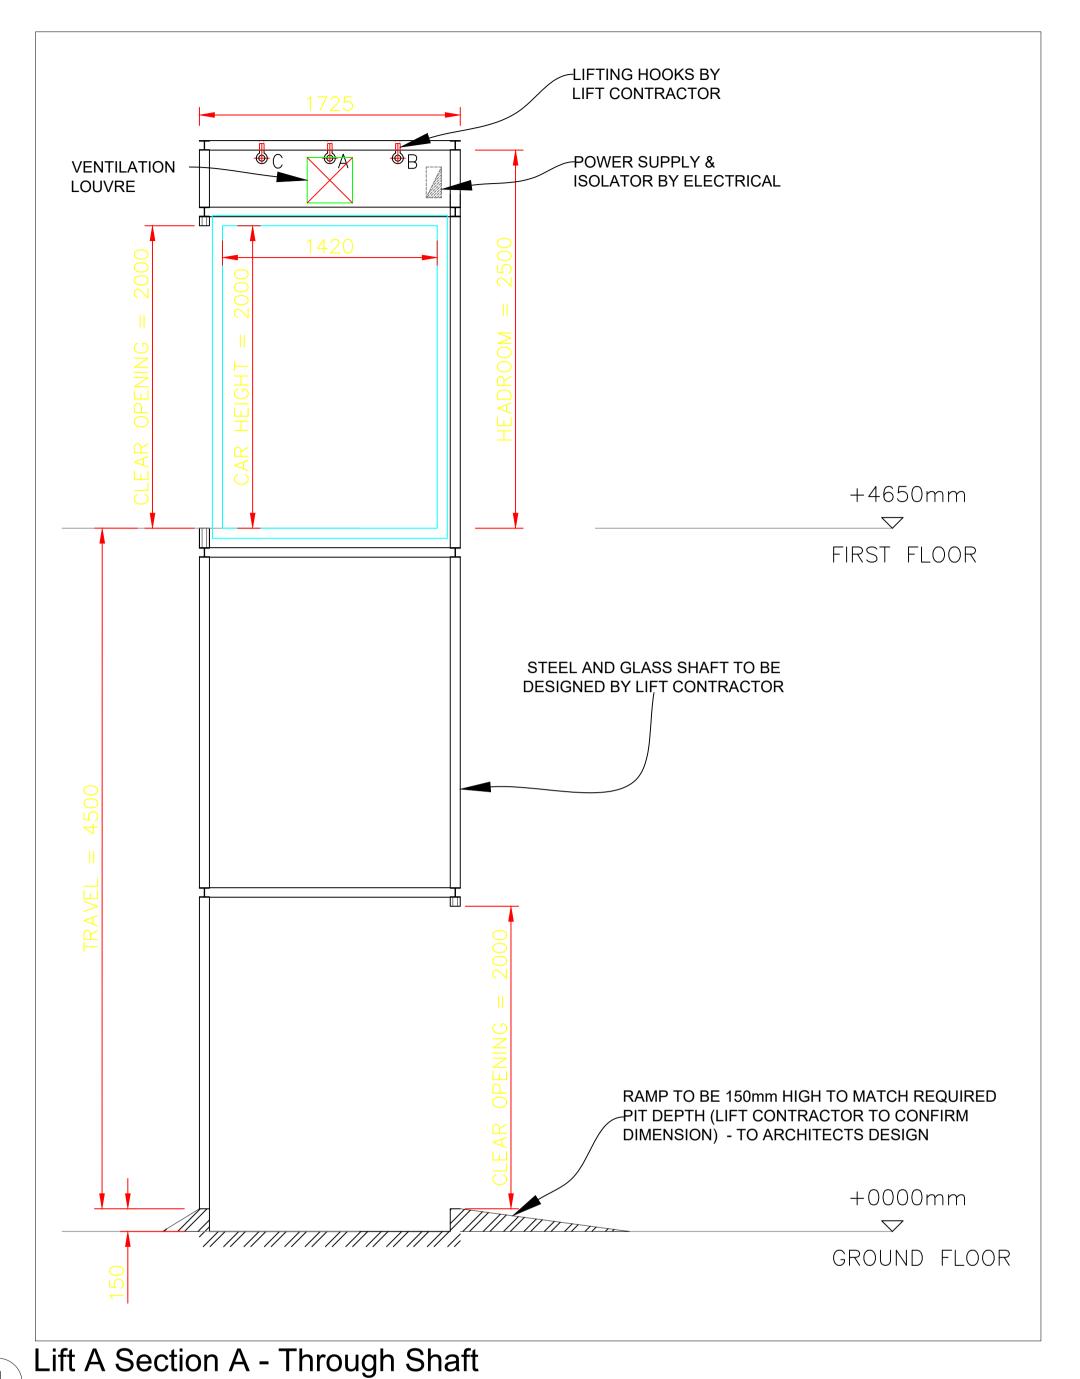

THIS IS A GLASS AND STEEL SCENIC LIFT. ALL FOUR SIDES ARE TO

HAVE A GLASS AND STEEL STRUCTURE. LIFT ARRANGEMENT DRAWING IS FOR INFORMATION PURPOSES ONLY. THE STEEL AND GLASS STRUCTURE IS NOT DRAWN TO SCALE OR DETAIL AS THE LIFT SUPPLIER IS TO PROVIDE STRUCTURAL REQUIREMENTS FOR THE LIFT'S FRAME STRUCTURE. LIFT SUPPLIER TO ENSURE THAT FINAL WORKSHOP DRAWINGS SUIT ALL REQUIREMENTS i.e. SNP (SPECIAL NEEDS PEOPLE) IN TERMS OF HEIGHT OF BUTTONS, BRAILLE ETC.

LIFT PIT DRAINAGE TO CIVIL ENGINEERS DETAILS. LOP - LANDING OPERATING PANEL, TO ALSO INDICATE DIRECTION AND LOCATION OF CAR.

ALL LEVELS INDICATED ARE ROUGH CONCRETE LEVELS FOR

FINISHED FLOOR LEVELS ADD +50mm FOR SCREED/TILE.

2. ALL DIMENSIONS TO BE CONFIRMED BY LIFT CONTRACTOR.

ELECTRICAL REQUIREMENTS

230V, 1 PHASE, 50HZ (±5%). 1 X DISTRIBUTION BOARD PER LIFT.

1 X 1 PHASE ISOLATOR PER LIFT. THE DB IS TO BE OUTSIDE THE SHAFT ABOVE THE CONTROLLER UNIT. LIFT CONTRACTOR TO INDICATE CORRECT POSITIONS ON SITE.

LIGHTING SUPPLY 230V, SINGLE PHASE, 50HZ.

1 X EARTH LEAKAGE. 1 X SINGLE PHASE ISOLATOR

NB: THE SINGLE-PHASE SHOULD HAVE IT'S OWN SEPARATE SUPPLY.

1 X 15A SOCKET IN PIT OR TOP OF SHAFT

1 X EARTH LEAKAGE 1 X SINGLE SOCKET ON TOP OF THE CABIN - BY LIFT CONTRACTOR

NB: THE SINGLE-PHASE SHOULD HAVE IT'S OWN SEPARATE SUPPLY.

SHAFT LIGHTING SHOULD BE 500MM FROM THE TOP AND BOTTOM. THE INTERMEDIATE FIXING SHOULD BE AT EVERY FLOOR LEVEL PLUS TWO WAY SWITCHING MIN. 50 LUX THROUGHOUT THE SHAFT. NO INSTALLATION CONDUIT OR ACCESSORIES TO BE WITHIN WALLS OF LIFT SHAFT. TWO LIGHTING POINTS PER ELEVATOR, TOGETHER WITH ONE 16 AMP. 3-PIN POWER PLUG IN THE MOTOR-ROOM / TOP OF SHAFT.

ENGINEERS INC. Head Office (KZN)
Unit 7&8 Doncaster Park,
10 Derby Place, Derby Downs Office Park, 239 Lange Street, Nieuw Muckleneuk Pretoria, 0181 Tel.: +27 (31) 205 2335 Tel.: +27 (12) 346 8676 DESIGN INFORMATION DESIGNED: CHECKED: DATE: SG GG 18/04/23 CLIENT INFORMATION Msunduzi Museum an agency of the PROJECT INFORMATION PROJECT DESCRIPTION: **Building Upgrade** PROJECT NAME: Msunduzi Complex Main Museum 351 Langalibalele St, Pietermaritzburg SITE DESCRIPTION: Museum DRAWING INFORMATION Lift A Layout - Disabled Platform Lift DRAWING SCALE: SHEET SIZE: As Shown DRAWING NUMBER: REVISION: LSG-2204-LIFT-800 T0

CONSULTANT INFORMATION

LSG CONSULTING


LIST OF REVISIONS

T0 18/04/23 Issued for Tender

REFERENCE DRAWING: 5044 - 100 COPYRIGHT RESERVED DATE: 05/10/2022



Electrical Drawings

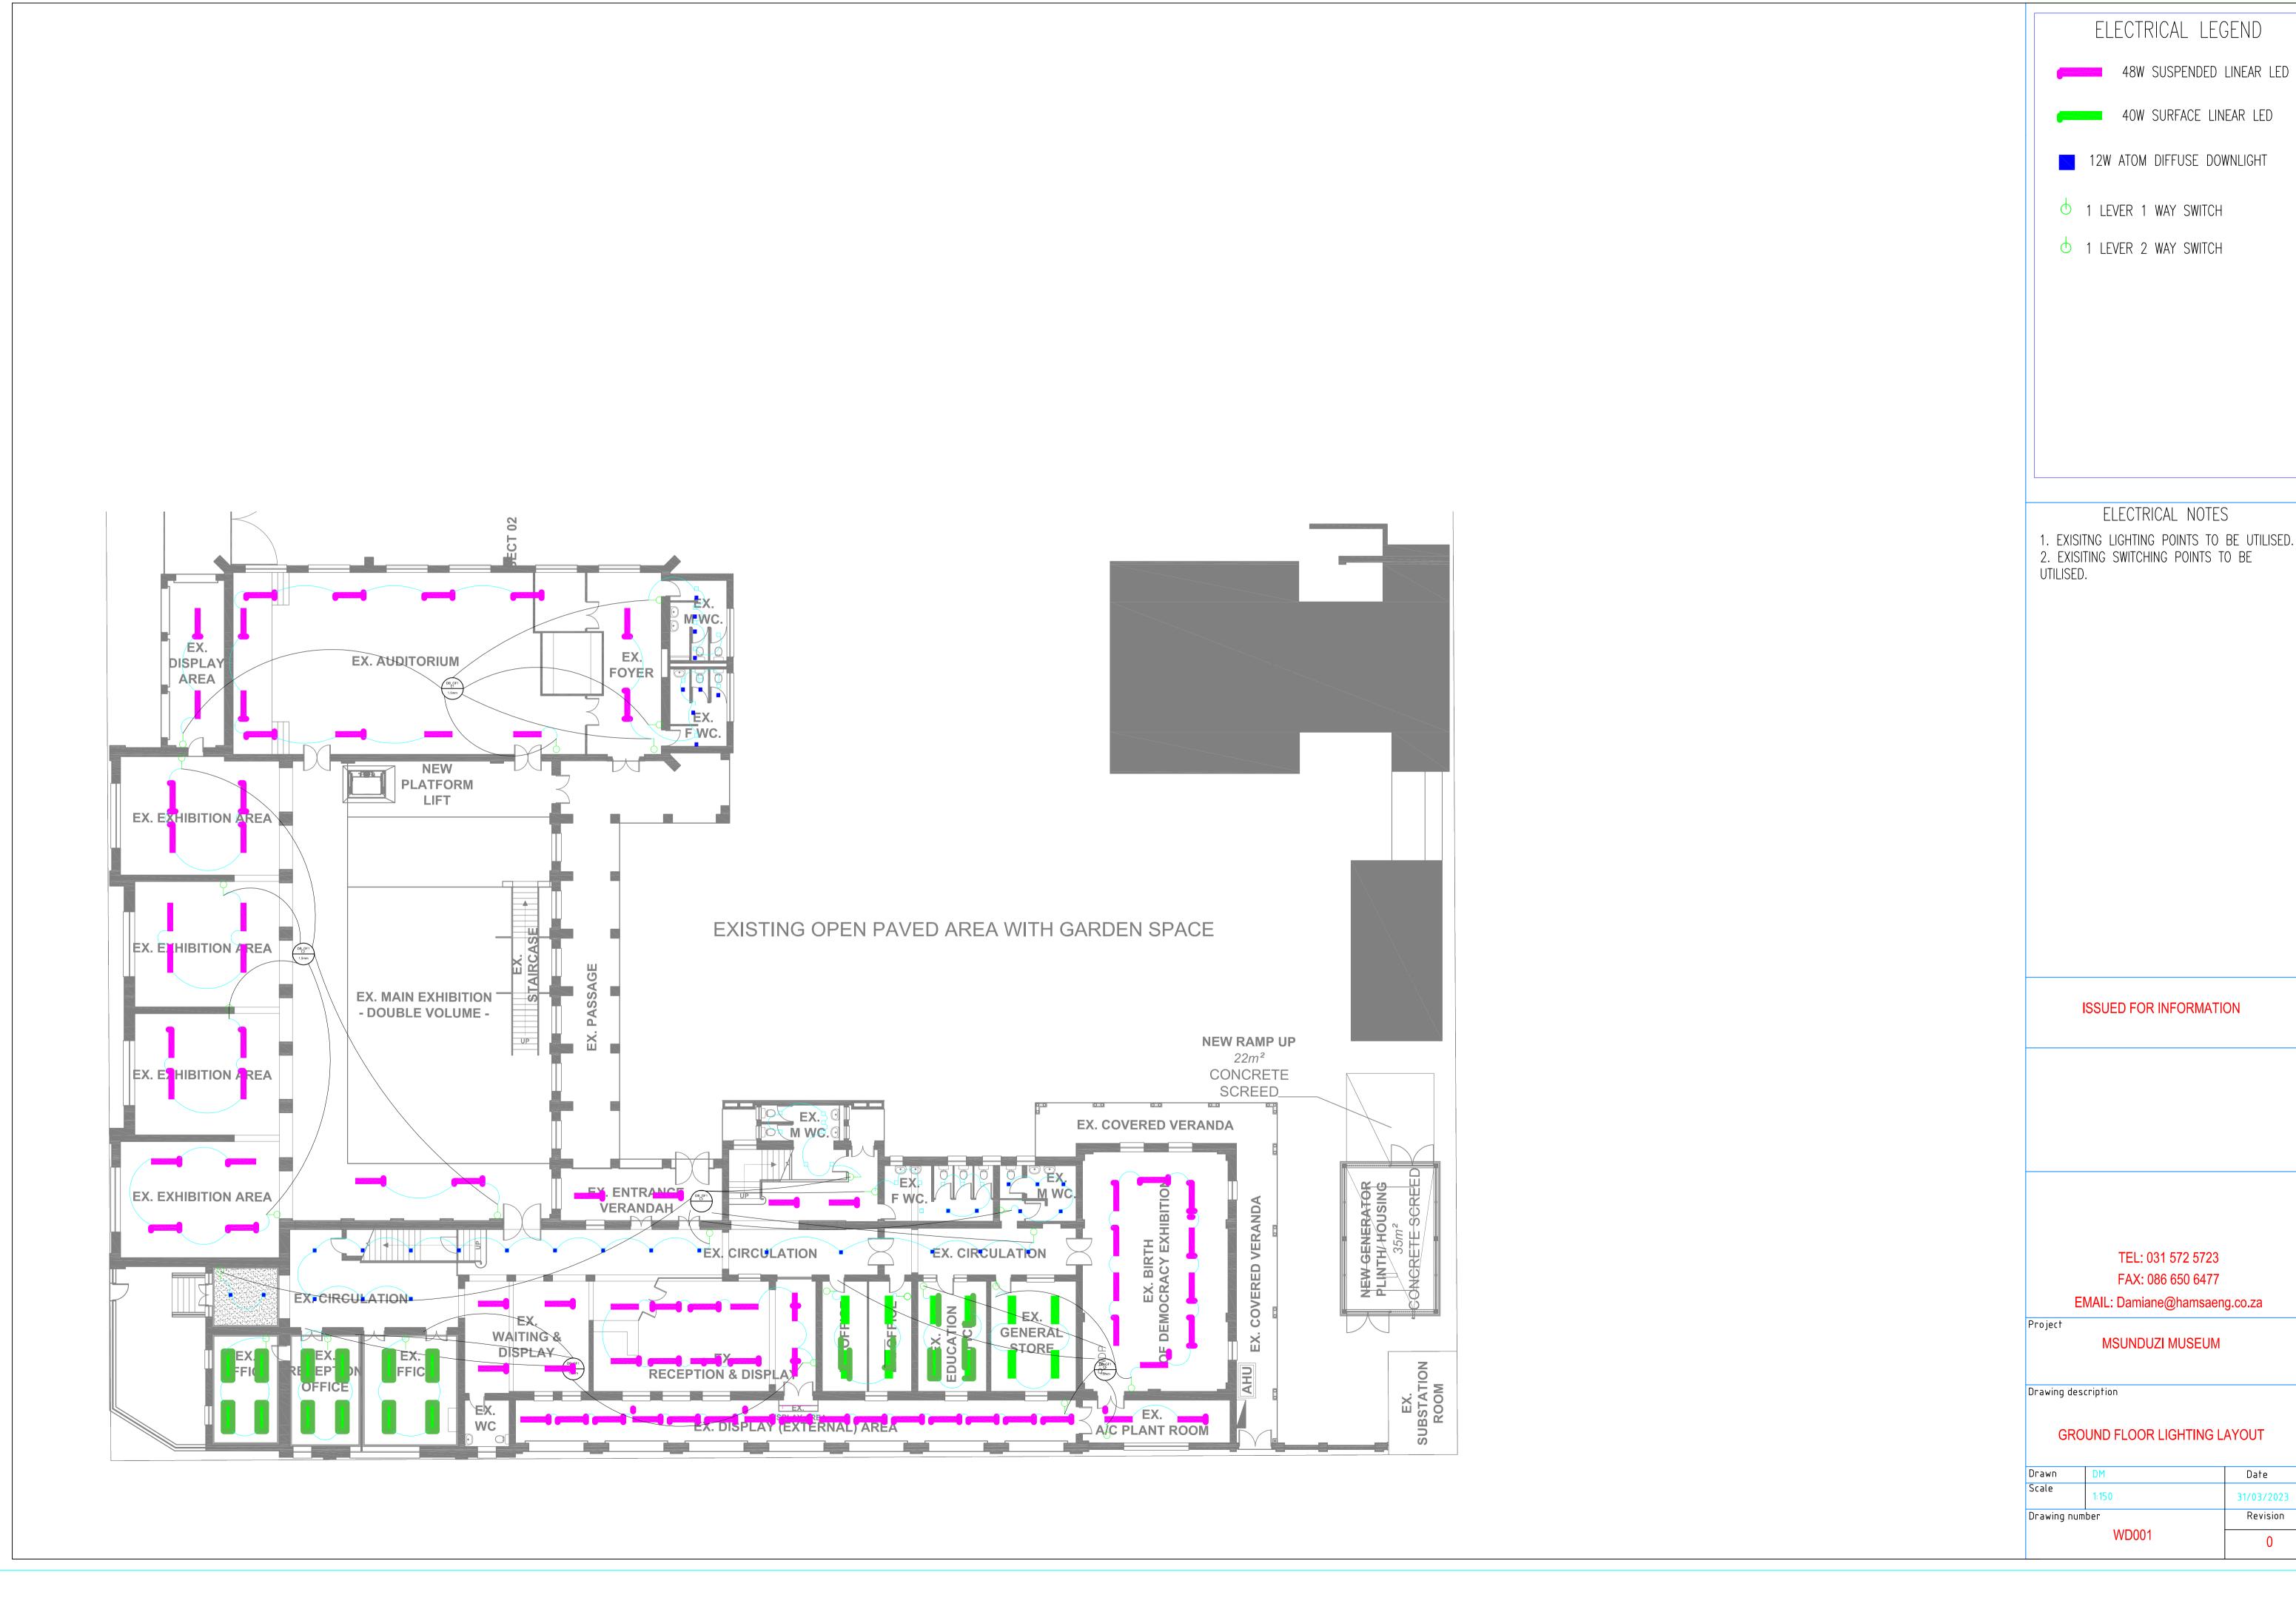

Date

Revision

0



ELECTRICAL LEGEND

48W SUSPENDED LINEAR LED

40W SURFACE LINEAR LED

12W ATOM DIFFUSE DOWNLIGHT

144W SUSPENDED PENDANT

ELECTRICAL NOTES

EXISITNG LIGHTING POINTS TO BE UTILISED.
 EXISITING SWITCHING POINTS TO BE UTILISED.

ISSUED FOR INFORMATION

TEL: 031 572 5723 FAX: 086 650 6477

EMAIL: Damiane@hamsaeng.co.za

-


MSUNDUZI MUSEUM

Drawing description

FIRST FLOOR LIGHTING LAYOUT

Drawn	DM	Date
Scale	1:150	31/03/2023
Drawing num	ber	Revision
	WD002	0

FIRST FLOOR - EXISTING LAYOUT WITH NEW LIFT

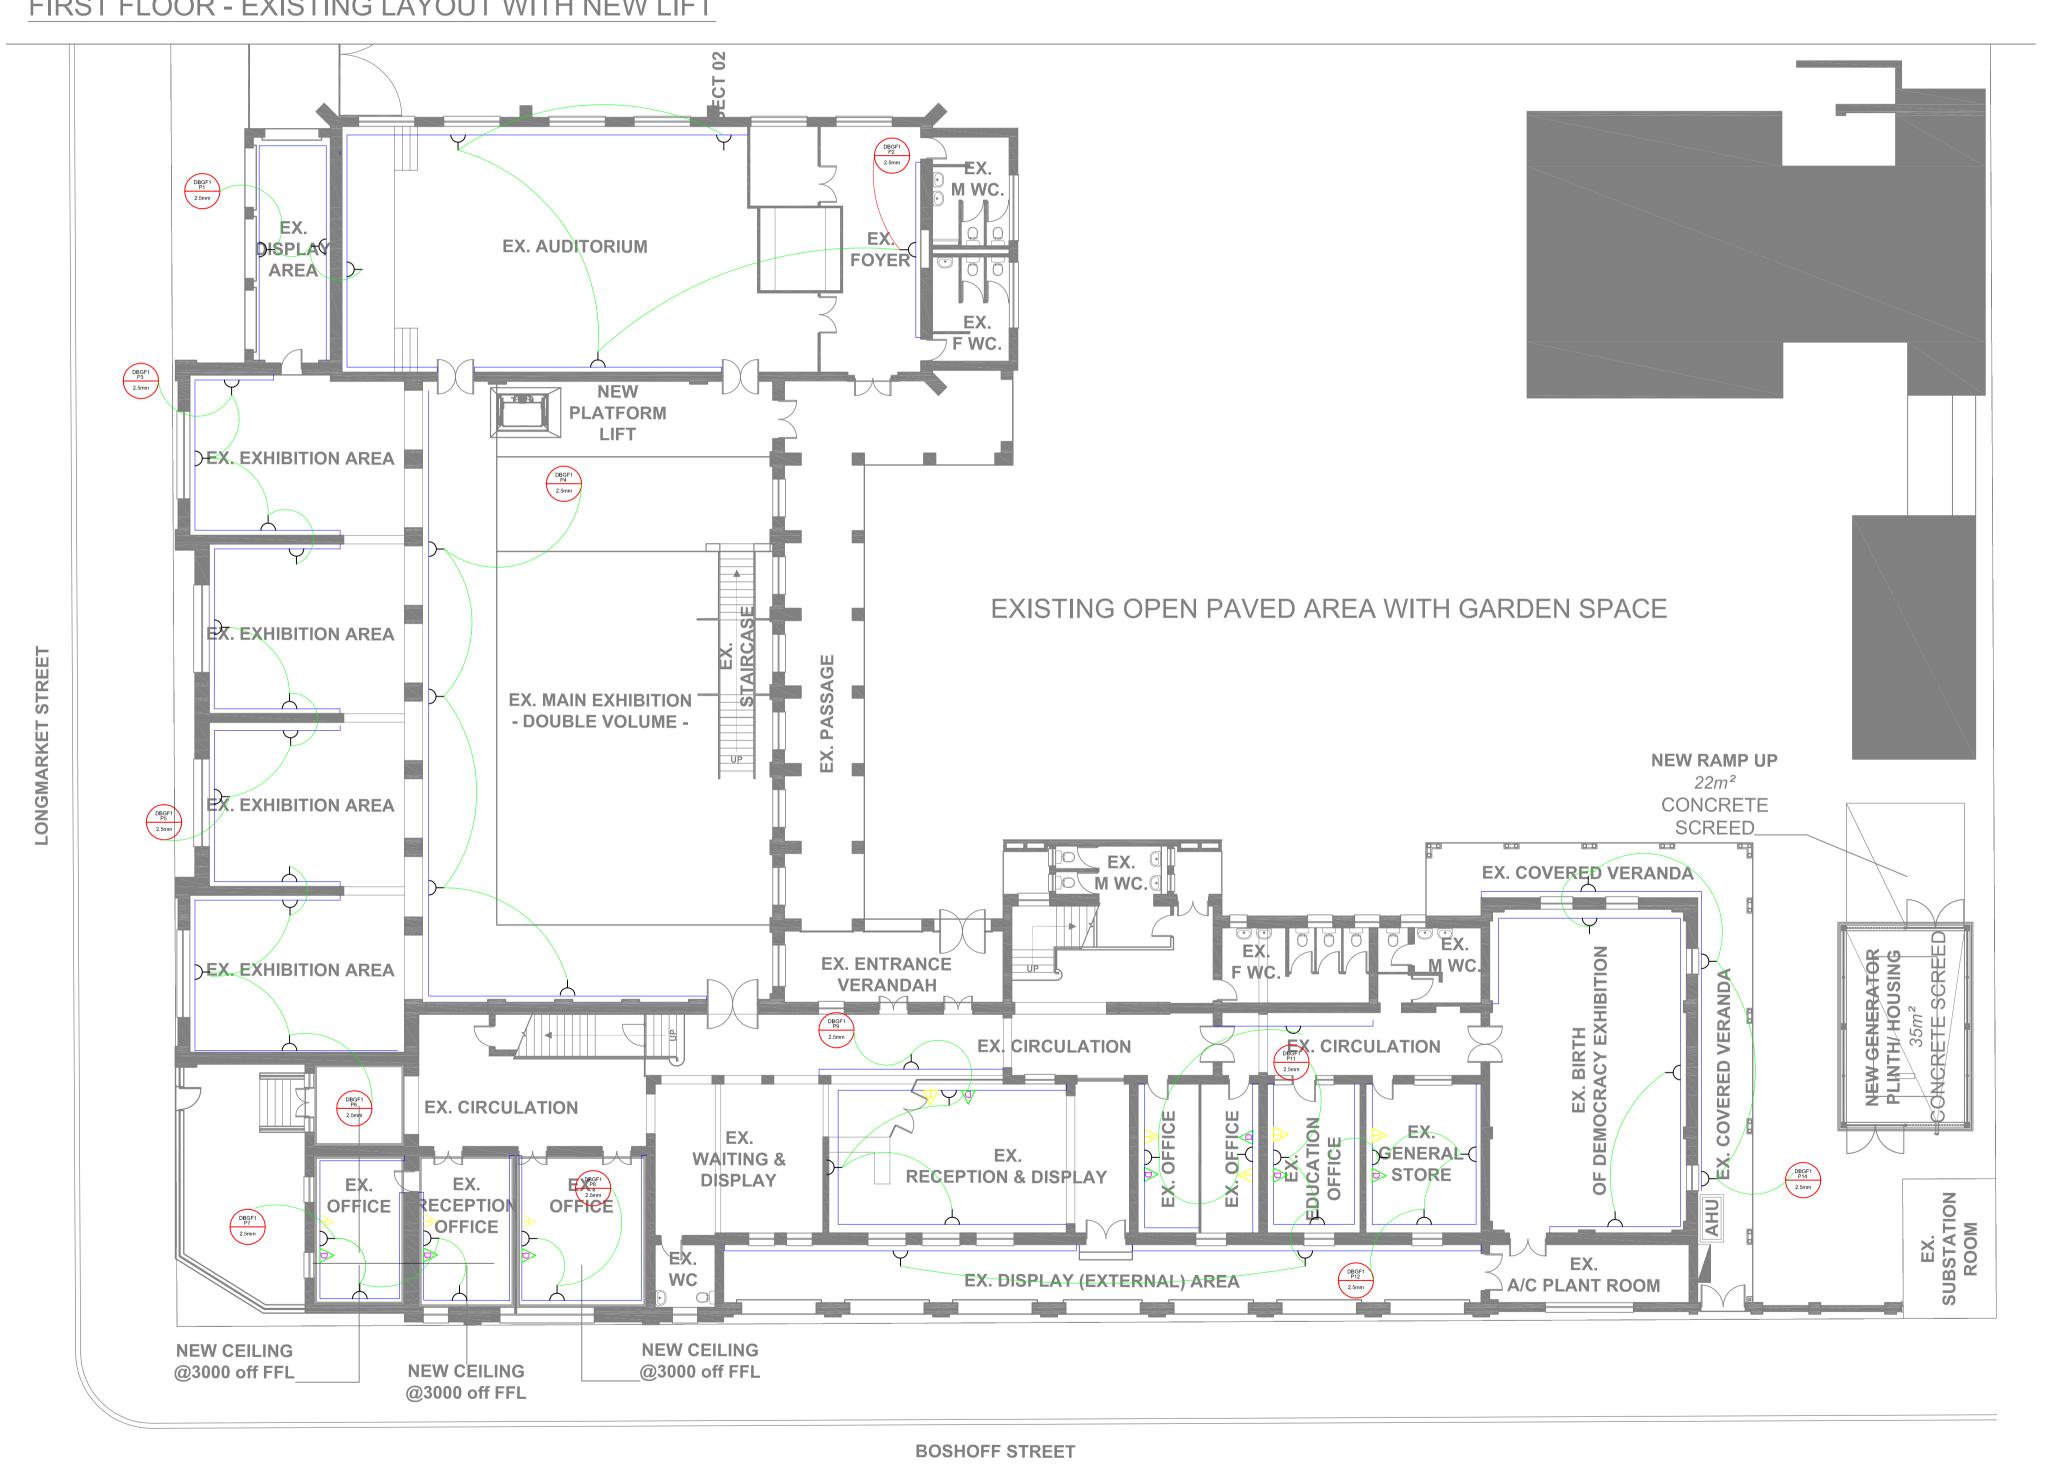

ELECTRICAL LEGEND

DEDICATED SWITCH SOCKET OUTLET

SWITCH SOCKET OUTLET

TELEPHONE POINT

DISTRIBUTION BOARD

NETWORK POINT

2 CHANNEL POWER SKIRTING

ELECTRICAL NOTES

1. SOCKET OUTLETS TO BE WIRED AS PER SANS 10142

2. EXISTING SOCKET OUTLET POSITIONS TO BE UTILISED, EXISTING WIREWAYS TO ALSO BE UTILISED.

3. NEW WIRE TO ALL NEW ELECTRICAL

OUTLETS.

ISSUED FOR INFORMATION

TEL: 031 572 5723 FAX: 086 650 6477


EMAIL: Damiane@hamsaeng.co.za Project

MSUNDUZI MUSEUM

Drawing description

POWER_LAYOUT GROUND_FLOOR

Drawn	DM	Date
Scale	1:150	31/03/2023
Drawing number		Revision
WD 003		0

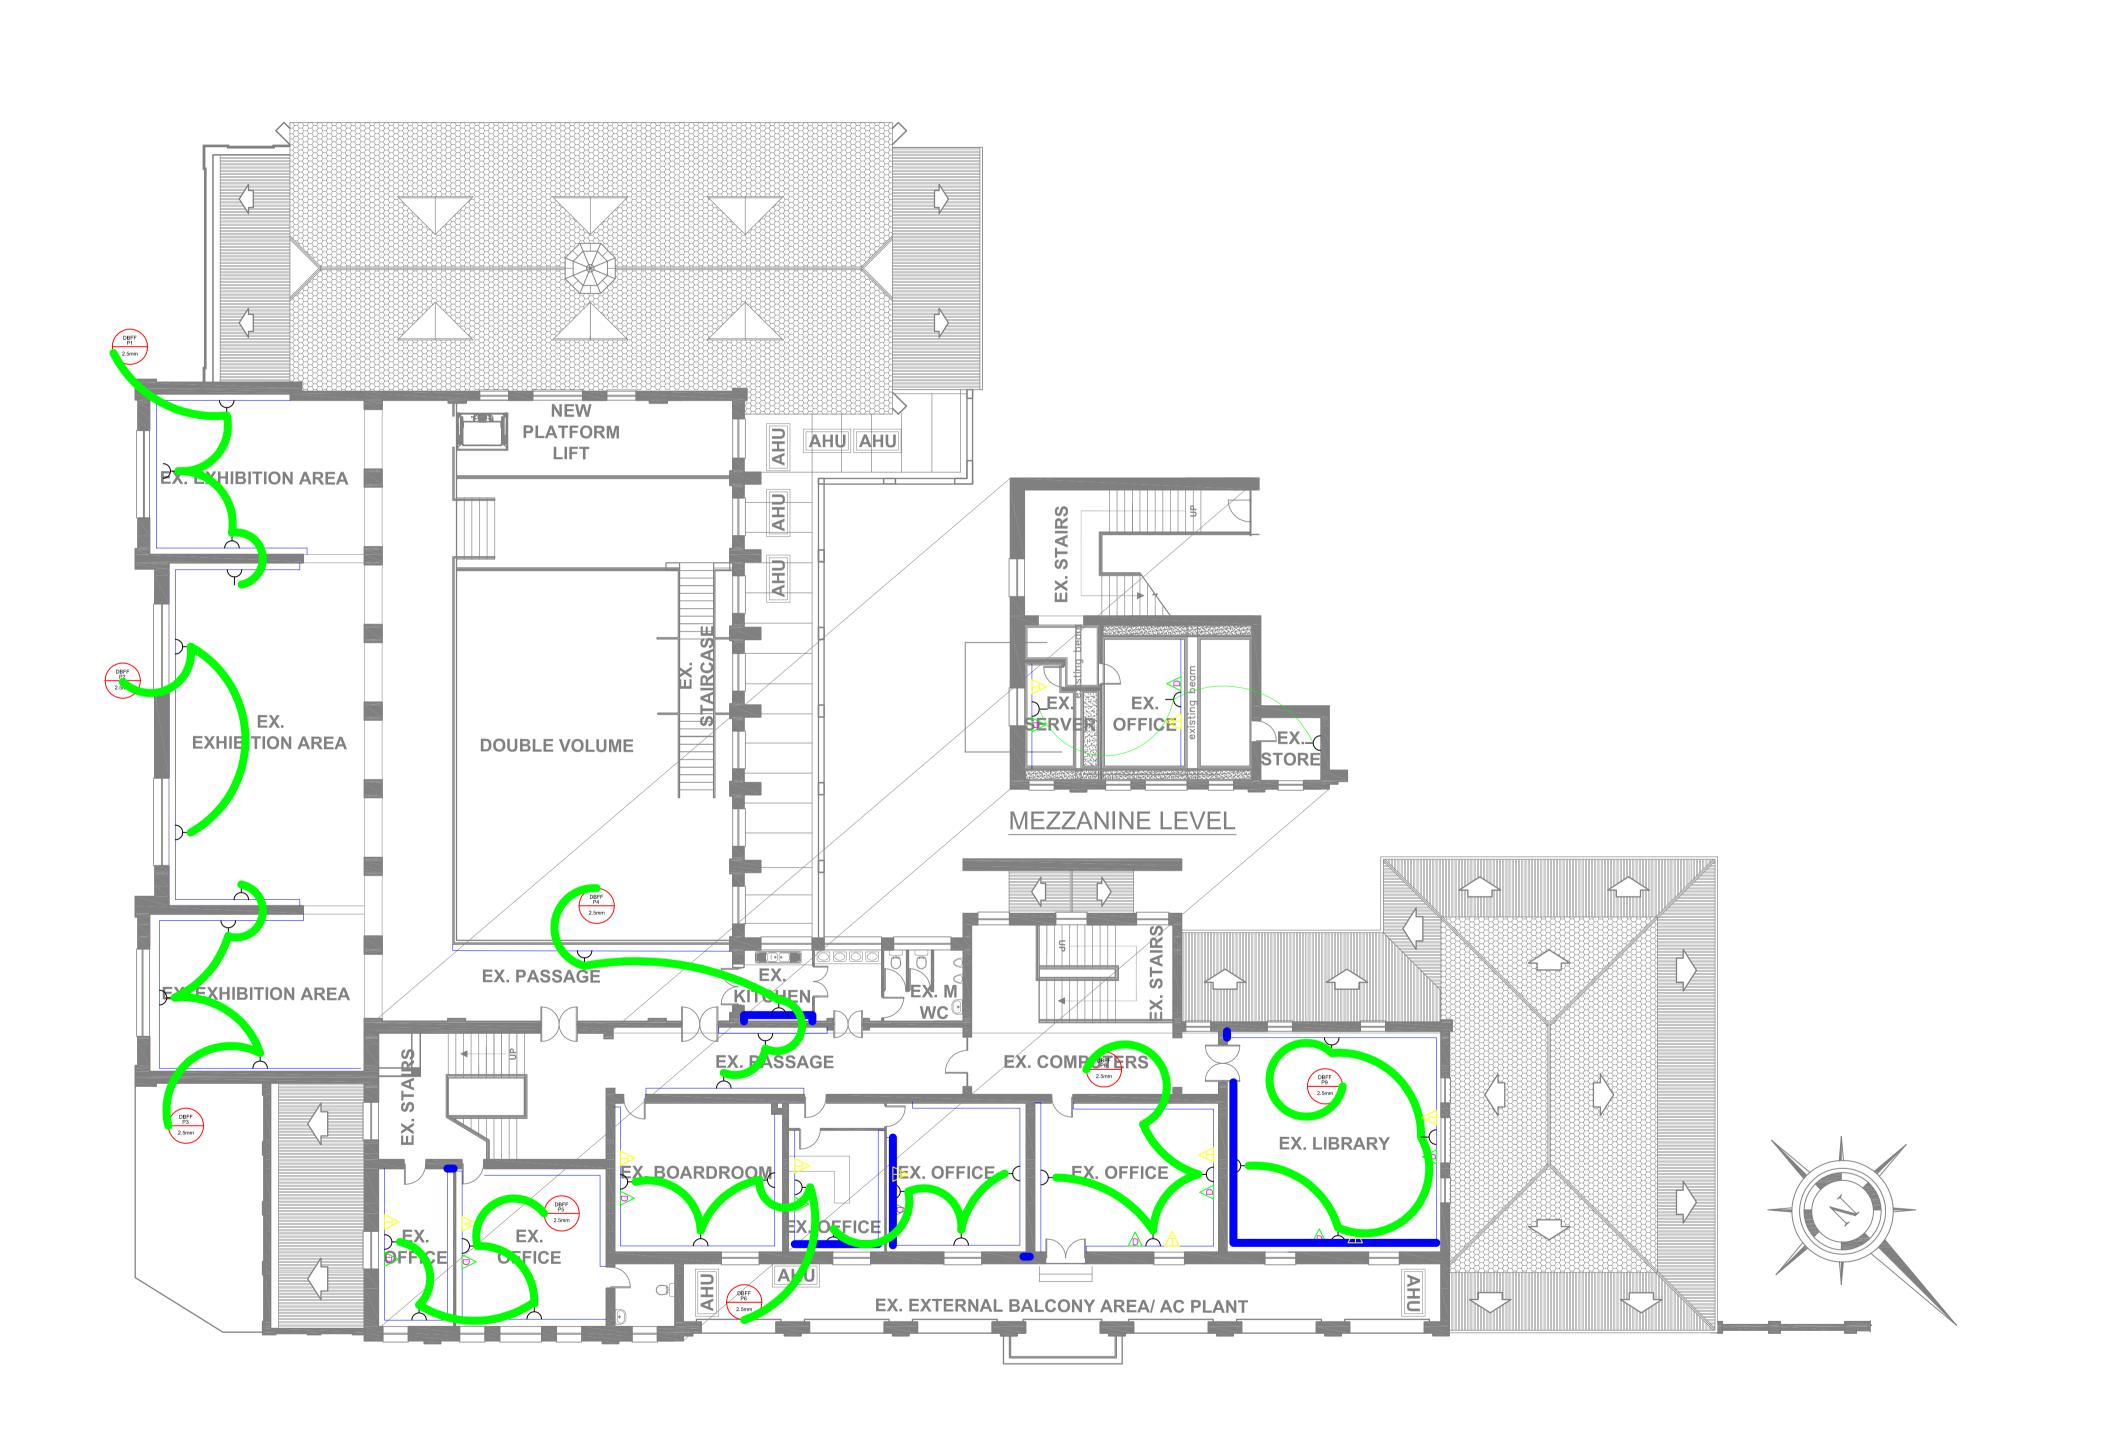

ELECTRICAL LEGEND

SWITCH SOCKET OUTLET



DEDICATED SWITCH SOCKET OUTLET TELEPHONE POINT

NETWORK POINT

DISTRIBUTION BOARD

2 CHANNEL POWER SKIRTING

ELECTRICAL NOTES

1. SOCKET OUTLETS TO BE WIRED AS PER SANS 10142

2. EXISTING SOCKET OUTLET POSITIONS TO BE UTILISED, EXISTING WIREWAYS TO ALSO BE UTILISED.

3. NEW WIRE TO ALL NEW ELECTRICAL OUTLETS.

ISSUED FOR INFORMATION

TEL: 031 572 5723 FAX: 086 650 6477

EMAIL: Damiane@hamsaeng.co.za

MSUNDUZI MUSEUM


Drawing description

POWER_LAYOUT FIRST_FLOOR


Date Drawn Scale 31/03/2023 Drawing number Revision WD 004 0




STRUCTURAL DRAWINGS

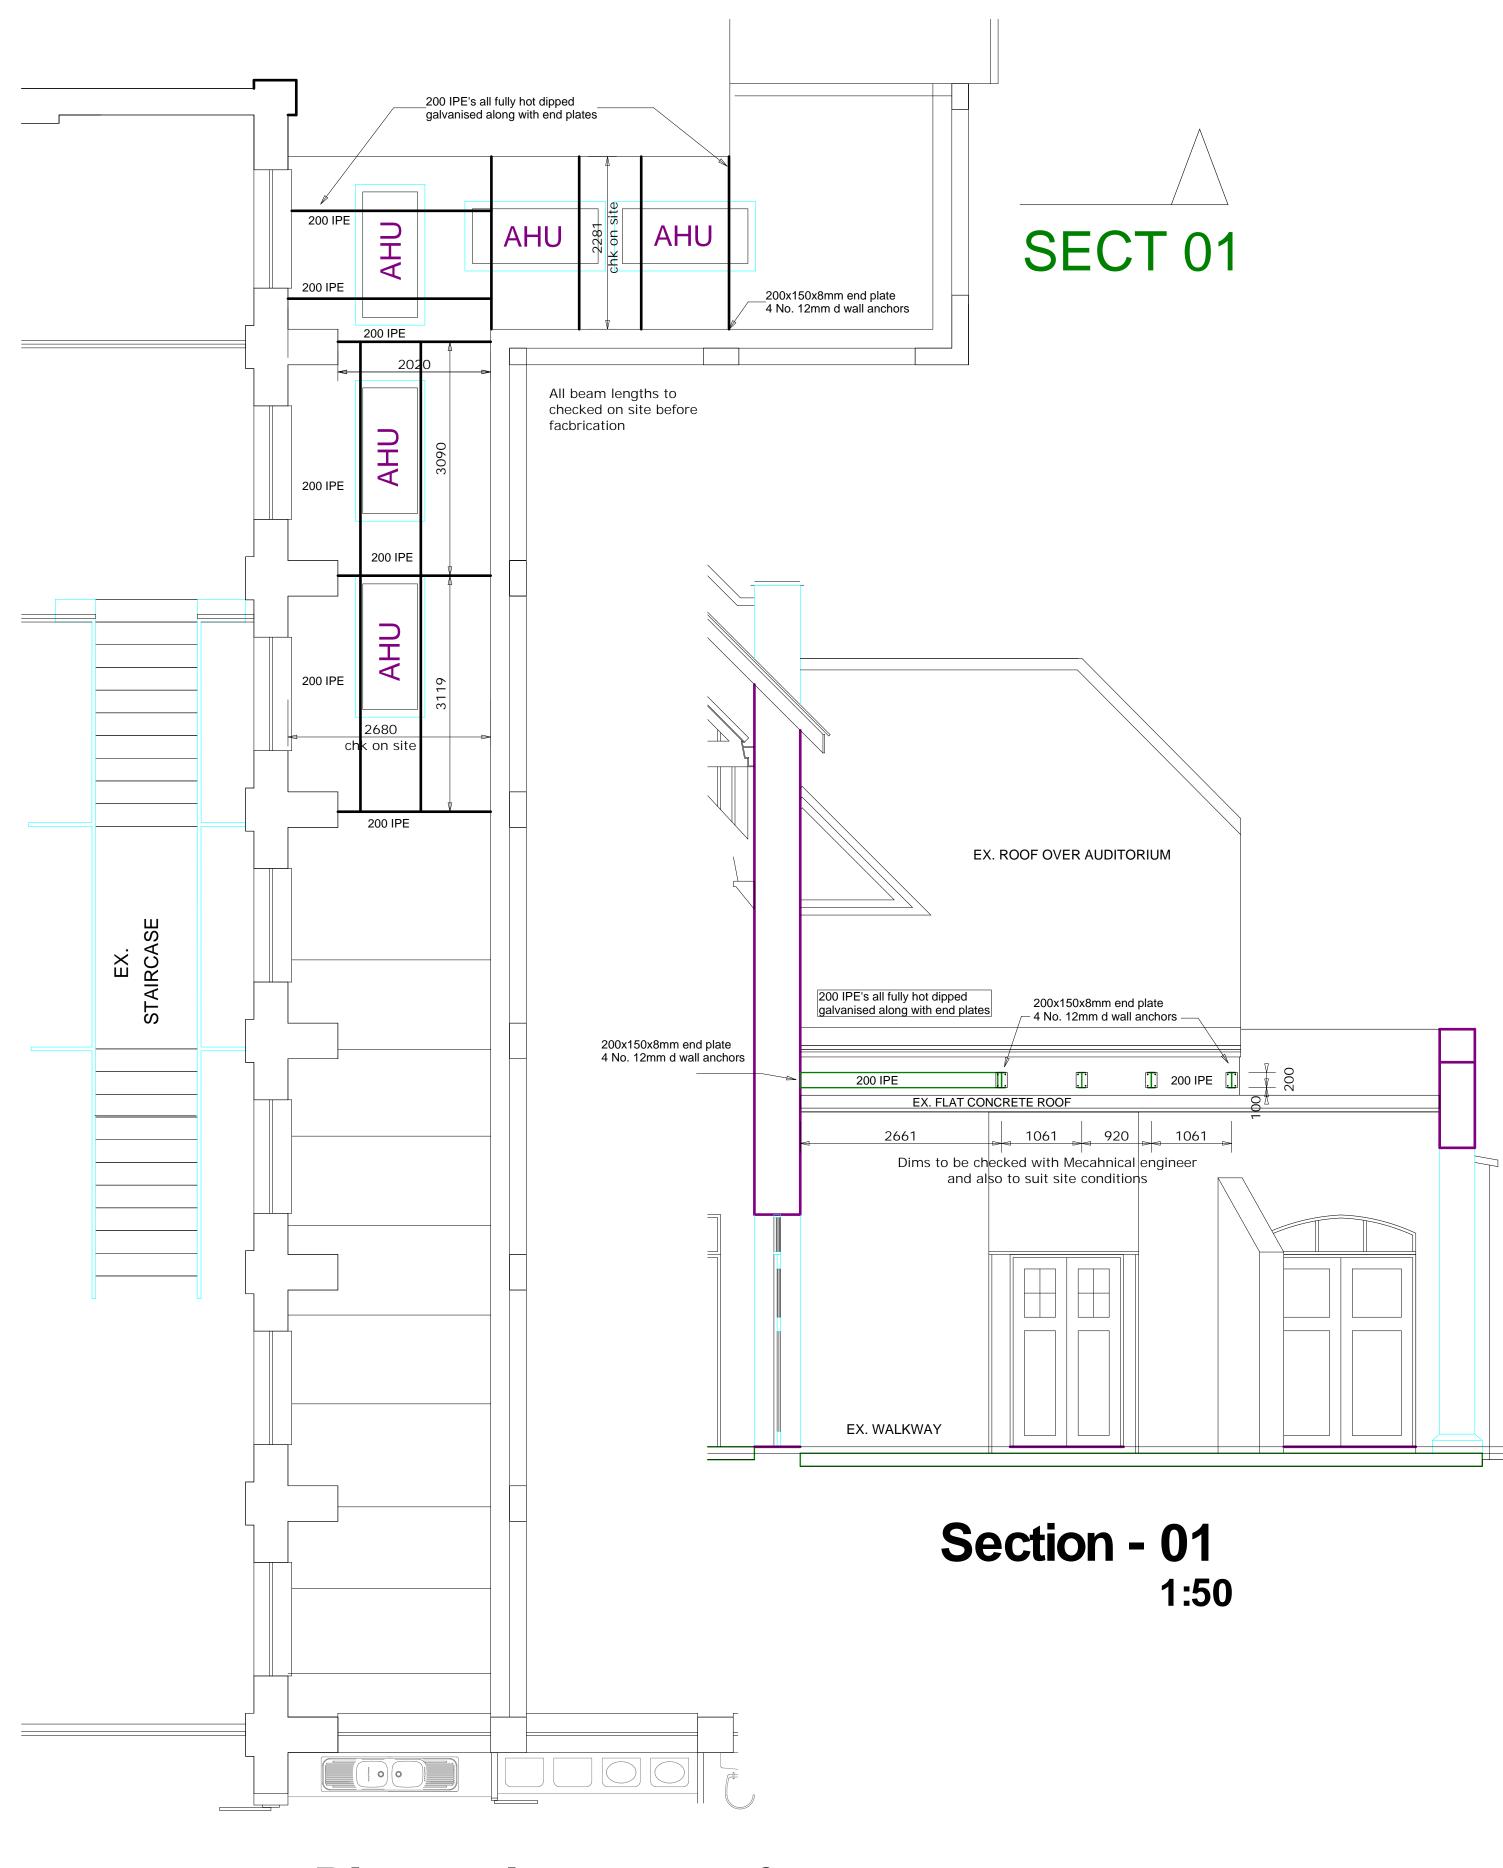


Plan on lean-to roof 1:50

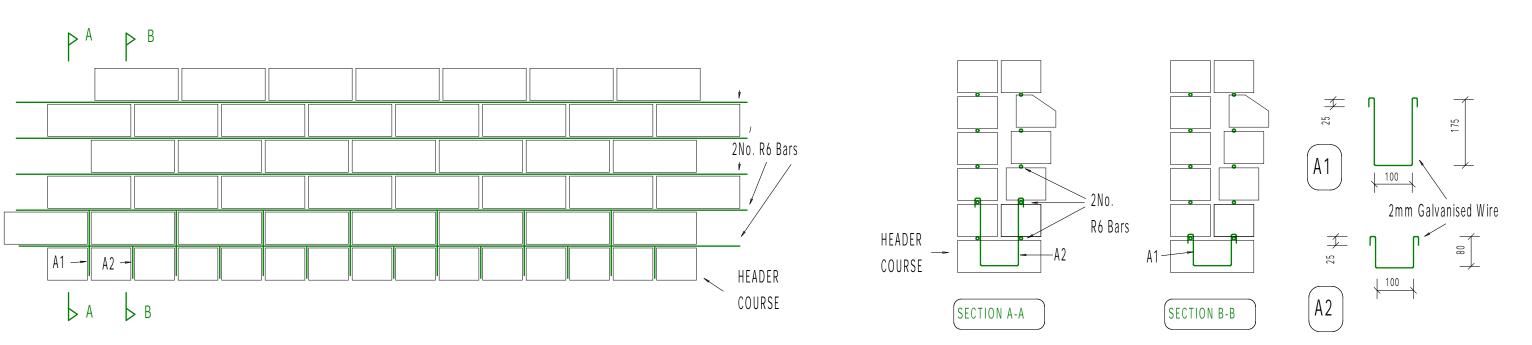


ELEVATION OF BRICK BEAM OVER OPENNINGS

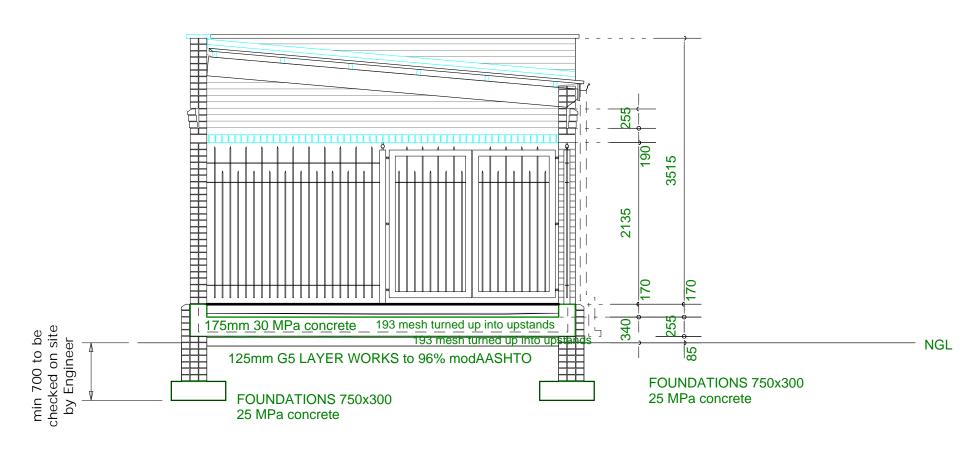

CROSS SECTION - 1:50

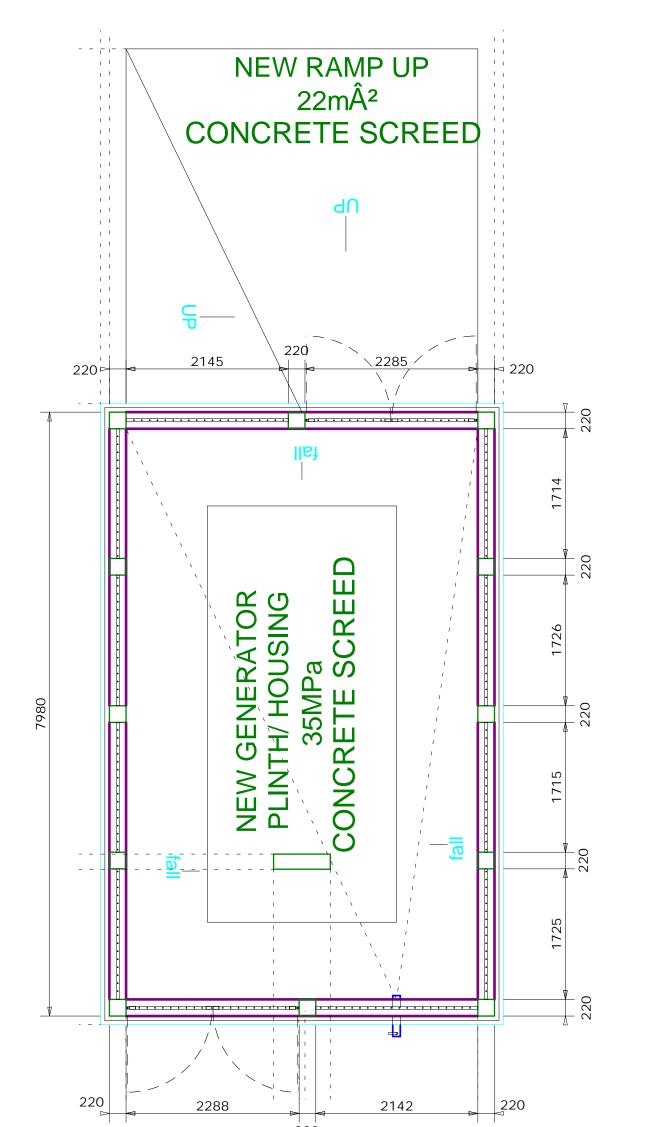

NEW GENERATOR HOUSING PLAN - 1:50

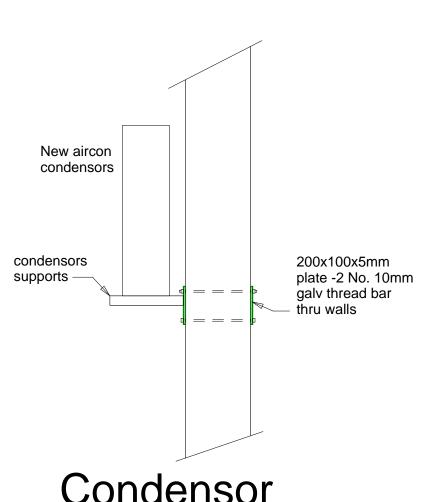

Condensor supports - 1:20

