


NOTES PARAPET ROOF +6500 100mm X 30mm X 1600mm VERTICAL WOODEN SLATS CLADDED ON WALL 100mm X 30mm X 1600mm VERTICAL WOODEN SLATS CLADDED ON STEEL FRAME NATURAL STONE CLADDING RING BEAM +3500 Clea Vu Fence or similar approved 1000mm High Mild Steel-Anti Climb Railings / PLATFORM EDGING TO F.F.L +500 ENGNR'S DETAIL NORTH WEST ELEVATION **Scale 1:100** PARAPEARARET ROOF +6500 +6500 NATURAL STONE CLADDED FEATURE WALL WITH 750 RADIUS CIRCULAR OPENINGS FOR ART SCULPTURE DISPLAYS **LOCATION PLAN** NATURAL STONE CLADDING RING BEAM RAPT SCLIPTURE DISPL SOUTH AFRICAN NATIONAL BIODIVERSITY INSTITUTE SOUTH FRONT ENTRANCE ELEVATION **Scale 1:100** South African National Biodiversity Institute PARAPEARAPET ROOF +6500 +6500 RING BEAM +3500+3500 **REVISIONS** PROJECTNEERS CONSULTING ENGINEERS & PROJECT MANAGERS PROJECTNEERS PROJECTNEERS CONSULTING ENGINEERS SOUTH WEST ELEVATION & PROJECT MANAGERS BUILDING 2, 1ST FLOOR, THORNHILL OFFICE PARK 94 BEKKER ROAD, MIDRAND, 1685 **Scale 1:100** +27 11 043 1307 technical@projectneers.com 100mm X 30mm X 1600mm VERTICAL WOODEN SLATS CLADDED ON WALL N.K.MPOFU B.TSHUMA S. ZUNGU J. DAVIDSON APPROVAL CONSULTANT N.K. MPOFU PARAPETRARET ROOF +6500 +6500 THE MASTER HELD AT THE PROJECTNEERS CONSULTING MIDRAND OFFICE BEARS THE ORIGINAL SIGNATURE OF APPROVAL ASSESSMENT, DESIGN & PROJECT MANAGEMENT OF REQUIRED NEW BUILDINGS & REPAIRS, RENOVATIONS & UPGRADES TO VARIOUS 200mm X 30mm X 20000mm HORIZONTAL _ WOODEN PERGOLA @ ENTR. COVERING INFRASTRUCTURE ASSETS IN THE THOHOYANDOU BOTANICAL GARDEN, THOHOYANDOU, & NATIONAL ZOOLOGICAL GARDEN CAMPUSES BASED IN PRETORIA & MOKOPANE RING BEAM +3500+3500 THOHOYANDOU BOTANICAL GARDENS **ELEVATIONS** ARCHITECTURAL F.F.L F. CONTRACT NUMBER **ISSUED FOR** ZA2018_2008 SOUTH EAST ELEVATION DRAWING NUMBER
ORG STATE YEAR PROJ. NO. CLIENT SITE ROLE SERIAL NO. REV **TENDER Scale 1:100** PJN_ZA_2022_2002_SANBI_TBG_ARC_2005

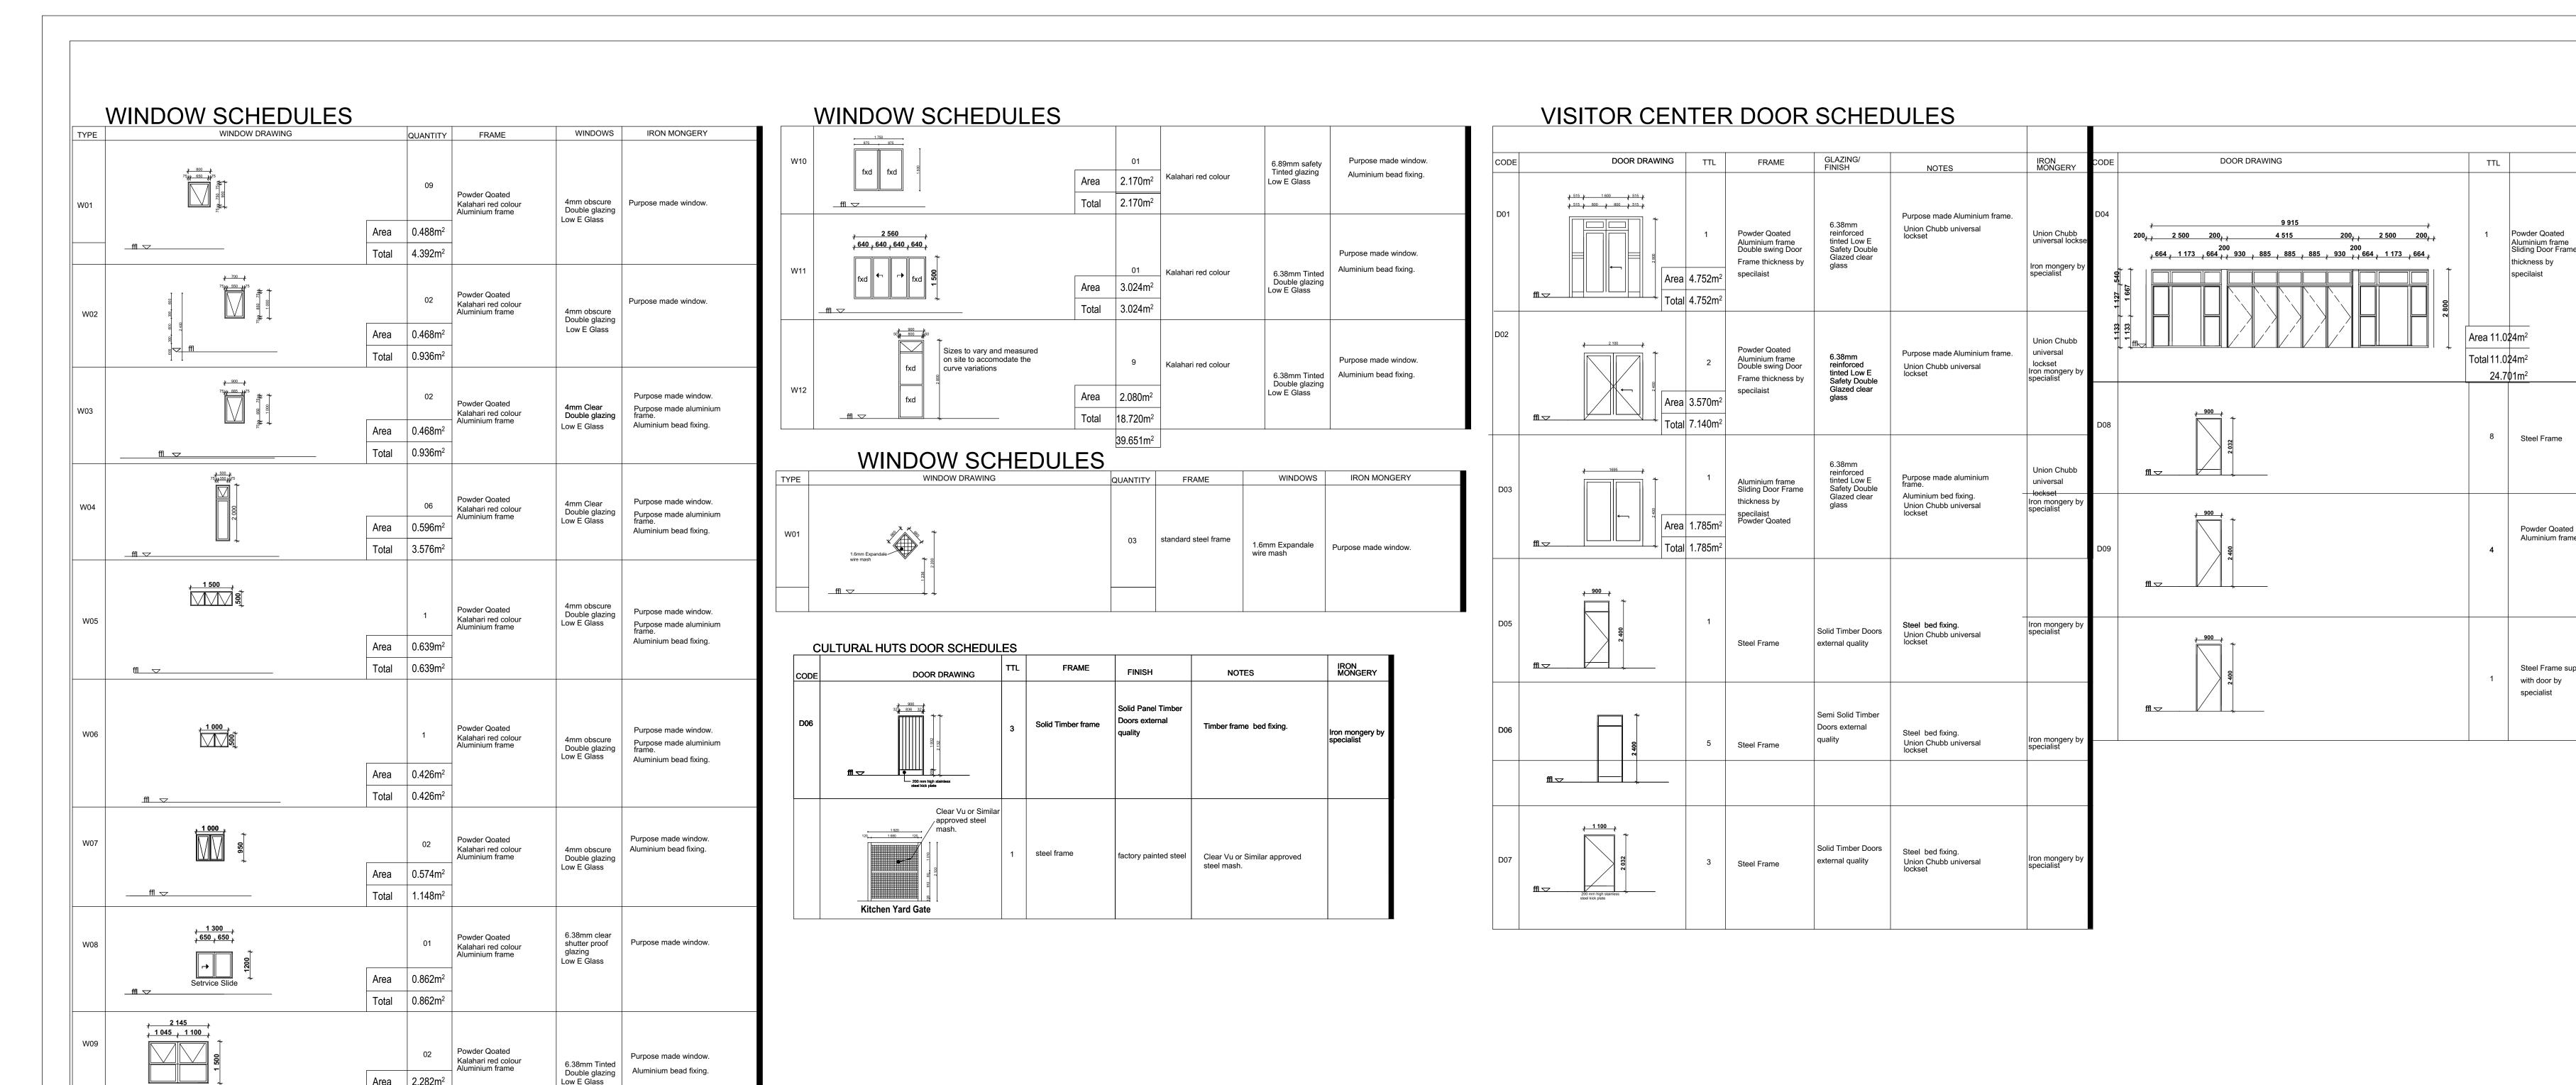

Do Not Comply with SANS 10400 XA

Additional Insulation required With at least R-Value of 3.48 m²K/W

SANS 204:

<u> </u>			
Roof venting	Unventilated		
Basic Roof Construction	Galvanised IBR Roof Sheets @ 15° & 5° pitch respectively with flat ceiling		
Direction of heat flow	Down & Upwards		
Min R- value of insulation required	2.7 m ² K/W		
Additional Thermal Insulation	Flexible BOQ polyester fibre blanket		
	24 kg/m³		

Conclusion:

It's recommended that a Flexible BOQ polyester fibre blanket, with a thickness of 120 mm needs to be installed in order to achieve the additional min R-value of 2.70 m²K/W

.FENESTRATION CALCULATIONS -NATURAL ENVIRONMENT CONTROL

FLOOR AREAS

NETT FLOOR AREA	429.12m²	
GLAZING AREA	64.35m²	

15% Of NETT FLOOR AREA:

 $(429.12m^2/100) \times 15 = 64.37m^2$

GLAZING AREA TO 15% Of NETT FLOOR AREA $= 64.35 \text{m}^2$ **GLAZING AREA** 15% Of NETT FLOOR AREA = 64.37m²

GLAZING AREA IS LESS THAN 15% Of NETT FLOOR AREA THEREFORE SANS 204 IS NOT REQUIRED

2. ROOF ASSEMBLY:

REF: SANS 204:2011 Table 8. Min. **SANS 10400 XA:** R-values for Roof & Ceiling - (Page 17)

Occupancy	G1
Design Occupancy Time	24hrs per day / 7 days per week
Climate Zone	3 - HOT INTERIOR
Minimum R-value required	2.70 m ² K/W
Direction of heat flow	Down & Upwards

REF: SANS 204:2011 Table 10.

CALCULATION	Min. R-values for Roof & Ceiling - (Page 20)
Basic Roof Assembly	Galvanised IBR Roof Sheets
R- value for metal cladding	0.38 m ² K/W
R-Value of Ceiling	0.06 m ² K/W
TOTAL R - Obtained	0.44 m ² K/W

Obtained R-Value =>Minimum R-value required

LOCATION PLAN

universal

Iron mongery

Semi Solid Timber

6.38mm reinforced tinted Low E Safety Double

Powder Qoated Aluminium frame


Steel Frame supplied

with door by

Union Chubb universal lockset

Union Chubb universal lockset

Strong room Doors Union Chubb universal lockset

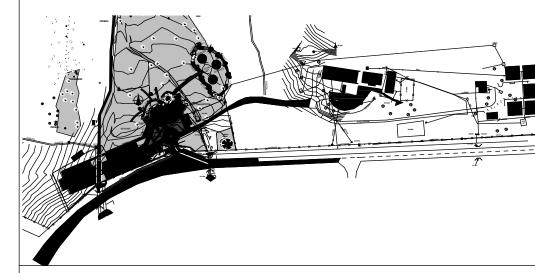

SOUTH AFRICAN NATIONAL BIODIVERSITY INSTITUTE





South African National Biodiversity Institute

REVISION			REVISIONS
	REV NO.	DATE	DESCRIPTION
	R01	2022-09-12	ISSUED FOR REVIEW.
	R02	2022-09-20	CHANGE ROOF SLAB TO IBR CHRORMADEK OVE SCULLERY AREA ON ROOF PLAN & SECTION
	R02	2022-09-20	INTRODUCE VEG WASH STAINLESS STEEL SINK IN KITCHEN
	R01	2022-09-12	change of traditional hut specifications

PROJECTNEERS CONSULTING ENGINEERS & PROJECT MANAGERS

PROJECTNEERS

PROJECTNEERS CONSULTING ENGINEERS **& PROJECT MANAGERS**

technical@projectneers.com

DRAWING CHECKS					
DESIGNED BY	DESIGN CHECKED BY	DRAWN BY	DRAWING CHECKED B		
N.K.MPOFU	B.TSHUMA	S. ZUNGU	J. DAVIDS		
APPROVAL CON	ISULTANT				

N.K. MPOFU THE MASTER HELD AT THE PROJECTNEERS CONSULTING MIDRAND OFFICE BEARS THE ORIGINAL SIGNATURE OF APPROVA

ASSESSMENT, DESIGN & PROJECT MANAGEMENT OF REQUIRED NEW BUILDINGS & REPAIRS, RENOVATIONS & UPGRADES TO VARIOUS

INFRASTRUCTURE ASSETS IN THE THOHOYANDOU BOTANICAL GARDEN, THOHOYANDOU, & NATIONAL ZOOLOGICAL GARDEN CAMPUSES BASED IN PRETORIA & MOKOPANE

THOHOYANDOU BOTANICAL GARDENS

WINDOW & DOOR SCHEDULES DISCIPLINE ENERGY EFFICIECNY CALCULATIONS

CONTRACT NUMBER

ISSUED FOR TENDER

ZA2018_2008 ORG STATE YEAR PROJ.NO. CLIENT SITE ROLE SERIAL.NO. REV PJN_ZA_2022_2002_SANBI_TBG_ARC_2006