

SECURITY ENTRANCE FLOOR PLAN (RENOVATION)



NEW 89MM THICK LAFARGE GYPSUM FIXED PARTITION DRYWALL PARTITIONING SYSTEM OR SIMILAR APPROVED, COMPRISING OF INTERNAL FRAMING FORMED OF 64MM WIDE LAFARGE GALVANISED STEEL STUDS OR SIMILAR APPROVED, FIXED AT 600MM C/C TO LARFARGE GALVANISED FLOOR TRACKS OR SIMILAR APPROVED. INCLUDING WHERE NECESSARY ANY ADDITIONAL GALVANISED STEEL STUDDING TO FORM DOOR OPENINGS, GLAZING & OTHER APETURES, ANGLES, CORNERS & TERMINATION ENDS. INTERNAL STEEL FRAMING TO BE DRESSED ON BOTH SIDESWITH 12MM THICK TAPERED EDGE LAFARGE PLASTERBOARD OR SIMILAR APPROVED IN SINGLE LENGTHS TO SUITE HEIGHT, BUTT JOINTED & SECURED TO STEEL STUDDING WITH 25MM DRYWALL SCREWS AT 220MM C/C, JOINTS TO BE TAPPED & JOINTED WITH LAFARGE JOINTING COMPOUND OR SIMILAR APPROVED & FLUSHED OVER WITH SKIM PLASTER, LEAVING IT PREPARED FOR DECORATION. ALL EXPOSED ALUMINIUM DOOR FRAMES, GLAZINGFRAMES, CEILING & WALL CHANNELS. BATTENS & SKIRTING ARE TO BE FORMED OF COLOUR ANODISED ALUMINIUM SECTIONS (COLOUR TO ARCHITECT'S APPROVAL). INSTALLATION TO BE IN ACCORDANCE WITH SABISA INSTALLATION GUIDELINES.

INSTALL NON-COMBUSTIBLE 63MM THICK CAVITYBATT INSULATION OR SIMILAR APPROVED OF DENSITY 14KG/M³ (PROGRESSIVELY AS BOARDING PROCEEDS) BETWEEN THE STUDS WITH THE GLASSWOOL TISSUE FACING THE INSTALLER, FIT SECURELY WITH CLOSELY BUTTED JOINTS, LEAVING NO GAPS.

JOINERY SPECIFICATIONS:

ALL BUILT-IN CUPBOARDS/ WORKTOPS / BENCHES BY SPECIALIST TO ARCHITECT'S

GENERAL NOTES:

ALL WORK TO COMPLY WITH AND BE CARRIED OUT IN STRICT ACCORDANCE WITH NATIONAL BUILDING REGULATIONS SANS 10400


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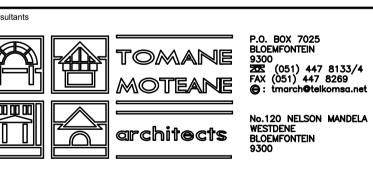
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LEGEND:	
.1111111111	NEW GYPSUM DRYWALL PARTITION TO BE BUILT
	NEW BRICK WALL TO BE BUILT
=====	EXISTING WALL TO BE DEMOLISHED
_	EXISTING WALL
	EXISTING DOOR TO BE REMOVED
	EXISTING SINK TO BE REMOVED
<u>D1</u>	NEW DOOR TO BE INSTALLED
W1 1	NEW WINDOW TO BE INSTALLED
SF1 1	NEW SHOPFRONT TO BE INSTALLED
	AREA TO BE REFURBISHED & ALTERED

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	0	SEPT.	2022	Where indicated with revision cloud	DN

TENDER DRAWINGS



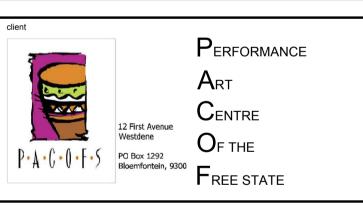



ARCHITECTURE

REFURBISHMENT & ALTERATIONS TO THE EXISTING PACOFS ENTRANCE

LOBBY IN BLOEMFONTEIN

PACOFS SECURITY ENTRANCE: DEMOLITION PLAN & RENOVATION FLOOR PLAN

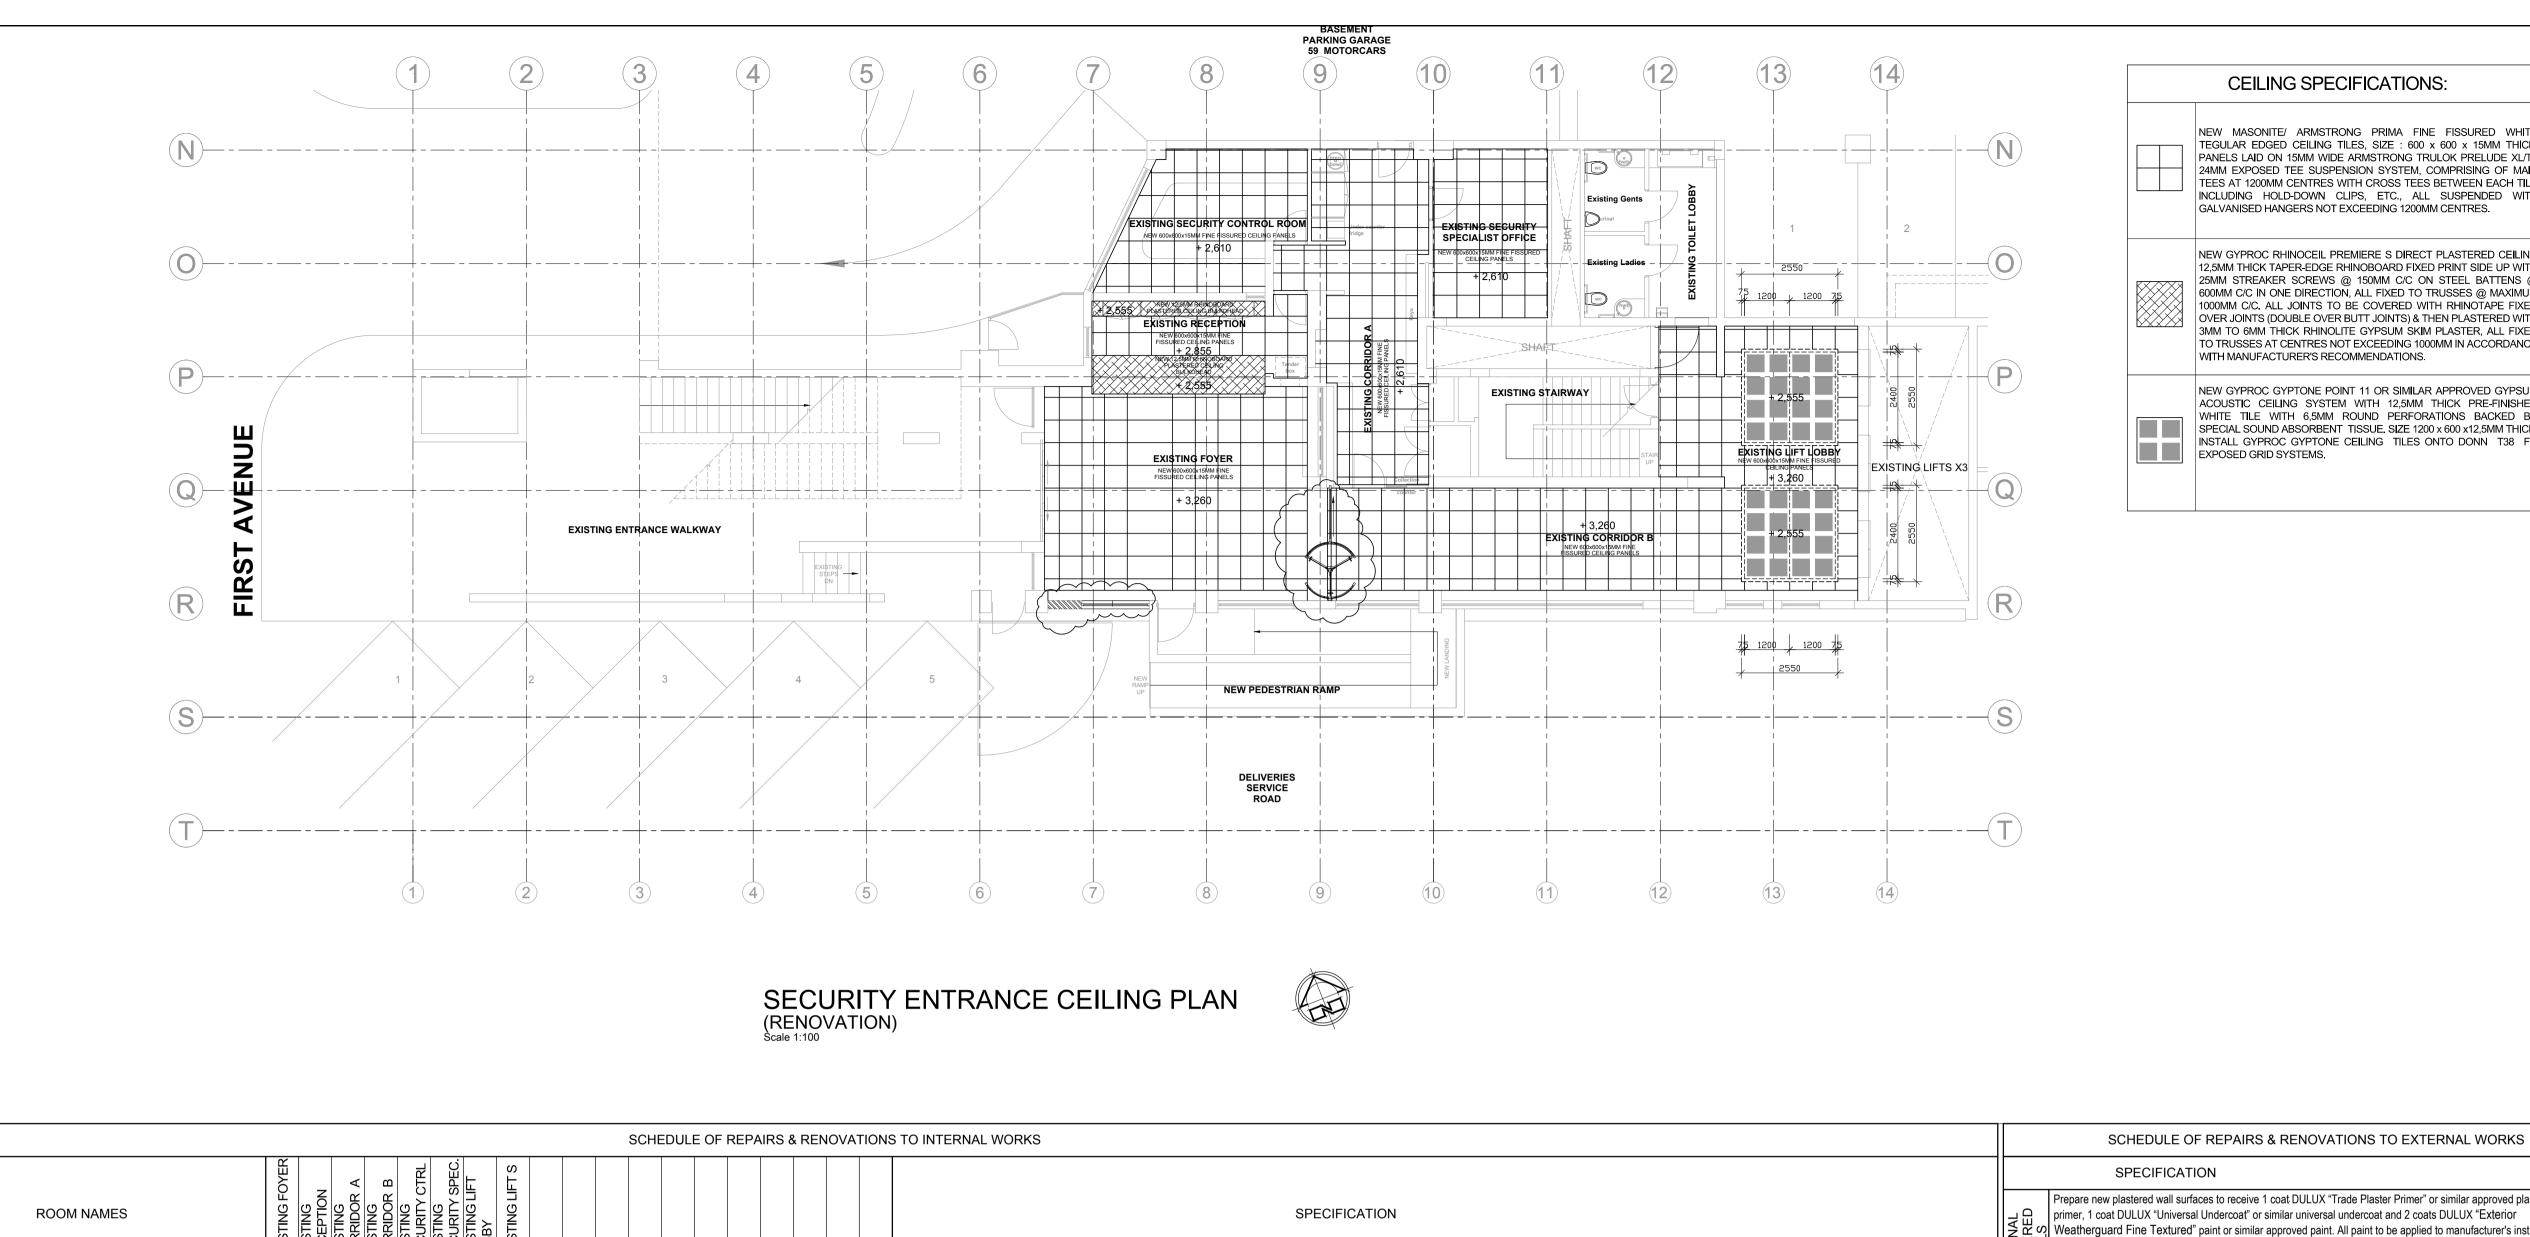

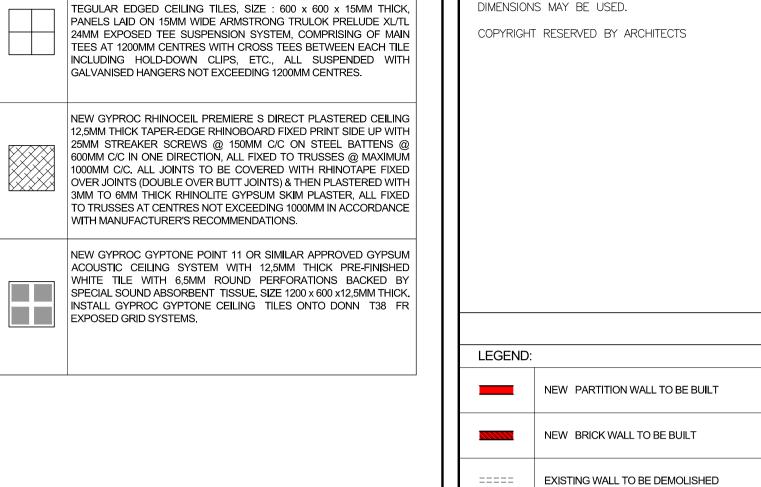

CEILING SPECIFICATIONS:

NEW MASONITE/ ARMSTRONG PRIMA FINE FISSURED WHITE

GENERAL NOTES:

EXISTING WALL

ALL WORK TO COMPLY WITH AND BE CARRIED OUT IN STRICT

ACCORDANCE WITH NATIONAL BUILDING REGULATIONS SANS 10400 ALL DIMENSIONS TO BE CHECKED ON SITE BEFORE ANY WORK IS PUT IN HAND. THIS DRAWING MUST NOT BE SCALED. ONLY FIGURED

TENDER DRAWINGS

EXISTING DOOR TO BE REMOVED

NEW DOOR TO BE INSTALLED

NEW WINDOW TO BE INSTALLED


NEW SHOPFRONT TO BE INSTALLED


EXISTING SINK TO BE REMOVED

	ROOM NAMES	EXISTING FOYER	ECEPTION EXISTING CORRIDOR A EXISTING EXISTING SECURITY CTRL EXISTING LIFT OBBY EXISTING LIFT SECURITY SPEC.	SPECIFICATION SPECIFICATION Prepare new plastered wall surfaces to receive 1 coat DULUX "Trade Plaster Primer" or similar approved plaster primer, 1 coat DULUX "Universal Undercoat" or similar universal undercoat and 2 coats DULUX "Exterior Weatherguard Fine Textured" paint or similar approved paint. All paint to be applied to manufacturer's instructions. Colour: To Architect's approval	NO. DATE O SEPT. 2022 Where indic
	VINYL SHEETING			1. Existing NCI tiles to be thoroughly cleaned & lose & cracked/damaged tiles to be removed. Areas where tiles are removed to be to be diamond grinded with care. Surface to be prepared to receive prime substrate with one coat UZIN NC 360 universal primer. UZIN NC 150 S to be mixed with clean water unitl a homogenous mix has been achieved before applying 5mm thick UZIN NC 150 S self-levelling screed compound evenly with trowel or rake, all in accordance with the manufacturer's instructions. 2. Install new 2mm thick x 2m wide iQ Eminent homogeneous vinyl sheeting with PUR reinforced surface treatment, manufactured in accordance with SANS 10070, using a reliable Self-Leveller when required, including all cutting & waste. The sheeting must be rolled in both directions with an articulated 68kg three-sectional roller immediately after it has been laid into the adhesive. Joints must be butted, grooved & heat welded using the manufacturer's colour-matched multi-colour welding rod, ensuring that the welding rod bonds to more than 70% of the sheet thickness.	client
	RUBBER TILE			1. Existing NCI tiles to be thoroughly cleaned & lose & cracked/damaged tiles to be removed. Areas where tiles are removed to be filled with non-shrink grout & the entire area to be diamond grinded. 2. Install new 3.2mm thick x 501mm x 501mm OR 1005mm x 1005mm norament® 825 grano rubber floor tiles with round pastilles, manufactured in accordance with EN 14041 and laid in FloorworX No. 55 two-part polyurethane adhesive which has been spread using a trowel fitted with an A2 notched blade at a rate of approximately 12m² per 6kg pack on a previously prepared Class 1 sub-floor in accordance with SANS 10070, using FloorworX Self Leveller when required, including all cutting and waste manufacturer's colour-matched multi-colour welding rod, ensuring that the welding rod bonds to more than 70% of the sheet thickness.	12 First Westde
	VINYL SKIRTING	00		1. Existing timber skirting / vinyl skirting to be removed throughout. 2. Install new FloorworX Extruda Skirting 100mm high (item code MCB100), fixed with FloorworX No. 71 contact adhesive spread using a brush onto both material and working surface.	consultants
	CEMENT PLASTERED BRICKWALLS (Existing Plastered Brickwalls) CEMENT PLASTERED BRICKWALLS			1. Where applicable, flaking paint on the existing internal plastered walls to be removed & plaster cracks to be sealed with CEMCRETE "Interior Crack Filler" or similar approved crack filler. All to manufacturer's instructions. Prepare wall surface to receive new paint. 2. Apply 1 new coat plaster primer as per SANS 681 and 2 new coats 1st grade acrylic PVA paint as per SANS 1586. All to comply with SANS 10305 (Painting of buildings). Prepare new brickwalls surface to receive 10-15mm thick 1:3 masonry cement plaster finished smooth with a steel trowel as per SANS 2001 EM1. Masonry cement used to comply with SANS 50413 class MC 22.5X or MC 12.5	
ELEMENTS	(New Plastered Brickwalls) DRYWALL PARTITION			Install new 89mm thick Lafarge Gypsum fixed partition drywall partitioning system or similar approved, comprising of internal framing formed of 64mm wide lafarge galvanised steel studs or similar approved, fixed at 600mm c/c to Larfarge galvanised floor tracks or similar approved, including where necessary any additional galvanised steel studding to form door openings, glazing & other apetures, angles, corners & termination ends. Internal steel framing to be dressed on both sides with 12mm thick tapered edge Lafarge plasterboard or similar approved in single lengths to suite height, butt jointed & secured to steel studding with 25mm drywall screws at 220mm c/c, joints to be tapped & jointed with Lafarge jointing compound or similar approved & flushed over with skim plaster, leaving it prepared for decoration. All exposed aluminium door frames, glazingframes, ceiling & wall channels, battens & skirting are to be formed of colour anodised aluminium sections (colour to architect's approval). Installation to be in accordance with SABISA installation guidelines.	discipline ARCHITECTU service
	PORCELAIN WALL TILES	0		1. Existing plastered & painted wall to be prepared to receive new porcelain wall tiles. 2. Install new 600 x 600mm full body textured porcelain wall tiles from floor level up to ceiling height to comply with SANS 1449. Wall tiles to include 8 x12mm long aluminium M-trim edging (code:SQE 120.N) installed according to manufacturer's instructions & bedded in tile adhesive while tiles are laid. Colour - to PACOFS & Architect's approval. 1. Existing glazed wall tiles to be removed throughout & walls (new & existing) to be prepared to receive new mosaic wall tiles.	REFURBISHMI THE EXISTING
	MOSAIC WALL TILES COMPOSITE BOARD WALL CLADDING	0		2. Install new 150mm wide mosaic wall tiles up to two rows above new sink & counter to comply with SANS 1449. Wall tiles to include 8 x12mm long aluminium M-trim edging (code:SQE 120.N) installed according to manufacturer's instructions & bedded in tile adhesive while tiles are laid. Colour - Purple (to Architect's approval). Wall above tiles to be finished with paint as mentioned in wall paint specifications. Install new 16mm thick PG Bison Formica B13 Composite Board finished in "American Walnut Fusion", consisting of a Formica High Pressure Laminate bonded to a substrate with laminate on one side backer, constructed in accordance with the layout detail drawings.	LOBBY IN BLC
	ACRYLIC WALL PAINT (Existing Plastered Brickwalls)			1. Existing plastered & painted wall to be prepared to receive new paint. 2. Apply 1 coat Durafill Fillercoat (code: M370-2700) & 2 coats DULUX "Luxurious Silk" pure acrylic paint, all in accordance with Architect's specifications & manufacturer's instructions. Colour - Olive (code: 90YY 35/ 304), Light Charcoal (code: 40 YY 25/ 074) & Charcoal (code: 30 YY 11/ 076). 1. New plastered & painted wall to be prepared to receive new paint.	drawing title
	ACRYLIC WALL PAINT (New Plastered Brickwalls) ACRYLIC WALL PAINT (New Dry Wall Partitions)	00		2. Apply 1 coat Durafill Fillercoat (code: M370-2700) & 2 coats DULUX "Luxurious Silk" pure acrylic paint, all in accordance with Architect's specifications & manufacturer's instructions. Colour - Olive (code: 90YY 35/ 304), Light Charcoal (code: 40 YY 25/ 074) & Charcoal (code: 30 YY 11/ 076). 1. New plastered & painted wall to be prepared to receive new paint. 2. Apply 1 coat Durafill Fillercoat (code: M370-2700) & 2 coats DULUX "Luxurious Silk" pure acrylic paint, all in accordance with Architect's specifications & manufacturer's instructions. Colour - Olive (code: 90YY 35/ 304), Light	PACOFS SECU CEILING PLAN REPAIRS & RE
	WALL CAVITY INSULATION (New Dry Wall Partitions)			Charcoal (code: 40 YY 25/ 074) & Charcoal (code: 30 YY 11/ 076). Install new non-combustible 63mm thick cavitybatt insulation or similar approved of density 14kg/m³ (progressively as boarding proceeds) between the studs with the glasswool tissue facing the installer. Fit securely with closely butted joints, leaving no gaps.	
	PREP BOWL TAP			Install new 450mm diameter x 157mm deep FRANKE "Rhondo Model RDX 610-44 Grade 304 18/ 10 polished stainless steel single prep bowl (code: 1990013) fitted on cupboard elsewhere specified complete 38mm waste fitting & 40mm uPVC deep seal P-trap. Install new COBRA "Strata" sink mixer single lever aerated swivel outlet plus & angle regulating valves including 1/2" BSP Female Inlet. All installed to manufacturer's specifications and compliant with SANS 226 Type 1 & SANS 1480 (code: SA-870)	scale AS SHOWN date JUNE 2021
	WINDOW BLINDS			Install new venetian blinds to specialist's specifications & detailing & Architect's approval.	DRAWING NUMBER B1027-TD 101


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A. TOMANE



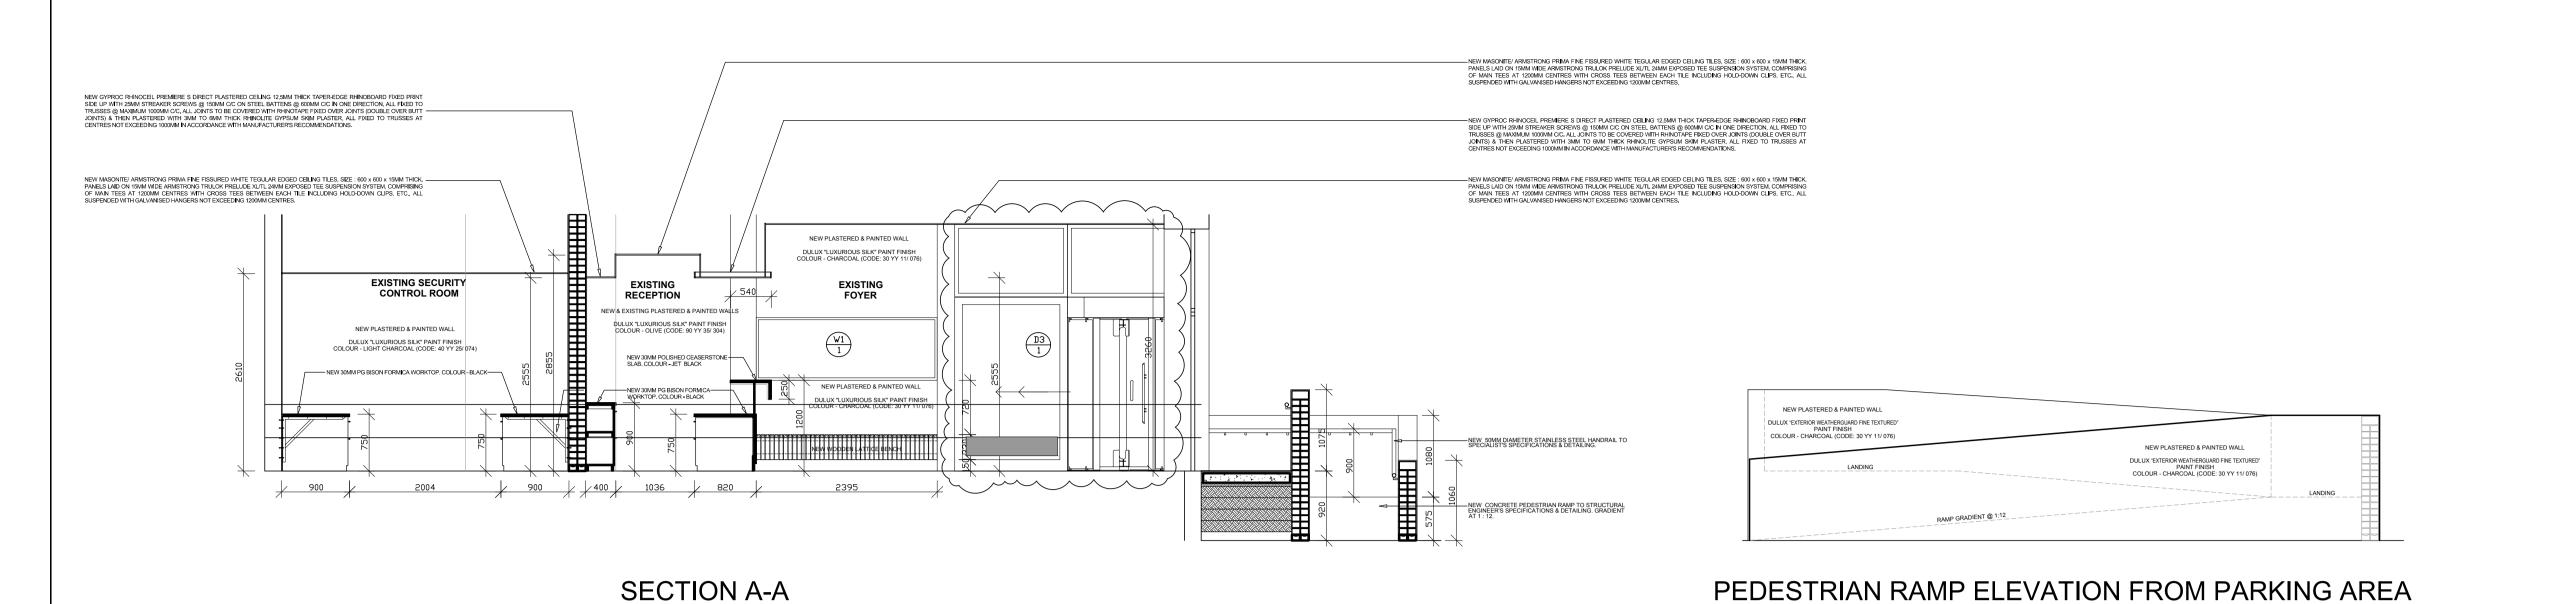

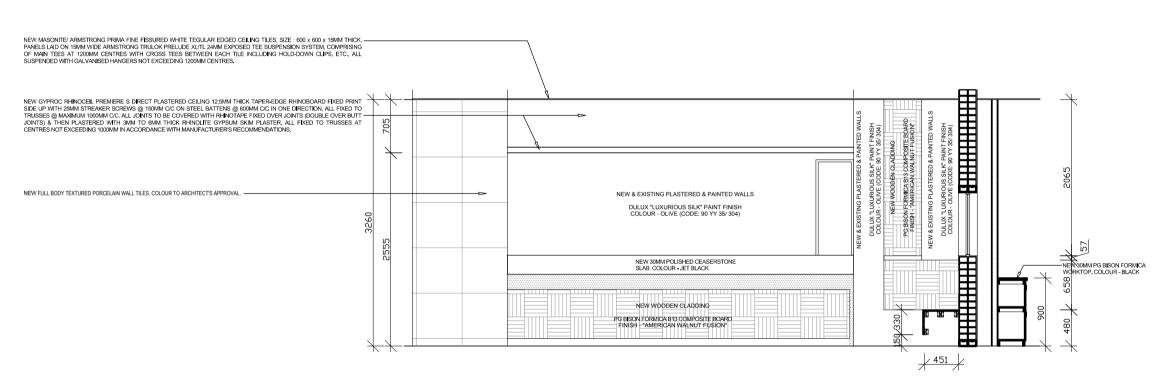ELEVATION OF RECEPTION COUNTER

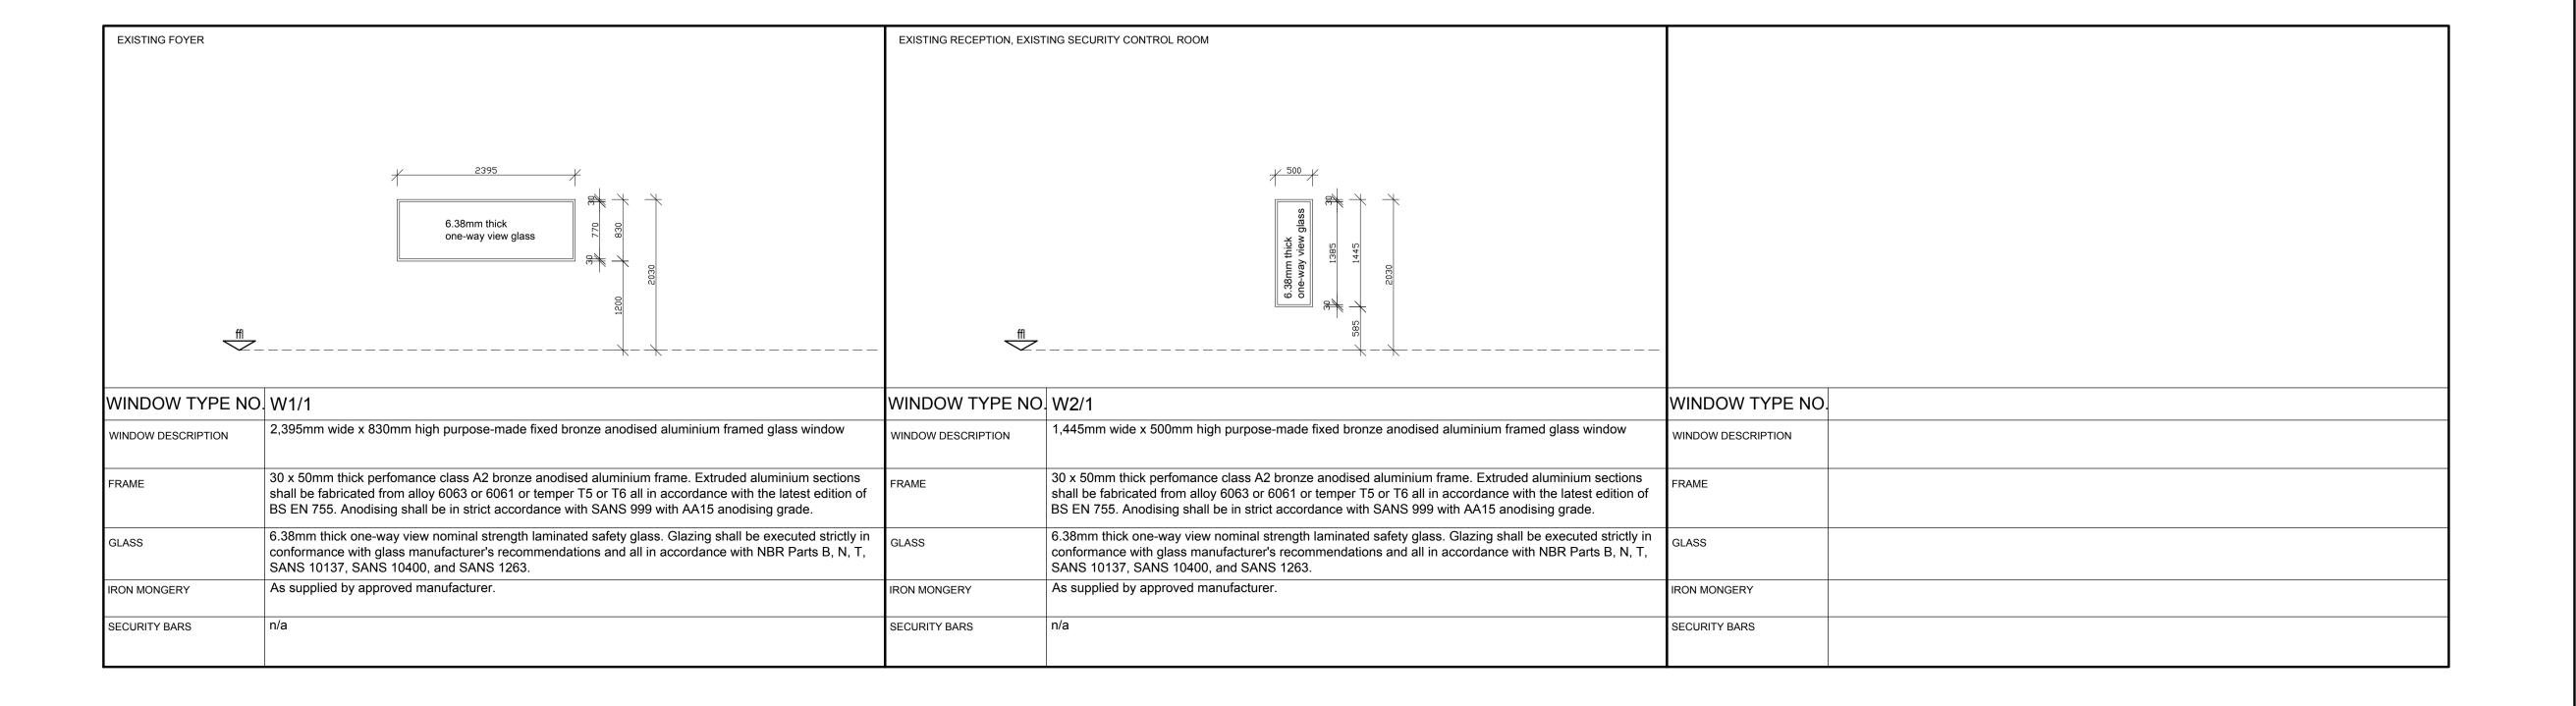

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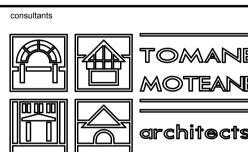
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discipline

ARCHITECTURE


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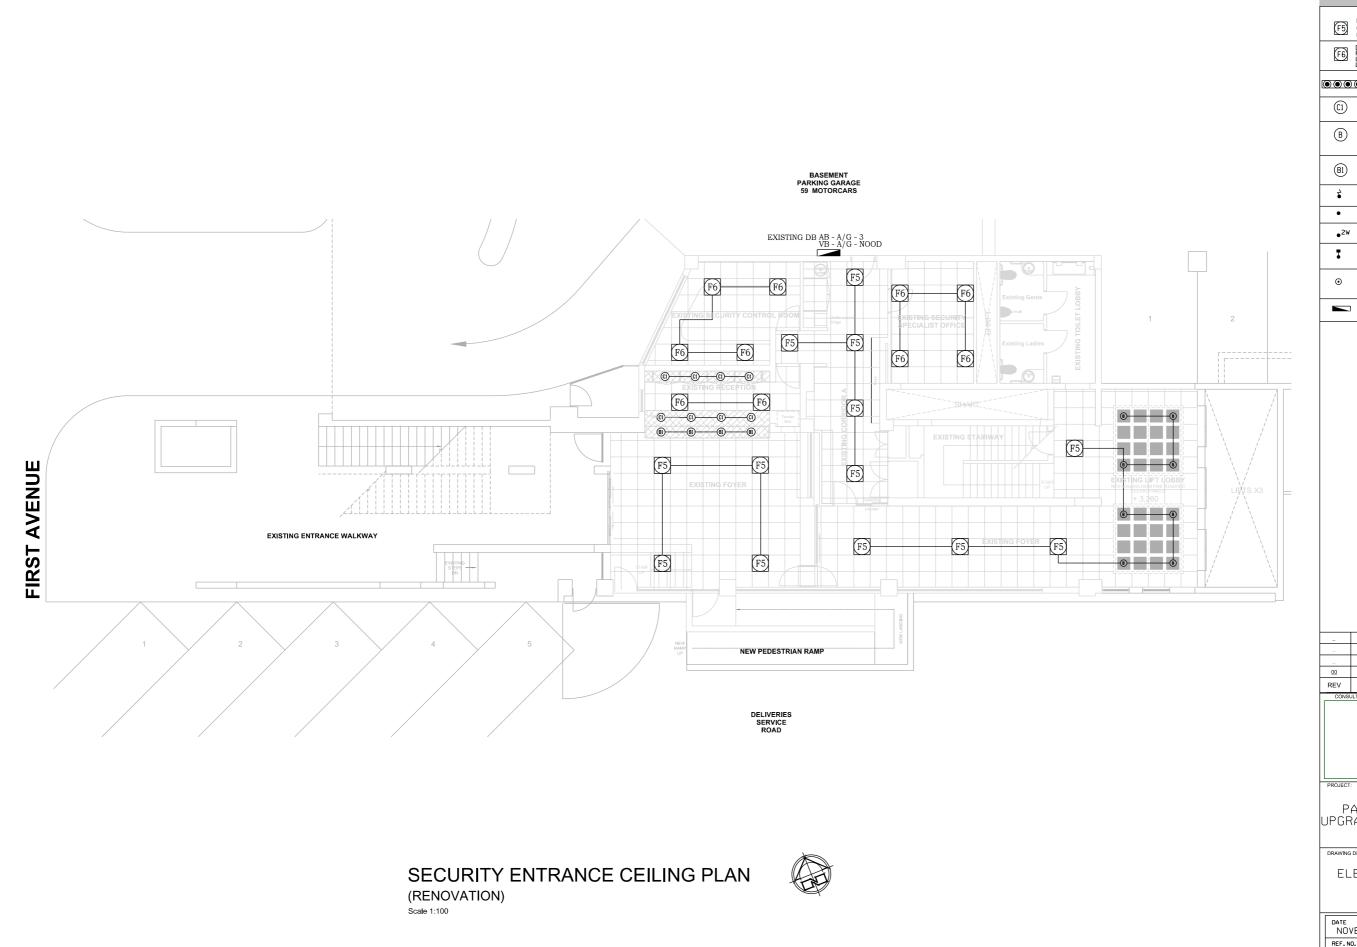
REFURBISHMENT & ALTERATIONS TO THE EXISTING PACOFS ENTRANCE LOBBY IN BLOEMFONTEIN

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PACOFS SECURITY ENTRANCE: SECTION, ELEVATIONS & WINDOW SCHEDULES

		our file no.:	
			B1027
scale	AS SHOWN	designed	A DE JONG/A, TOMANE
date	JUNE 2021	drawn	D. NANTAGYA
		checked	A. TOMANE
B10	027-TD 200		revision 0



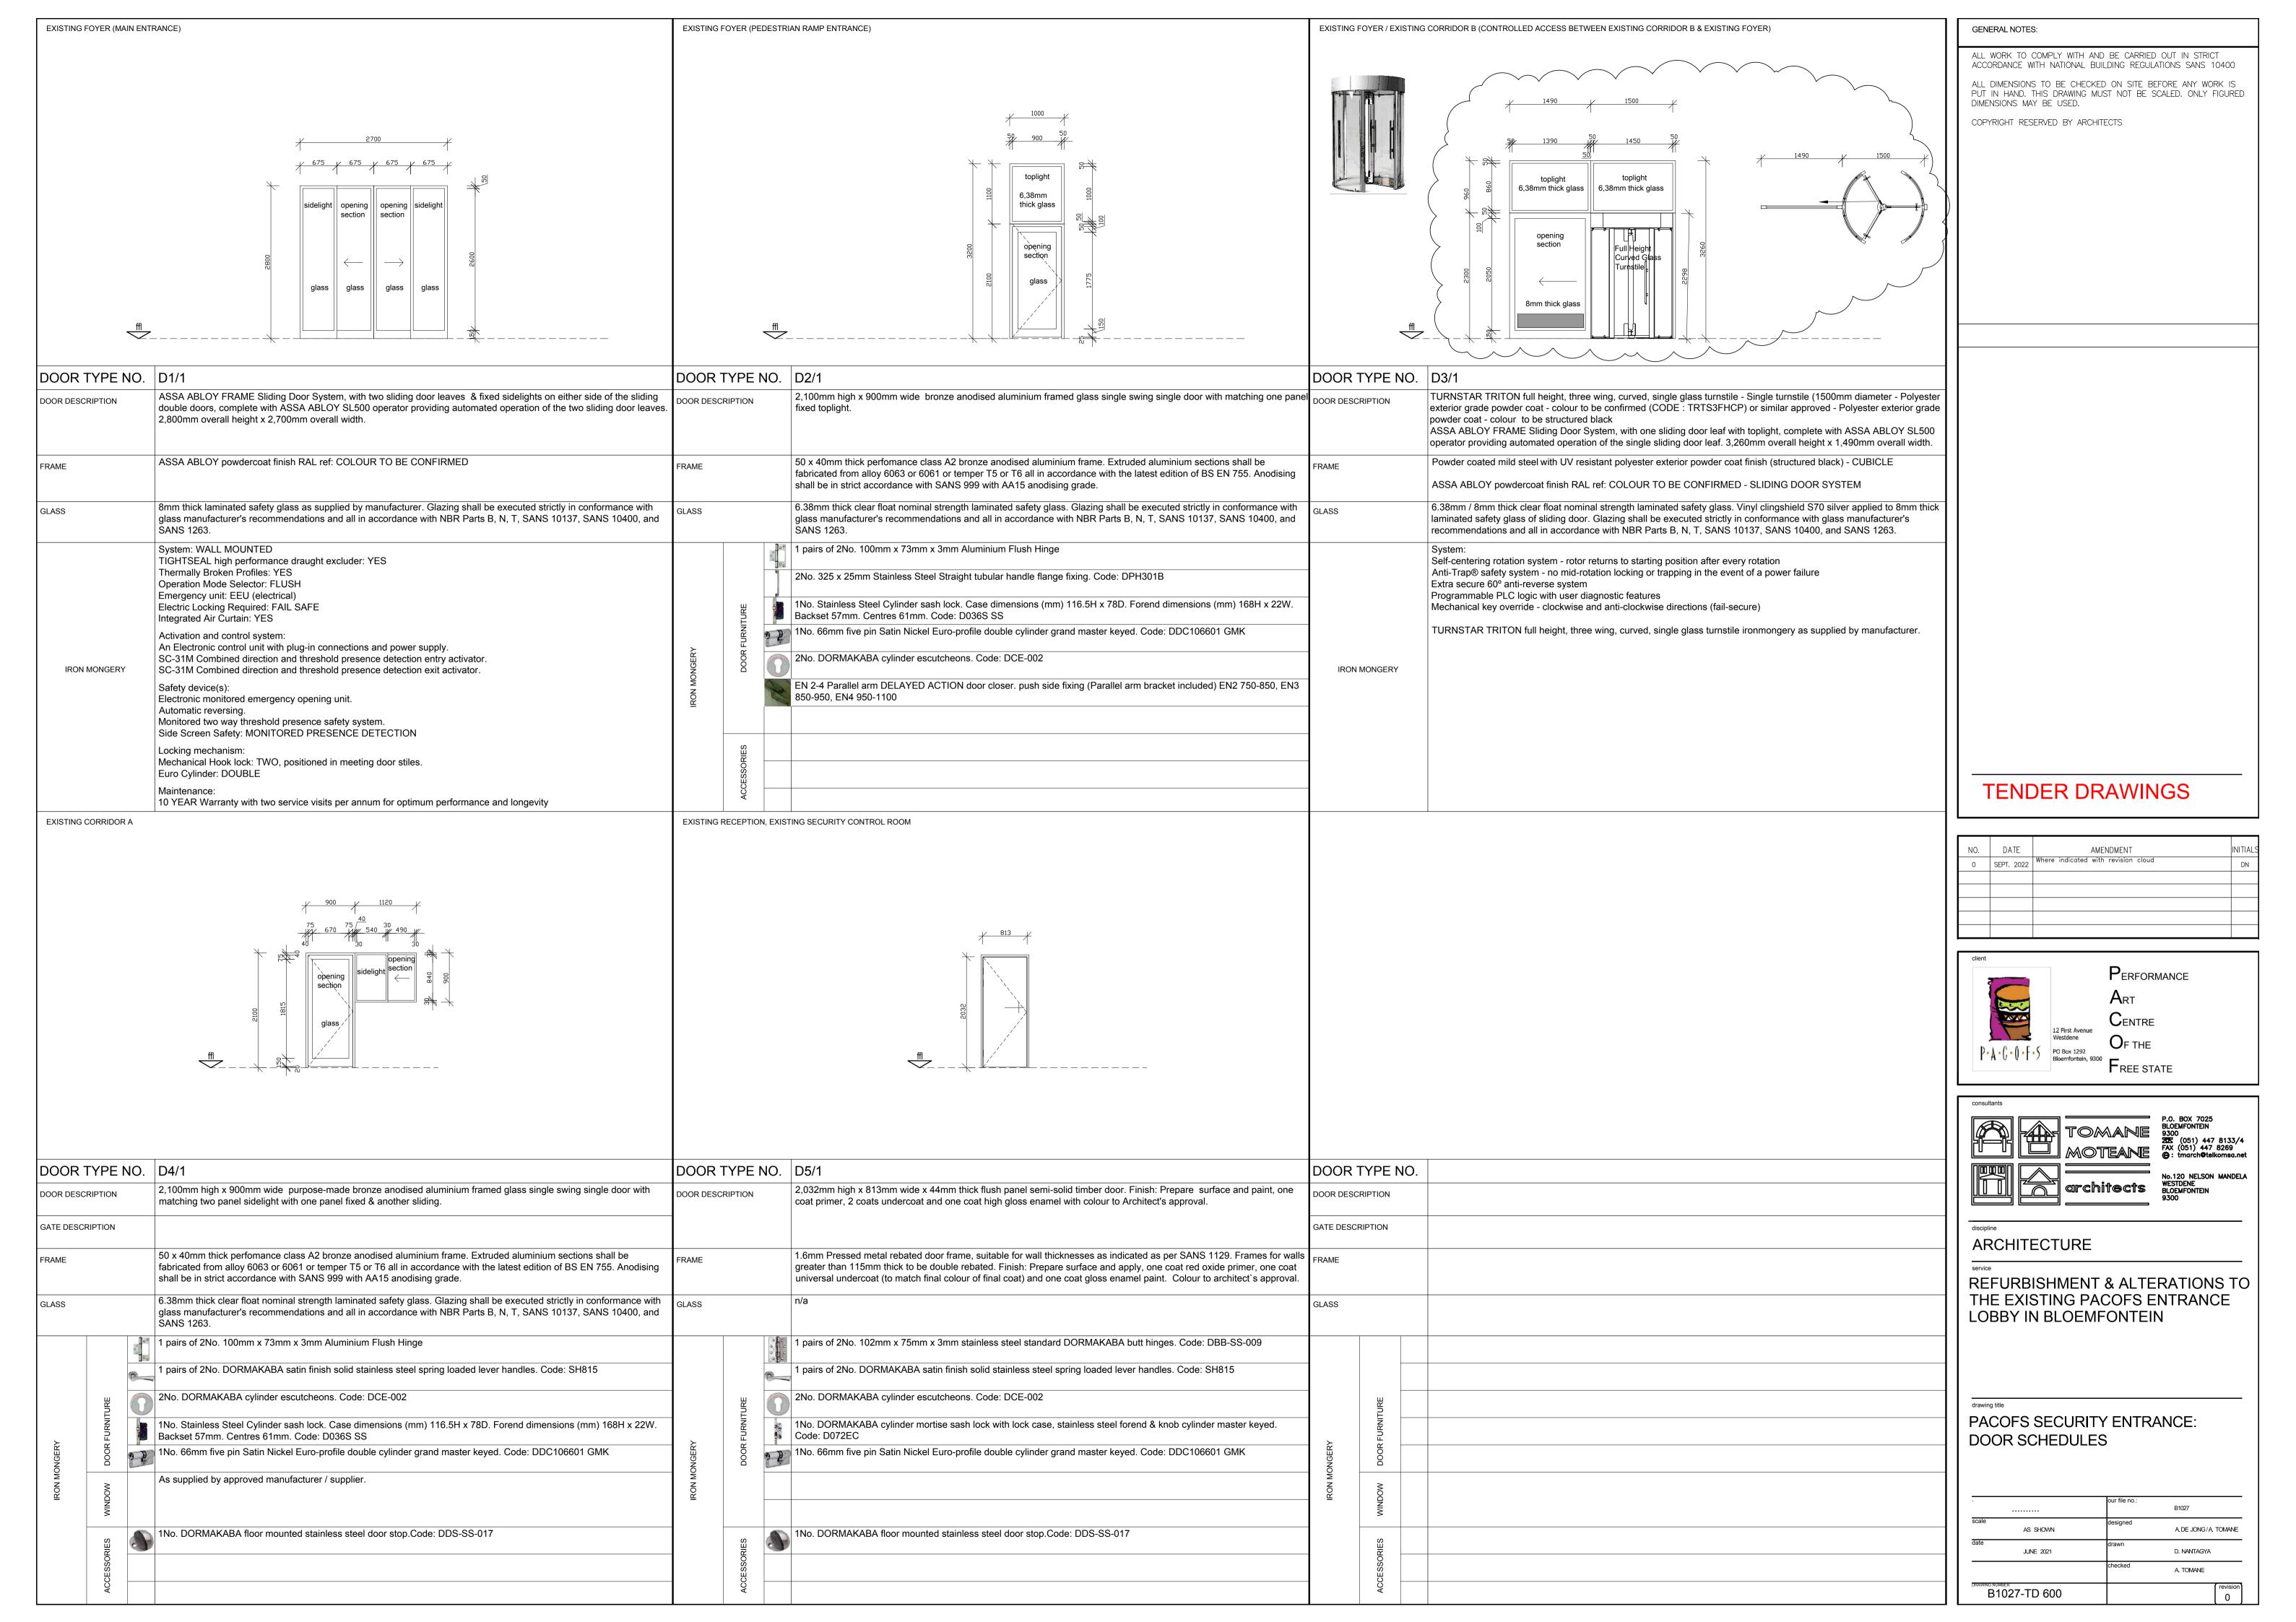

LEGEND

DECORATIVE RECESSED FLUORESCENT FITTING 600 x 600mm SUCH AS FM 90 AR 27 DIFFUSER OF LASCON OR OTHER APPROVED

DECORATIVE ROUND 10W LED DOWN LIGHT IVIOS HAL I OF OSRAM LIGHTING OR OTHER APPROVED.

DECORATIVE ROUND 12W LED DOWN LIGHT SUCH AS SYNERJI LED SLIM DOWNLIGHT FITTING SYLERDLIZWCW OR OTHER APPROVED.

ALUMINIUM PENDANT LIGHT FITTING SUCH AS PEN 2307 ALUMINIUM OF BRIGHT STAR LIGHTING OR OTHER APPROVED.

1 LEVER 1 WAY LIGHT SWITCH

1 LEVER 2-WAY LIGHT SWITCH

1 LEVER 1-WAY DIMMER LIGHT SWITCH

OCCUPANCY OR CEILING SENSORS SUCH AS OCCU SWITCH - A SMART MOVE CEILING SENSOR FROM PHILLIPS OR OTHER APPROVED

ELECTRICAL DISTRIBUTION BOARD

REFERENCE DRAWINGS


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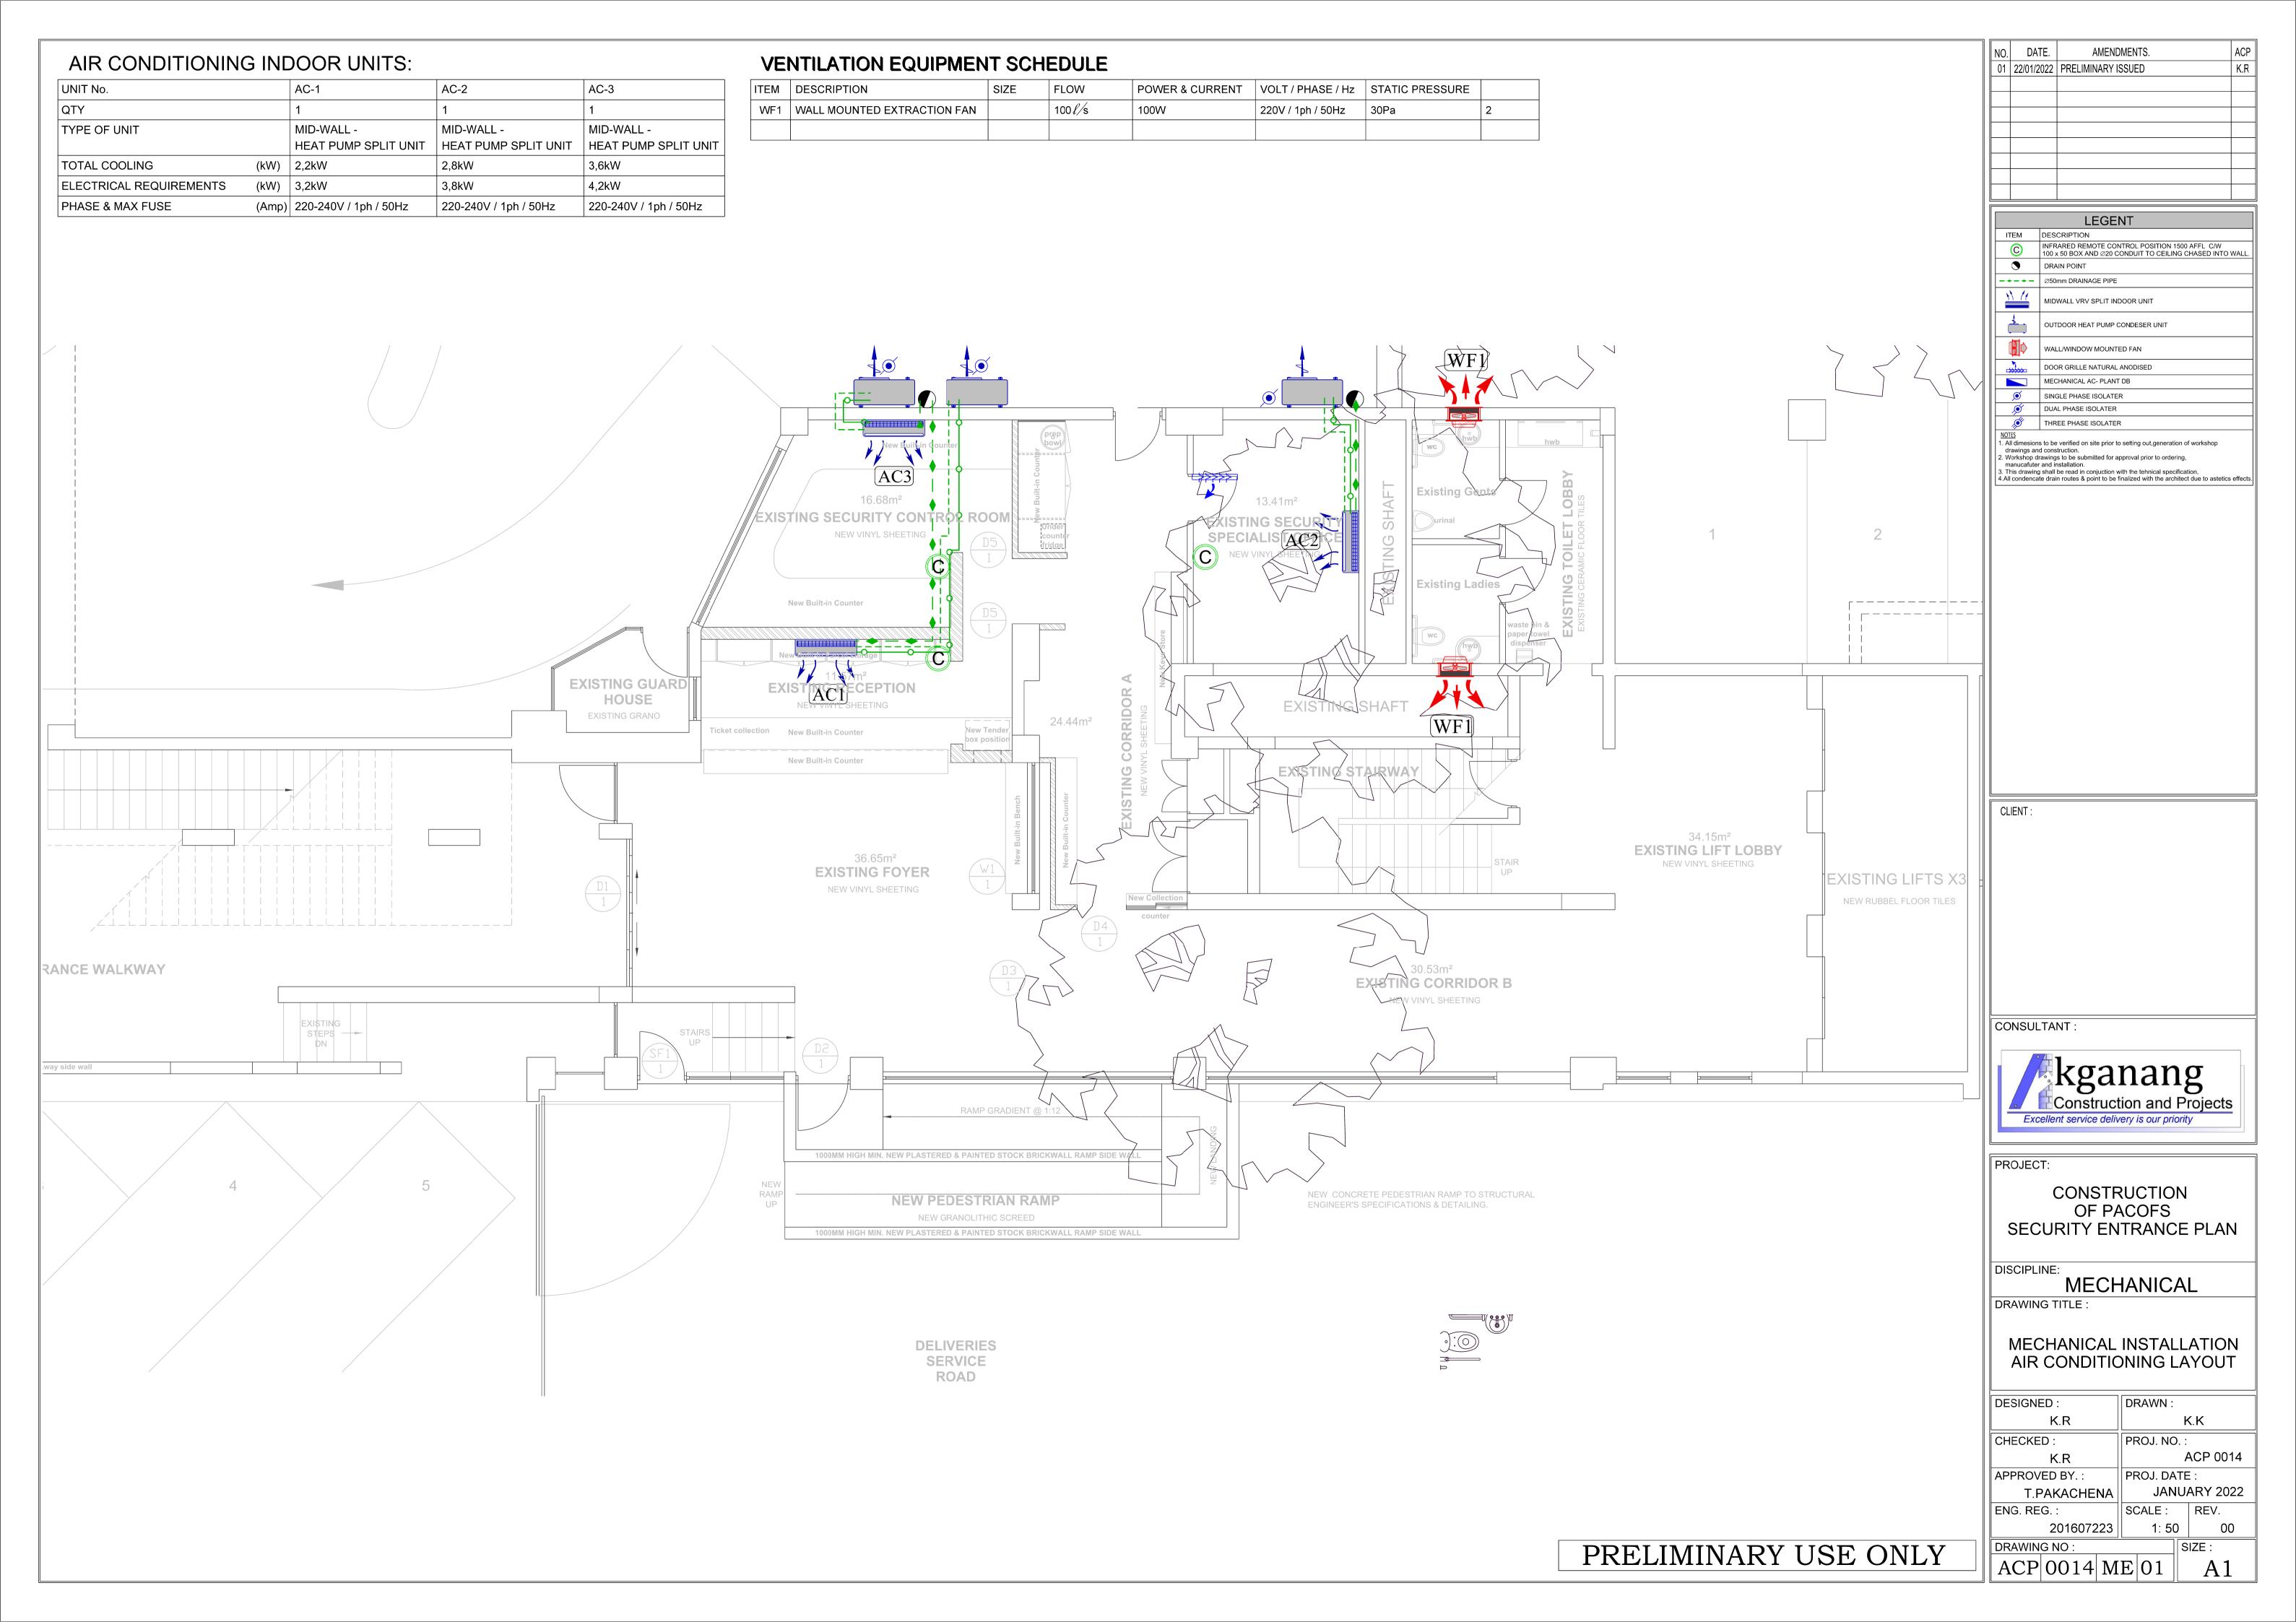
PACOFS REVITILIZATION UPGRADE AND REFURBISHMENT


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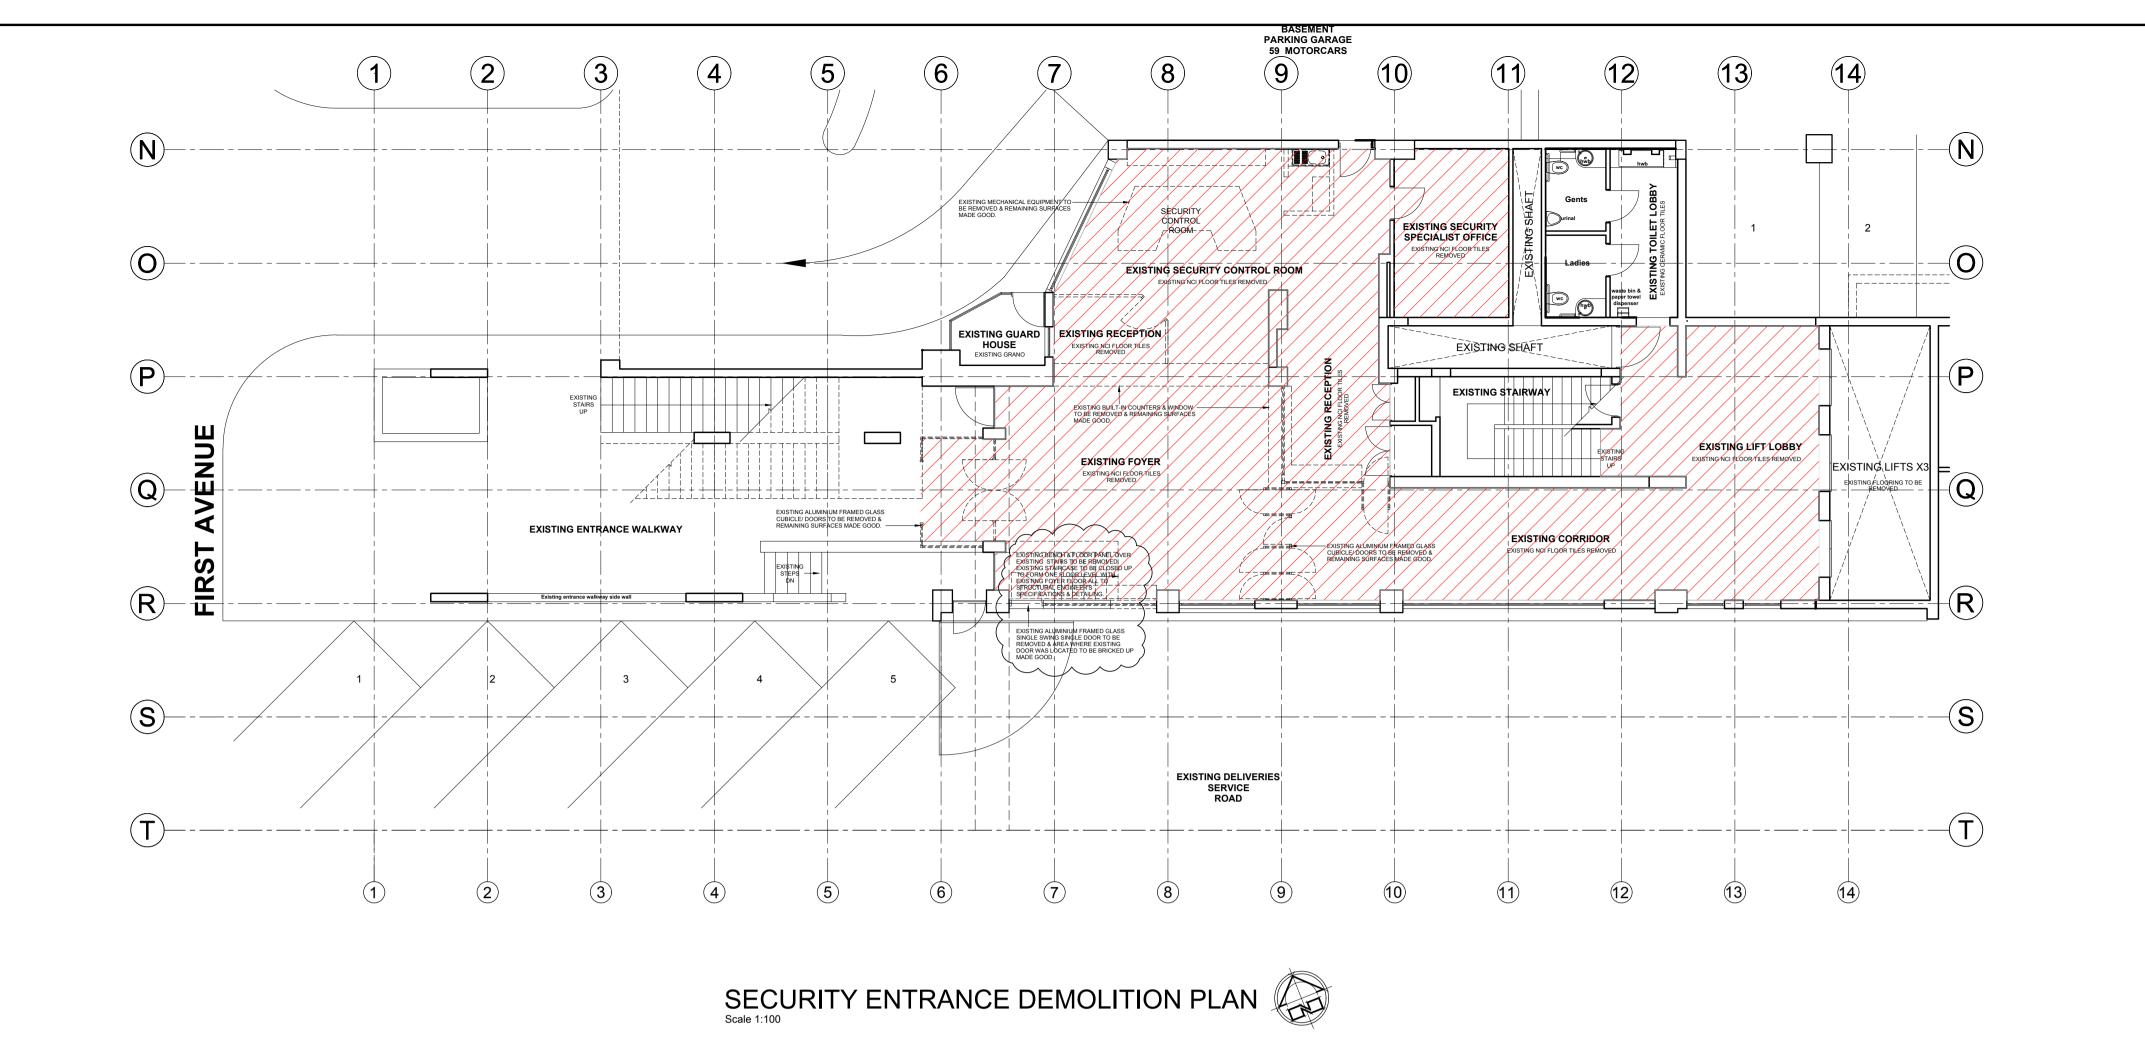
DATE	DESIGNED BY.
NOVEMBER 2021	L.MBOLEKWA
REF. NO. SE 2001	DRAWN BY. L.MBOLEKWA
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SCALE	APPROVED BY.
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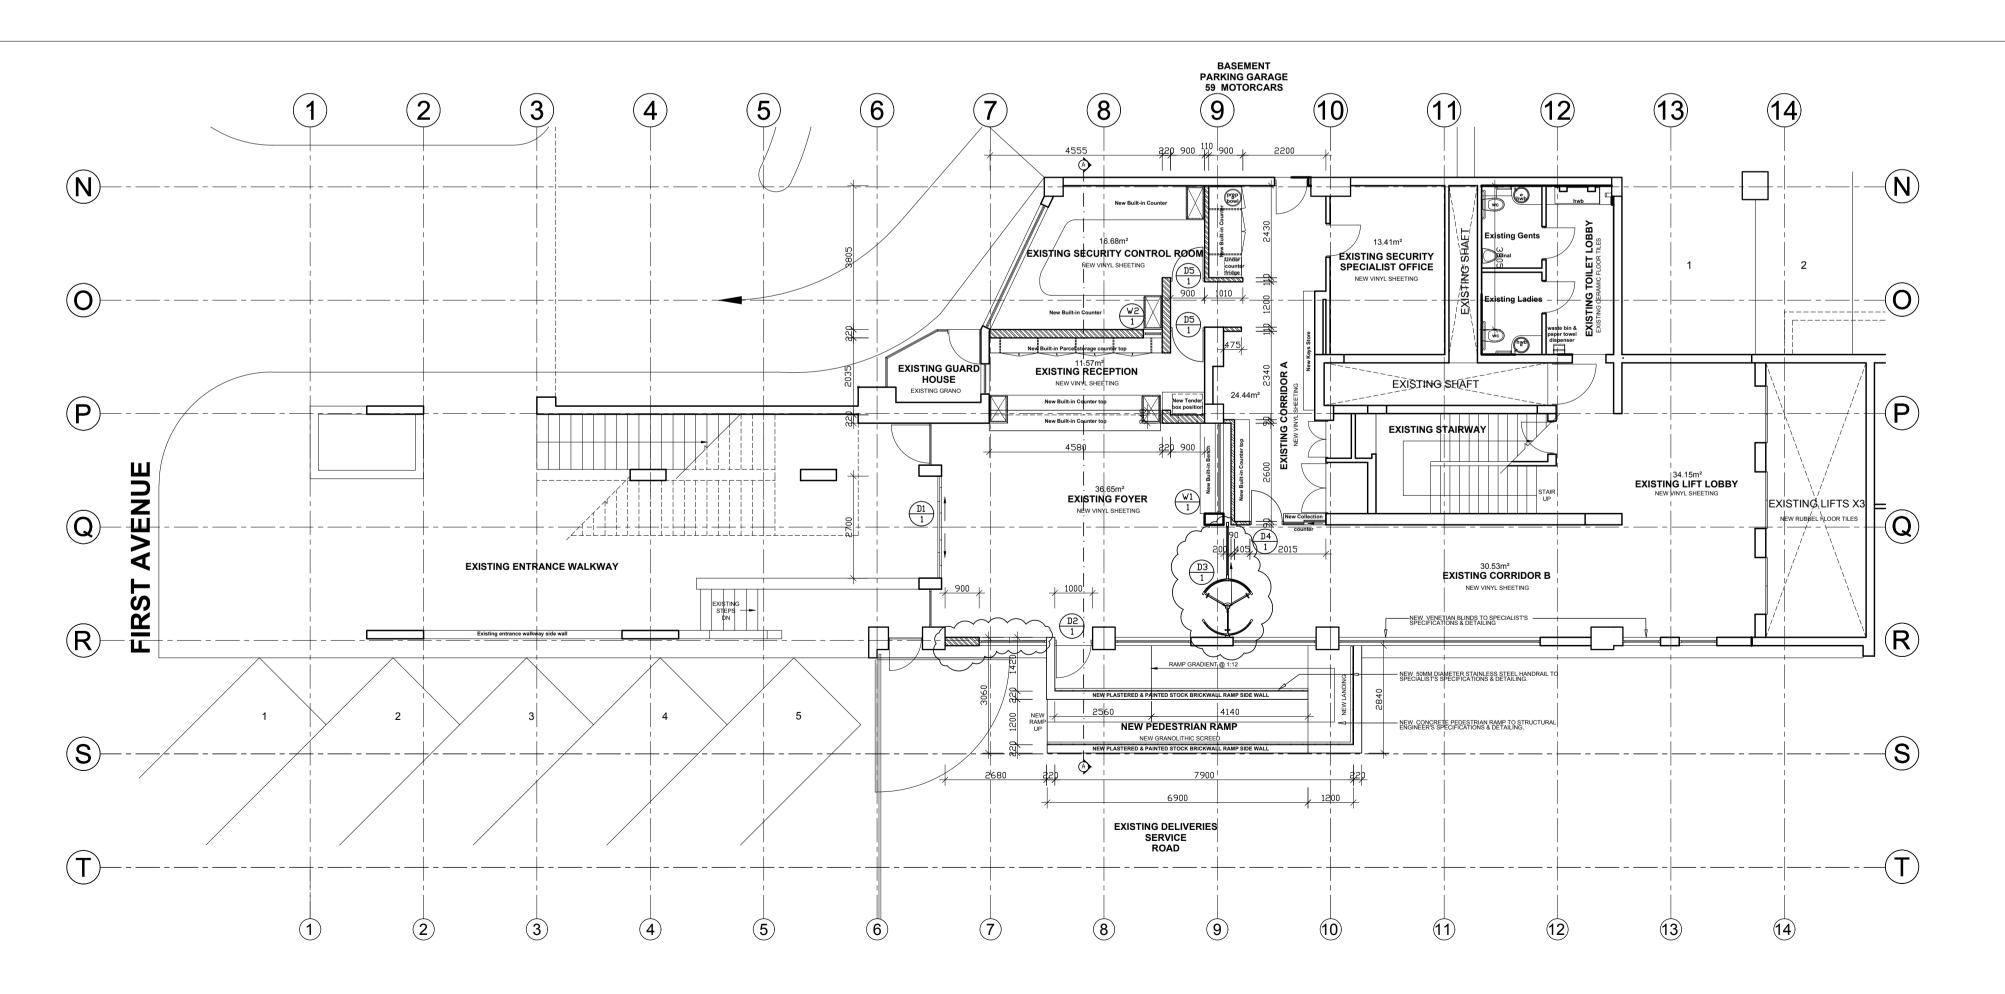


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SECURITY ENTRANCE FLOOR PLAN (RENOVATION)



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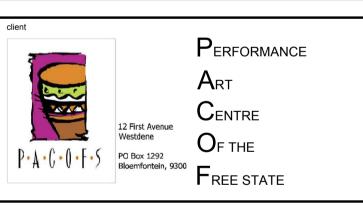
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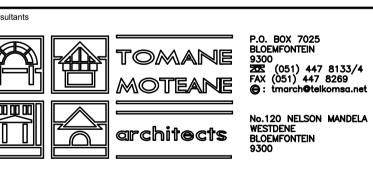
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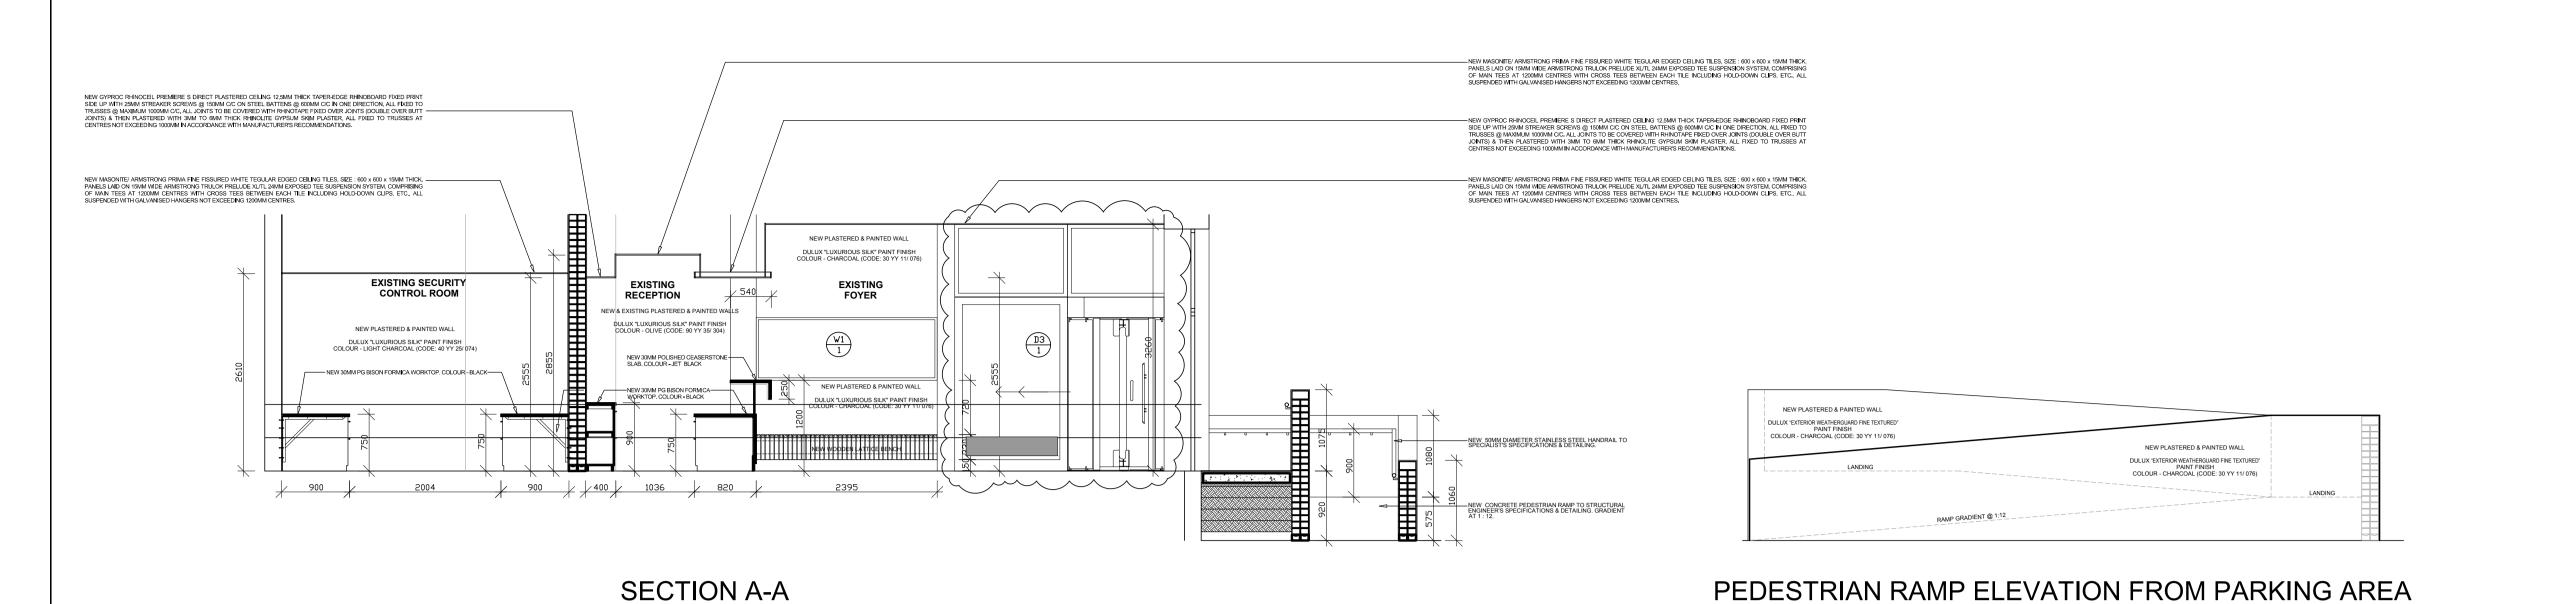


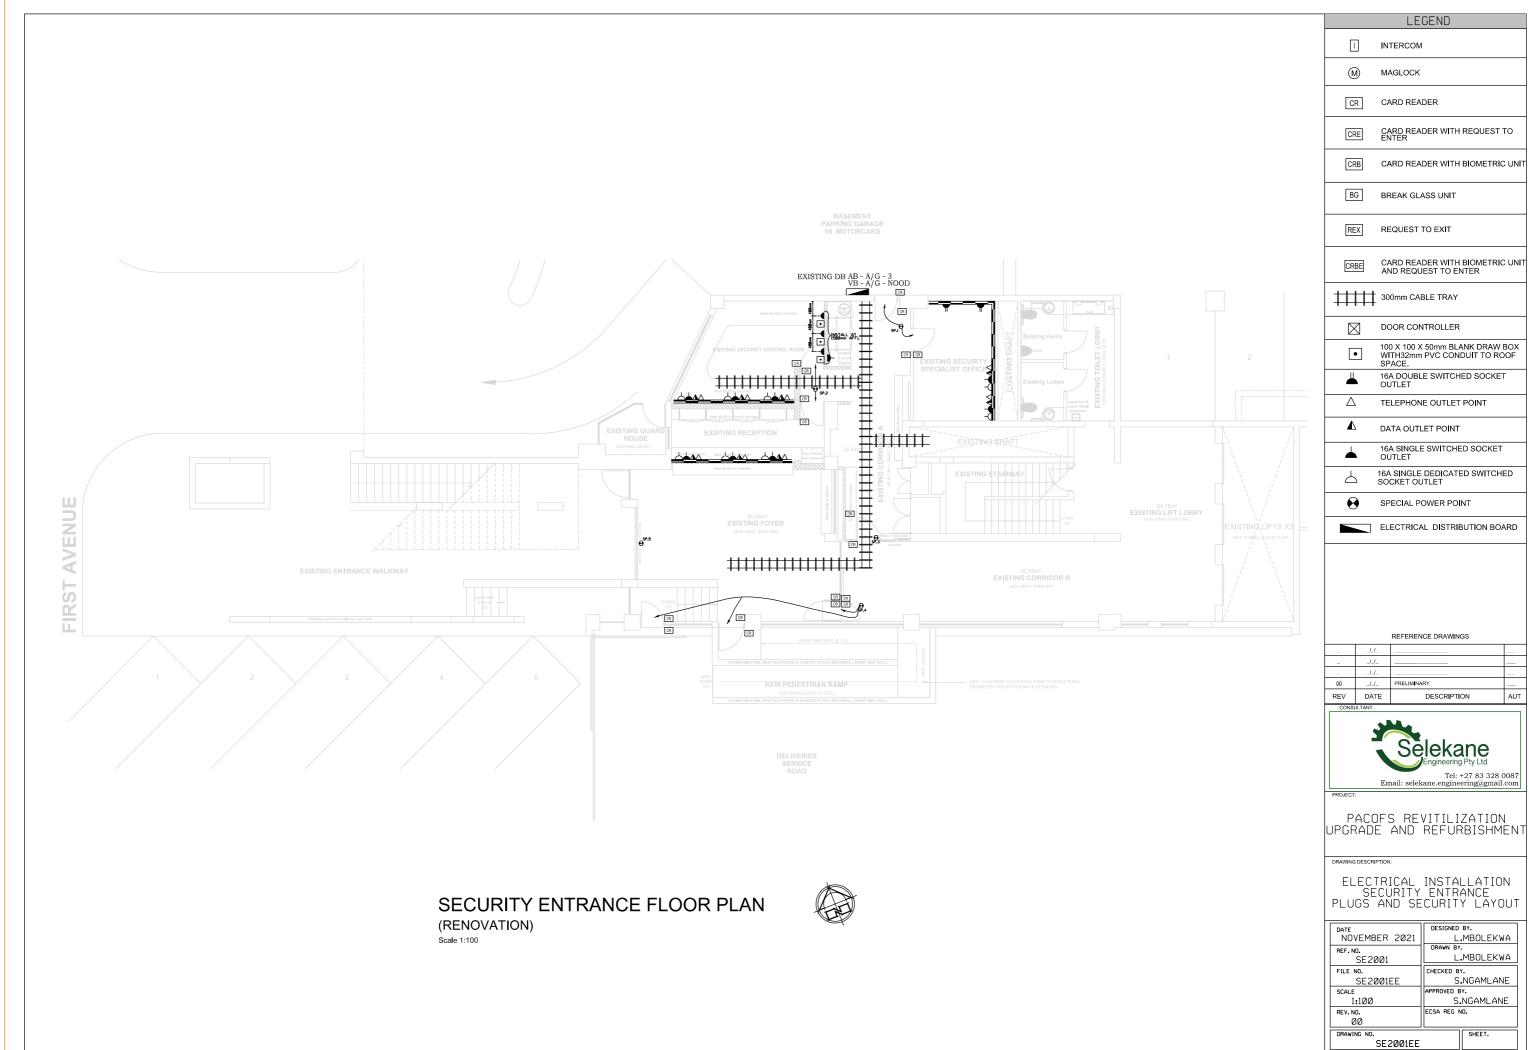
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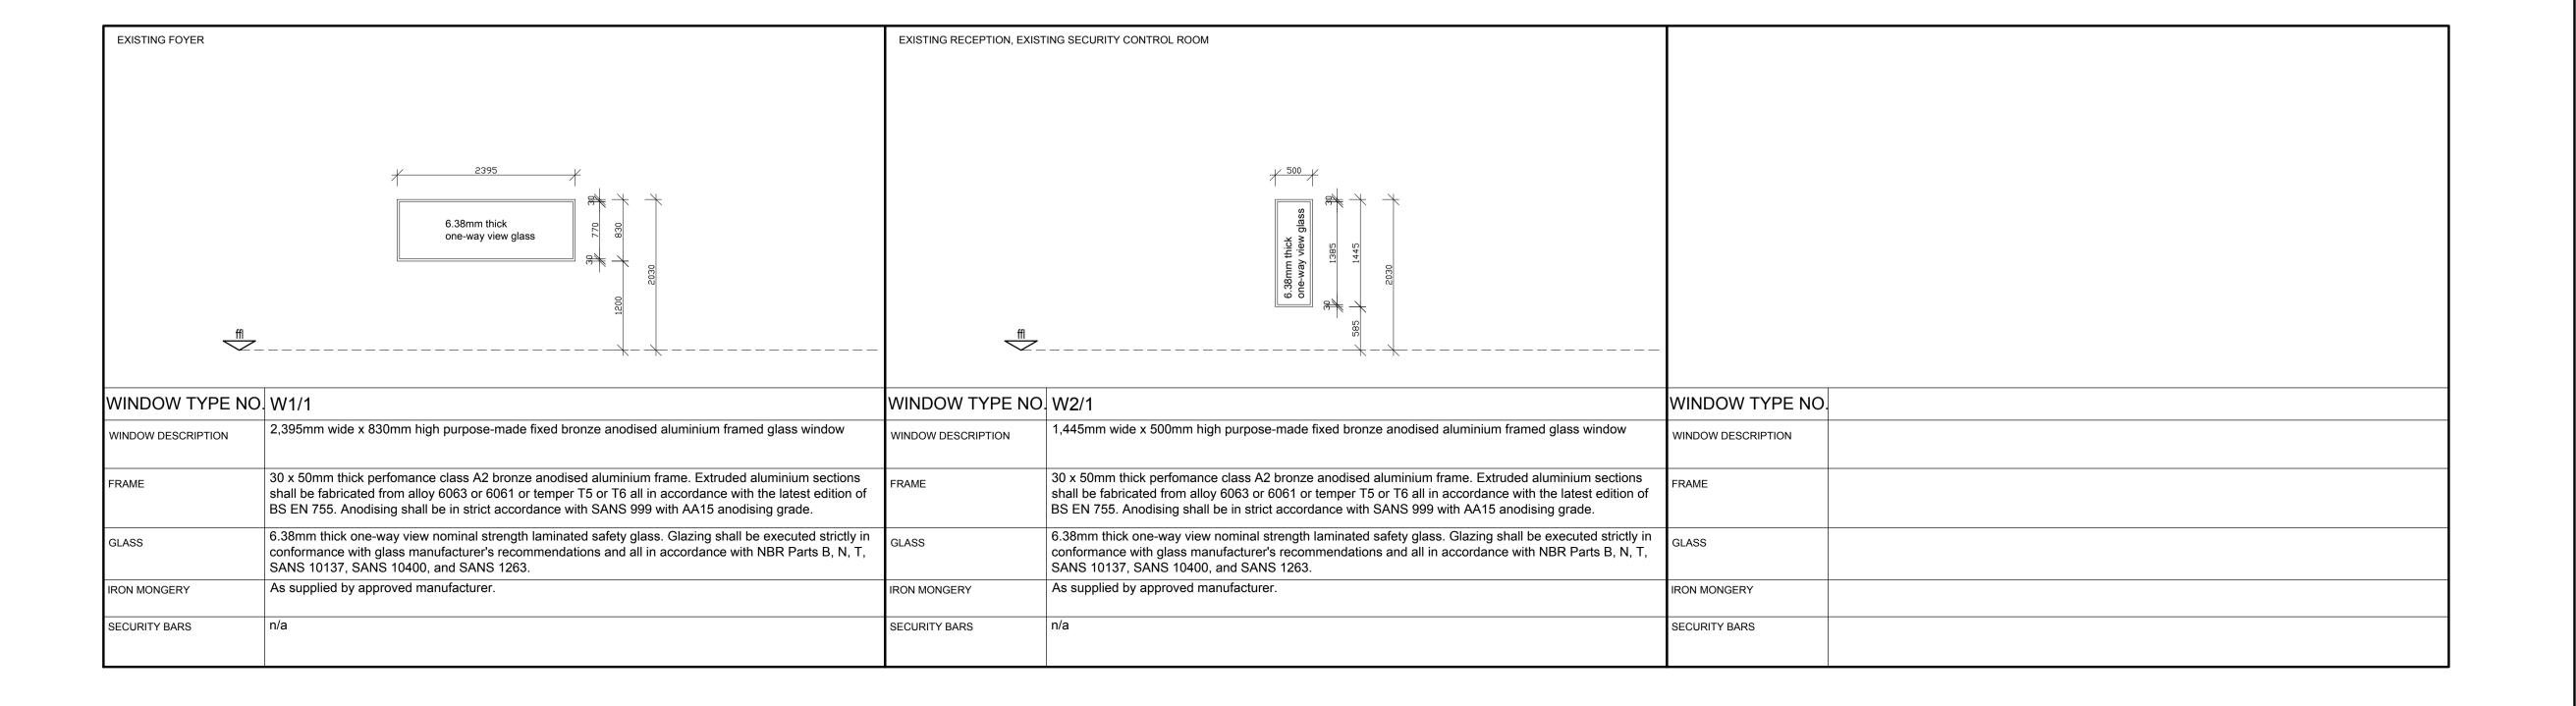
LOBBY IN BLOEMFONTEIN

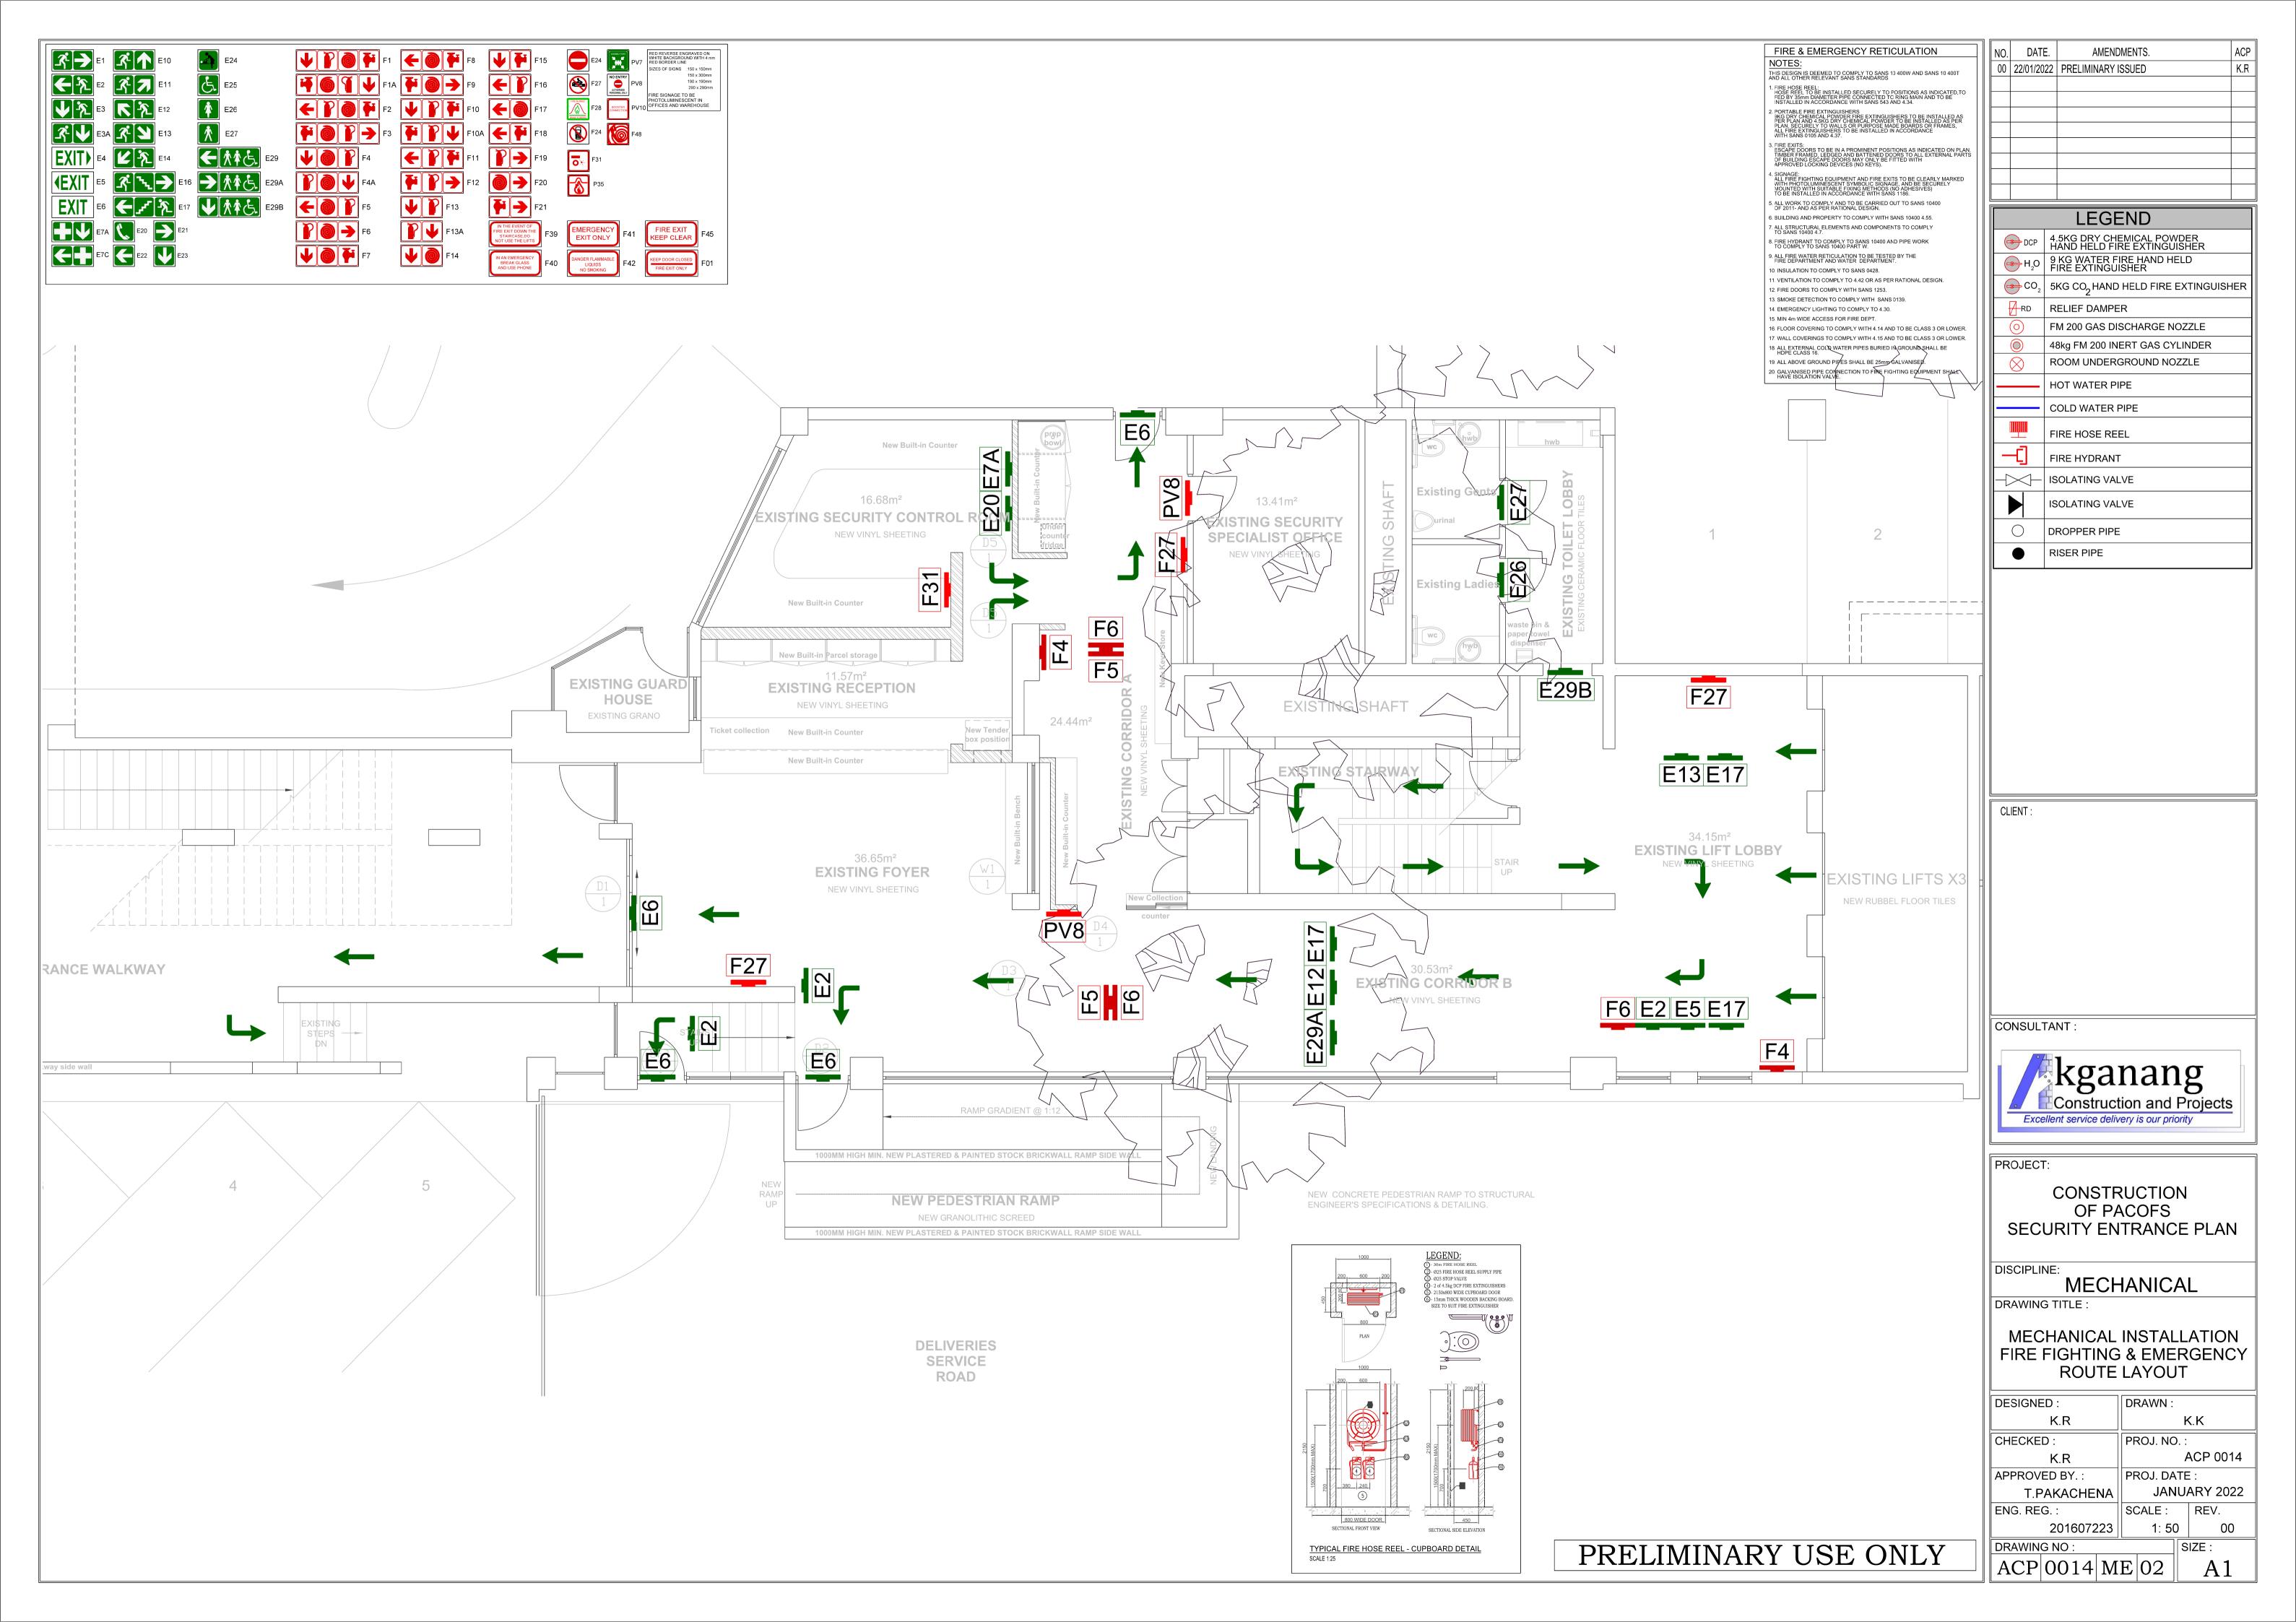PACOFS SECURITY ENTRANCE: DEMOLITION PLAN & RENOVATION FLOOR PLAN





ELEVATION OF RECEPTION COUNTER

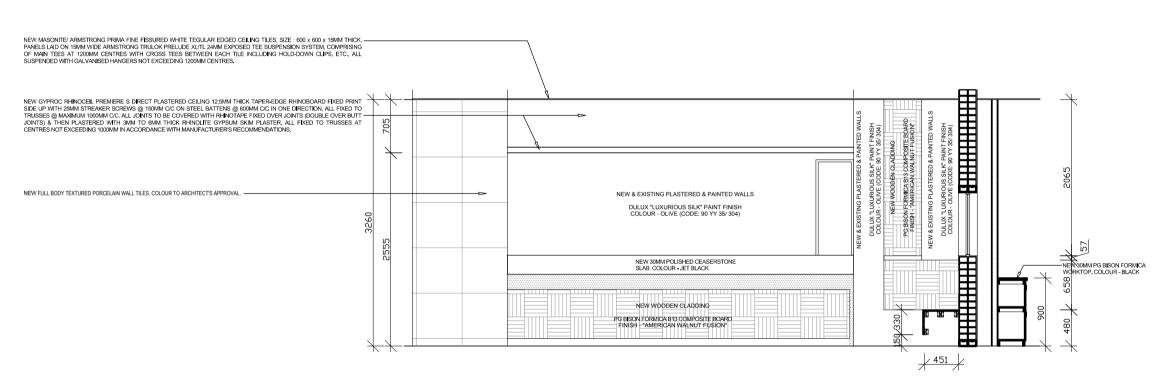

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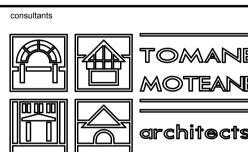
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discipline

ARCHITECTURE

service

REFURBISHMENT & ALTERATIONS TO THE EXISTING PACOFS ENTRANCE LOBBY IN BLOEMFONTEIN

awing title

PACOFS SECURITY ENTRANCE: SECTION, ELEVATIONS & WINDOW SCHEDULES

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scale	AS SHOWN	designed	A DE JONG/A, TOMANE
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DRAWING NUME B10	027-TD 200		revision 0