
MECHANICAL DRAWINGS

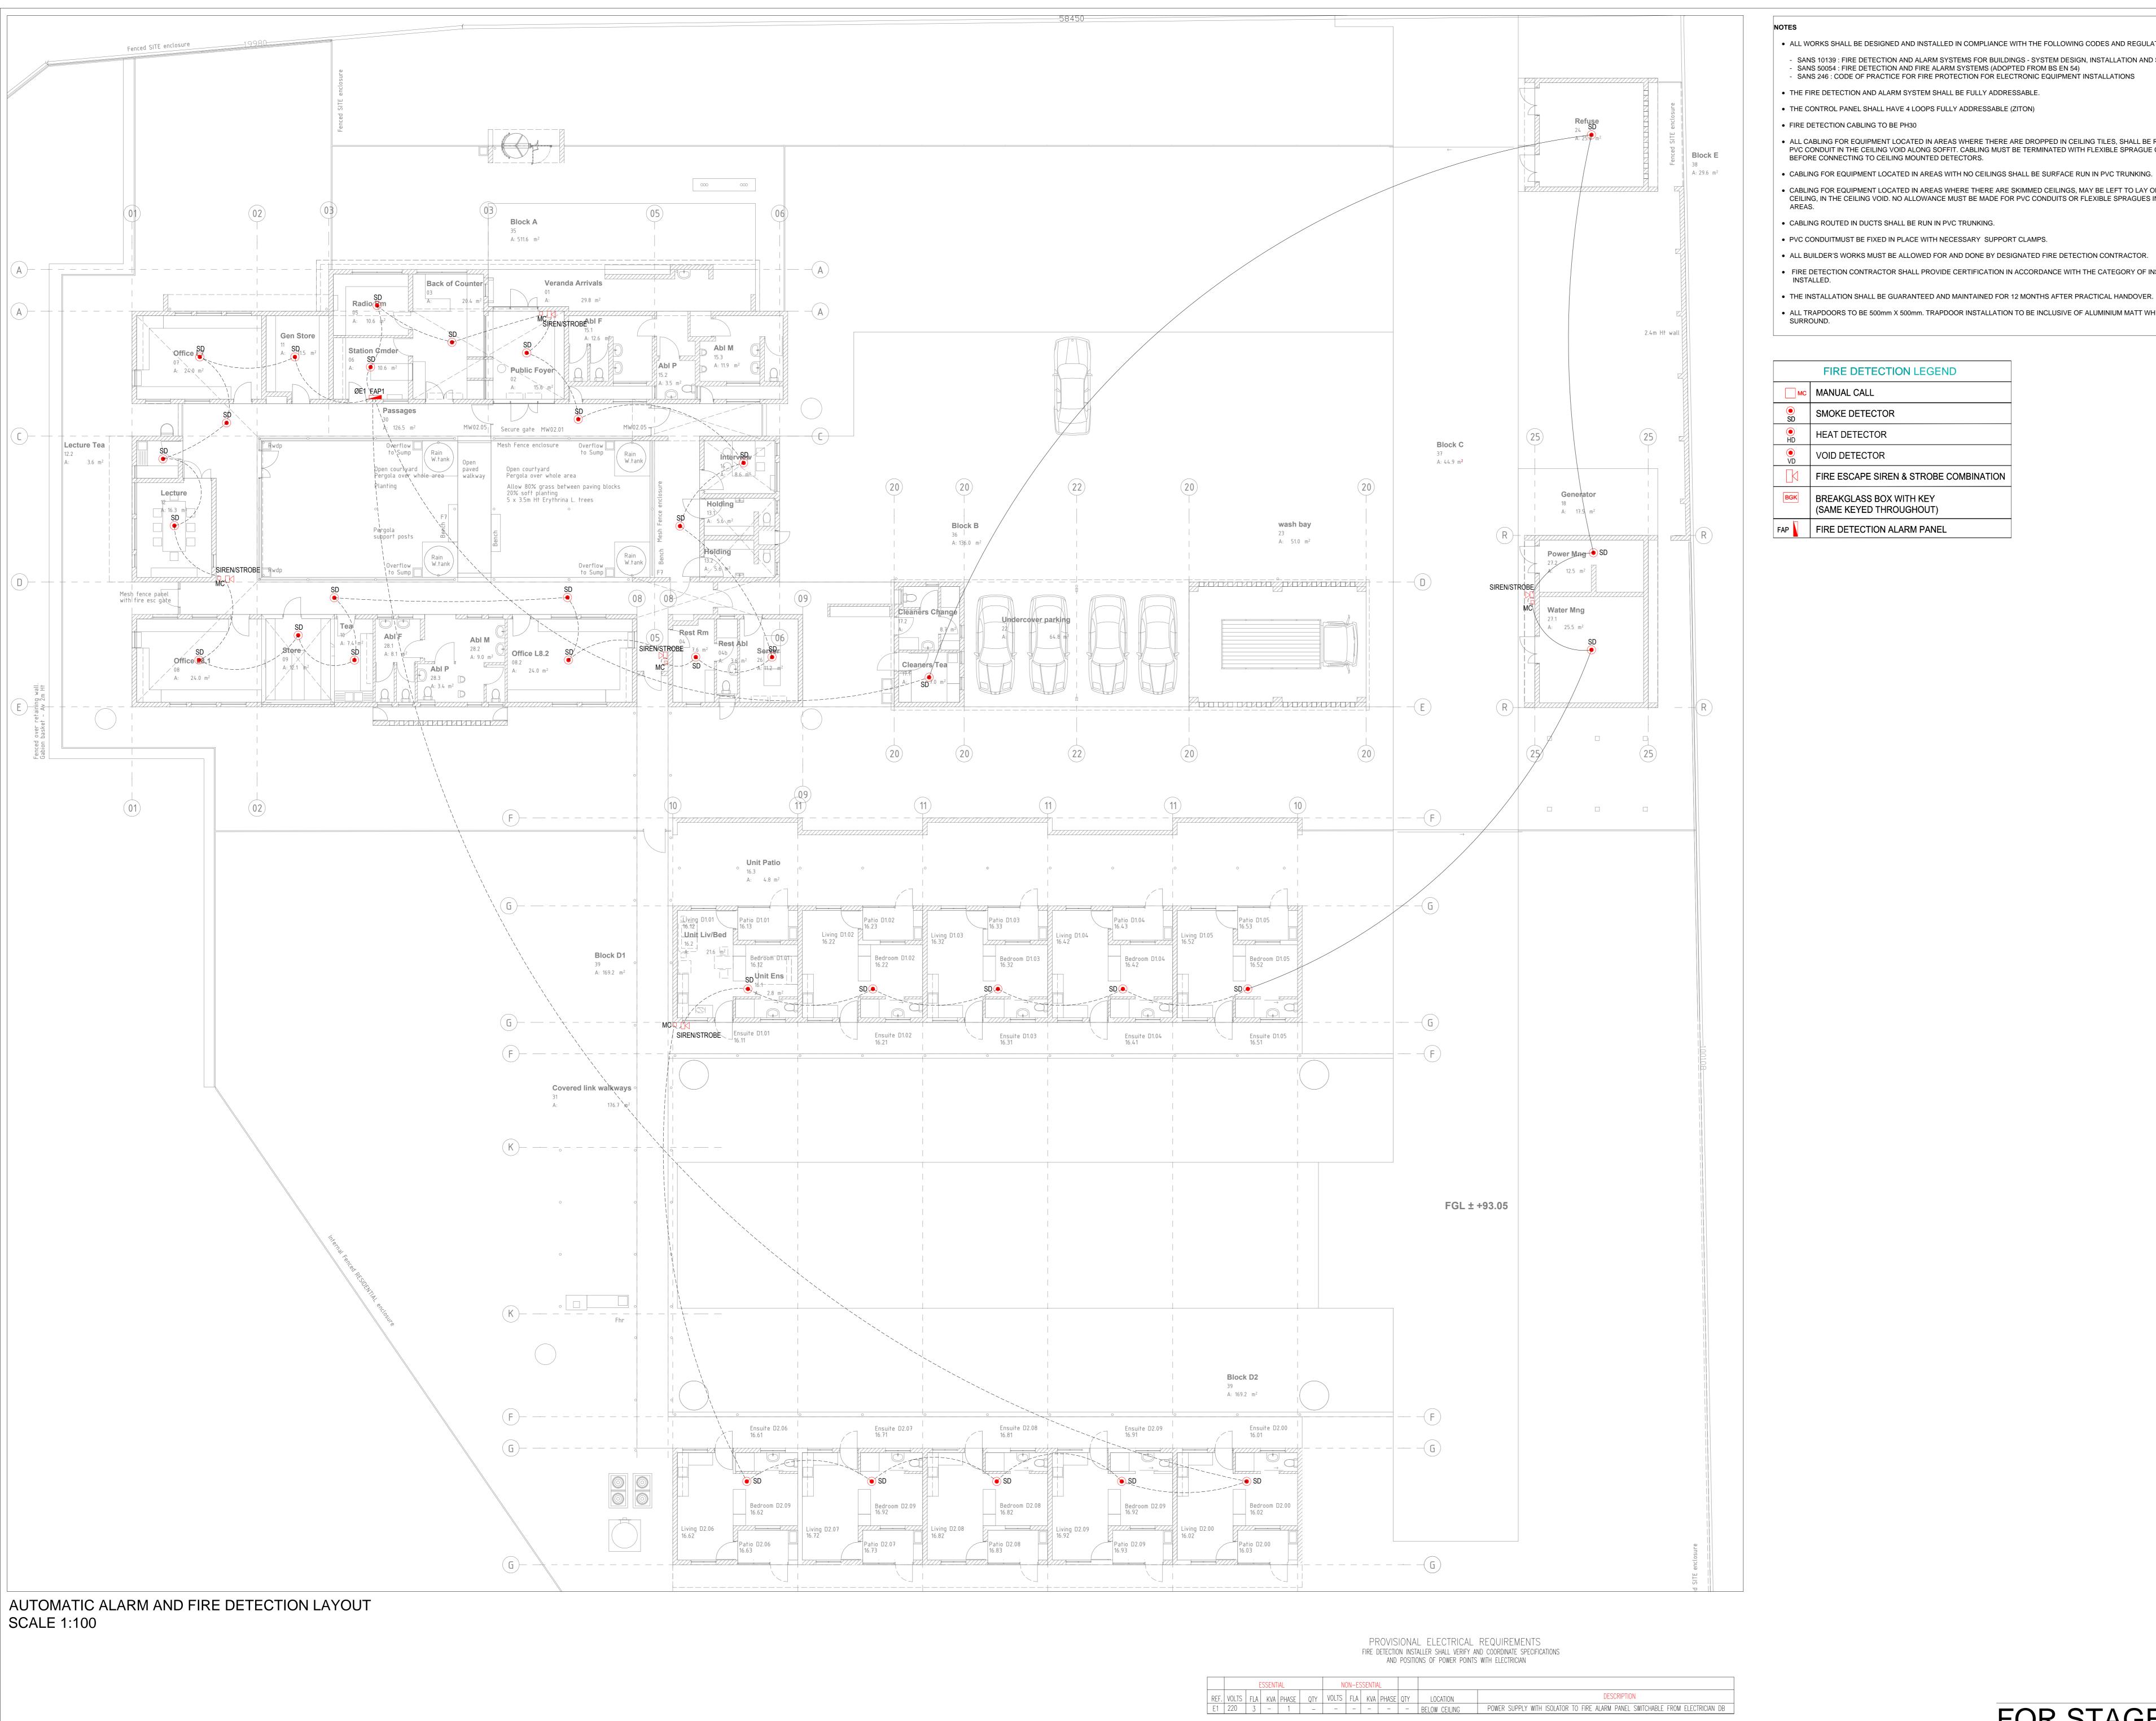

AUTOMATIC FIRE DETECTION

• ALL WORKS SHALL BE DESIGNED AND INSTALLED IN COMPLIANCE WITH THE FOLLOWING CODES AND REGULATIONS; - SANS 10139: FIRE DETECTION AND ALARM SYSTEMS FOR BUILDINGS - SYSTEM DESIGN, INSTALLATION AND SERVICING - SANS 50054 : FIRE DETECTION AND FIRE ALARM SYSTEMS (ADOPTED FROM BS EN 54)

- SANS 246 : CODE OF PRACTICE FOR FIRE PROTECTION FOR ELECTRONIC EQUIPMENT INSTALLATIONS

• THE FIRE DETECTION AND ALARM SYSTEM SHALL BE FULLY ADDRESSABLE.

• THE CONTROL PANEL SHALL HAVE 4 LOOPS FULLY ADDRESSABLE (ZITON)

 ALL CABLING FOR EQUIPMENT LOCATED IN AREAS WHERE THERE ARE DROPPED IN CEILING TILES, SHALL BE RUN IN PVC CONDUIT IN THE CEILING VOID ALONG SOFFIT. CABLING MUST BE TERMINATED WITH FLEXIBLE SPRAGUE CONDUIT BEFORE CONNECTING TO CEILING MOUNTED DETECTORS.

• CABLING FOR EQUIPMENT LOCATED IN AREAS WITH NO CEILINGS SHALL BE SURFACE RUN IN PVC TRUNKING.

 CABLING FOR EQUIPMENT LOCATED IN AREAS WHERE THERE ARE SKIMMED CEILINGS, MAY BE LEFT TO LAY ON THE CEILING, IN THE CEILING VOID. NO ALLOWANCE MUST BE MADE FOR PVC CONDUITS OR FLEXIBLE SPRAGUES IN THESE

CABLING ROUTED IN DUCTS SHALL BE RUN IN PVC TRUNKING.

• PVC CONDUITMUST BE FIXED IN PLACE WITH NECESSARY SUPPORT CLAMPS.

• ALL BUILDER'S WORKS MUST BE ALLOWED FOR AND DONE BY DESIGNATED FIRE DETECTION CONTRACTOR.

FIRE DETECTION CONTRACTOR SHALL PROVIDE CERTIFICATION IN ACCORDANCE WITH THE CATEGORY OF INSTALLATION

ALL TRAPDOORS TO BE 500mm X 500mm. TRAPDOOR INSTALLATION TO BE INCLUSIVE OF ALUMINIUM MATT WHITE FRAME

	FIRE DETECTION LEGEND				
MC	MANUAL CALL				
© SD	SMOKE DETECTOR				
• HD	HEAT DETECTOR				
VD	VOID DETECTOR				
	FIRE ESCAPE SIREN & STROBE COMBINATION				
BGK	BREAKGLASS BOX WITH KEY (SAME KEYED THROUGHOUT)				
FAP	FIRE DETECTION ALARM PANEL				

ARCHITECT: Durban: 46 Lena Ahrens Road, Glenwood, Durban 4000 tel: 031 201 0445 fax: 031 201 6609 email: admindbn@artek4.co.za
Port Shepstone: 19 Tradewinds, Marine Drive, Shelly Beach tel: 039 682 2447 fax: 039 682 2446 email: adminps@artek4.co.za

ISSUED FOR STAGE 4 APPROVAL MK 06/11/2024 UPDATED TO SUIT NEW ARCHITECTURAL LAYOUT

REVISION CONSULTING MECHANICAL ENGINEERS:

DESCRIPTION

MAHESH KHOOSAL & ASSOCIATES Mechanical Consulting Engineers PH: 031-536 8306 FAX: 031-536 8276

BY DATE

NEW NTSHINGWE SATELLITE POLICE STATION


Portion 481 of the Farm Makathini Flats No 16533 Access road P441, Ntshongwe, uMhlabuyalingana Local Municipality


for the South African Police Services

DRAWING TITLE : AUTOMATIC ALARM AND FIRE DETECTION NTSHONGWE POLICE STATION

SCALE: 1:100 PROJ. No. M693 26/09/23 DRG. No.: M693/FD/01 C

FOR STAGE 4

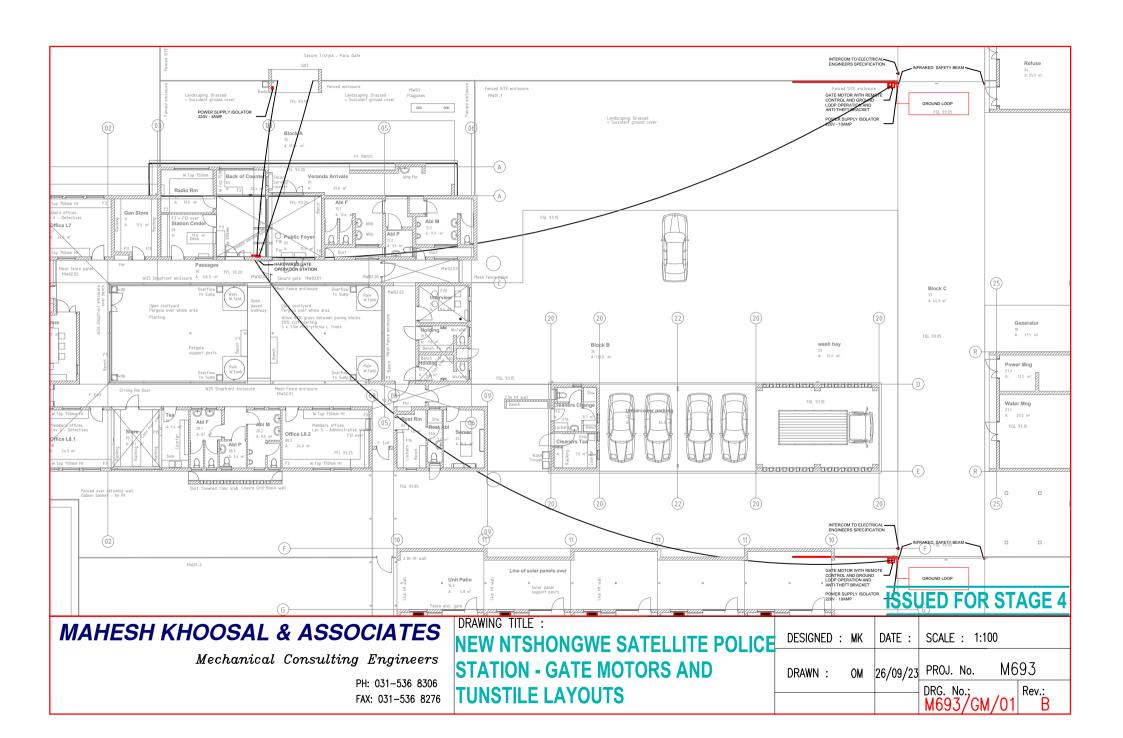

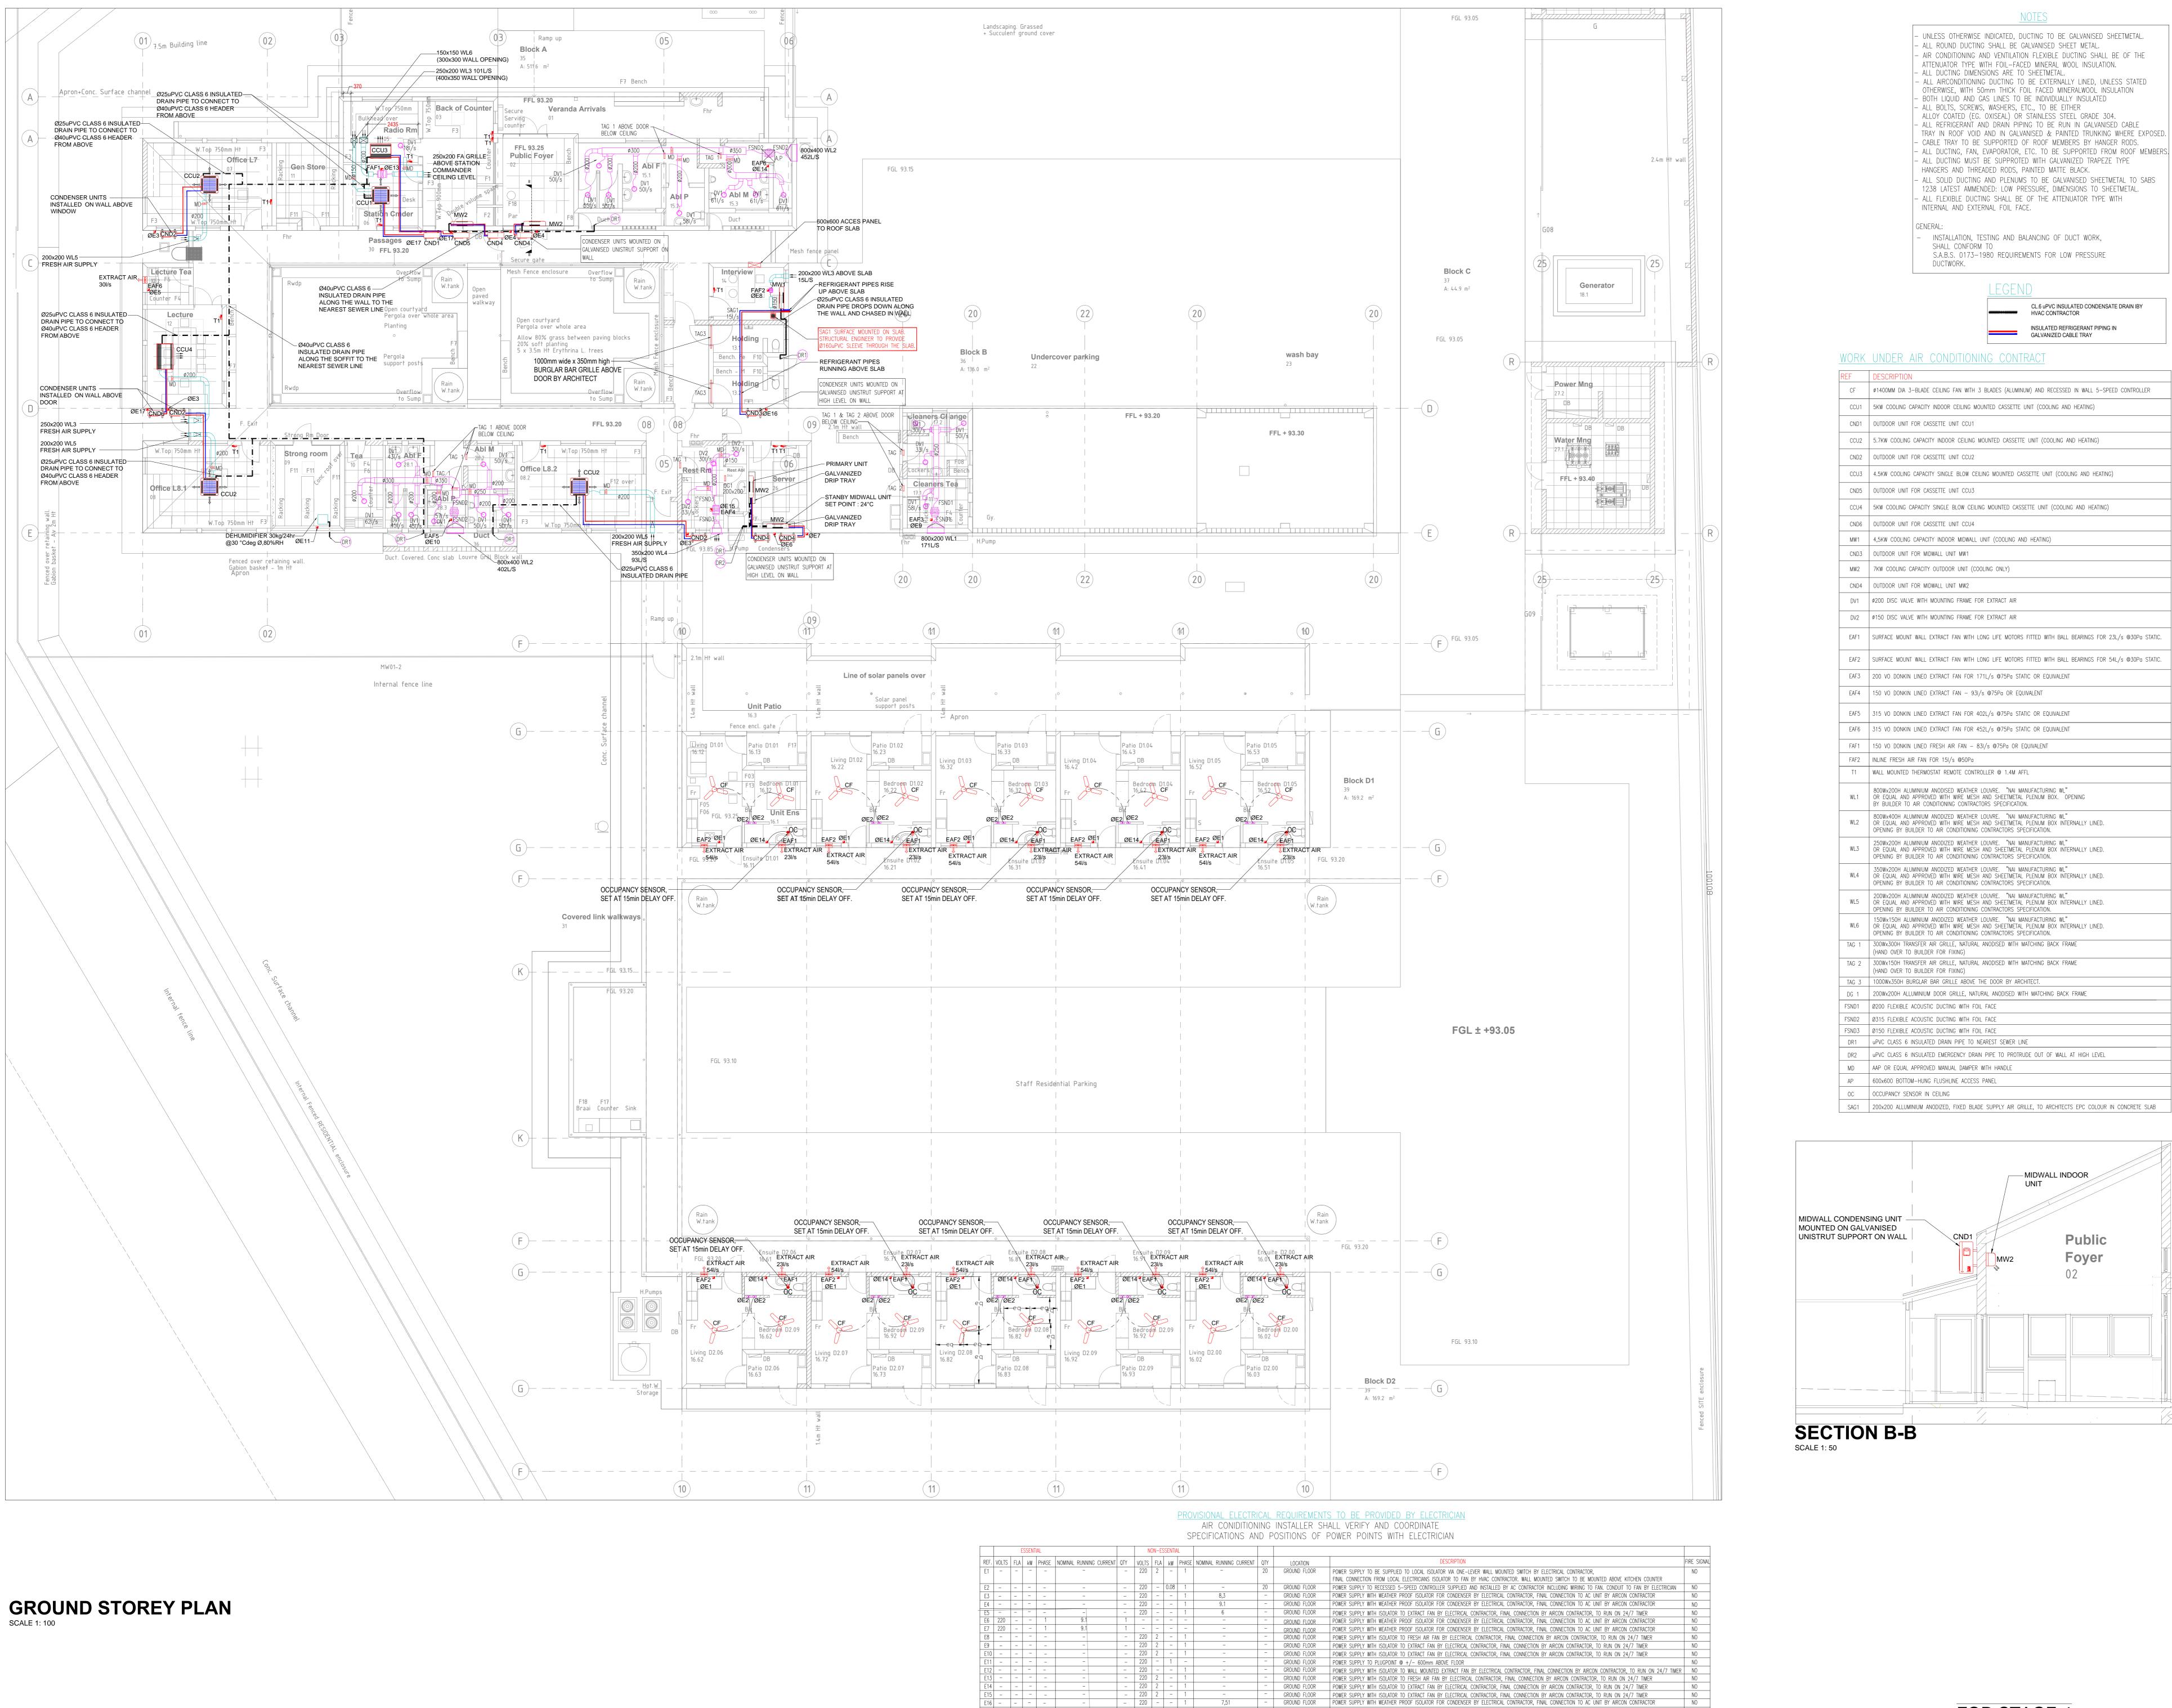

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LOCAL AUTHORITY STAMPS:

 Any discrepancies or unclear information must immediately be reported to the Mechanical Engineer prior to any commencement of work. MKA will not be held responsible for any remedial work if above 2. Onus is on the sub-contractor to ensure installation is completed to the Mechanical Engineers specification. Do not scale this drawing.

General Notes: - ALL AIRCONDITIONING DUCTING TO BE EXTERNALLY LINED, UNLESS STATED procedure is not adhered to.

CL.6 uPVC INSULATED CONDENSATE DRAIN IBY

VURK	UNDER AIR CONDITIONING CONTRACT
REF	DESCRIPTION
CF	ø1400MM DIA 3-BLADE CEILING FAN WITH 3 BLADES (ALUMINUM) AND RECESSED IN WALL 5-SPEED CONTROLLER
CCU1	5KW COOLING CAPACITY INDOOR CEILING MOUNTED CASSETTE UNIT (COOLING AND HEATING)
CND1	OUTDOOR UNIT FOR CASSETTE UNIT CCU1
CCU2	5.7KW COOLING CAPACITY INDOOR CEILING MOUNTED CASSETTE UNIT (COOLING AND HEATING)
CND2	OUTDOOR UNIT FOR CASSETTE UNIT CCU2
CCU3	4.5KW COOLING CAPACITY SINGLE BLOW CEILING MOUNTED CASSETTE UNIT (COOLING AND HEATING)
CND5	OUTDOOR UNIT FOR CASSETTE UNIT CCU3
CCU4	5KW COOLING CAPACITY SINGLE BLOW CEILING MOUNTED CASSETTE UNIT (COOLING AND HEATING)
CND6	OUTDOOR UNIT FOR CASSETTE UNIT CCU4
MW1	4,5KW COOLING CAPACITY INDOOR MIDWALL UNIT (COOLING AND HEATING)
CND3	OUTDOOR UNIT FOR MIDWALL UNIT MW1
MW2	7KW COOLING CAPACITY OUTDOOR UNIT (COOLING ONLY)
CND4	OUTDOOR UNIT FOR MIDWALL UNIT MW2
DV1	Ø200 DISC VALVE WITH MOUNTING FRAME FOR EXTRACT AIR
DV2	Ø150 DISC VALVE WITH MOUNTING FRAME FOR EXTRACT AIR
EAF1	SURFACE MOUNT WALL EXTRACT FAN WITH LONG LIFE MOTORS FITTED WITH BALL BEARINGS FOR 23L/s @30Pa STATIC.
EAF2	SURFACE MOUNT WALL EXTRACT FAN WITH LONG LIFE MOTORS FITTED WITH BALL BEARINGS FOR 54L/s @30Pa STATIC.
EAF3	200 VO DONKIN LINEO EXTRACT FAN FOR 171L/s @75Pa STATIC OR EQUIVALENT
EAF4	150 VO DONKIN LINEO EXTRACT FAN - 93I/s @75Pa OR EQUIVALENT
EAF5	315 VO DONKIN LINEO EXTRACT FAN FOR 402L/s @75Pa STATIC OR EQUIVALENT
EAF6	315 VO DONKIN LINEO EXTRACT FAN FOR 452L/s @75Pa STATIC OR EQUIVALENT
FAF1	150 VO DONKIN LINEO FRESH AIR FAN — 831/s @75Pa OR EQUIVALENT
FAF2	INLINE FRESH AIR FAN FOR 15I/s @50Pa
T1	WALL MOUNTED THERMOSTAT REMOTE CONTROLLER @ 1.4M AFFL
WL1	800Wx200H ALUMINIUM ANODISED WEATHER LOUVRE. "NAI MANUFACTURING WL" OR EQUAL AND APPROVED WITH WIRE MESH AND SHEETMETAL PLENUM BOX. OPENING BY BUILDER TO AIR CONDITIONING CONTRACTORS SPECIFICATION.
WL2	800Wx400H ALUMINIUM ANODIZED WEATHER LOUVRE. "NAI MANUFACTURING WL" OR EQUAL AND APPROVED WITH WIRE MESH AND SHEETMETAL PLENUM BOX INTERNALLY LINED. OPENING BY BUILDER TO AIR CONDITIONING CONTRACTORS SPECIFICATION.
WL3	250Wx200H ALUMINIUM ANODIZED WEATHER LOUVRE. "NAI MANUFACTURING WL" OR EQUAL AND APPROVED WITH WIRE MESH AND SHEETMETAL PLENUM BOX INTERNALLY LINED. OPENING BY BUILDER TO AIR CONDITIONING CONTRACTORS SPECIFICATION.
WL4	350Wx200H ALUMINIUM ANODIZED WEATHER LOUVRE. "NAI MANUFACTURING WL" OR EQUAL AND APPROVED WITH WIRE MESH AND SHEETMETAL PLENUM BOX INTERNALLY LINED. OPENING BY BUILDER TO AIR CONDITIONING CONTRACTORS SPECIFICATION.
WL5	200Wx200H ALUMINIUM ANODIZED WEATHER LOUVRE. "NAI MANUFACTURING WL" OR EQUAL AND APPROVED WITH WIRE MESH AND SHEETMETAL PLENUM BOX INTERNALLY LINED. OPENING BY BUILDER TO AIR CONDITIONING CONTRACTORS SPECIFICATION.
WL6	150Wx150H ALUMINIUM ANODIZED WEATHER LOUVRE. "NAI MANUFACTURING WL" OR EQUAL AND APPROVED WITH WIRE MESH AND SHEETMETAL PLENUM BOX INTERNALLY LINED. OPENING BY BUILDER TO AIR CONDITIONING CONTRACTORS SPECIFICATION.
TAG 1	300Wx300H TRANSFER AIR GRILLE, NATURAL ANODISED WITH MATCHING BACK FRAME (HAND OVER TO BUILDER FOR FIXING)
TAG 2	300Wx150H TRANSFER AIR GRILLE, NATURAL ANODISED WITH MATCHING BACK FRAME (HAND OVER TO BUILDER FOR FIXING)
TAG 3	1000Wx350H BURGLAR BAR GRILLE ABOVE THE DOOR BY ARCHITECT.
DG 1	200Wx200H ALLUMINIUM DOOR GRILLE, NATURAL ANODISED WITH MATCHING BACK FRAME
FSND1	Ø200 FLEXIBLE ACOUSTIC DUCTING WITH FOIL FACE
FSND2	Ø315 FLEXIBLE ACOUSTIC DUCTING WITH FOIL FACE
FSND3	Ø150 FLEXIBLE ACOUSTIC DUCTING WITH FOIL FACE
DR1	upvc class 6 insulated drain pipe to nearest sewer line
DR2	UPVC CLASS 6 INSULATED EMERGENCY DRAIN PIPE TO PROTRUDE OUT OF WALL AT HIGH LEVEL
MD	AAP OR EQUAL APPROVED MANUAL DAMPER WITH HANDLE
AP	600x600 BOTTOM-HUNG FLUSHLINE ACCESS PANEL

- MIDWALL INDOOR

DESCRIPTION BY DATE REVISION CONSULTING MECHANICAL ENGINEERS: MAHESH KHOOSAL & ASSOCIATES Mechanical Consulting Engineers

ARTEK 4 ARCHITECTS (KZN) CO

ISSUED FOR STAGE 4 APPROVAL

CONSOLE UNITS CHANGED TO CEILING FANS IN THE

OM 02/07/2024

OM 03/06/2024

OM 24/04/2024

PH: 031-536 8306

FAX: 031-536 8276

LECTURE ROOM CASSETTE UNIT CHANGED TO SINGLE BLOW CEILING MOUNTED CASSETTE UNIT. DRAWING UPDATED TO SUIT NEW ARCH. LAYOUT ISSUED FOR STAGE 3

RESIDENTIAL AREA.

ISSUED FOR STAGE 3

ISSUED FOR STAGE 3

DRAWING UPDATED TO SUIT NEW ARCH. LAYOUT

tel: 031 201 0445 fax: 031 201 6609 email: admindbn@artek4.co.za

Port Shepstone: 19 Tradewinds, Marine Drive, Shelly Beach tel: 039 682 2447 fax: 039 682 2446 email:

Durban: 46 Lena Ahrens Road, Glenwood, Durban 4000

ARCHITECT:

NEW NTSHINGWE SATELLITE POLICE Portion 481 of the Farm Makathini

Flats No 16533 Access road P441, Ntshongwe, uMhlabuyalingana Local Municipality for the

South African Police Services


DRAWING TITLE : AIRCONDITIONING AND VENTILATION NTSHONGWE POLICE STATION DESIGNED: AK SCALE: 1:100 PROJ. No. M693 26/09/23 DRG. No.:


M693/AC/01


FOR STAGE 4


GROUND FLOOR POWER SUPPLY WITH WEATHER PROOF ISOLATOR FOR CONDENSER BY ELECTRICAL CONTRACTOR, FINAL CONNECTION TO AC UNIT BY AIRCON CONTRACTOR

CHECKED : PRINCIPAL:

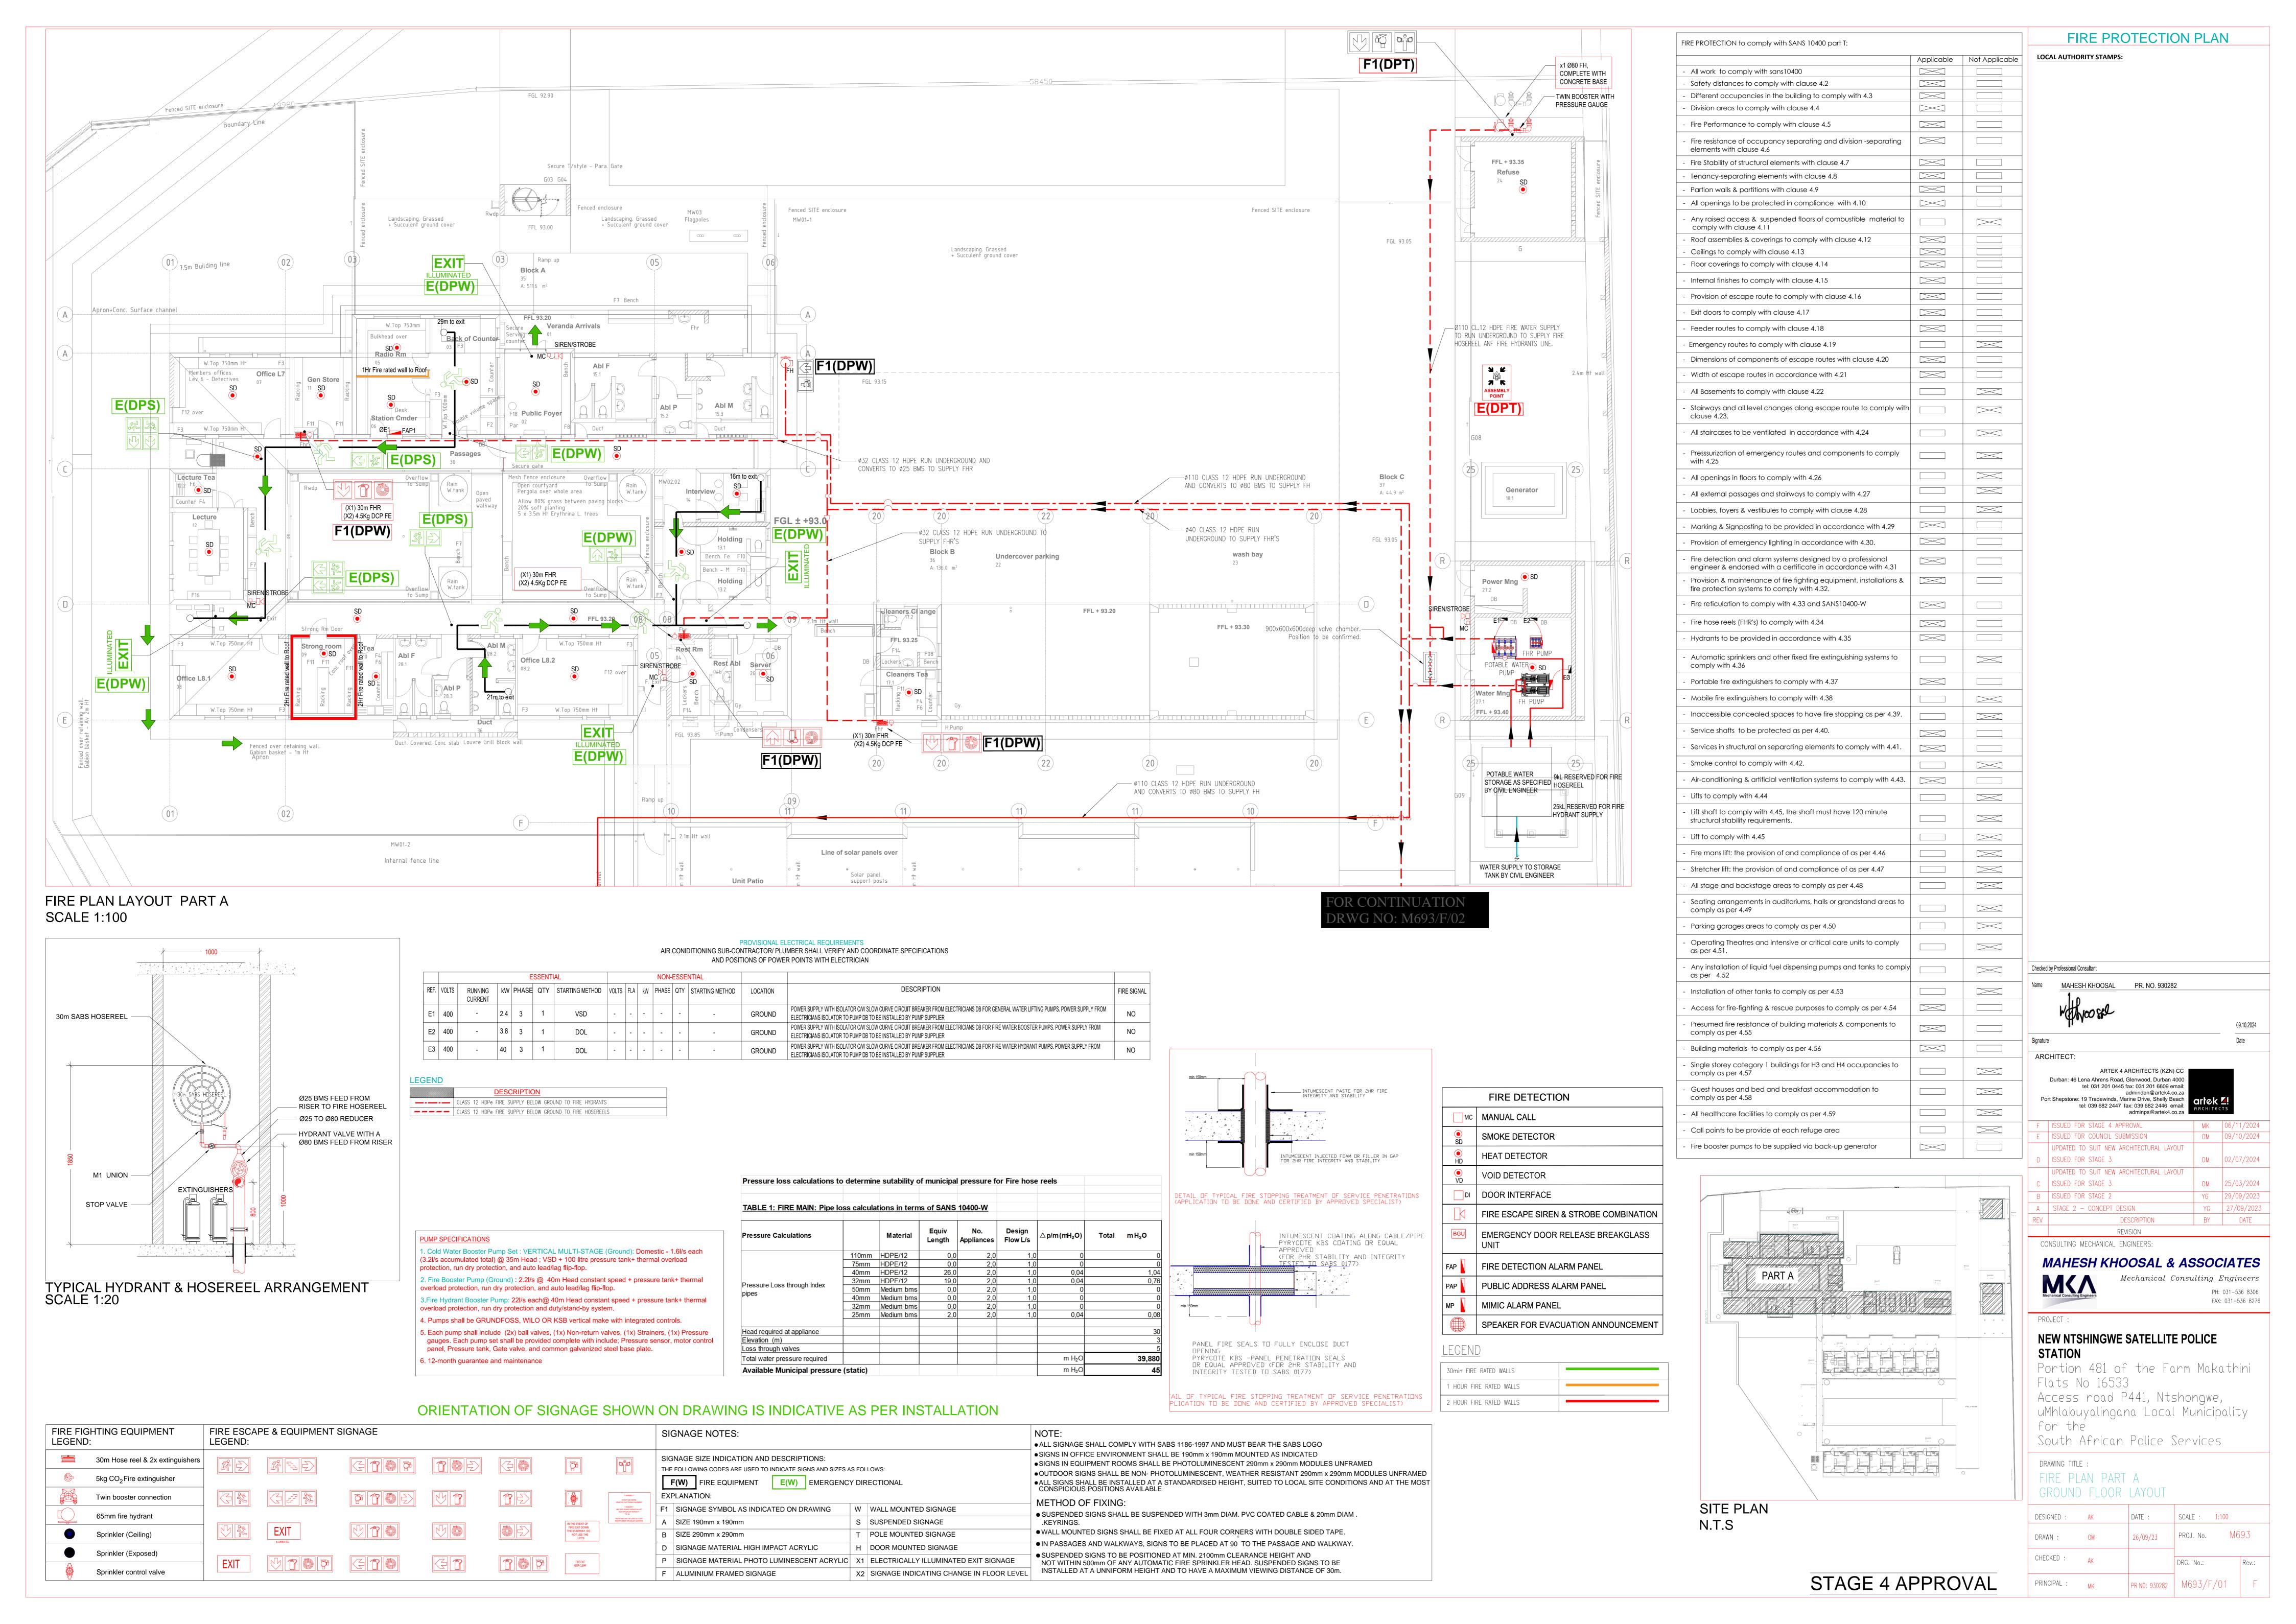

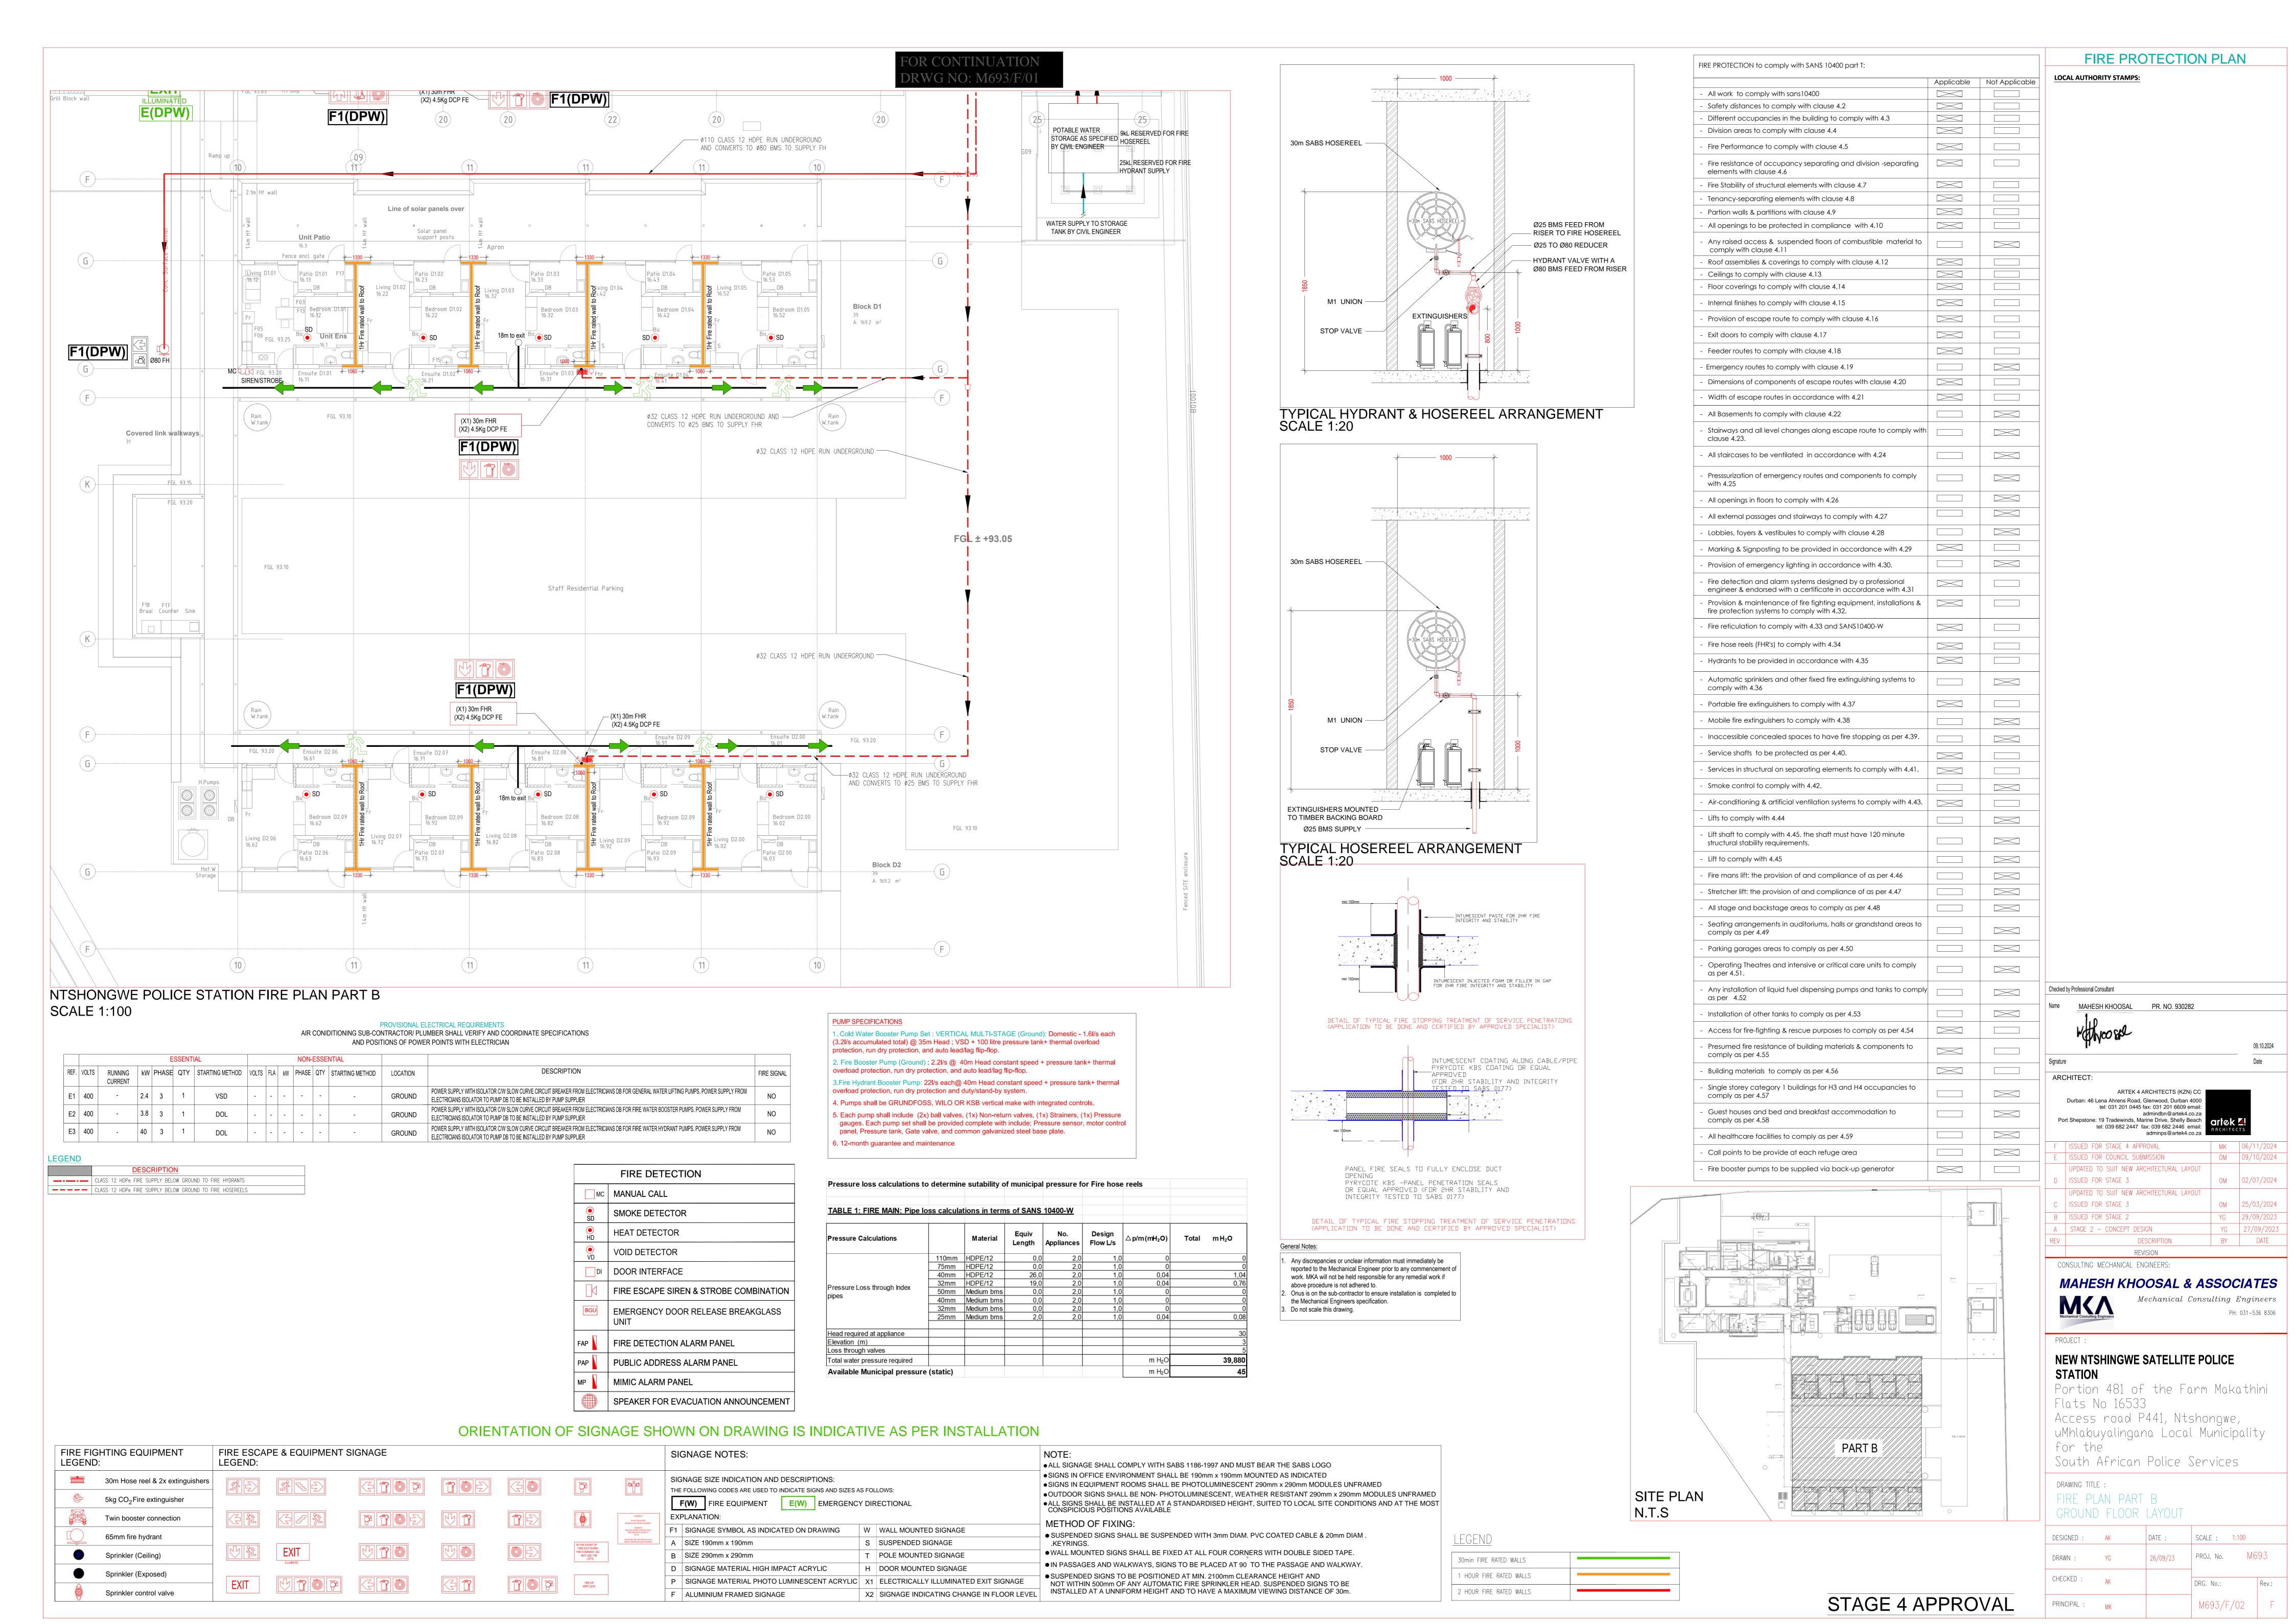

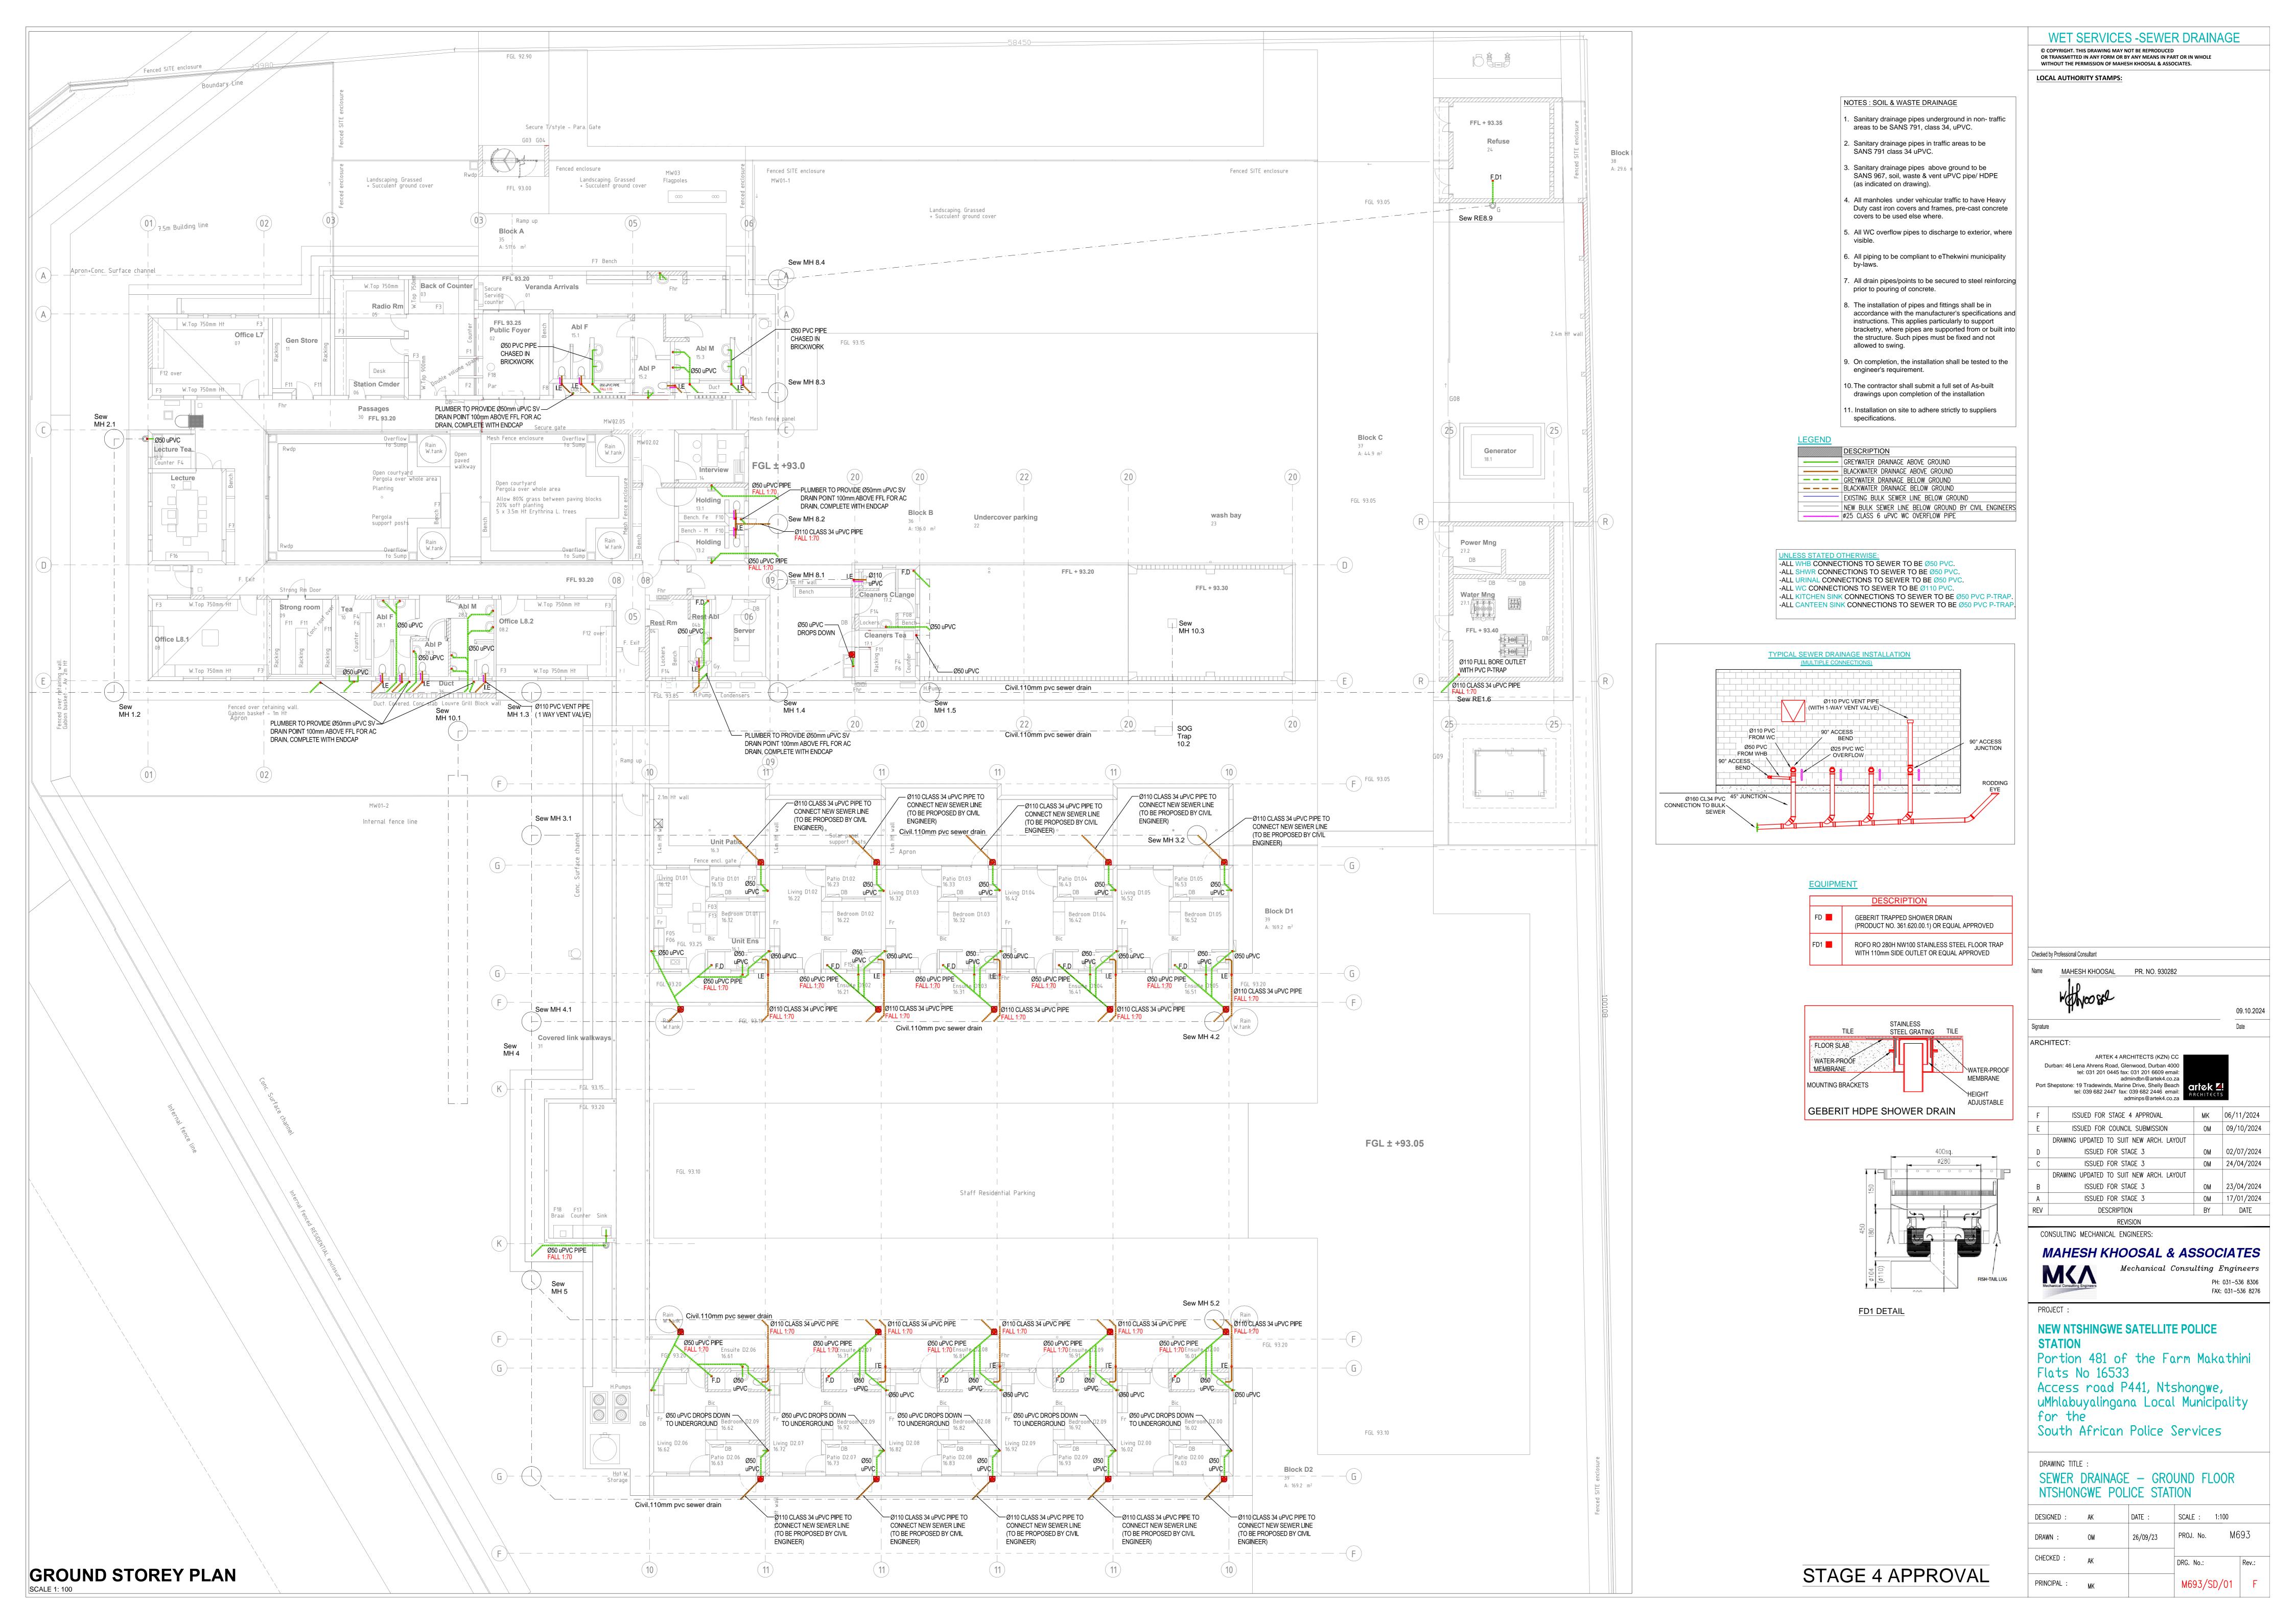

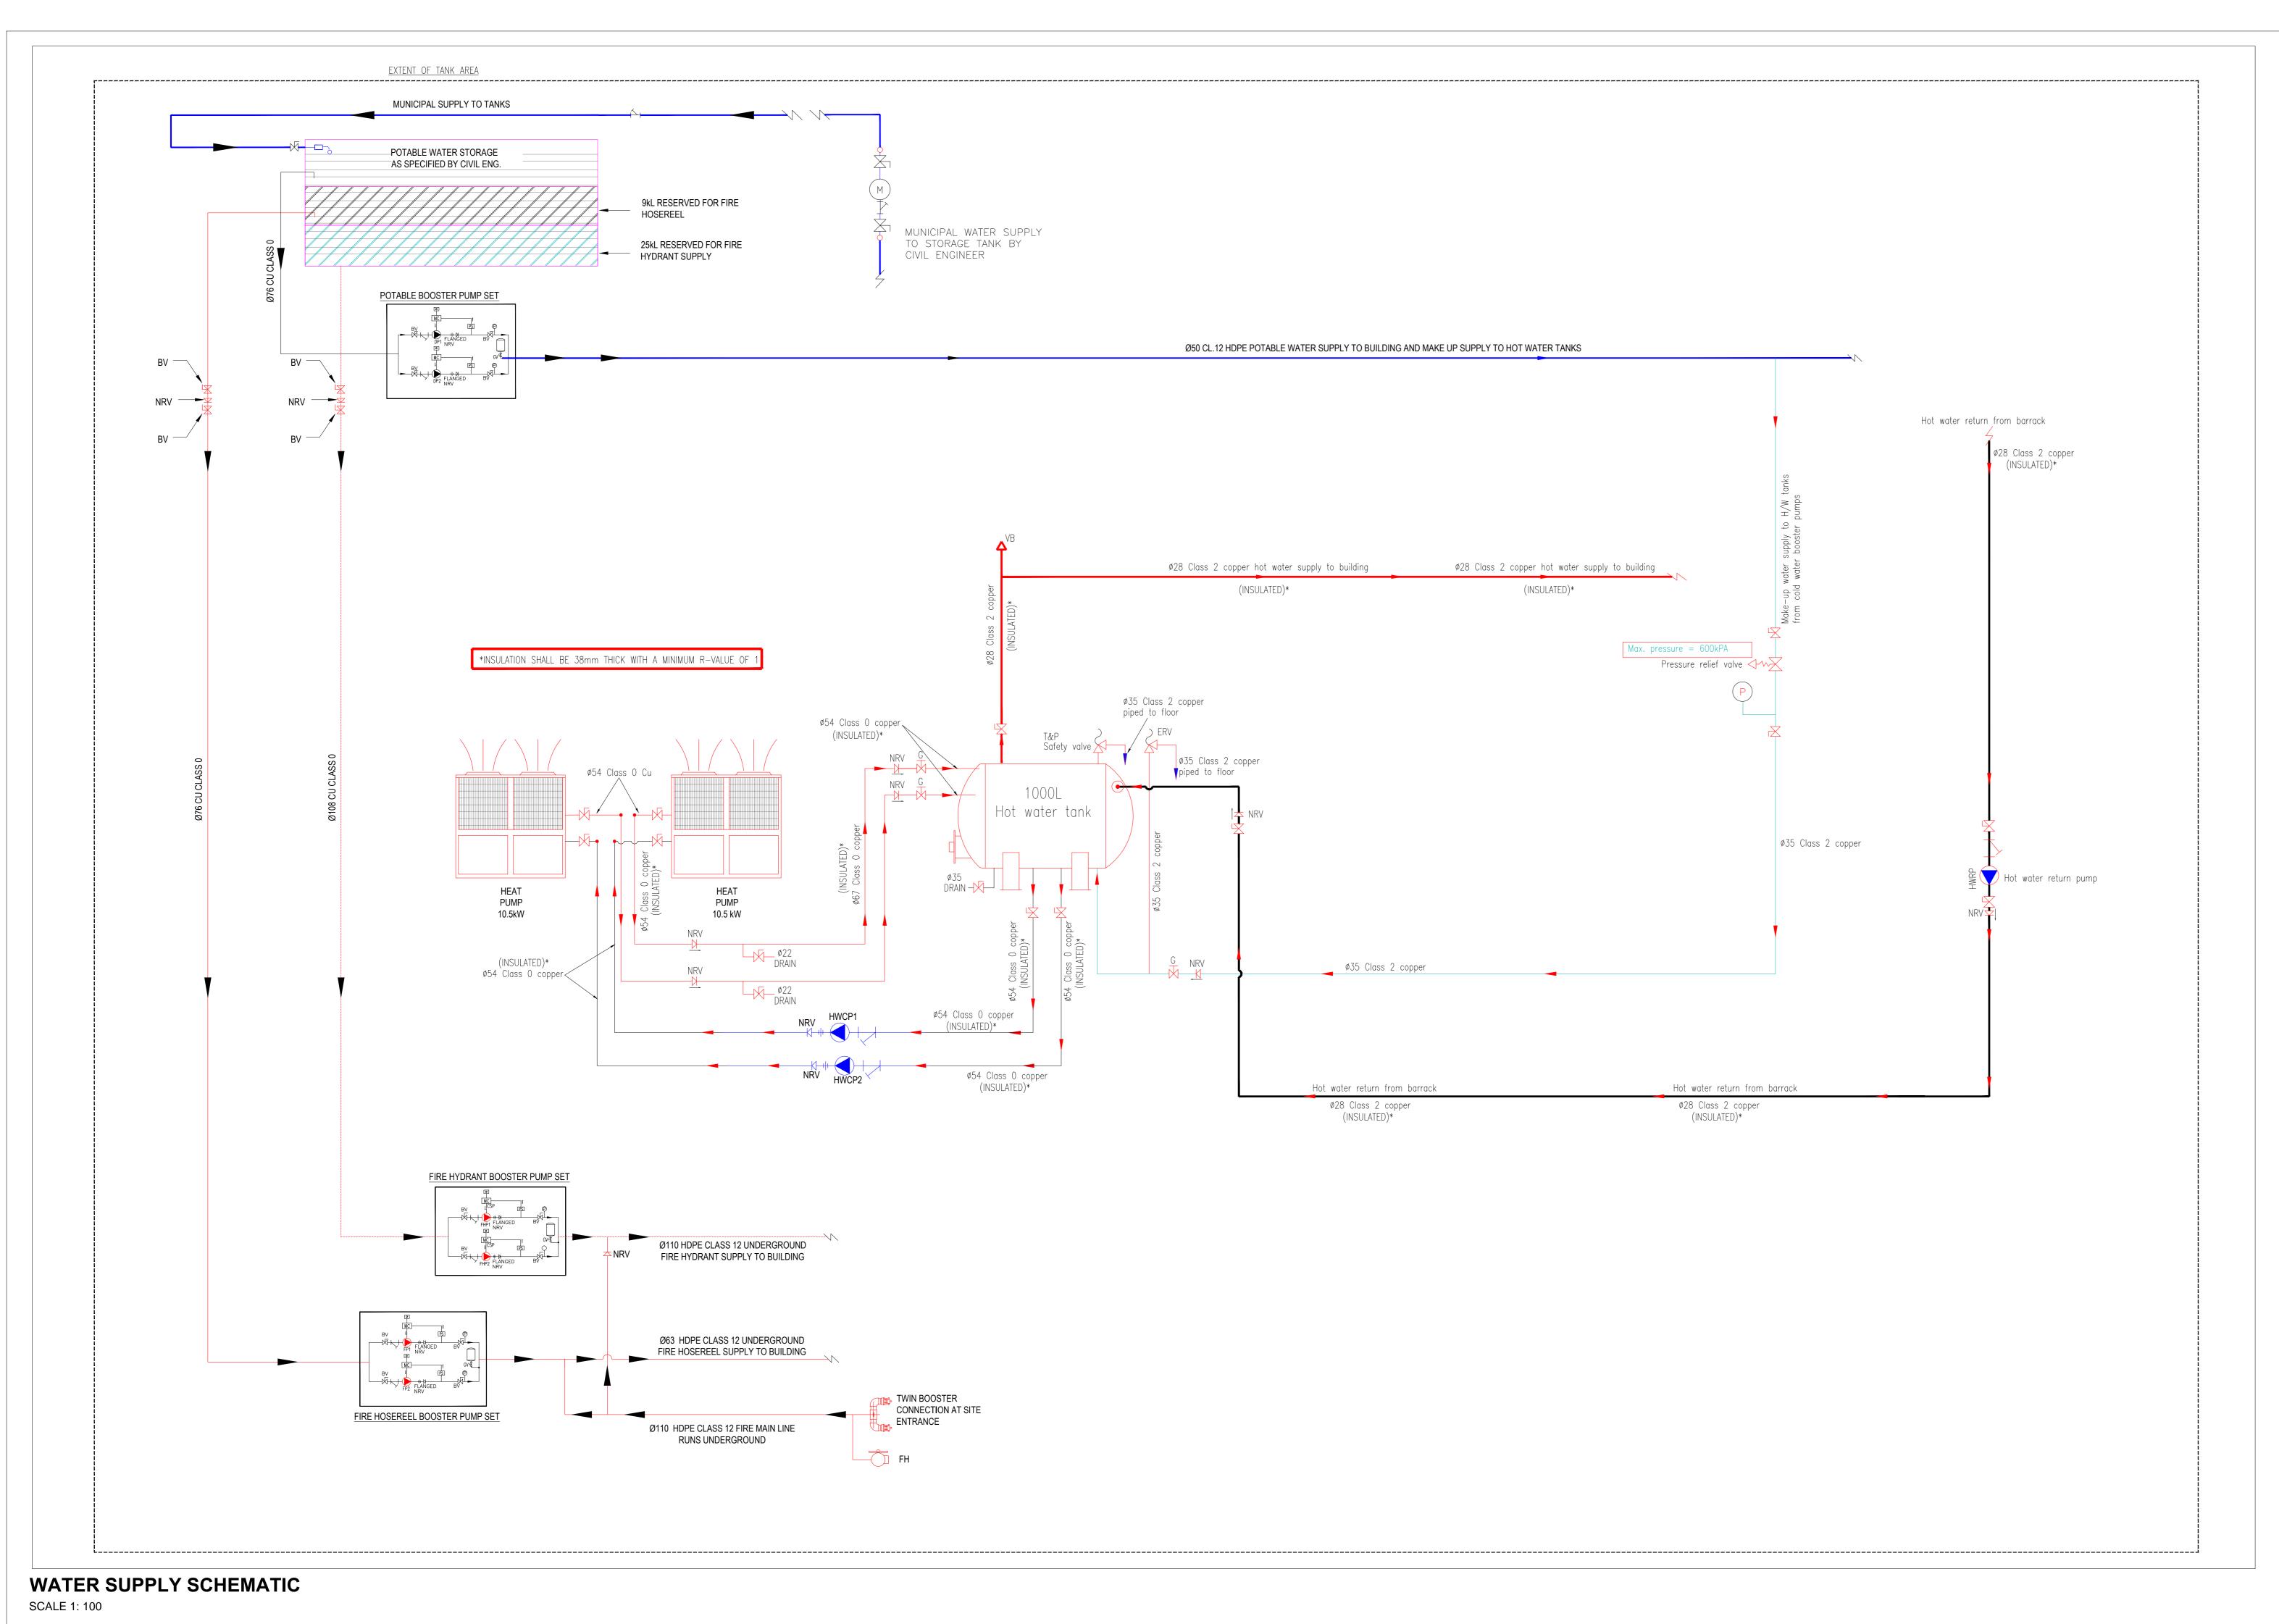

Note: Metallic pipe to be used above ground

Water supply, to building after water meter-

TYPICAL MUNICIPAL WATER METER DETAIL

(Refer to plan layout for size)

SCALE 1:50

Ball valve 🔓

for municipal water meter connection

Bulk Municipal water meter

(Refer to plan layout for size)

(Refer to plan layout for water meter size)

Incoming municipal water supply, <u>before</u>
water meter (Refer to plan layout for size)

DESCRIPTION SPECIFICATION Valve thread to match pipe G-GATE VALVE Valve thread to match pipe BV-BALL VALVE Swing type non-return valve. Valve NON RETURN VALVE thread to match pipe thread PRESSURE GAUGE Union thread to match pipe UNION POTABLE WATER PUMPS, Refer to Pump Spec. DP1&2 VARIABLE SPEED FIRE HOSE REEL PUMPS, Refer to Pump Spec. FP1&2 CONSTANT SPEED Table FIRE HYDRANT BOOSTER Refer to Pump Spec. FHP1&2 PUMPS, CONSTANT SPEED Table 0-1000kPa range pressure PRESSURE SWITCH EXPANSION VESSEL SAFETY VALVE EXPANSION RELIEF ERV VALVE VRV VACUUM RELIEF VALVE PRESSURE RELIEF VALVE STRAINER WATER METER PRESSURE SENSOR MOTOR CONTROL HIGH LEVEL P.C PUMP CUT OUT

SYSTEM 1				
HOT WATER STORAGE TANK	1-OFF 1000L VERTICAL TANK			
	- REFER TO STORAGE TANK GENERAL SPECIFICATION BELOW			
HOT WATER CIRCULATING	-2 OFF 2A/0.3kW, HOT WATER CIRCULATING PUMP @ 0.7l/s@5m HEAD			
PUMP. (HWRP)	- CONTRACTOR TO OFFER PUMP TO MATCH HEAT PUMP			
HOT WATER RETURN	-1 OFF 2A/0.3kW, HOT WATER RETURN PUMP @ 11/s@5m HEAD			
PUMP. (HWRP)				
HEAT PUMP	- 2 - OFF 10.5kW (OUTPUT) HEAT PUMPS; 220volt / 1 Phase			
	- HP TEMPERATURE SENSOR TO BE SUPPLIED WITH HEAT PUMP AND INSTALLED IN TANK			

SYSTEM 2				
HOT WATER STORAGE TANK	1-OFF 1000L VERTICAL TANK			
	- REFER TO STORAGE TANK GENERAL SPECIFICATION BELOW			
HOT WATER CIRCULATING	-2 OFF 2A/0.3kW, HOT WATER CIRCULATING PUMP @ 0.71/s@5m HEAD			
PUMP. (HWRP)	- CONTRACTOR TO OFFER PUMP TO MATCH HEAT PUMP			
HOT WATER RETURN	-1 OFF 2A/0.3kW, HOT WATER RETURN PUMP @ 11/s@5m HEAD			
PUMP. (HWRP)				
HEAT PUMP	- 2 - OFF 10.5kW (OUTPUT) HEAT PUMPS; 220volt / 1 Phase			
	- HP TEMPERATURE SENSOR TO BE SUPPLIED WITH HEAT PUMP AND INSTALLED IN TANK			

STORAGE TANK GENERAL SPECIFICATION.				
VESSEL SPECIFICATION				
SHELL MATERIAL	6mm MILD STEEL			
WELDING SPECIFICATION				
NDT	PRESSURE TESTING			
CORROSION PROTECTION				
PRIMER	OPTIGUARD PRIMER @ 100µ DFT			
INTERNAL TOP COAT	OPTI GLASS FLAKE @ 250µ DFT			
EXTERNAL COATING	2 COATS RED OXIDE PRIMER			
INSULATION				
INSULATION FILLER	GLASS OR MINERAL WOOL 80kg/m3			
CLADDING	0.8mm GALVANIZED MILD STEEL			
FITTINGS & INSTRUMENTATION				
TP/SAFETY VALVE	3/4" KWIKOT 600kPA			
PRESSURE GAUGE	Ø100mm WIKA, 0 - 1000kPa			
THERMOMETER	Ø100mm WIKA, 0 - 120°C			
SACRIFICIAL MODE	MAGNESIUM SEAL ROD			

PUMP SPECIFICATIONS 1. Cold Water Booster Pump Set: VERTICAL MULTI-STAGE (Ground): Domestic - 1.6l/s each (3.2l/s accumulated total) @ 35m Head; VSD + 100 litre pressure tank+ thermal overload protection, run dry protection, and auto lead/lag flip-flop. 2. Fire Booster Pump (Ground): 2.21/s @ 40m Head constant speed + pressure tank+ thermal overload protection, run dry protection, and auto lead/lag flip-flop. 3.Fire Hydrant Booster Pump: 22l/s each @ 40m Head constant speed + pressure tank+ thermal overload protection, run dry protection and duty/stand-by system. 4. Pumps shall be GRUNDFOSS, WILO OR KSB vertical make with integrated controls. 5. Each pump shall include (2x) ball valves, (1x) Non-return valves, (1x) Strainers, (1x) Pressure gauges. Each pump set shall be provided complete with include; Pressure sensor, motor control panel, Pressure tank, Gate valve, and common galvanized steel base plate. 6. Allow 12-month guarantee and maintenance

General Notes:

1. Any discrepancies or unclear information must immediately be reported to the Mechanical Engineer prior to any commencement of work. MKA will not be held responsible for any remedial work if above procedure is not adhered to. Onus is on the sub-contractor to ensure installation is completed to the Mechanical Engineers specification.
 Do not scale this drawing.

TO DISCHARGE TO EXTERIOR WHERE SENSOR CABLE VISIBLE STRAINER
 ↓ CONTROLLER LOCATED

Ø22 COPPER

Ø22 COPPER C/W SUPPLY

BALL VALVE

STRAINER

Ø22 COPPER C/W SUPPLY

Ø22 COPPER H/W SUPPLY

-ALL WORKS TO BE CARRIED OUT BY MUNICIPALITY

-ALL WATER SUPPLY PIPES CAST IN THE SLAB TO BE

-BALL-O-STOP STOPCOCKS/ANGLE VALVES SHALL BE

-ISOLATING VALVES SHALL BE PROVIDED WITHIN SERVICE

-ALL PIPING TO AND FROM GEYSER WITHIN A LENGTH OF

-ALL HOT WATER SUPPLY AND RETURN PIPING SHALL HAVE

-ALL GEYSERS SHALL HAVE INSULATION WITH A MINIMUM

-ALL PLUMBING MATERIAL, VALVES, TAPS TO BE JASWIC

-ALL PLUMBING INSTALLATION WORK TO COMPLY WITH ETHEKWINI WATER SUPPLY BY-LAWS, SANS 10252-1, SANS 10252-2, SANS 10254 AND SANS 10400.

-PIPING ARRANGEMENT FOR WATER METERS TO BE

AS PER MUNICIPALITY REQUIREMENTS

-ALL PLUMBING COMPONENTS ARE TO BE OF AN APPROVED TYPE AND LISTED ON THE JASWIC SCHEDULE OF APPROVED

INSULATION WITH A MINIMUM R VALUE=1m2.K/W

PROVIDED AT EACH SANITARY WARE CONNECTION

SHAFT OF EACH APARTMENT

ONE METER TO BE COPPER

R VALUE=2m2.K/W

WATER COMPONENTS.

TYPICAL GEYSER AND HEAT PUMP DETAIL

Ø22 Cu

EXPANSION RELIEF VALVE

BV 🚚

STAGE 4 APPROVAL

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Port Shepstone: 19 Tradewinds, Marine Drive, Shelly Beach
tel: 039 682 2447 fax: 039 682 2446 email:

ARCHITECTS G ISSUED FOR STAGE 4 APPROVAL MK 06/11/2024 ISSUED FOR COUNCIL SUBMISSION ISSUED FOR STAGE 3 ISSUED FOR STAGE 3 ISSUED FOR STAGE 3

09.10.2024

FAX: 031-536 8276

M693/WS/02 G

OM 09/10/2024 OM 31/07/2024 OM 05/07/2024 OM 02/07/2024 OM 23/04/2024 ISSUED FOR STAGE 3 ISSUED FOR STAGE 3 DESCRIPTION BY DATE REVISION CONSULTING MECHANICAL ENGINEERS:

ARTEK 4 ARCHITECTS (KZN) CC

Checked by Professional Consultant

MAHESH KHOOSAL PR. NO. 930282

Durban: 46 Lena Ahrens Road, Glenwood, Durban 4000

MAHESH KHOOSAL & ASSOCIATES Mechanical Consulting Engineers Mechanical Consulting Engineers

PROJECT :

NEW NTSHINGWE SATELLITE POLICE

STATION Portion 481 of the Farm Makathini

Flats No 16533 Access road P441, Ntshongwe, uMhlabuyalingana Local Municipality

for the South African Police Services

DRAWING TITLE :

PRINCIPAL: MK

COLD & HOT WATER SUPPLY SCHEMATIC DESIGNED : AK SCALE : 1:100 PROJ. No. M693 26/09/23 DRAWN: , CHECKED : AK DRG. No.:

