






public works

Construction Drawing for Msinga High School - Block A: Plan;Section and Elevations

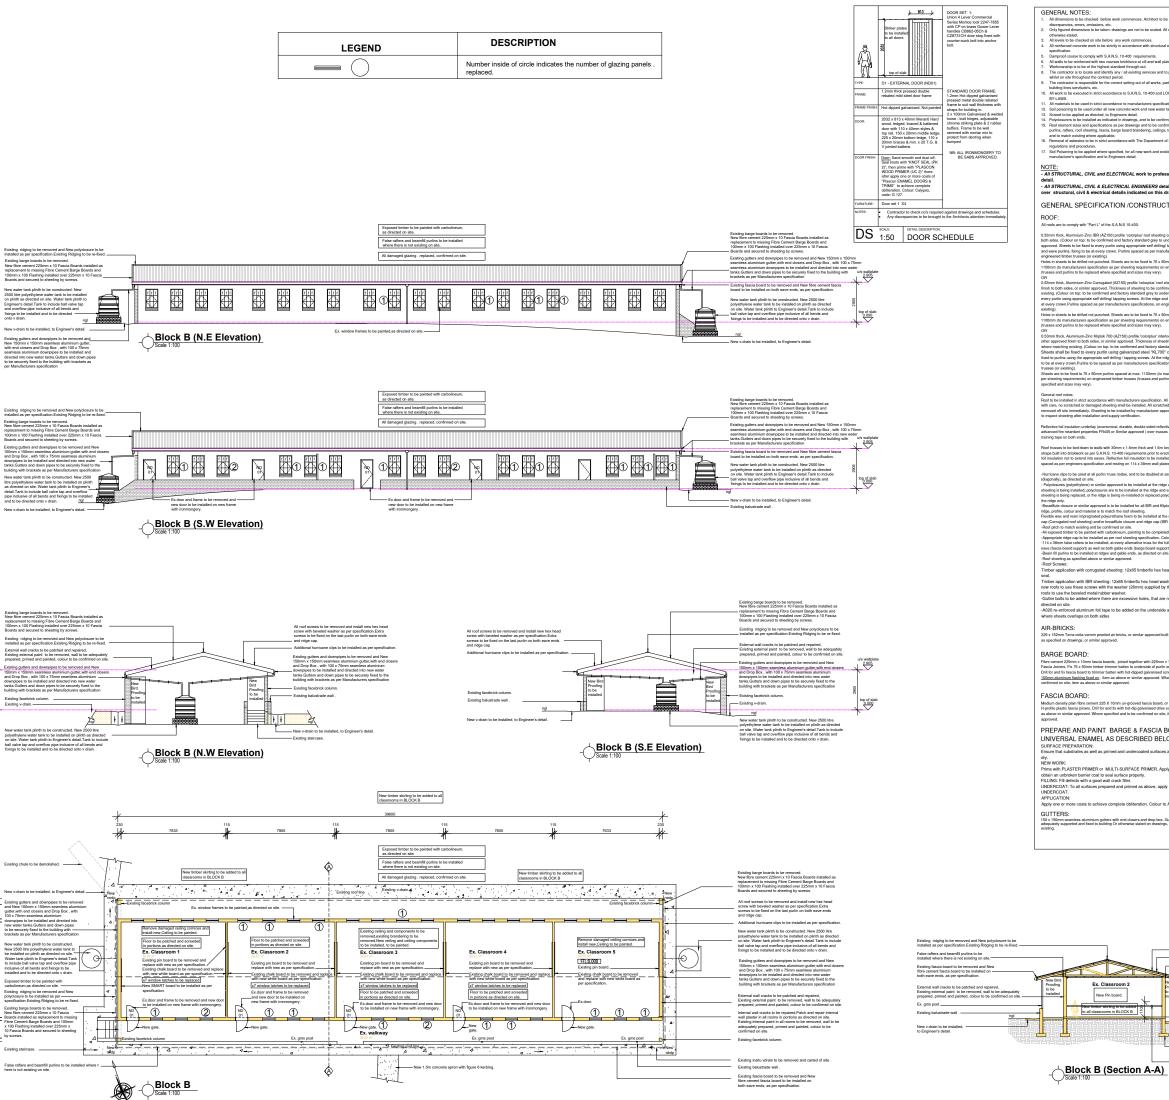

NOTE:
- All STRUCTURAL, CIVIL and ELECTRICAL work to professi

uerani.
- All STRUCTURAL, CIVIL & ELECTRICAL ENGINEERS details to take preferen over structural, civil & electrical details indicated on this drawing.

GENERAL SPECIFICATION /CONSTRUCTION NOTES:

BARGE BOARD:

FASCIA BOARD:

PREPARE AND PAINT BARGE & FASCIA BOARDS WITH UNIVERSAL ENAMEL AS DESCRIBED BELOW:

CEILING TRAP DOORS:

MASONRY WALL: INTERNAL AND EXTERNAL (PLASTER

FLASHING / WATERPROOFING:

GLAZING PANELS:

SKIRTING:

BRICK WORK:

CHALK BOARDS REPLACED WITH WHITE BOARDS:

PINING BOARD:


All information is to be confirmed on site and directed by th responsible individual, items as above or similar approved, and to match existing where applicable. Any discrepancies be brought to the consultants attention prior to the commencement of any work.



School - Block B: Plan; Section and Drown: T.Singh

KZN Department of Public Works Stamp and Signature

DOPW Drawing No:

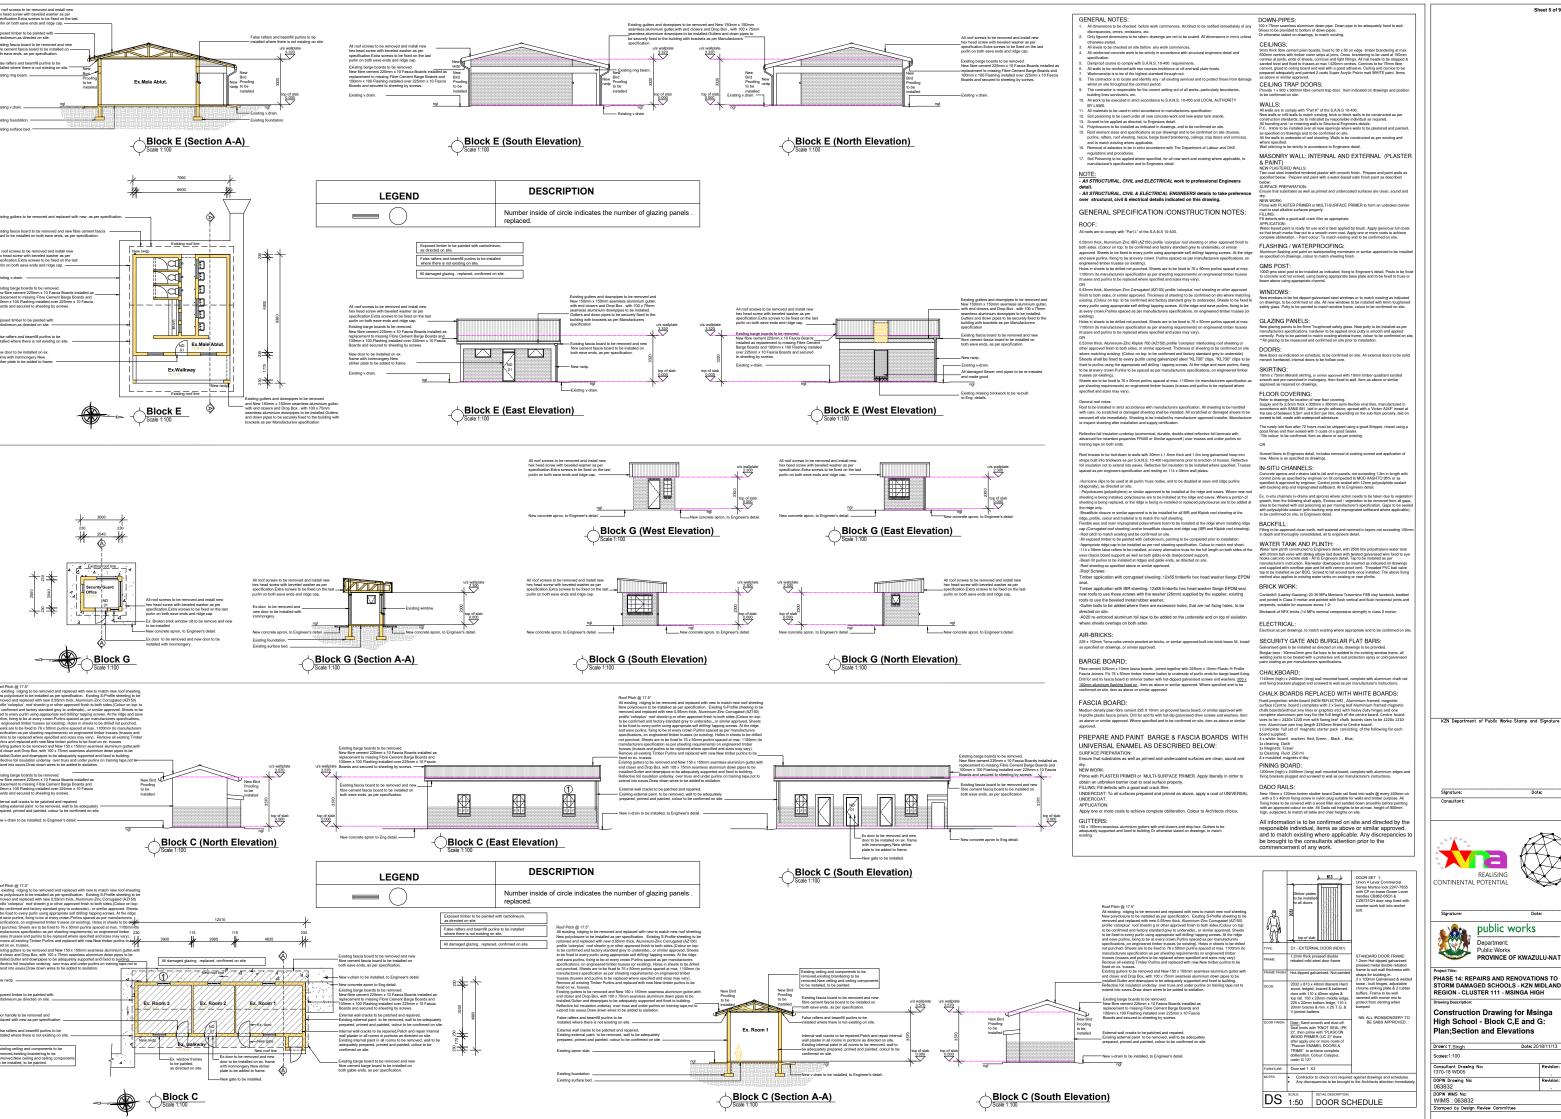







PHASE 14: REPAIRS AND RENOVATIONS TO STORM DAMAGED SCHOOLS - KZN MIDLANDS REGION - CLUSTER 111 - MSINGA HIGH

Construction Drawing for Msinga High School - Block C,E and G: Plan;Section and Elevations






public works


PHASE 14: REPAIRS AND RENOVATIONS TO STORM DAMAGED SCHOOLS - KZN MIDLANDS REGION - CLUSTER 111 - MSINGA HIGH

Construction Drawing for Msinga High School - Block D: Plan;Section and Elevations

DOPW Drawing No:

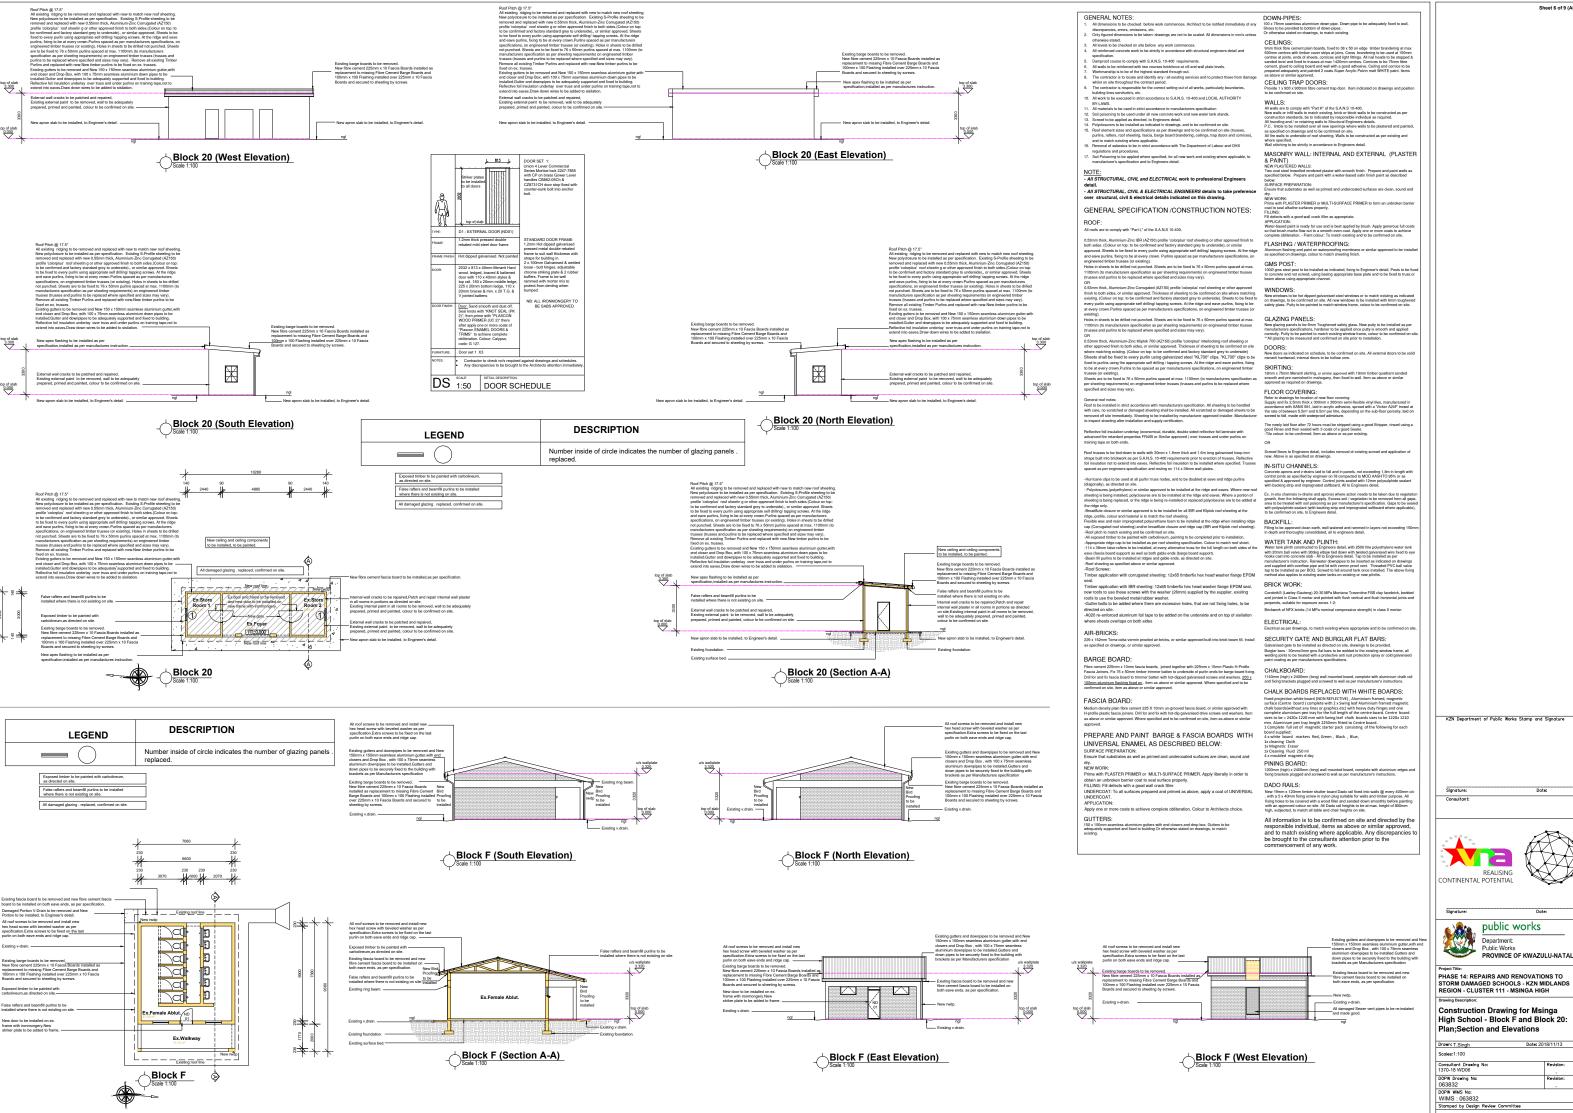

KZN Department of Public Works Stamp and Signature

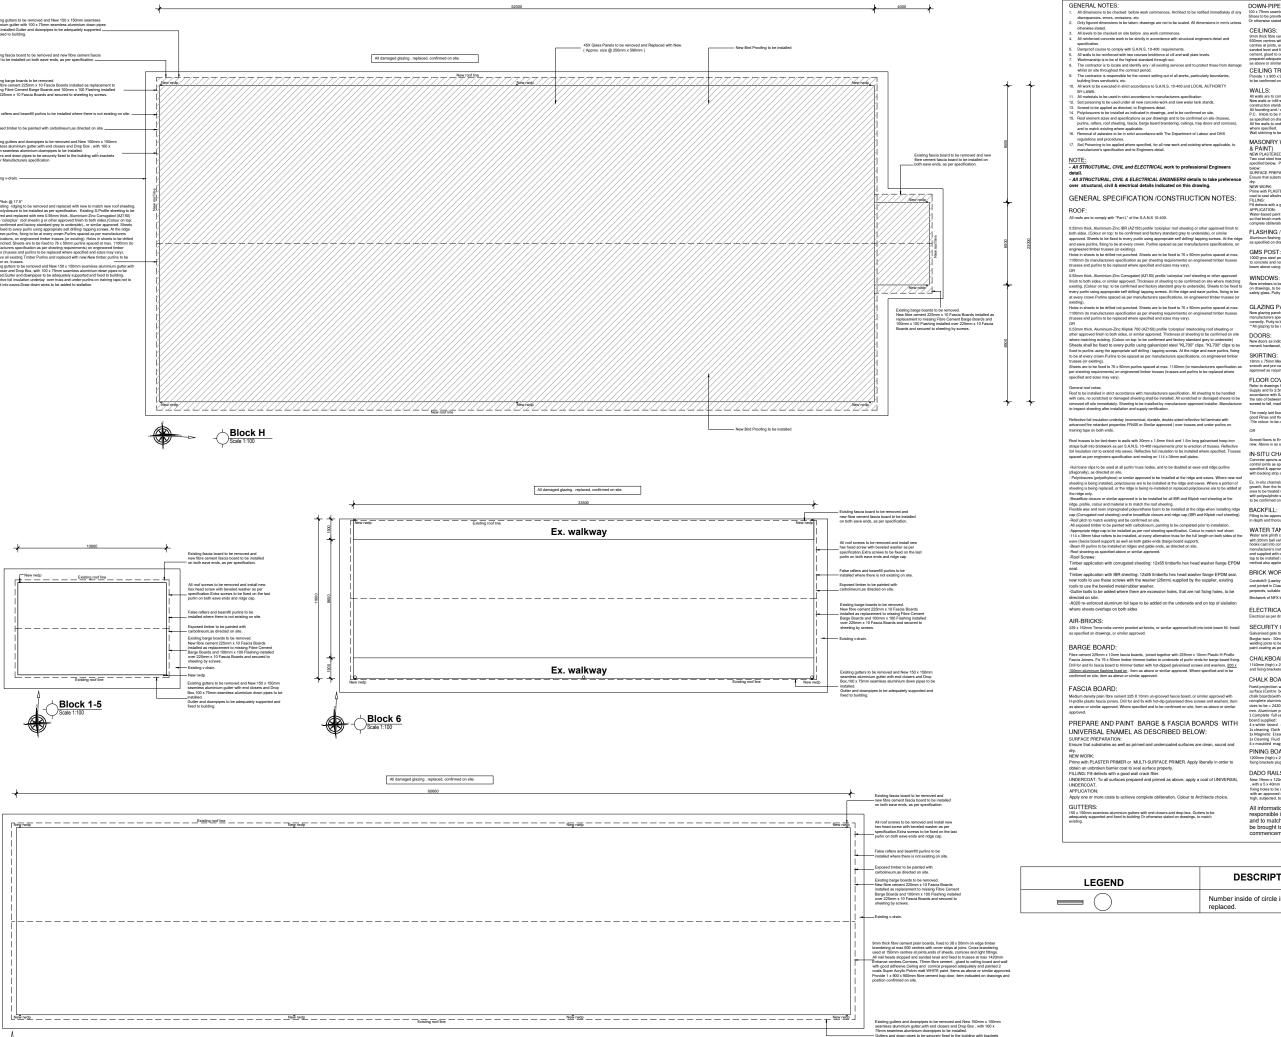

Block 7

DOWN-PIPES:

coordance to S.A.N.S. 10-400 and LOCAL AUTHORITY

- All STRUCTURAL, CIVIL & ELECTRICAL ENGINEERS details to take preference over structural, civil & electrical details indicated on this drawing.

CEILINGS:

CEILING TRAP DOORS: Provide 1 x 900 x 900mm fibre cement to be confirmed on site.

MASONRY WALL: INTERNAL AND EXTERNAL (PLASTER

FILLING: Fill defects with a good wall crack filler as appropriate APPLICATION: Water-based paint is ready for use and is best applie so that brush marks flow out to a smooth even coat. complete obliteration. - Paint colour: To match existin

FLASHING / WATERPROOFING:

GLAZING PANELS:

SKIRTING:

FLOOR COVERING:

IN-SITU CHANNELS: Concrete aprors and v-drains laid to fall a control joints as specified by engineer on specified & approved by engineer. Confer with backing strip and impregnated softba

BRICK WORK:

ELECTRICAL

SECURITY GATE AND BURGLAR FLAT BARS:

CHALKBOARD:

CHALK BOARDS REPLACED WITH WHITE BOARDS:

1 Complete full set of magnetic starter pack consisting board supplied: 4 x white board markers Red, Green , Black , Blue, 1x cleaning Cloth 1x Magnetic Eraser 1x Cleaning Fluid 250 ml 4 x moulded magnets d day

PINING BOARD:

DADO RAILS:

All information is to be confirmed on site and directed by th responsible individual, items as above or similar approved, and to match existing where applicable. Any discrepancies be brought to the consultants attention prior to the commencement of any work.






public works

PROVINCE OF KWAZULU-NATA

PHASE 14: REPAIRS AND RENOVATIONS TO STORM DAMAGED SCHOOLS - KZN MIDLANDS REGION - CLUSTER 111 - MSINGA HIGH Construction Drawings for Msinga

Drawn: T.Singh Scales:1:100 DOPW Drawing No: 063832 DOPW WMS No: WIMS: 063832 Stamped by Design Review

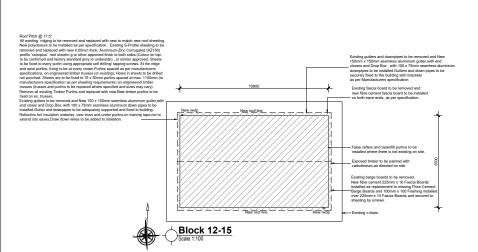

Block 21
| Scale 1:100



Existing rod line Existing barge boards to be removed.

New fibre cement 225mm x 10 Fascia Boainstalled as replacement to missing Fibre 0
Barge Boards and 100mm x 100 Flashing
over 225mm x 10 Fascia Boards and secu
sheeting by screws. Existing foot late:

21X Glass Panels to be removed and Replaced with New. (Size to be determined on Site)

New rwdp Existing roof line Exposed timber to be painted with carbolineum,as directed on site. Existing roof line New rwdp Block 11 Scale 1:100

GENERAL NOTES:

All minrovad concrete work to be strictly in accordance with structural engineers detail and specification.

All seals to be minrovade and accordance with structural engineers detail and expectation.

All seals to be minrovade with the courses brickhore at all and real plate levels.

Who when which p is to be the highest standard through out.

The contractor is to locate and deterify any if all existing services and to protect these from damage whilst on sets throughout the contest position.

The contractor is to locate and deterify any if all existing services and to protect these from damage whilst on sets throughout the contest position of all works, perstockedly boundaries, building lims servicularly boundaries.

All when the service serviced in strict accordance to S.A.N.S. 10-400 and L.COAL AUTHORITY BY ALMS.

All materials to be used in strict accordance to instandarchers specification.

All materials in the used in strict accordance to instandarchers specification.

All materials in the used in strict accordance to instandarchers specification.

By all materials to be used in strict accordance to instandarchers specification.

By all materials to be used in strict accordance to instandarchers specification.

By all materials to be used in strict accordance and the secondaries of the secondaries and specifications as per deserged and to be confirmed on site.

By all the secondaries and specifications as per deserged and to be confirmed on site (trauses, particular and structural contractors).

By all the secondaries are deserved and the secondaries of the secondaries and t

NOTE:
- All STRUCTURAL, CIVIL and ELECTRICAL work to professional Engineers

detail. - All STRUCTURAL, CIVIL & ELECTRICAL ENGINEERS details to take preference over structural, civil & electrical details indicated on this drawing.

GENERAL SPECIFICATION /CONSTRUCTION NOTES:

ROOF:

OR

OSmm thick, Aluminium-Zinc Corrugated (AZ150) profile 'tolopiagh' nor disheating or other approved finish to both sides, or similar approved. Thickness of alterating to be confirmed on size where matching sixting, (Colour on both sides, or similar approved. Thickness of alterating to be confirmed and sixting sixting, (Colour on both costs) andeauting to be confirmed and sixting sixting, (Colour on both costs) and sixting s

OS-mm bits, Almanum-Zer-Rigick 70(5) porfile tolorphical intendeding roof sheeting or other approved frieth to both sides, or similar approved. This changes of sheeting or other approved frieth to both sides, or similar approved. This changes of sheeting to be confirmed and sides to except the property of the confirmed and sides to the side of the side of the sides of the

aganced as per engineers appoilications and resting on 114.9 30mm wall plates.

NETTU CHA

**Commission Service of the Commission Service of the

AIR-BRICKS:

Entrouched Selfmen x 10mm lascia boards, joined together with 225mm x 10mm fascia boards, joined together with 225mm x 10mm fascia boards, 10mm fascia boards x 10mm fascia boards x 10mm fascia boards to frience batten with to 45pd galvairiade screws an 100mm aluminum fasching fixed on. Item as above or similar approved. Where specorifismed on all is, tile ma as above or similar approved. FASCIA BOARD:

PREPARE AND PAINT BARGE & FASCIA BOARDS WITH UNIVERSAL ENAMEL AS DESCRIBED BELOW:

oy.

NEW WORK:

NEW WORK:

Prime with PLASTER PRIMER or MILITISUIFFACE PRIMER. Apply liberally in order to obtain an unbrown barrier coat to seak surface property.

FILLING: Fill defects with a good wall crack filler.

UNDERCOAT: To all surfaces prepared and primed as above, apply a coat of UNIVERSAL UNDERCOAT.

Apply one or more coats to achieve complete obliteration. Colour to Architects choice.

GUTTERS:

DOWN-PIPES:

CEILINGS:

CEILING TRAP DOORS: Provide 1 x 900 x 900mm fibre cement to be confirmed on site.

WALLS:

P.C. Intols to be installed over all new openings where walls as specified on drawings and to be confirmed on site. All fire walls to underside of roof sheeting. Walls to be constru-where specified. Wall stitching to be strictly in accordance to Engineers detail.

MASONRY WALL: INTERNAL AND EXTERNAL (PLASTER & PAINT)

NEW PLASTERED WALLS:
Two cost steel rewelled rendered plaster with smooth finish. Prepare and paint walls as a specified broken, Prepare and paint walls as a specified broken, Prepare and paint with a water based satin finish paint as described of the prepared plant with a water based satin finish paint as described on the prepared plant with a water based satin finish paint as described on the prepared plant with a water based satin finish paint as described on the prepared plant with a water based satin finish paint as described on the prepared plant with a water based satin finish paint as described and the prepared plant with a water based satin finish paint as described and the prepared plant with the plant with the prepared plant with the plant with the prepared plant with the plant wit

s with a good wall crack filler as appropriate

GMS POST:

FLOOR COVERING:

IN-SITU CHANNELS:

WATER TANK AND PLINTH:

SECURITY GATE AND BURGLAR FLAT BARS:

CHALK BOARDS REPLACED WITH WHITE BOARDS:

sizes to be = 2420.12 um with viswing ried Trake book
mm. Aluminium pen tray length 2250mm fitted to Cent
mm. Aluminium pen tray length 2250mm fitted to Cent
board supplied:
At white board markers Red, Green , Black , Blue,
1x cleaning Cloth
1x Magnetic Fraser
1x Cleaning Fluid 250 ml
4 x moulded magnets d day

PINING BOARD

DADO RAILS:

All information is to be confirmed on site and directed by th responsible individual, items as above or similar approved, and to match existing where applicable. Any discrepancies be brought to the consultants attention prior to the commencement of any work.

KZN Department of Public Works Stamp and Signature





Department: PROVINCE OF KWAZULU-NATAL

PHASE 14: REPAIRS AND RENOVATIONS TO STORM DAMAGED SCHOOLS - KZN MIDLANDS REGION - CLUSTER 111 - MSINGA HIGH


Construction Drawings for Msinga High School - Block 8;10;11;12-15;20;21

Drawn: T.Singh Consultant Drawing No 1370-18 WD08 DOPW Drawing No:

063832

DOPW WIMS No:
WIMS : 063832

Stamped by Design Review Com

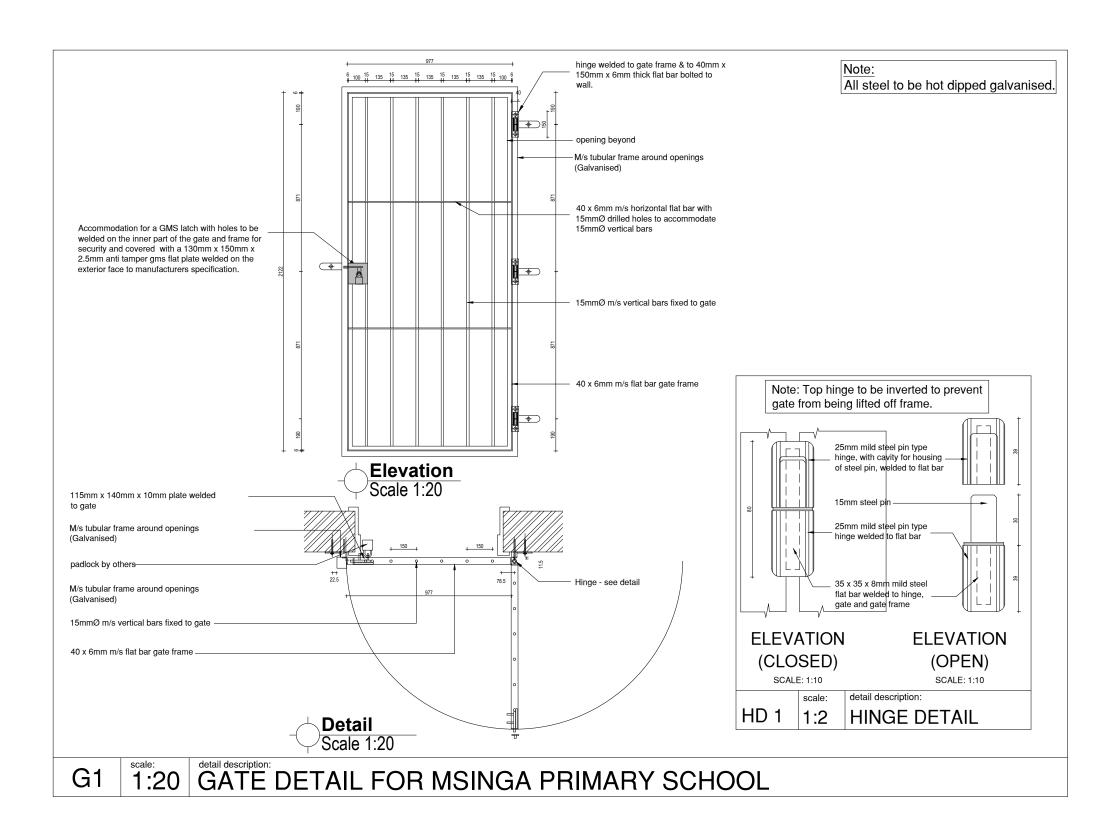

KZN Department of Public Works Stamp and Signature

Sheet 9 of 9 (A2)

Signature:

Date:

Consultant:



Signature:

public works

Department:
Public Works
PROVINCE OF KWAZULU-NATAL

ct Title:

PHASE 14: REPAIRS AND RENOVATIONS TO STORM DAMAGED SCHOOLS - KZN MIDLANDS REGION - CLUSTER 111 - MSINGA HIGH

Drawing Description:

GATE DETAIL

Drawn: Trishaan Singh	Date: 20 :	20/04/20
Checked By: Muazzam Khan	Date: 2020/06/22	
Scales: AS SHOWN		
Consultant Drawing No: 1370-18 WD09		Revision:
DODW CONTRACT N		5

0

DOPW WIMS No: WIMS: 063832

063832

Stamped by Design Review Committee

