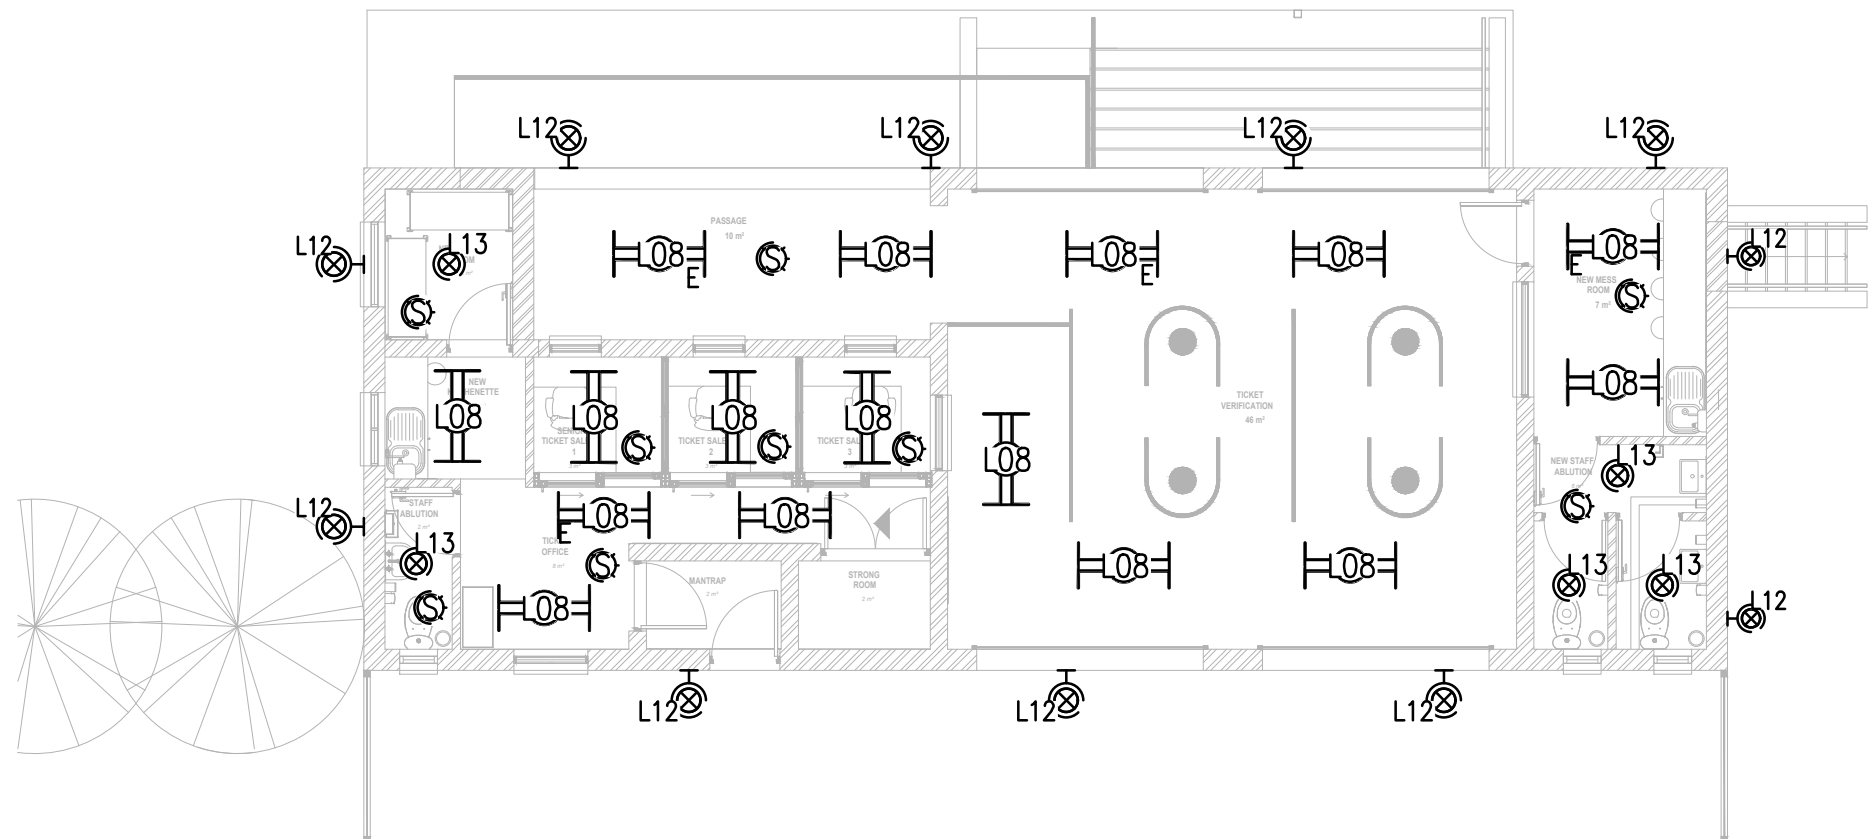
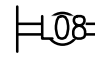
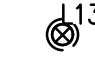
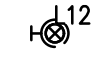

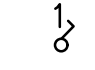
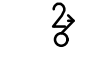
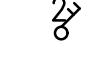

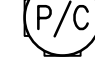




E



GROUND FLOOR PLAN – ZONE A TICKET OFFICE
LIGHTING LAYOUT
SCALE 1:100

LEGEND

-  TYPE L08: SURFACE MOUNTED FITTING, 43W LED LAMP WITH 0,8mm POWDER-COATED MILD / ROLLED STEEL LUMINAIRE BODY AND COVER, COLOUR WHITE. THE COVER SHALL BE ATTACHED TO THE MAIN BODY. ELECTRONIC BALLAST TO BE INTEGRAL TO LUMINAIRE. OUTPUT TO BE MIN. FITTINGS TO COMPLY AND BEAR SANS 60598 –2–3 SAFETY MARK THE LAMP HOLDERS TO BE IP65 RATING..
-  TYPE L13: SURFACE-MOUNTED LUMINAIRE WITH A DIE-CAST ALUMINIUM BASE AND TRIM RING AND A HIGH-IMPACT OPAL ACRYLIC DIFFUSER. BASE-MOUNTED CONTROL GEAR. BOTH THE BASE AND TRIM RING ARE TO BE POWDER COATED. SIZE: PLUS MINUS 280mm DIAMETER. OUTPUT TO BE 20W, 2000LM, 4000K AND CRI OF 80 PLUS. FITTINGS TO COMPLY WITH SANS 60508 CODES AND OR CE AND ROHS CERTIFICATION, WITH AN IP65 RATING FOR THE LAMP COMPARTMENT
-  TYPE L12: SURFACE MOUNTED LUMINAIRE, 18W LED WITH 2400LM, 4000K AND CRI OF 70 PLUS, FROM A DIE-CAST ALUMINIUM BODY AND HIGH-IMPACT ACRYLIC DIFFUSER. THE GEAR TRAY TO BE MADE FROM GALVANIZED AND PASSIVATED STEEL AND POWDER COATED. FITTINGS TO COMPLY WITH THE SANS 60598 CODES AND OR CE AND ROHS CERTIFICATION WITH AN IP65 RATING FOR THE LAMP COMPARTMENT.
-  OCCUPANCY SENSOR
-  16A 1GANG 1WAY LIGHT SWITCH
-  16A 1GANG 2WAY LIGHT SWITCH
-  16A 2GANG 2WAY LIGHT SWITCH
-  ELECTRICAL DISTRIBUTION BOX
-  PHOTO CELL
-  CIRCUIT NUMBER
-  DISTRIBUTION BOARD NUMBER

AMENDMENTS					CLIENT DETAIL		CONSULTANT DETAIL		PROJECT STATUS		DESIGNED	CONTRACT No.	LOCATION OF PROJECT
NR	DATE	APPROVED	DESCRIPTION	PAR	 PASSENGER RAIL AGENCY OF SOUTH AFRICA		 CONSULTANT DRAWING NUMBER: KB077_PRASA_EL_LL_201		<div><div><div></div>CONCEPT DRAWING</div><div><div></div>TENDER DRAWING</div><div><div></div>APPROVED CONSTRUCTION DRAWING</div><div><div></div>AS BUILT DRAWING</div></div> <div>PROJECT ENGINEER OF PRASA:</div> <div>NAME: _____ SIGNATURE _____</div> <div>Prof Reg No: _____ DATE _____</div> <div>INSPECTOR OF WORKS</div> <div>NAME: _____ SIGNATURE _____</div> <div>DATE _____</div>		NAME: P. THSBALALA Prof Reg No: _____ SIGNATURE _____ DATE _____	CONTRACT No. _____	CAPE TOWN TO STRAND - SUB CORRIDOR 1
											DRAWN		PROJECT No. KB077
											CHECKED		SHEET No. 1 OF 1
											AUTHORISED		PAPER SIZE A1
													SCALE AS INDICATED
													DATE: SEP 2022
													PRASA DRAWING NUMBER: KB077_PRASA_EL_LL_201