

DETAIL DESCRIPTION:

PLAN VIEW

DETAIL NO: | SCALE:

NOTES:

CONCRETE GRADE: Blinding 15MPa / 13mm

Main Structure

- 35MPa / 19mm Wall 35MPa / 19mm Floor slab
- 35MPa / 19mm 35MPa / 19mm Suspended slab 35MPa / 19mm Beams 35MPa / 19mm Columns
- Thrust blocks 15MPa / 19mm Incased pipes 35MPa / 19mm
- Mass concrete 15MPa / 19mm

CONCRETE FINISHES:

- Main Structure Base top
- Base sides Wall both sides Wall top
- Floor slab top F2
- F2 Beam soffit U3 Bean top Column sides F2
- Thrust blocks sides Thrust blocks top
- Incased pipe sides Incased pipe top

GENERAL NOTES:

- All exposed concrete edges to be chamfered 20mm x 20mm. Except if specified differently.
- Imported fill below main structure to be at least Grade G5 or equivalent.
- Supply and apply " Chryso Dem 10" or similar approved vegetable-based, biodegradable and non toxic release agent at rate of 30m² / liter as thinly as possible and as near as possible to time of concreting. Preferably sprayed onto steel shutters.
- Supply and spray "MasterKure 181" or similar approved non-degrading, liquid based on Pliolite Resin curing compound suitable for spray application to freshly poured concrete at and application rate of 6m² / liter as soon as the shutters have been stripped or as soon as floating has been finished on floor surfaces.
- Supply and apply "Master Protect 480" or similar approved non-toxic solvent free high build, protective epoxy resin coating applied to prepared concrete surface in two separate coats at an application rate of 5m² / liter per coat.

STEEL AND PIPE NOTES:

 All pipes and steelwork shall be fusion bonded epoxy coated to DFT 300 micron thick unless indicated otherwise or stainless steel items

Do not scale off drawing - ASK THE ENGINEER IF Any discrepancies between any drawings must be clarified before work is continued on site.



READ THIS DRAWING IN CONJUCTION WITH

Drawing Number Drawing Description 13-019-V-01-01-01 | Site Plan 13-019-V-01-02-02 | Sections & Details 13-019-V-01-02-03 | Elevations 3-019-V-01-02-04 Foundation, Roof & Electrical Plans 13-019-V-01-02-05 Pipe Schedule & Details

AMENDMENTS				
Rev.	Date	Description		

ECA CONSULTING VRYHEID OFFICE: 161 High Street | Vryheid | Kwa Zulu Natal | vryheid@ecaconsult.co.za Tel: +27 (0)34 983 2825 www.ecaconsult.co.za **OTHER OFFICES:** Company Reg.: 2004/019299/07 MBOMBELA | GAUTENG |

ISO Registered 9001:2015

Approved by Engineer: Name: J.W. Janse v Rensburg Designation: PrTechEng

Signature: Date: 4 Feb 2022 ECSA Reg.: 201070143

PIETERMARITZBURG |

DIHLABENG

LOCAL



Approved by Client: Signature:

Project:

CLARENS WTW

Drawing description:


INLET, DOSING CHAMBER AND BUILDING: SECTIONS


Date: Jan 2021 Drawn: M BOTHA Scale/s: AS SHOWN ¹ Rev.: Drawing number: 13-019-V-01-02-01


 All pipes and steelwork shall be fusion bonded epoxy coated to DFT 300 micron thick unless indicated otherwise or stainless steel items

STEEL AND PIPE NOTES

SEE DETAIL NO:

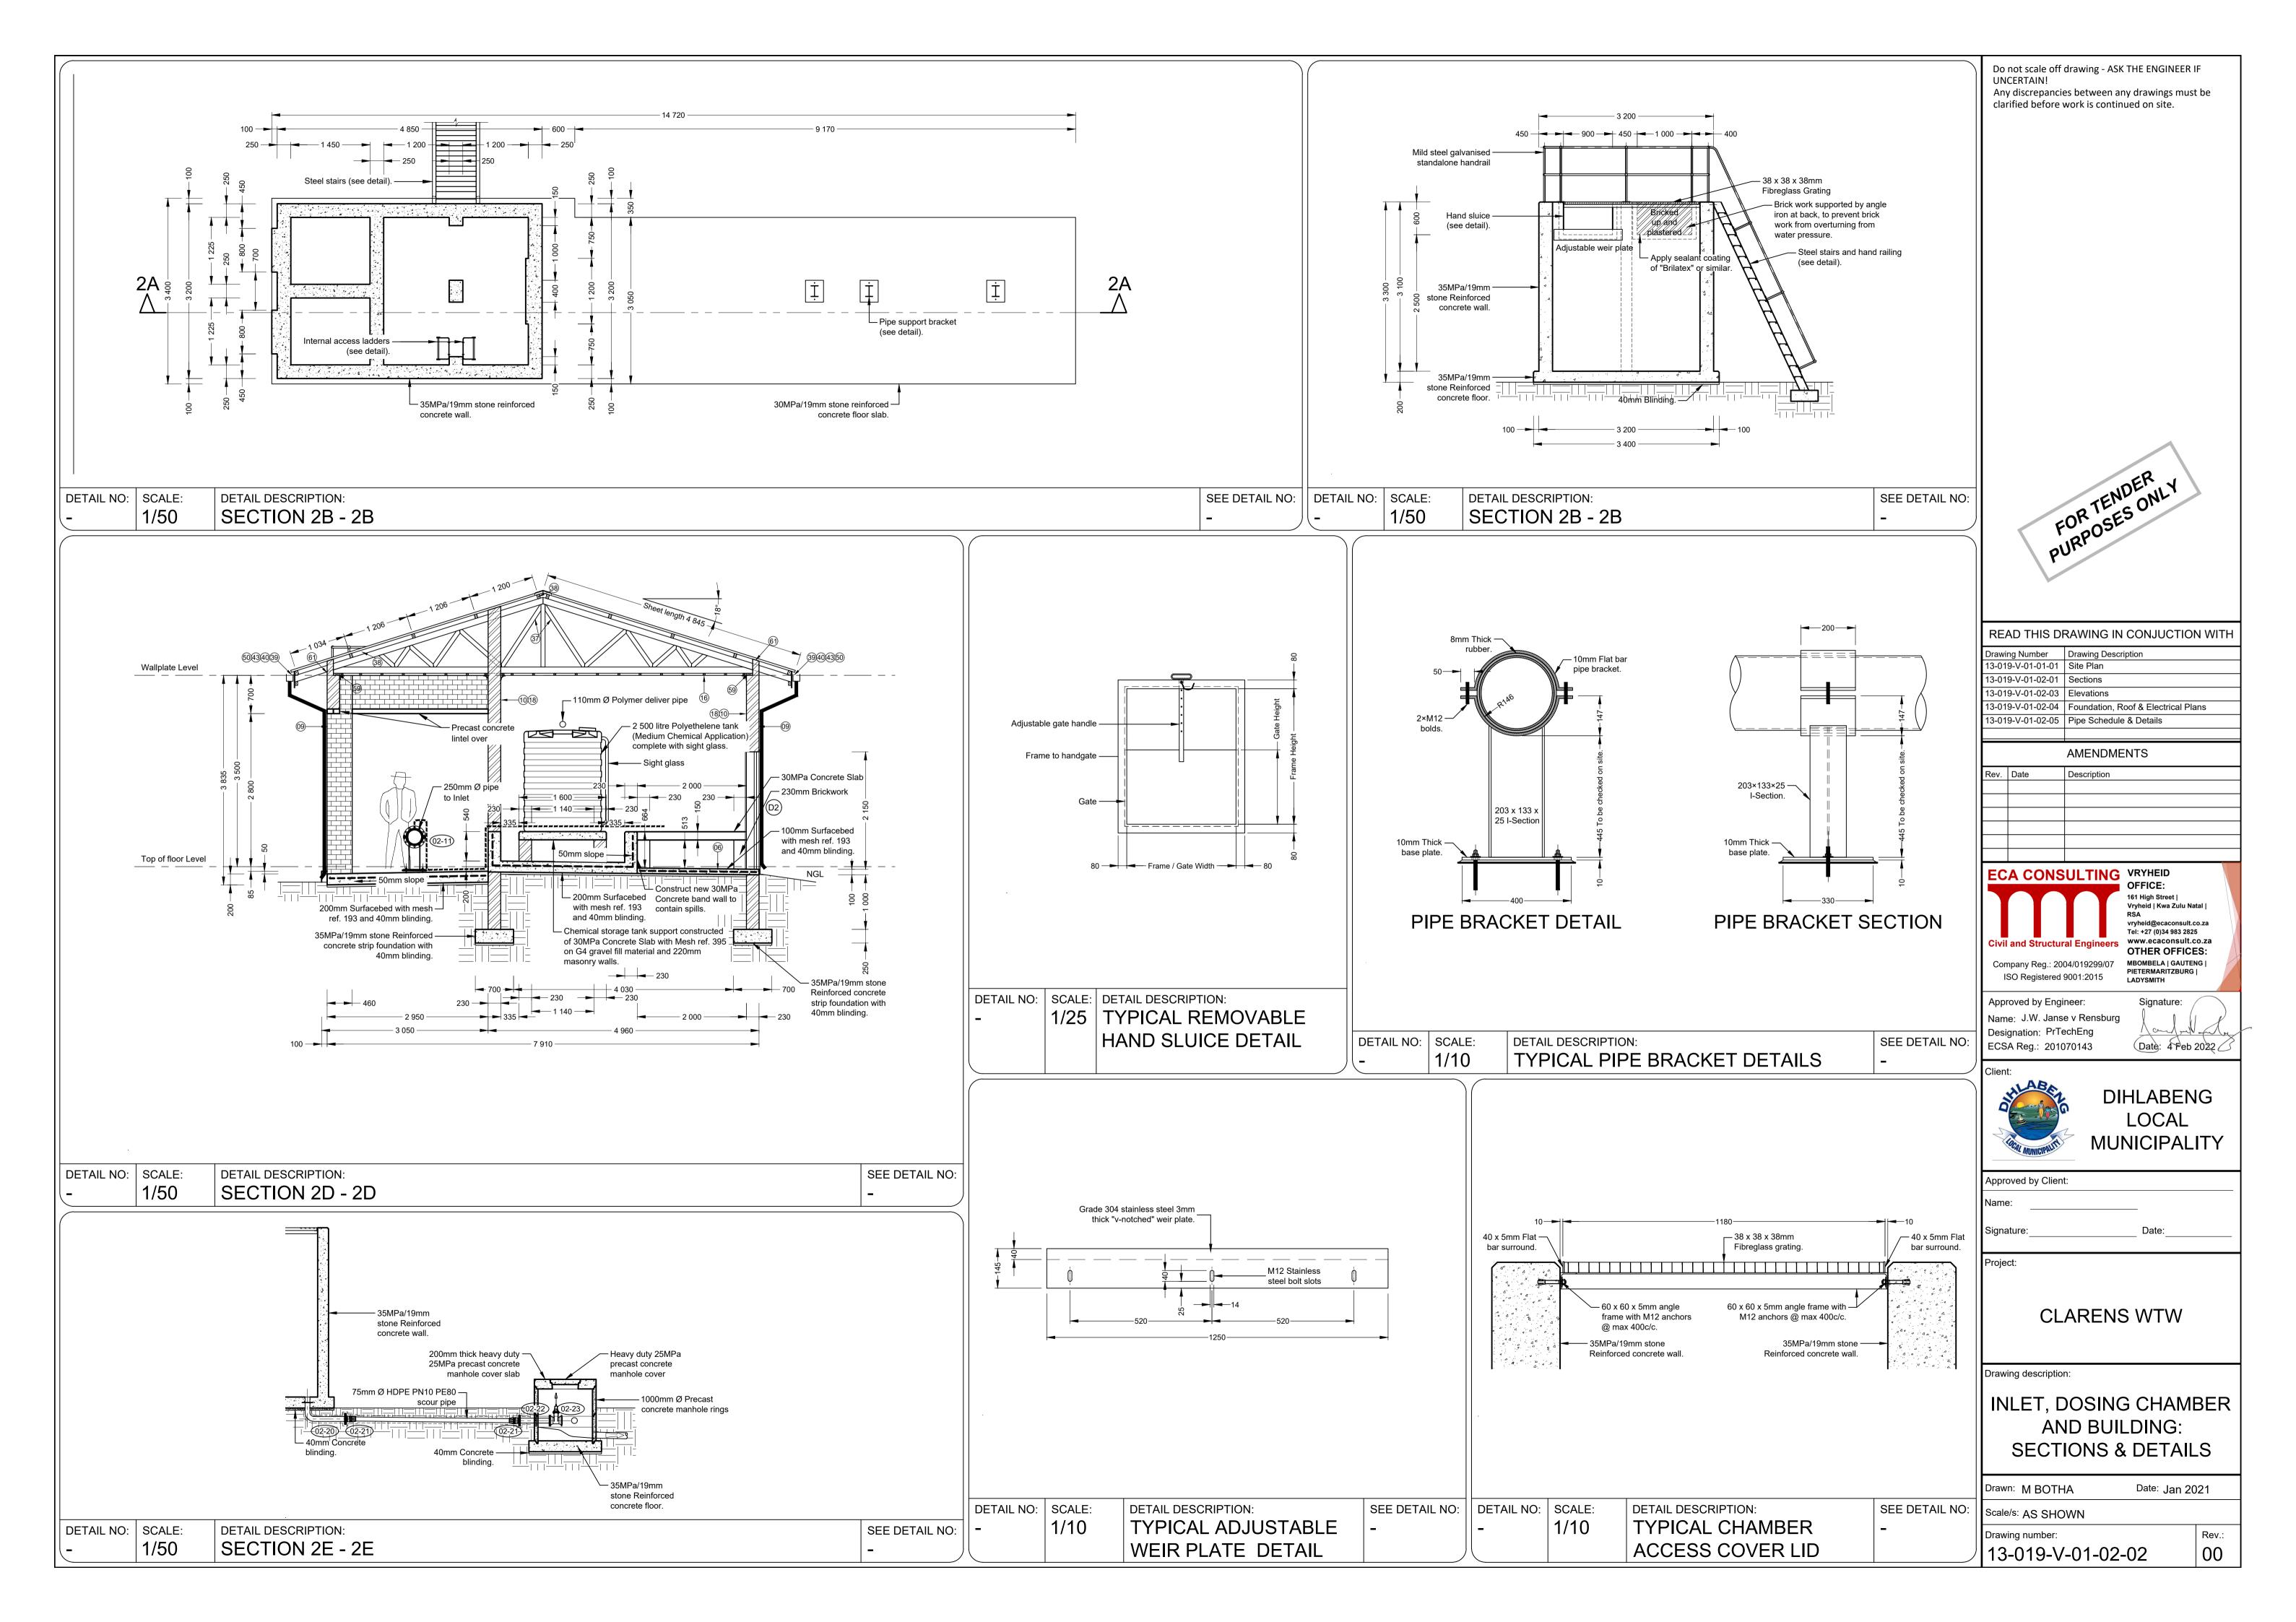

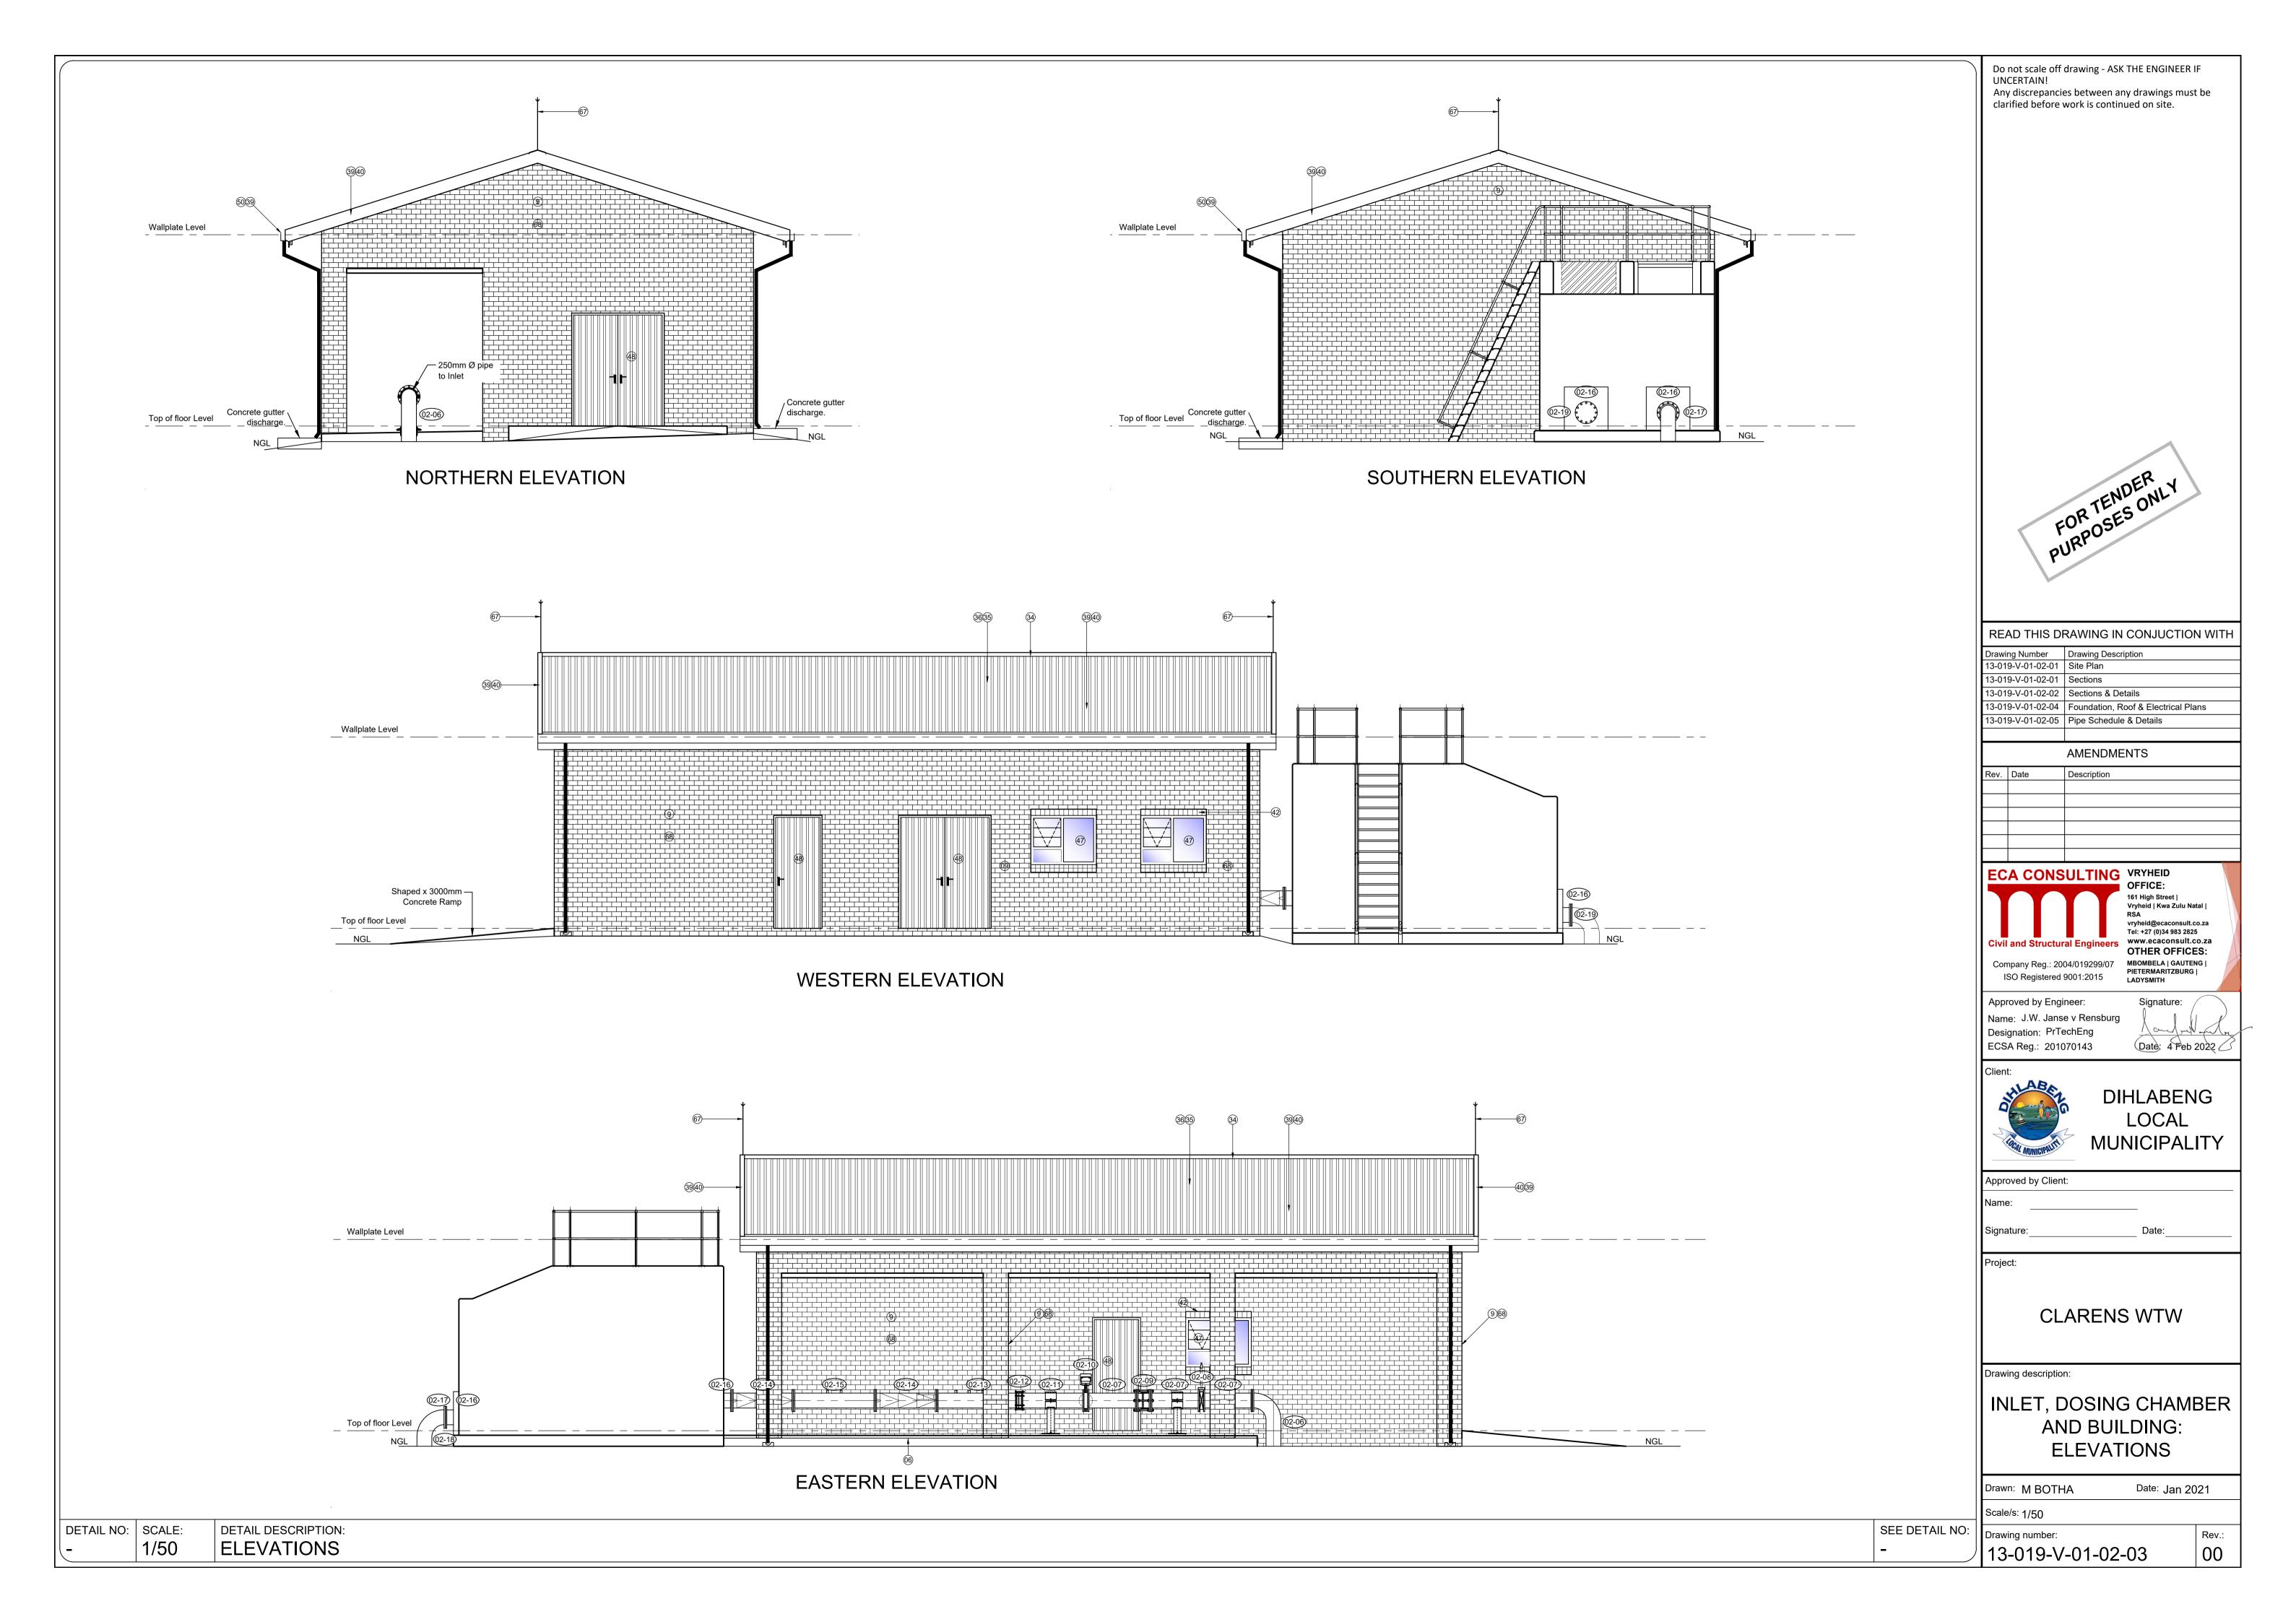

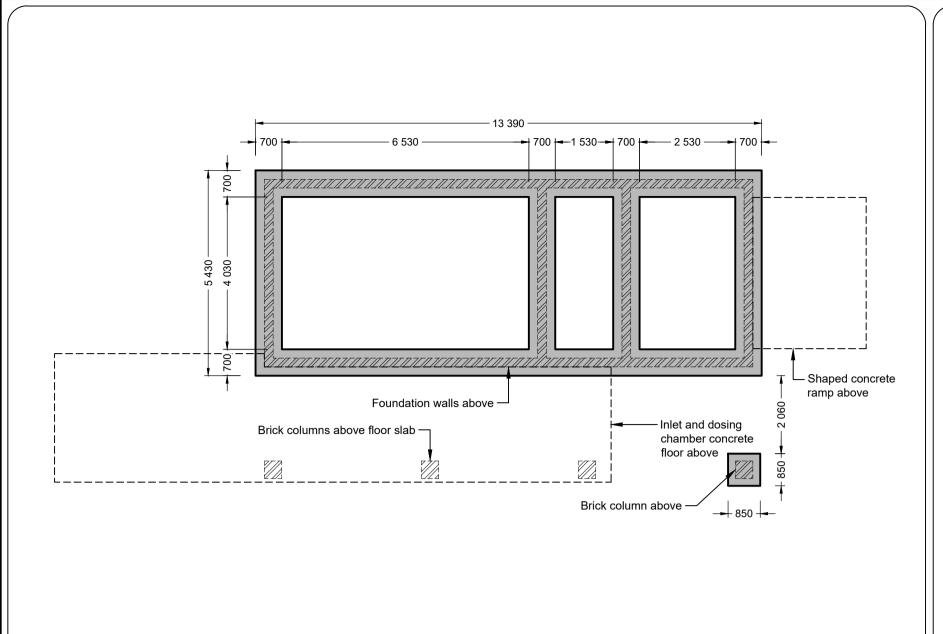



SEE DETAIL NO:


DETAIL DESCRIPTION:


FOUNDATION LAYOUT

DETAIL NO: | SCALE:

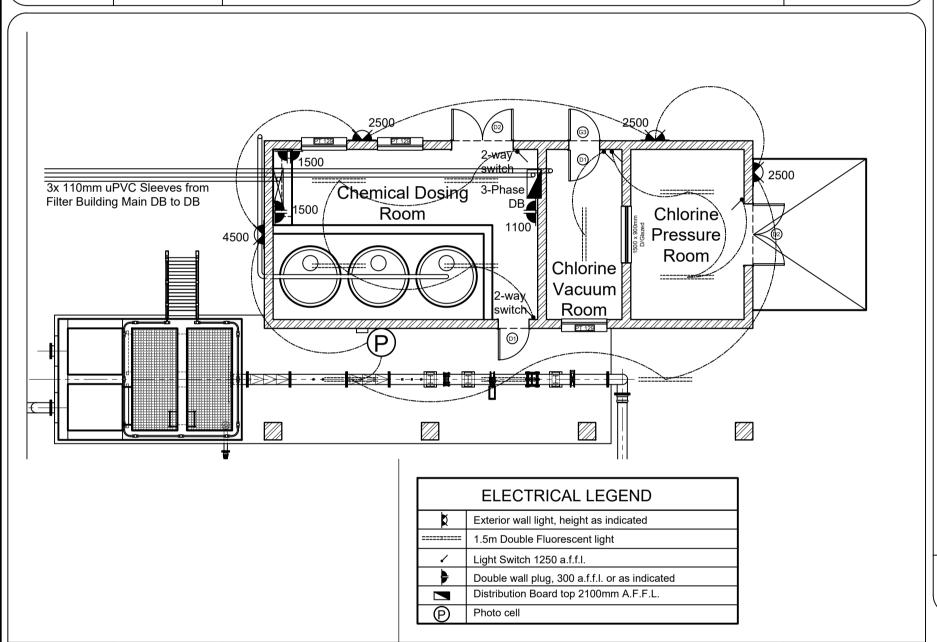

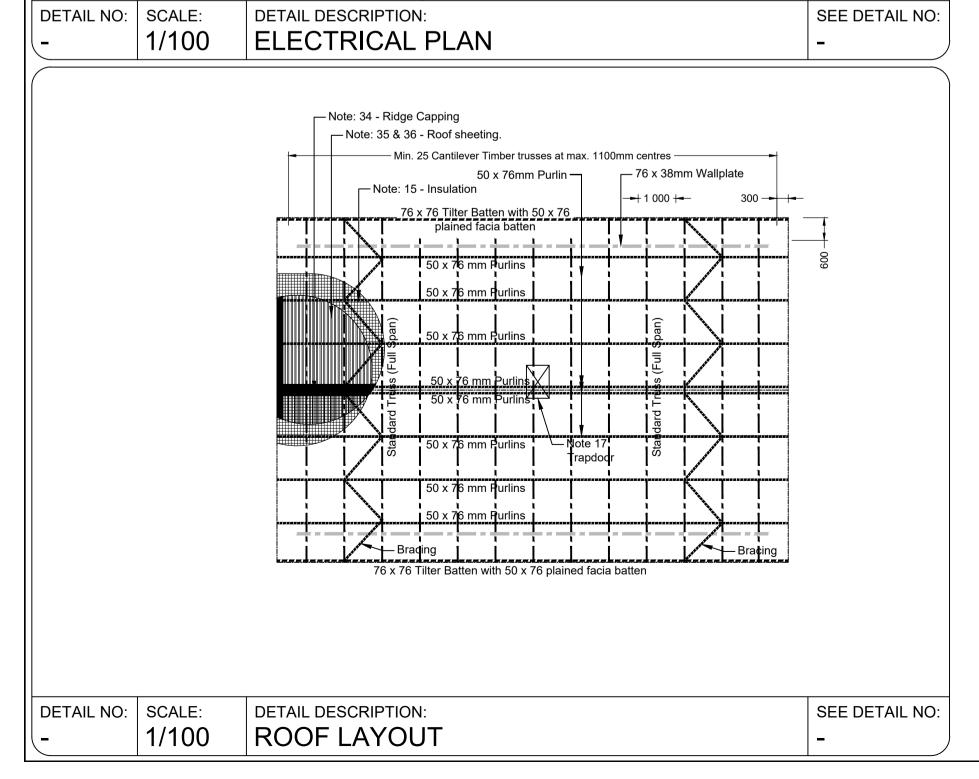

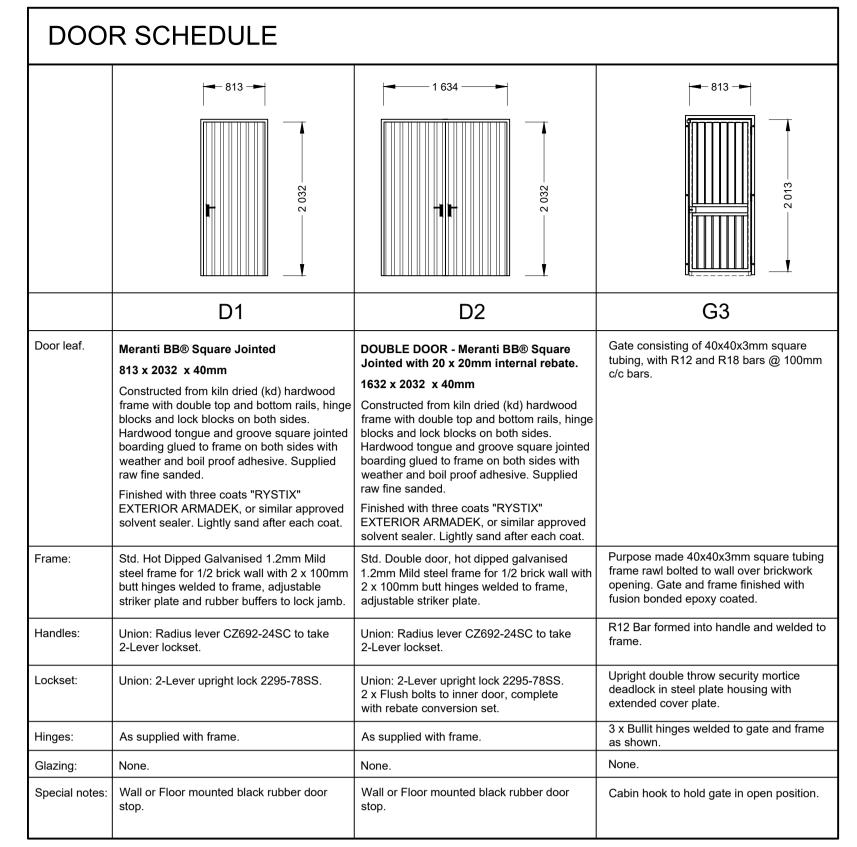

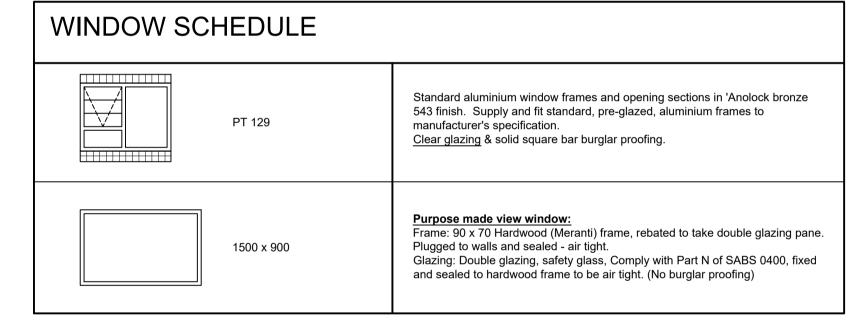

DETAIL NO: | SCALE: **DETAIL DESCRIPTION:** SEE DETAIL NO: 1/50 DOOR & WINDOW SCHEDULE

BUILDING WORK NOTES:

- 1. TERMITE POISON: Treat ground under all internal & external walls, concrete beds and slabs in accordance with SABS 1165. Then apply 50mm river sand over poison.
- 2. FLOORS: 100mm Thick, 20MPa concrete surface bed, floated to Class U2 with mesh ref. 245 set 25mm below top on 250Microns USB green damp proof membrane on 25mm sand bed on compacted G5 fill. To be poisoned in accordance with SABS 1165 soil poison with with 5 year guarantee.
- 3. 100mm, Sloping 20MPa concrete surface bed floated to Class U2 with mesh ref. 245 set 25mm below top on cast on 250 micron USB Green, damp proof membrane, with all side overlaps sealed with approved contact adhesive, on 50mm sand on approved G5 filling to be poisoned as Item 1. Concrete to have non-slip U2 finish, wood float.
- 4. ±450 x ±450 x 10mm SLIP FREE CERAMIC TILES: As approved on 3:1 tile cement mortar. All joints to be continuous in both directions with total thickness of 6mm min. Tiles laid to manufacturers recommendations and instructions. Tiles to be Group A quality - Sand / Terracotta Colour.
- 5. 75mm high SKIRTING TILES: Cut from floor tiles, as approved on 3:1 cement mortar. All joints to be laid in same direction as floor tiles. Tiles to be laid to manufacturers recommendations and instructions.
- 6. Apply Flowshield 1000 self smoothing epoxy compound to a minimum thickness of 1000 microns in accordance with the manufacturers Flowcrete SA's installation methodology. Colour to be Goosewing Grey 222 or equal and approved. Concrete floors to be clean, dry, sound and free of laitance with residual moisture content of less than 4%. Applied by Specialist Sub contractor.
- 7. 19x76mm MERANTI SKIRTING BOARD: Nailed to wall. All nails to be punched and filled. Finish with 2 coats poly-urethane paint.
- 8. UNTINTED GRANOLITHIC: 22mm min. thick floor finish
- 9. FACE BRICK IN STRETCHER BOND: 'Corobrick 'Nabraska Travertine' or similar approved 'FBS' quality clay face bricks to SABS 227:2002 with all joints and perpends to be 6mm square deep recessed. WALLS WATERPROOFING: Apply bagwash and bitumen emultion to external face of of internal brick skin on all external / cavity walls.
- 10. PLASTER AND PAINT: All walls finished with minimum 15mm plaster and painted with one coat professional plaster primer, and two coats "Plascon - Double Velvet, Colour - VEL 17 Broken White." or other approved interior quality paint.
- 11. WHITE GLAZED TILES: Three rows above unit, with returns where applicable in dove grey grout.
- 12. MATT WHITE GLAZED TILES (200 x 200): 'Jonson' or similar approved, eight (8) rows tile all round in dove grey grout.
- 13. BRICK ON EDGE WINDOW SILL: all joints to be flush half round pointed joints. Window sills underneath walkway roof to be soldier course.
- 14. Interior 12mm CEMENT PLASTER WINDOW SILLS: finish as for PLASTER & PAINT walls.
- 15. INSULATION: 'Sisalation FR 500' or similar approved, insulation on top of purlins on 40mm chicken mesh. Care to be taken when installing hurricane clips not to damage sisalation.
- 16. 4mm THICK FIBRE-CEMENT SHEET CEILINGS: Secured to 38 x 50mm brandering at maximum 400mm centres, fitted with H-profiled cover strips and 75mm Gypsum coved conice. Treat all nails and joints with one primer coat and finish ceiling and conic with one undercoat and two coats acrylic PVA
- 17. 600x600 CEILING TRAP DOOR: as per roof plan. Finish with 1 universal undercoat and two coats eggshell enamel paint to comply with SABS 630 type 2, or equivalent standard. Colour as for ceiling.
- 18. PLASTER & PAINT: Provide 2 coats acrylic PVA suitable for washing with a mild detergent and with a mat finish. Apply at 10 m² / liter spread rate. Undercoat: Provide 1 coat alkaline resistant 100% pure acrylic filler coat. Spread rate 6 m² / liter.
- 19. Class 1, off-shutter concrete. Finishing: One coat bonding liquid, followed by 1 coat 'Plascon' Plascotex texture paint, applied with a texture roller to manufacturer's specifications.
- 20. SUSPENDED CEILING: 'Everite' or similar approved ceiling in 'Everite' Pentatile' boards in 595mm x 1195mm nominal size. Installation complete with T-Grids, wall angles, hold down clips, suspension rods, hooks, plates etc. Installation by specialist / expert.
- 21. WC White 'Vaal' Aquasave low level suite (Code 750151) with 90° outlet washdown pan and catching 6 litre SISO cistern complete with heavy duty seat and lid, fitments and flushpipe or similar approved. Cistern connector hose with 232 angle regulating valve.
- 22. WHB White 'Vaal' Springbok 550 WHB (code 7031) with one tap hole fitted to wall with semi consealed brackets (8118ZO) or similar approved. Basin connector hose with 232 angle regulating valve. Basin waste: 11/4" Chrome plated basin waste with slotted shank, plug chain & stay (code 301-32) from cobra or similar approved. Basin waste trap: 11/4" Chrome plated bottle trap with outlet to 40mm uPVC. (Code 340/40) or similar approved.
- 23. Suitable metal type (S/steel) toilet roll holder fixed to walls
- 24. 600x19mm STAINLESS STEEL CHROMIUM PLATED TOWEL RAIL: complete with chromium plated end brackets plugged and screwed to wall.
- 25. 450x600x6mm "GG" QUALITY POLISHED GLASS MIRROR: Fix to wall position as shown on site with round nose chromium plated mirror screws. Four per mirror. 1 per basin.
- 26. 4.5kg DCP: dry powder chemical fire extinguisher with hook made of 120x20x2mm mild steel strip bent to form hook for extinguisher screwed twice to 520x100x22mm hardwood. Hardwood screwed and plugged with 6 screws and plugs. Positioned as shown on site. Provide 190x190mm ABS plastic symbolic safety signs - type FB2, plugged and screwed to wall at all fire extinguishers.
- 27. MEDICINE CABINET: Standard white built in type. Complete with mirrors on doors, shelves etc.. All as approved. Size
- 28. WALL SAFE: Aprox. size 280 x 310 x 230mm deep, bolted to wall with expansion bolts to inside of safe, with integrated security lock.

- 29. 2 x (2400x1140mm) GREEN CHALK BOARD: To comply with CKS-36-1980 or equivalent code of practice, complete with chalk rail as one unit. Strictly according to manufacturers instructions. Bottom of board to be 900mm from finished floor
- 30. Pinning board as per detail 2 Coats pva paint finish.
- 31. Shelves as per details.
- 32. Standard 150 X 150 white glazed soap holder.
- 33. As per detail.
- 34. 0.6mm Thick 450mm girth ridge capping all as described for roof covering. Provided polyethylene filler blocks to ridging.
- 35. Kliplok 700/ Kingclip 700/ Saflok700: 0.53mm thick 'Chromadek/Globalcoat' to one side, profiled steel sheeting to steel structure roof & sides: Colour - Dark dolphin.
- 36. Determine the direction of prevailing winds before laying sheets. Sheets must be projected minimum 50mm beyond

purlins at eaves. Holes in sheets to be drilled, not punched.

- 37. Prefabricated cleated (Gangnail) roof trusses to engineers approval, tied down to walls with galvanized hoop-iron straps built in. Trusses to be spaced at max 1200mm C/C on 76 × 38mm wall plates. TR1 and TR2 certificates to be provided.
- 38. Hurricane clips to be provided and secured to 76 x 50mm SA Pine Purlins purlins and trusses at every intersection.
- 39. Barge Boards & Fascias 'Everite Nutec' fibre-cement: 225 × 10m thick Fascias.
- 40. Approved H-profile barge boards joiners. Provide drill for and fix with hot-dipped galvanized screws and washers. 76 × 50mm trimmer batten to underside of purlin ends for
- 41. G4/G5 Approved natural gravel fill material under floor slabs, compacted in layers not exceeding 150mm, to 93% Mod. AASHTO.
- 42. Face brick-on-edge roller course.

barge board fixing.

200 x 80mm Barge Board.

- 43. 76mm × 76mm Pine wrot splayed eaves, purlins spiked and stormclipped to rafters.
- 44. 140 × 140mm Pre cast concrete posts holed for 12mm Ø MS
- 45. 30MPa Concrete ring beam with off-shutter finish and 20mm chamfers to all exposed edges. Rebar to details.
- 46. SINK UNIT: 'Franke Curvline CVN 622' or similar approved
- insert sink (drop in).
- 47. Windows: as scheduled 48. Doors: as scheduled.
- 49. Foundations: 40mm Thick, 15 MPa blinding layer to bottom of trenches with 30 MPa Concrete strip foundations to detail under all walls with top of foundation to be minimum 400mm below natural ground level. Reinforcing to rebar details.
- 50. 125mm Continuously rolled aluminium square guttering. Fixed with aluminium gutter brackets for fascia fixing. 125mm Circular downpipe complete with downpipe connection, offset combination, shoe and downpipe clips for fixing to wall.
- Worktops to be 32mm thick Laminated Saligna worktops Refer to detail.
- 53. 50 x 50 x 3mm Galvanised MS angle bracket minimum 500mm long, twice bolted to post and twice bolted to bearer.
- 54. 12mm Ø Stud anchor bolt to concrete post.
- 55. 10mm Ø Steel bolts with washers.
- 56. ±198mm x 46mm Thick laminated SA Pine Beam to veranda roofing secure rafters to bearer with storm clips.
- 57. Timber finishes:All exposed timber: Pine trusses, purlins, wall plates, etc., treated with 2 coats 'Carbolineum'
- 58. 38 × 114mm Bracing.
- 59. 38 × 76mm Wall plate trimmed to suit beam filling.
- 60. 50 x 50 x 3mm Hot dipped galvanised mild steel angle with 'fish tail' cast in position to thresholds.
- 61. 110mm Thick beam filling.
- 62. Brickforce every two courses in foundations, every course above window head to wall plate level and every third course
- 63. Walls where indicated on drawings to be taken up to underside of roof sheeting as fire-walls.
- 64. 80mm Thick, 20 MPa x 1000mm, with mesh ref. 245, wide V-shaped surface channel cast in 2000mm lengths to falls to suit conditions with wood float U2 finish.
- 65. 80mm Thick x 1000mm wide 20 MPA concrete apron cast in
- 2000mm lengths to falls to suit conditions to U3 finish. 66. Ramp verandah floor to suit external levels. ie. NO STEPS
- 67. Lightning protection: All buildings to be provided with lightning
- protection in accordance with pages LP/1 to LP/6 inclusive, as the tender document.
- and height of joint. Provide similar 100mm thick and 100mm wide bitumen impregnated soft-board to exposed edged.

68. Expansion joint formed with 10mm thick soft-board full length

- 69. Column bases to be 600 deep x 350 x 500mm wide 25MPa concrete to pre-cast column basis
- 70. External plumbing: Use is to be made of Sewer piping and fittings under the 'Marley' - Soil and Vent & Underground Drain piping and fitting systems.
- 71. 1000mm High Balustrade to detail.

Do not scale off drawing - ASK THE ENGINEER IF

Any discrepancies between any drawings must be clarified before work is continued on site.



READ THIS DE	RAWING IN CONJUCTION V		
Drawing Number	Drawing Description		
13-019-V-01-01-01	Site Plan		
13-019-V-01-02-01	Sections		
13-019-V-01-02-02	Sections & Details		
13-019-V-01-02-03	Elevations		
13-019-V-01-02-05	Pipe Schedule & Details		
AMENDMENTS			

Rev.	Date	Description		
EC	ECA CONSULTING VRYHEID			



ISO Registered 9001:2015 Approved by Engineer Name: J.W. Janse v Rensburg Designation: PrTechEng

Signature: Date: 4 Feb 2022 ECSA Reg.: 201070143

MUNICIPALITY

LADYSMITH

DIHLABENG LOCAL


Approved by Client:	
Name:	
Signature:	Date:

Drawing description:

INLET, DOSING CHAMBER AND BUILDING: FOUNDATION, **ROOF & ELECTRICAL PLANS**

CLARENS WTW


Drawn: M BOTHA Date: Jan 2021 Scale/s: AS SHOWN Rev.: Drawing number: |13-019-V-01-02-04

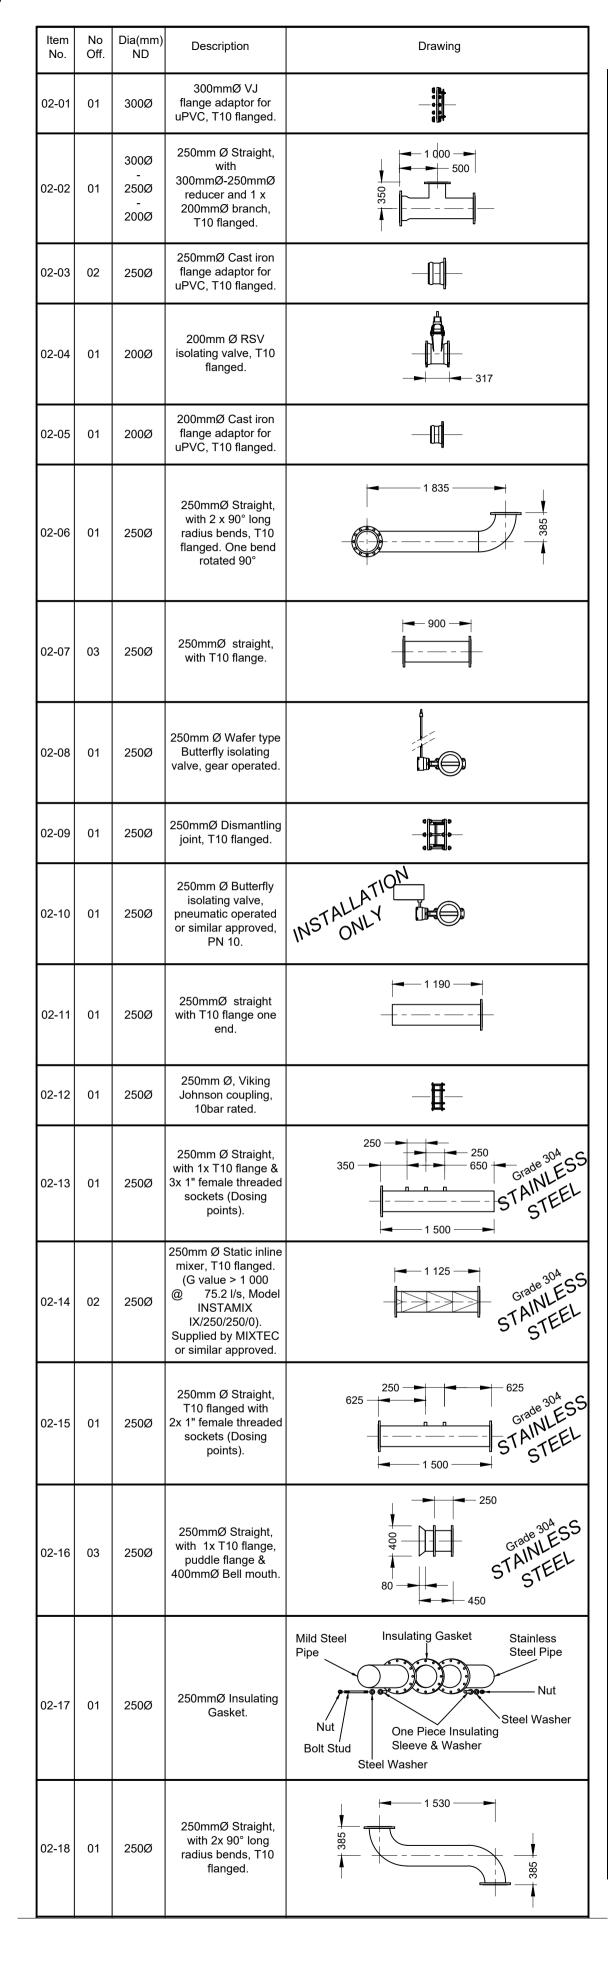


Item No.	No Off.	Dia(mm) ND	Description	Drawing
02-19	01	250Ø	250mm Ø T10 blank flange.	Grade 30A SS STAINLESS STAINLESL
02-20	01	80Ø	80Ø Straight, with 90° long radius bend, 1 x T10 flange & puddle flange.	690
02-21	02	80Ø	75mm Ø × 3" HDPE flange adapter T10.	— 1 39—
02-22	01	80Ø	80mm Ø Straight, T10 flanged with puddle flange.	250
02-23	01	80Ø	80mm Ø RSV Gate Valve to SANS 664, T10 flanged.	

STEEL AND PIPE NOTES:

 All pipes and steelwork shall be fusion bonded epoxy coated to DFT 300 micron thick unless indicated otherwise or stainless steel items

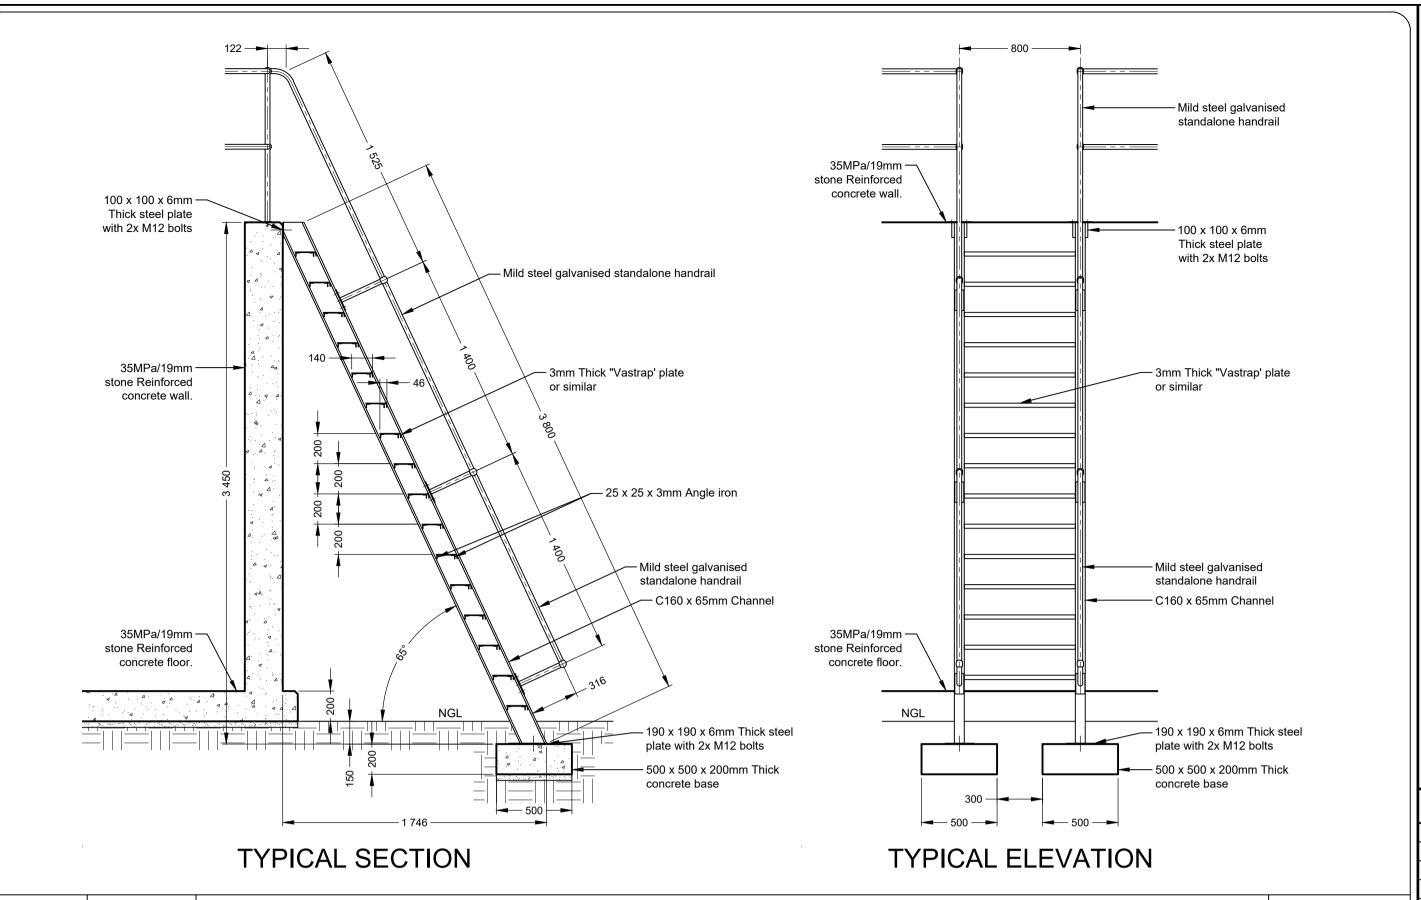

DETAIL NO: SCALE: DETAIL DESCRIPTION: SEE DETAIL NO: - 1/10 STEEL STAIRCASE DETAILS -

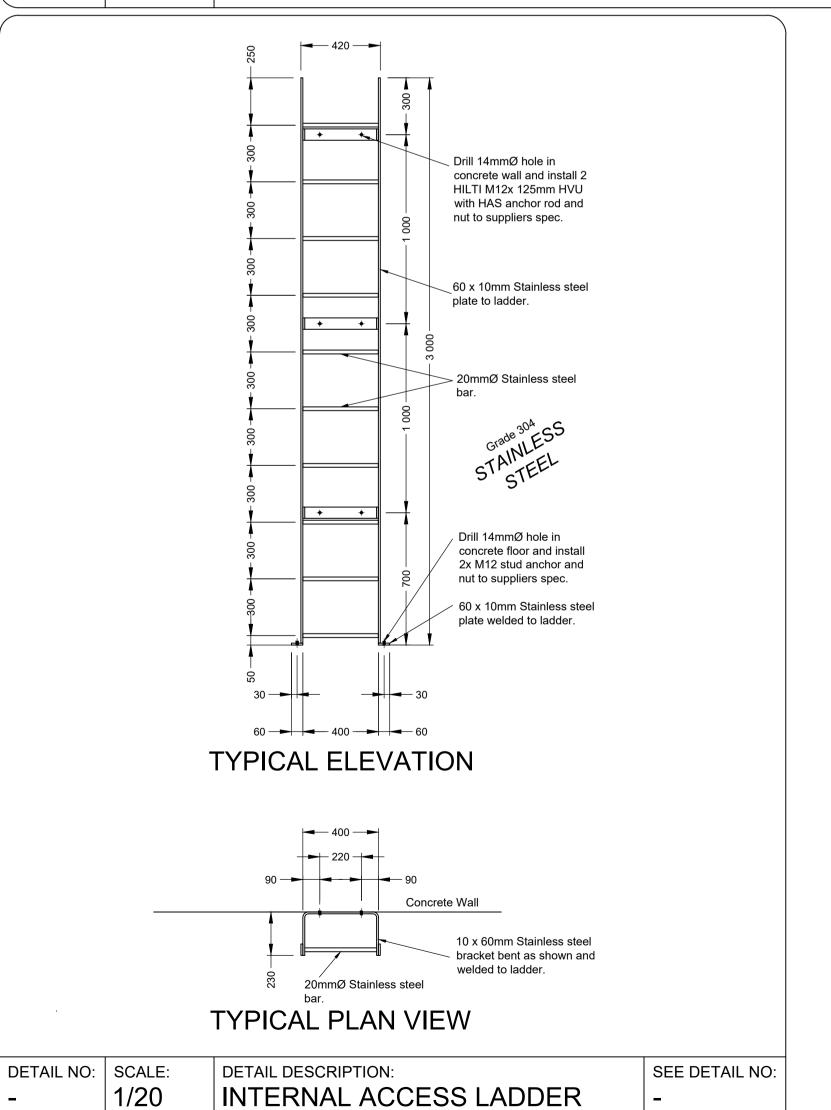

DETAILS (STAINLESS STEEL)




Do not scale off drawing - ASK THE ENGINEER IF

Any discrepancies between any drawings must be

clarified before work is continued on site.

	READ THIS DRAWING IN CONJUCTION WITH			
	Drawing Number	Drawing Description		
	13-019-V-01-01-01	Site Plan		
	13-019-V-01-02-01	Sections		
╛	13-019-V-01-02-02	Sections & Details		
	13-019-V-01-02-03	Elevations		
	13-019-V-01-02-04	Foundation, Roof & Electrical Plans		
1				

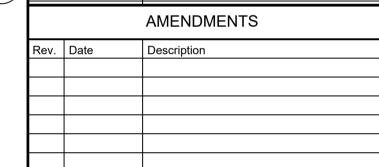



Approved by Engineer:
Name: J.W. Janse v Rensburg
Designation: PrTechEng
ECSA Reg.: 201070143

gnation: PrTechEng
A Reg.: 201070143

Date: 4 Peb 2022

Signature:



Approved by Client:

Name:

Signature:

Date:

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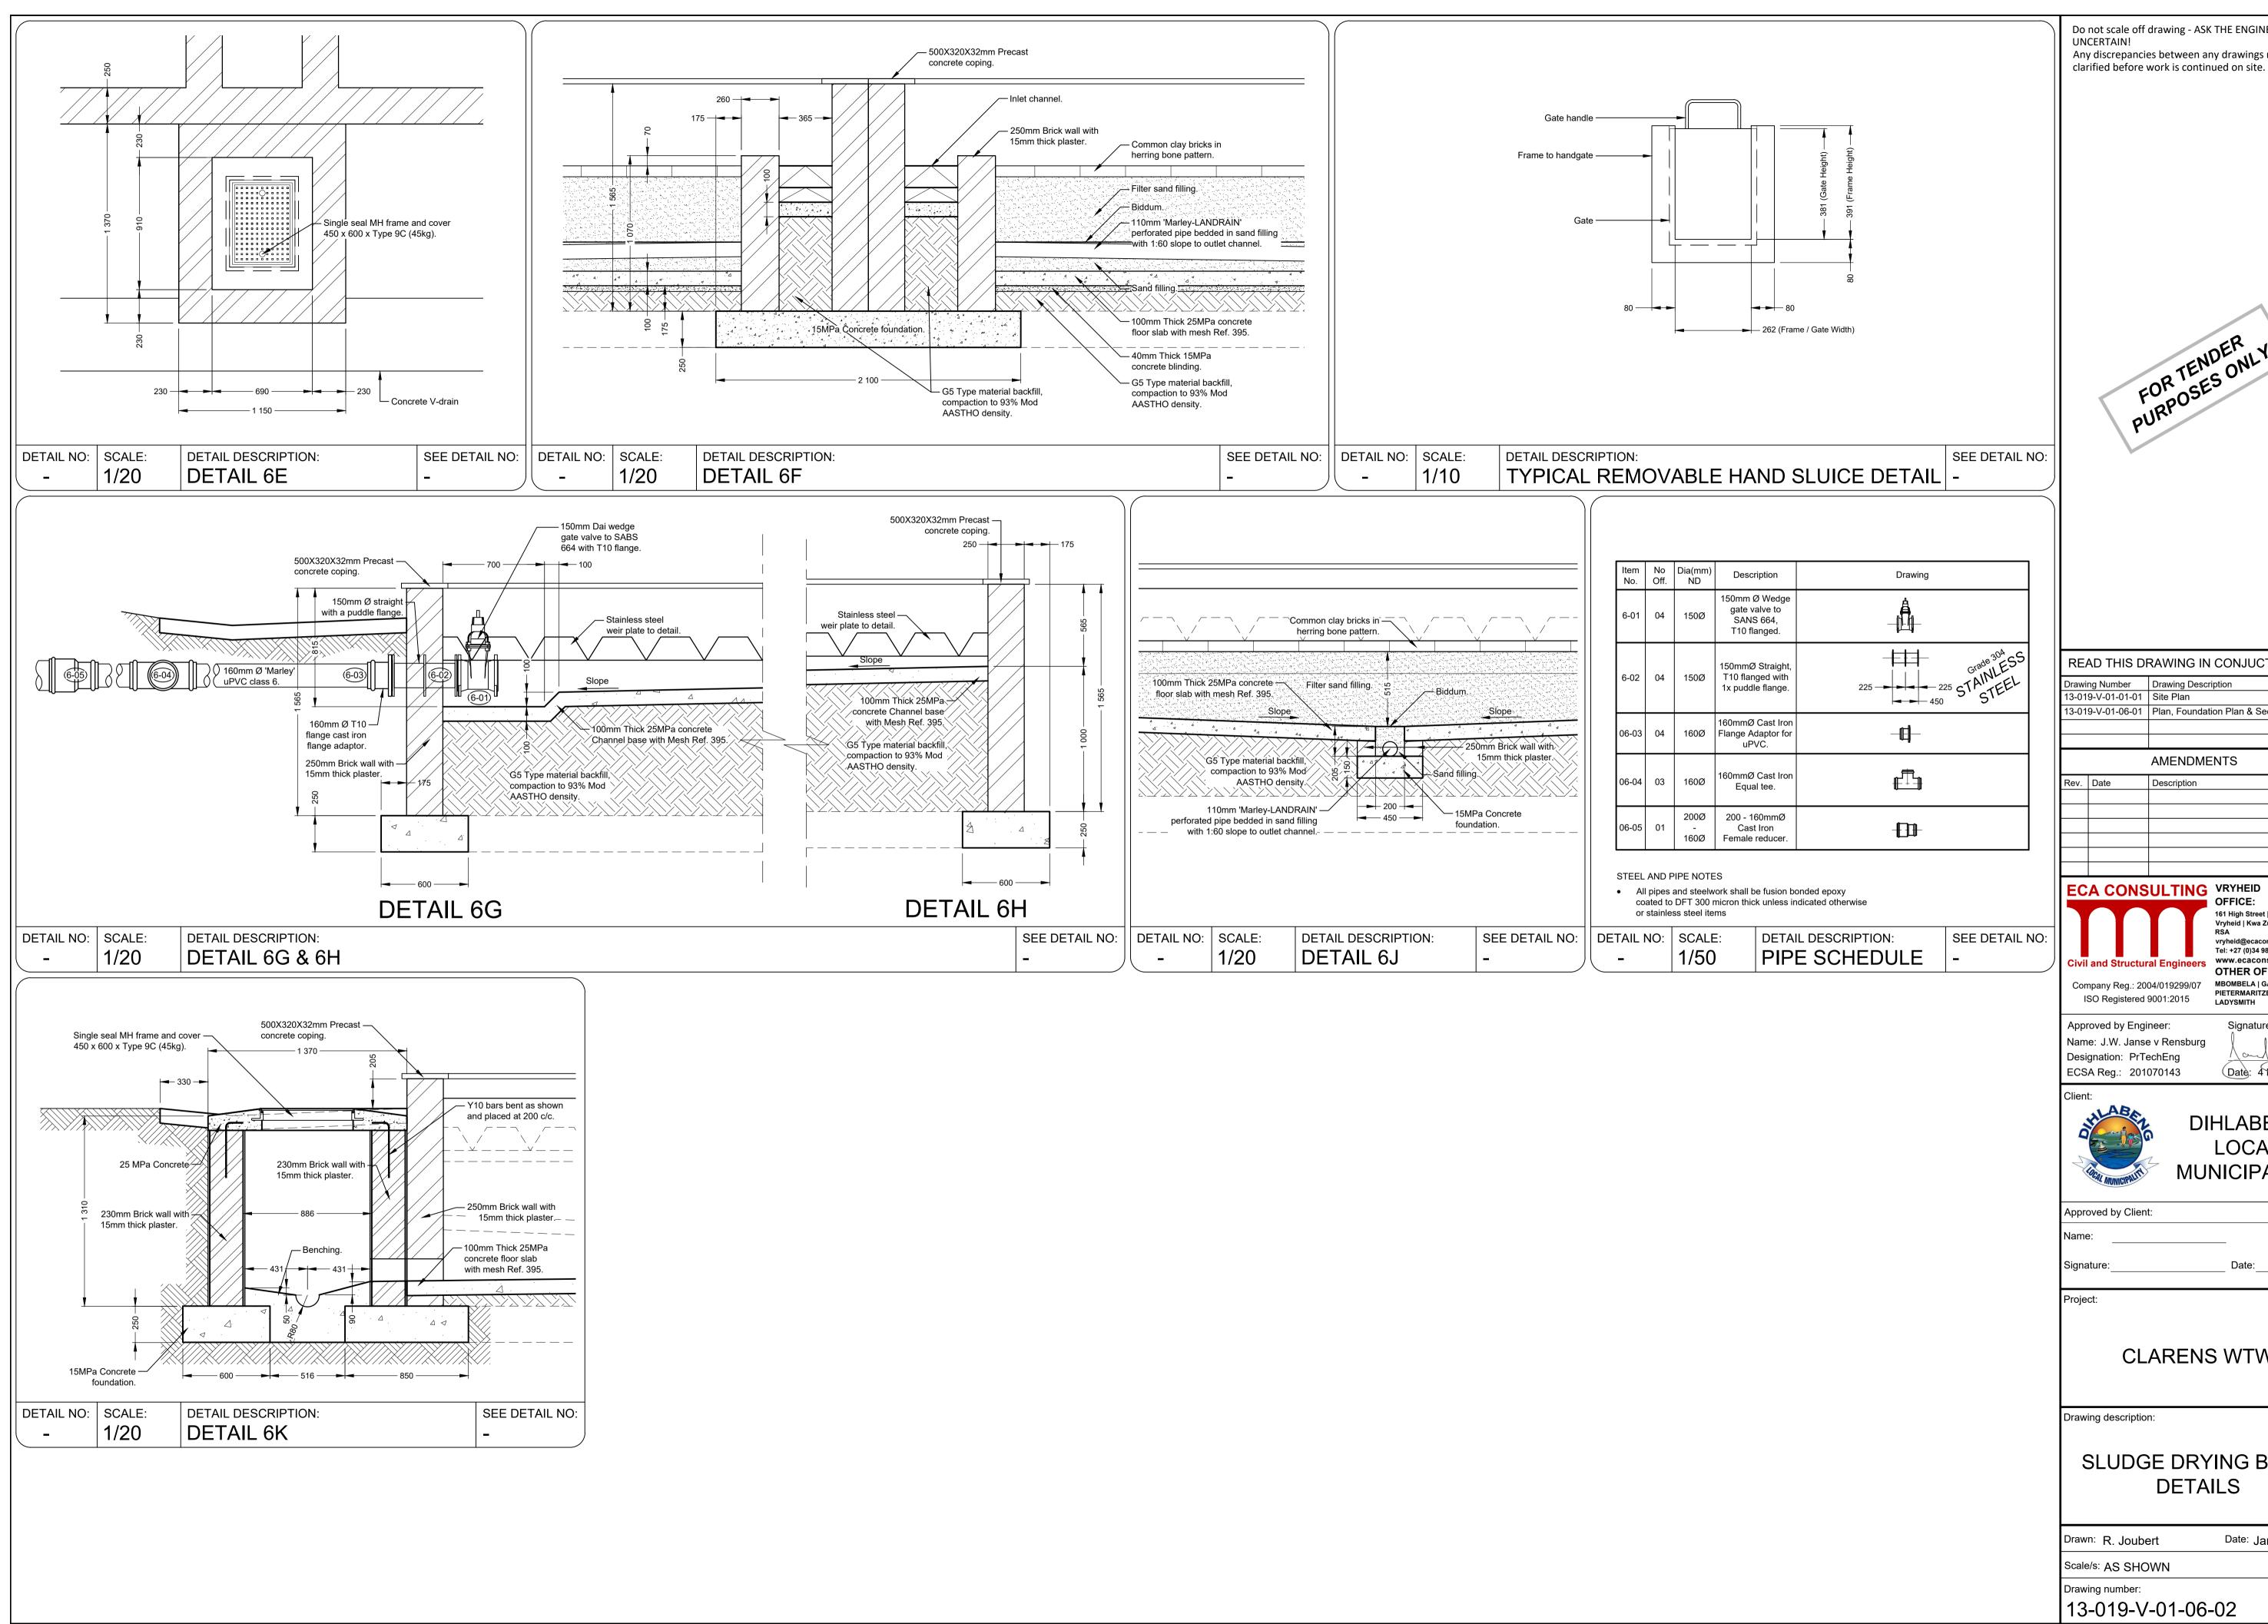
CLARENS WTW

Drawing description:

INLET, DOSING CHAMBER AND BUILDING: PIPE SCHEDULE & DETAILS

Drawn: M BOTHA	Date: Jan 20	21
Scale/s: AS SHOWN		
Drawing number:		Rev.:
13-019-V-01-0	2-05	00

DETAIL NO:	SCALE:	DETAIL DESCRIPTION:	SEE DETAIL NO:
_	1/50	PIPE SCHEDULE	-



Do not scale off drawing - ASK THE ENGINEER IF Any discrepancies between any drawings must be

READ THIS DRAWING IN CONJUCTION WITH Drawing Number Drawing Description 13-019-V-01-01 Site Plan 13-019-V-01-06-01 Plan, Foundation Plan & Sections **AMENDMENTS** Description

ECA CONSULTING VRYHEID OFFICE: 161 High Street | Vryheid | Kwa Zulu Natal | RSA vryheid@ecaconsult.co.za Tel: +27 (0)34 983 2825 www.ecaconsult.co.za **Civil and Structural Engineers OTHER OFFICES:** MBOMBELA | GAUTENG | Company Reg.: 2004/019299/07 PIETERMARITZBURG | ISO Registered 9001:2015

Approved by Engineer: Name: J.W. Janse v Rensburg Designation: PrTechEng

Date: 4 Peb 2022

Signature:


DIHLABENG LOCAL MUNICIPALITY

CLARENS WTW

Drawing description:

SLUDGE DRYING BEDS: DETAILS

Drawn: R. Joubert Date: Jan 2021 Scale/s: AS SHOWN Rev.:

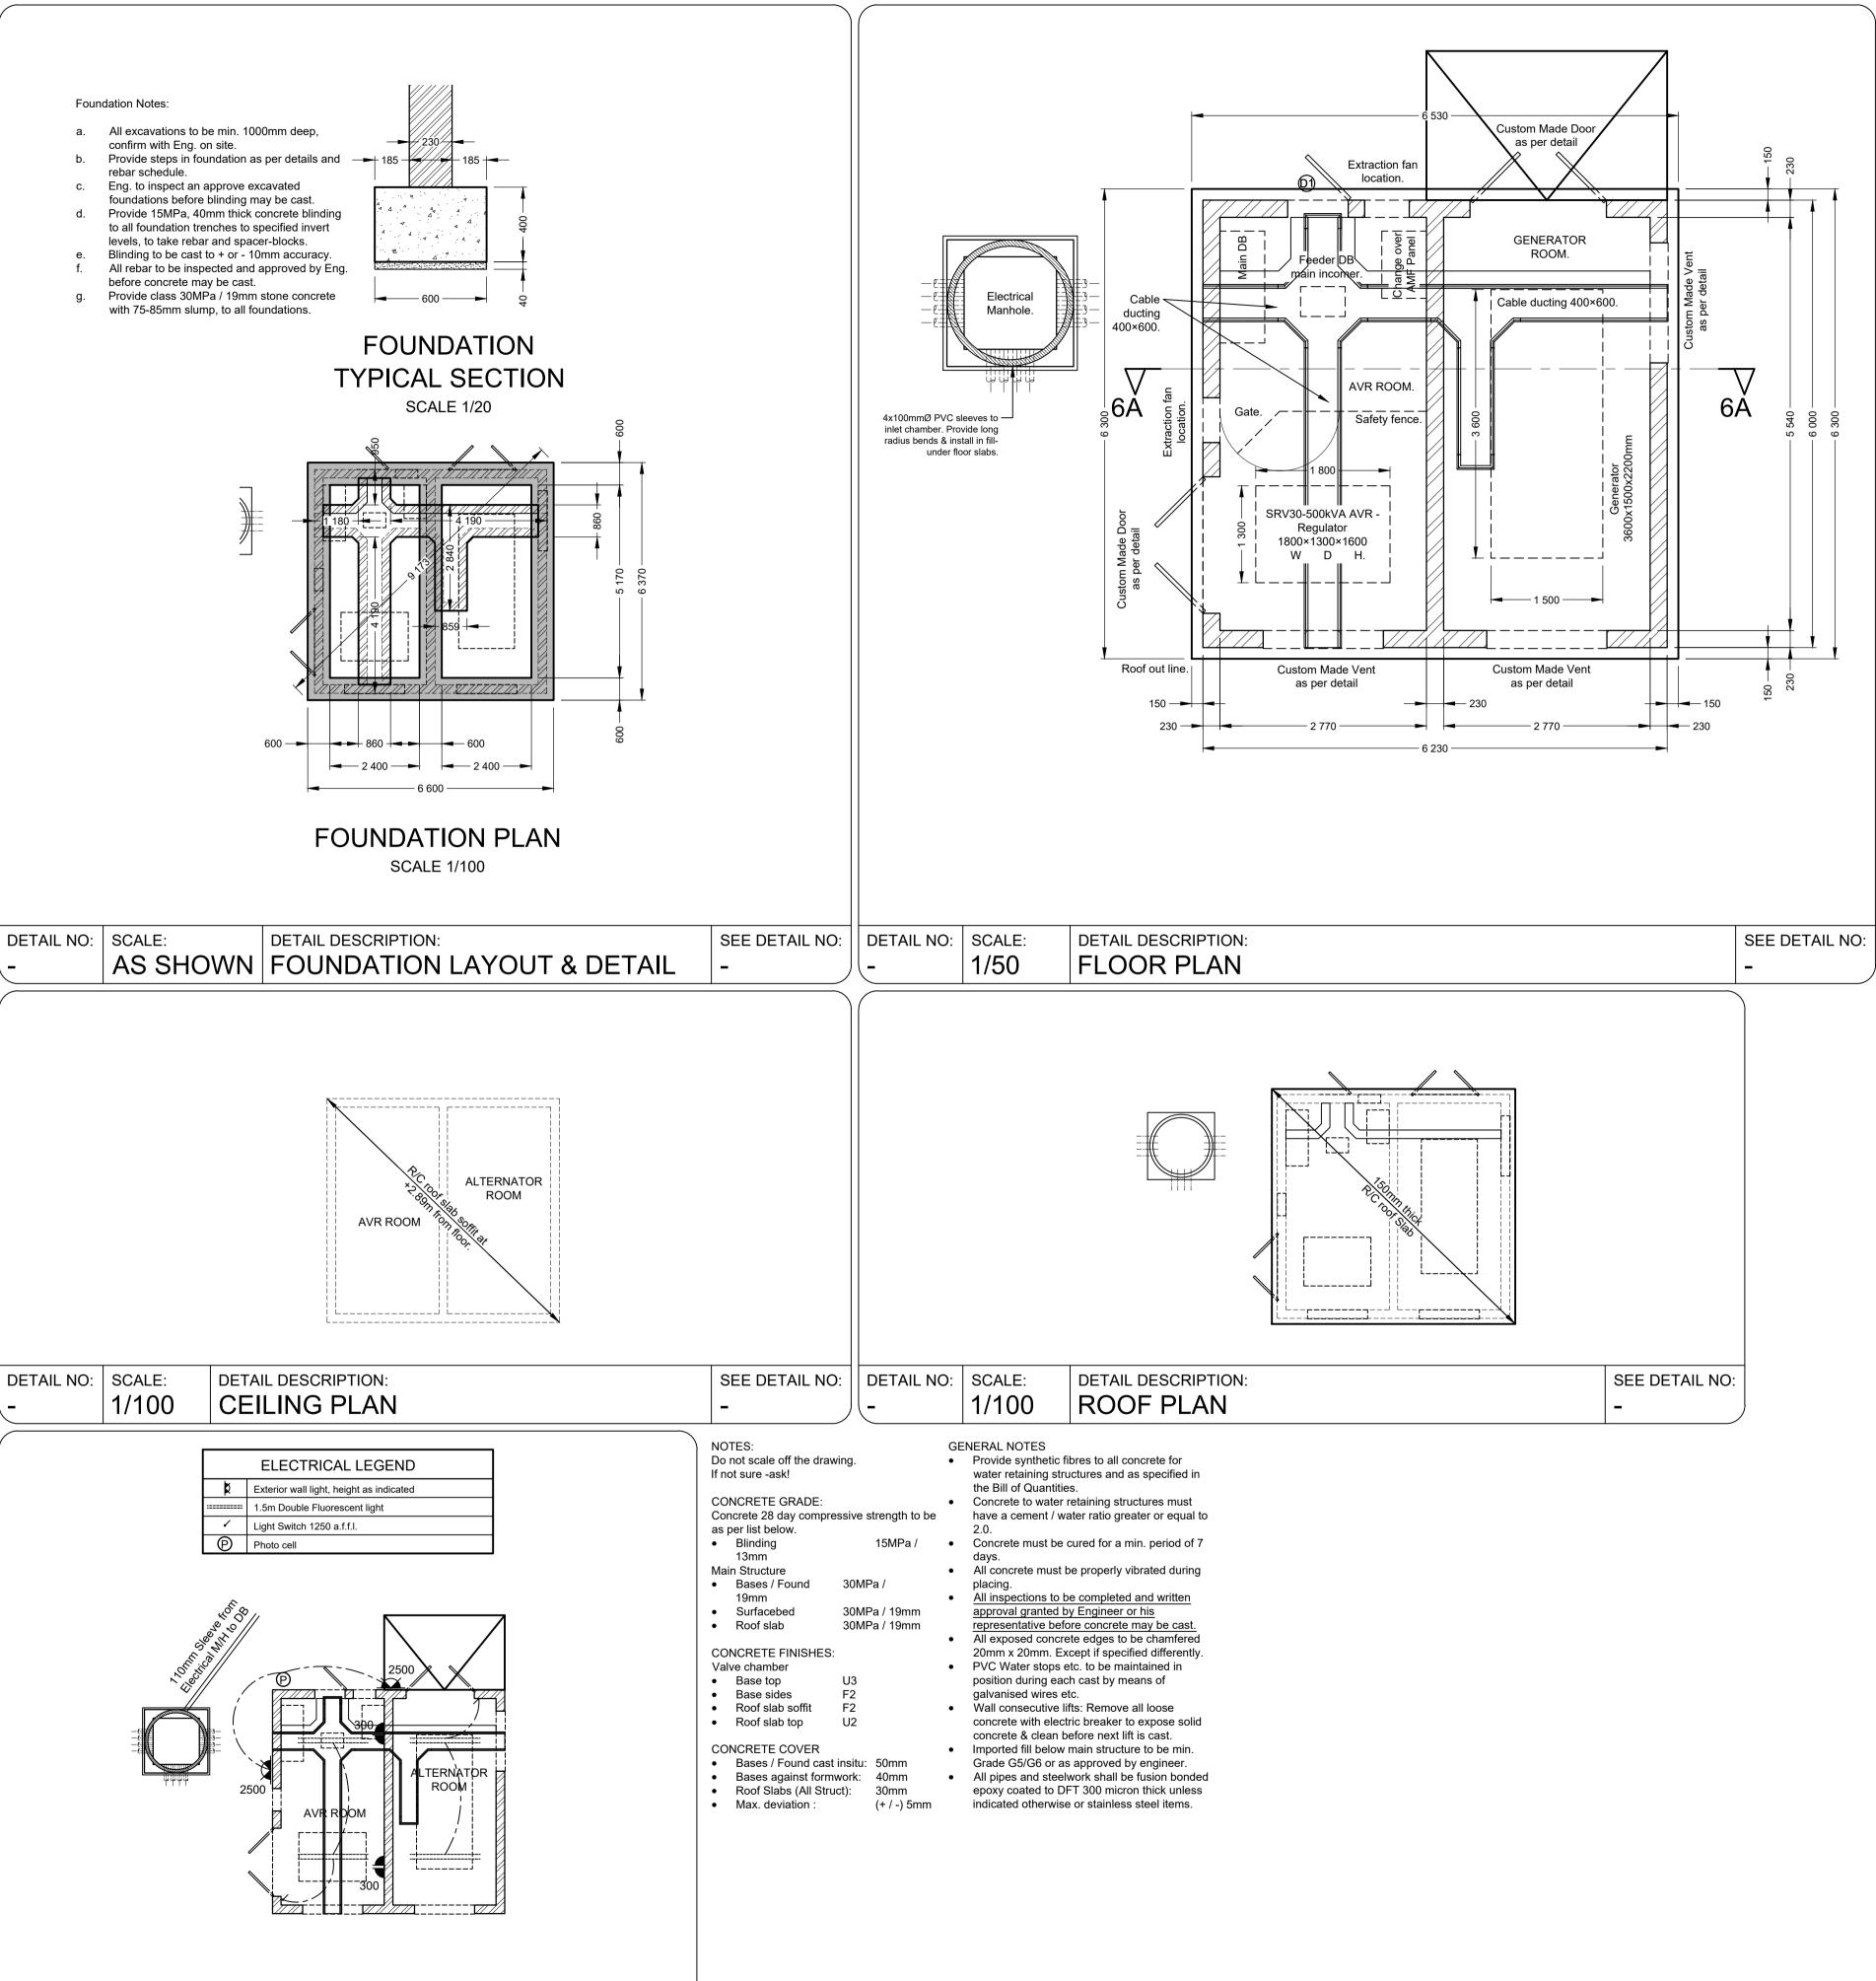

DETAIL DESCRIPTION:

ELECTRICAL PLAN

DETAIL NO: | SCALE:

SEE DETAIL NO:

BUILDING WORK NOTES:

- TERMITE POISON: Treat ground under all internal & external walls, concrete beds and slabs in accordance with SABS 1165. Then apply 50mm river sand over poison.
- FLOORS: 100mm Thick, 20MPa concrete surface bed, floated to Class U2 with mesh ref. 245 set 25mm below top on 250Microns USB green damp proof membrane on 25mm sand bed on compacted G5 fill. To be poisoned in accordance with SABS 1165 soil poison with with 5 year guarantee.
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- ±450 x ±450 x 10mm SLIP FREE CERAMIC TILES: As approved on 3:1 tile cement mortar. All joints to be continuous in both directions with total thickness of 6mm min. Tiles laid to manufacturers recommendations and instructions. Tiles to be Group A quality Sand / Terracotta Colour.
- 75mm high SKIRTING TILES: Cut from floor tiles, as approved on 3:1 cement mortar. All joints to be laid in same direction as floor tiles. Tiles to be laid to manufacturers recommendations and instructions.
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- 19x76mm MERANTI SKIRTING BOARD: Nailed to wall. All nails to be punched and filled. Finish with 2 coats poly-urethane paint.
- 8. UNTINTED GRANOLITHIC: 22mm min. thick floor finish (Screed).
- 9. FACE BRICK IN STRETCHER BOND: 'Corobrick 'Nabraska Travertine' or similar approved 'FBS' quality clay face bricks to SABS 227:2002 with all joints and perpends to be 6mm square deep recessed. WALLS WATERPROOFING: Apply bagwash and bitumen emultion to external face of of internal brick skin on all external / cavity walls.
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- 12. MATT WHITE GLAZED TILES (200 x 200): 'Jonson' or similar approved, eight (8) rows tile all round in dove grey grout.
- BRICK ON EDGE WINDOW SILL: all joints to be flush half round pointed joints. Window sills underneath walkway roof to be soldier course.
- 14. Interior 12mm CEMENT PLASTER WINDOW SILLS: finish as for PLASTER & PAINT walls.
- 15. INSULATION: 'Sisalation FR 500' or similar approved, insulation on top of purlins on 40mm chicken mesh. Care to be taken when installing hurricane clips not to damage sisalation.
- 16. 4mm THICK FIBRE-CEMENT SHEET CEILINGS: Secured to 38 x 50mm brandering at maximum 400mm centres, fitted with H-profiled cover strips and 75mm Gypsum coved conice. Treat all nails and joints with one primer coat and finish ceiling and conic with one undercoat and two coats acrylic PVA paint.
- 17. 600x600 CEILING TRAP DOOR: as per roof plan. Finish with 1 universal undercoat and two coats eggshell enamel paint to comply with SABS 630 type 2, or equivalent standard. Colour as for ceiling.
- 18. PLASTER & PAINT: Provide 2 coats acrylic PVA suitable for washing with a mild detergent and with a mat finish. Apply at 10 m² / liter spread rate. Undercoat: Provide 1 coat alkaline resistant 100% pure acrylic filler coat. Spread rate 6 m² / liter.
- 19. Class 1, off-shutter concrete. Finishing: One coat bonding liquid, followed by 1 coat 'Plascon' Plascotex texture paint, applied with a texture roller to manufacturer's specifications.
- 20. SUSPENDED CEILING: 'Everite' or similar approved ceiling in 'Everite' Pentatile' boards in 595mm x 1195mm nominal size. Installation complete with T-Grids, wall angles, hold down clips, suspension rods, hooks, plates etc. Installation by specialist / expert.
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- 23. Suitable metal type (S/steel) toilet roll holder fixed to walls.
- 600x19mm STAINLESS STEEL CHROMIUM PLATED TOWEL RAIL: complete with chromium plated end brackets plugged and screwed to wall.
- 25. 450x600x6mm "GG" QUALITY POLISHED GLASS MIRROR: Fix to wall position as shown on site with round nose chromium plated mirror screws. Four per mirror. 1 per basin.
- 26. 4.5kg DCP: dry powder chemical fire extinguisher with hook made of 120x20x2mm mild steel strip bent to form hook for extinguisher screwed twice to 520x100x22mm hardwood. Hardwood screwed and plugged with 6 screws and plugs. Positioned as shown on site. Provide 190x190mm ABS plastic symbolic safety signs type FB2, plugged and screwed to wall at all fire extinguishers.
- MEDICINE CABINET: Standard white built in type. Complete with mirrors on doors, shelves etc.. All as approved. Size 380x610mm.
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- 29. 2 x (2400x1140mm) GREEN CHALK BOARD: To comply with CKS-36-1980 or equivalent code of practice, complete with chalk rail as one unit. Strictly according to manufacturers instructions. Bottom of board to be 900mm from finished floor
- 30. Pinning board as per detail 2 Coats pva paint finish.
- 32. Standard 150 X 150 white glazed soap holder.
- 33. As per detail.

31. Shelves as per details.

- 34. 0.6mm Thick 450mm girth ridge capping all as described for roof covering. Provided polyethylene filler blocks to ridging.
- 35. Kliplok 700/ Kingclip 700/ Saflok700: 0.53mm thick 'Chromadek/Globalcoat' to one side, profiled steel sheeting to steel structure roof & sides: Colour - Dark dolphin.
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- Approved H-profile barge boards joiners. Provide drill for and fix with hot-dipped galvanized screws and washers.
 76 × 50mm trimmer batten to underside of purlin ends for barge board fixing.
- G4/G5 Approved natural gravel fill material under floor slabs, compacted in layers not exceeding 150mm, to 93% Mod. AASHTO.
- 42. Face brick-on-edge roller course.
- 43. 76mm × 76mm Pine wrot splayed eaves, purlins spiked and stormclipped to rafters.
- 44. 140 × 140mm Pre cast concrete posts holed for 12mm Ø MS bolts.
- 45. 30MPa Concrete ring beam with off-shutter finish and 20mm
- chamfers to all exposed edges. Rebar to details.

 46. SINK UNIT: 'Franke Curvline CVN 622' or similar approved
- insert sink (drop in).
- 47. Windows: as scheduled
- 48. Doors: as scheduled.
- 49. Foundations: 40mm Thick, 15 MPa blinding layer to bottom of trenches with 30 MPa Concrete strip foundations to detail under all walls with top of foundation to be minimum 400mm below natural ground level. Reinforcing to rebar details.
- 50. 125mm Continuously rolled aluminium square guttering. Fixed with aluminium gutter brackets for fascia fixing. 125mm Circular downpipe complete with downpipe connection, offset combination, shoe and downpipe clips for fixing to wall.
- Worktops to be 32mm thick Laminated Saligna worktops -Refer to detail.
- 52. Horizontal DPC.
- 53. 50 x 50 x 3mm Galvanised MS angle bracket minimum 500mm long, twice bolted to post and twice bolted to bearer.
- 54. 12mm Ø Stud anchor bolt to concrete post.
- 55. 10mm Ø Steel bolts with washers.
- 56. ±198mm x 46mm Thick laminated SA Pine Beam to veranda roofing secure rafters to bearer with storm clips.
- 57. Timber finishes:All exposed timber: Pine trusses, purlins, wall
- 58. 38 × 114mm Bracing.
- 59. 38 × 76mm Wall plate trimmed to suit beam filling.

plates, etc., treated with 2 coats 'Carbolineum'.

- 60. 50 x 50 x 3mm Hot dipped galvanised mild steel angle with 'fish tail' cast in position to thresholds.
- 61. 110mm Thick beam filling.
- 62. Brickforce every two courses in foundations, every course above window head to wall plate level and every third course
- 63. Walls where indicated on drawings to be taken up to underside of roof sheeting as fire-walls.
- 64. 80mm Thick, 20 MPa x 1000mm, with mesh ref. 245, wide V-shaped surface channel cast in 2000mm lengths to falls to suit conditions with wood float U2 finish.
- 65. 80mm Thick x 1000mm wide 20 MPA concrete apron cast in 2000mm lengths to falls to suit conditions to U3 finish.
- 66. Ramp verandah floor to suit external levels. ie. $\underline{\text{NO STEPS.}}$
- 67. Lightning protection: All buildings to be provided with lightning protection in accordance with pages LP/1 to LP/6 inclusive, as the tender document.
- 68. Expansion joint formed with 10mm thick soft-board full length and height of joint. Provide similar 100mm thick and 100mm wide bitumen impregnated soft-board to exposed edged.
- 69. Column bases to be 600 deep x 350 x 500mm wide 25MPa concrete to pre-cast column basis.
- 70. External plumbing: Use is to be made of Sewer piping and fittings under the 'Marley' Soil and Vent & Underground Drain piping and fitting systems.
- 71. 1000mm High Balustrade to detail.

Do not scale off drawing - ASK THE ENGINEER IF UNCERTAIN!
Any discrepancies between any drawings must be clarified before work is continued on site.



RE	AD THIS DI	RAWING IN CONJUCTION WI
Drawi	ing Number	Drawing Description
13-01	9-V-01-01-01	Site Plan
13-01	9-V-01-07-02	Section, Elevations & Details
13-01	9-V-01-07-03	Door & Louvre Details
		AMENDMENTS
Rev.	Date	Description

Civil and Structural Engineers

Company Reg.: 2004/019299/07
ISO Registered 9001:2015

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Vryheid | Kwa Zulu Natal |
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OTHER OFFICES:
MBOMBELA | GAUTENG |
PIETERMARITZBURG |
LADYSMITH

Approved by Engineer:

Name: J.W. Janse v Rensburg

Designation: PrTechEng

ECSA Reg.: 201070143

Date: 4 Feb 2022

Signature:

DIHLABENG
LOCAL
MUNICIPALITY

MUNICH	
Approved by Client:	
Name:	
Signature:	Date:

ject:

CLARENS WTW

Drawing description:


GENERATOR & A.V.R.
ROOM BUILDING:
BUILDING WORK & PLANS


 Drawn:
 M BOTHA
 Date:
 Jan 2021


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 AS SHOWN


 Drawing number:
 Rev.:

 13-019-V-01-07-01
 00

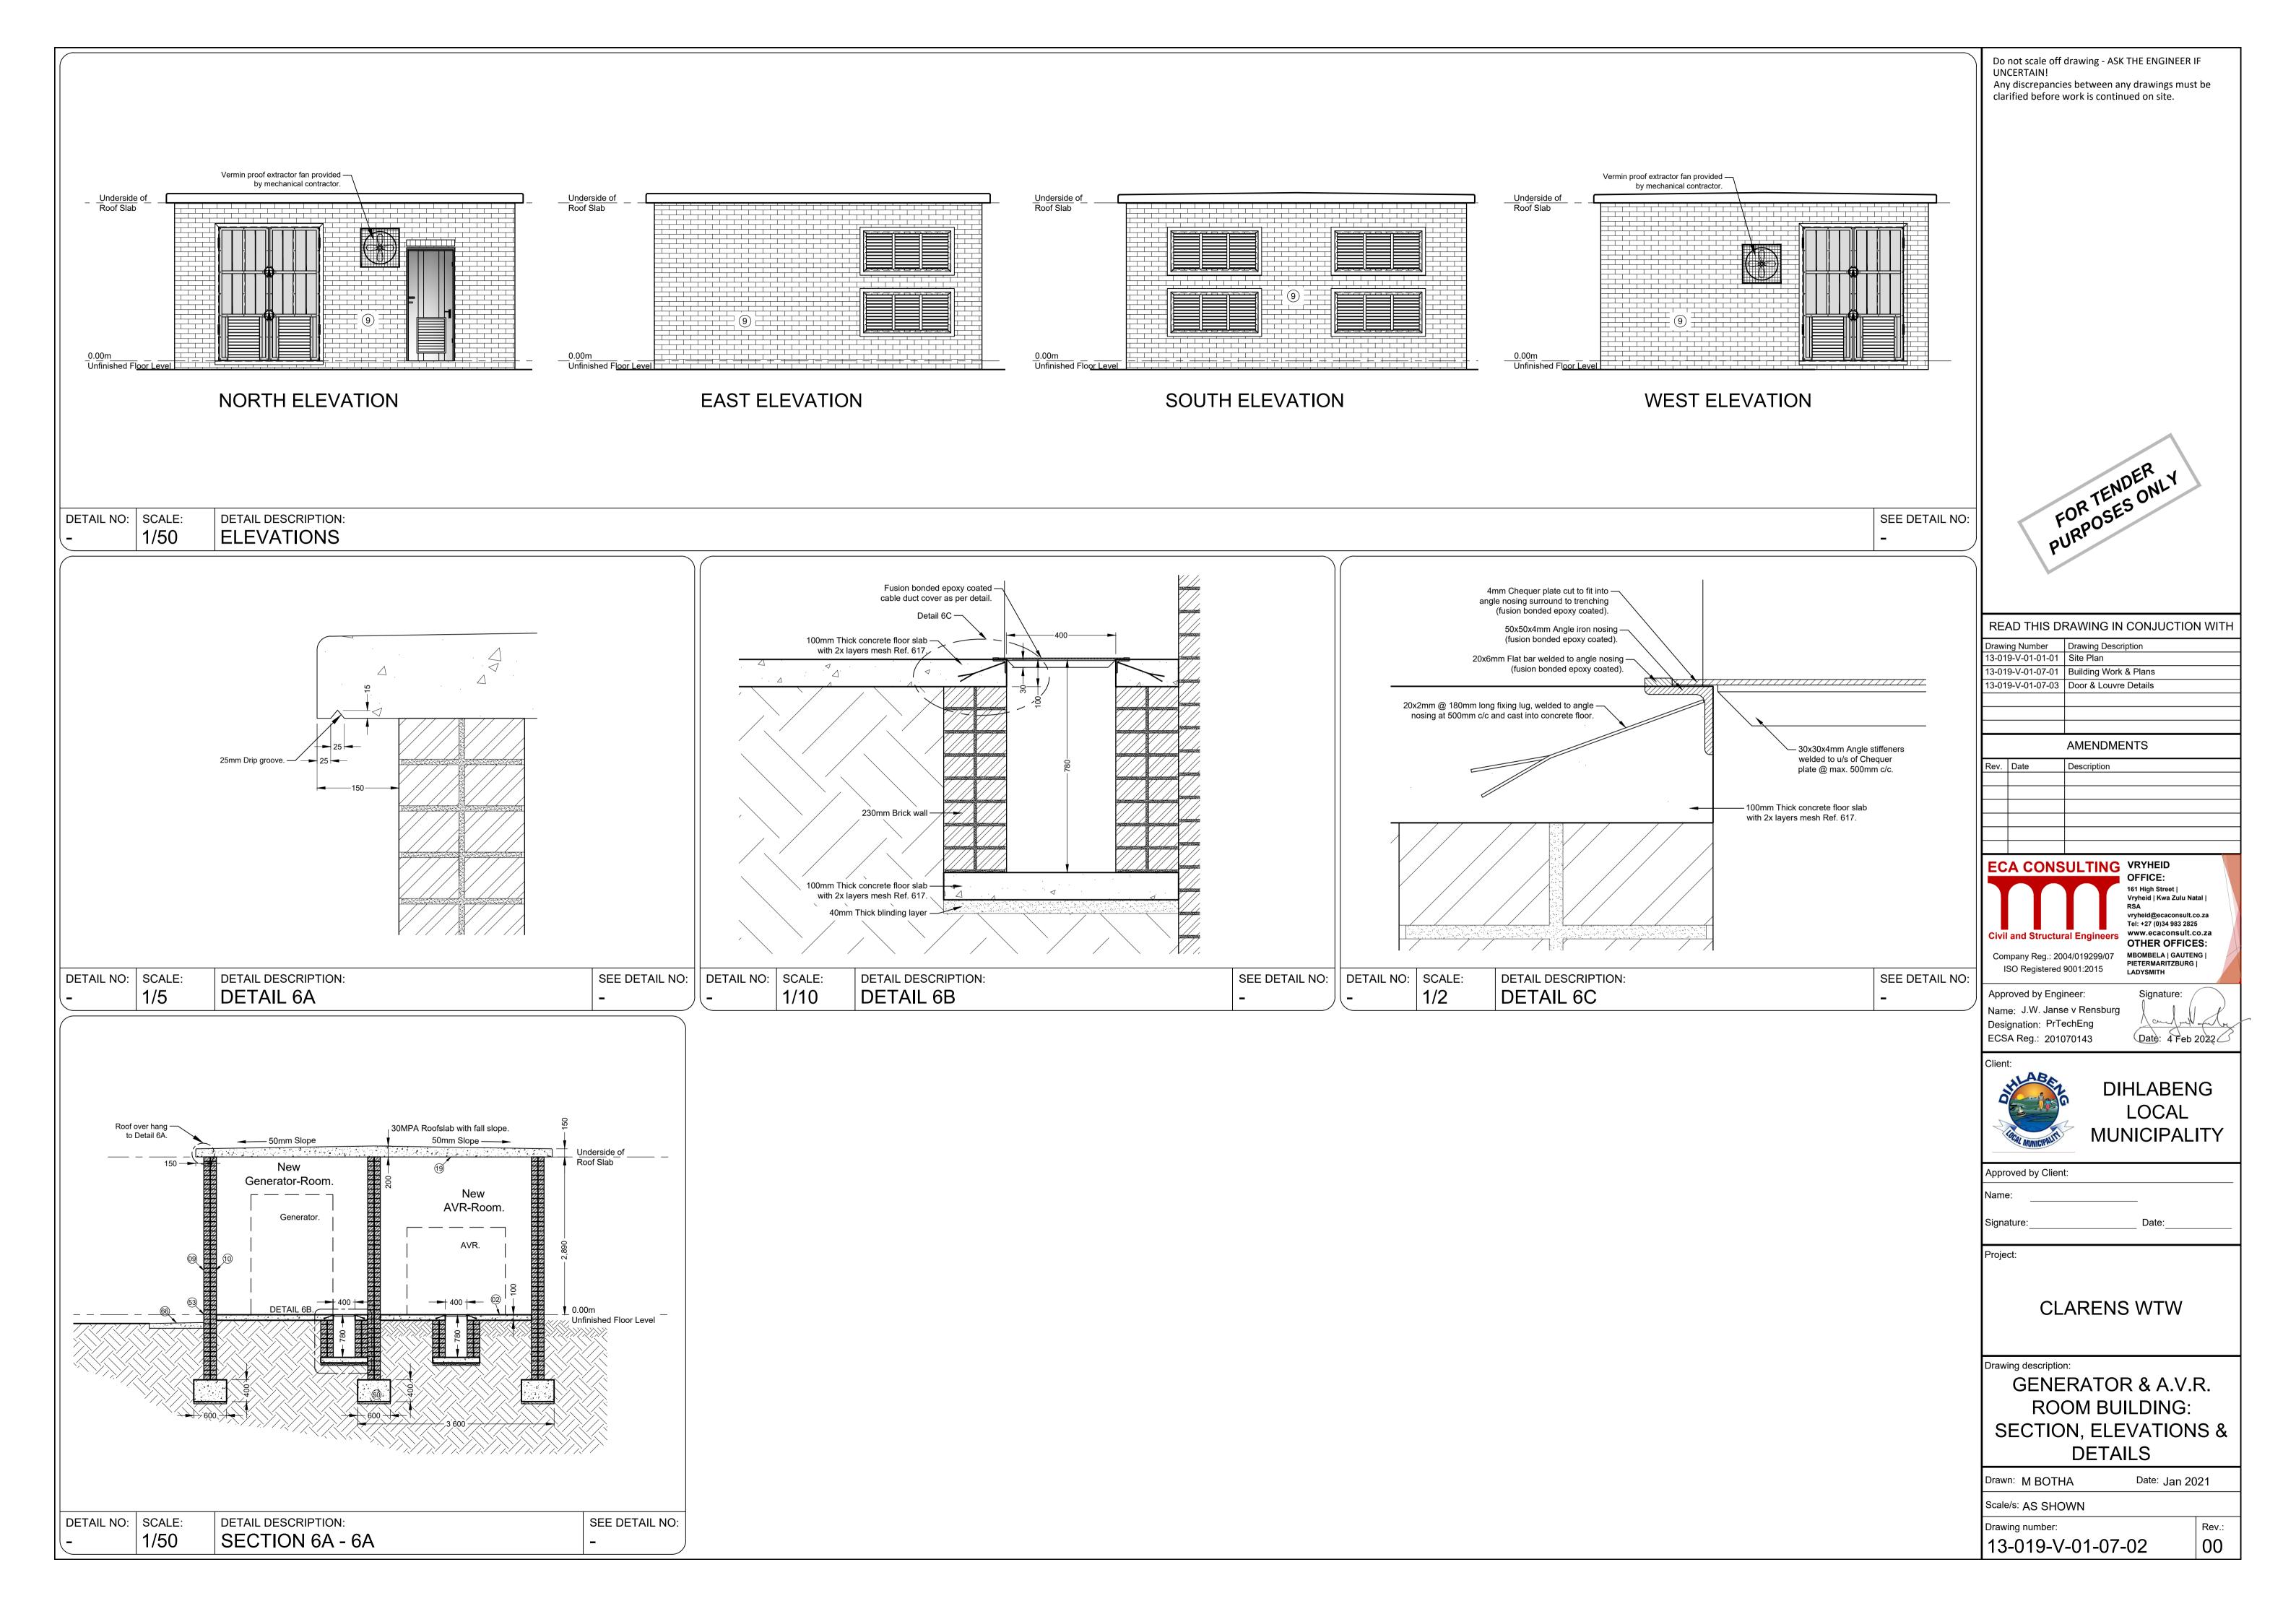

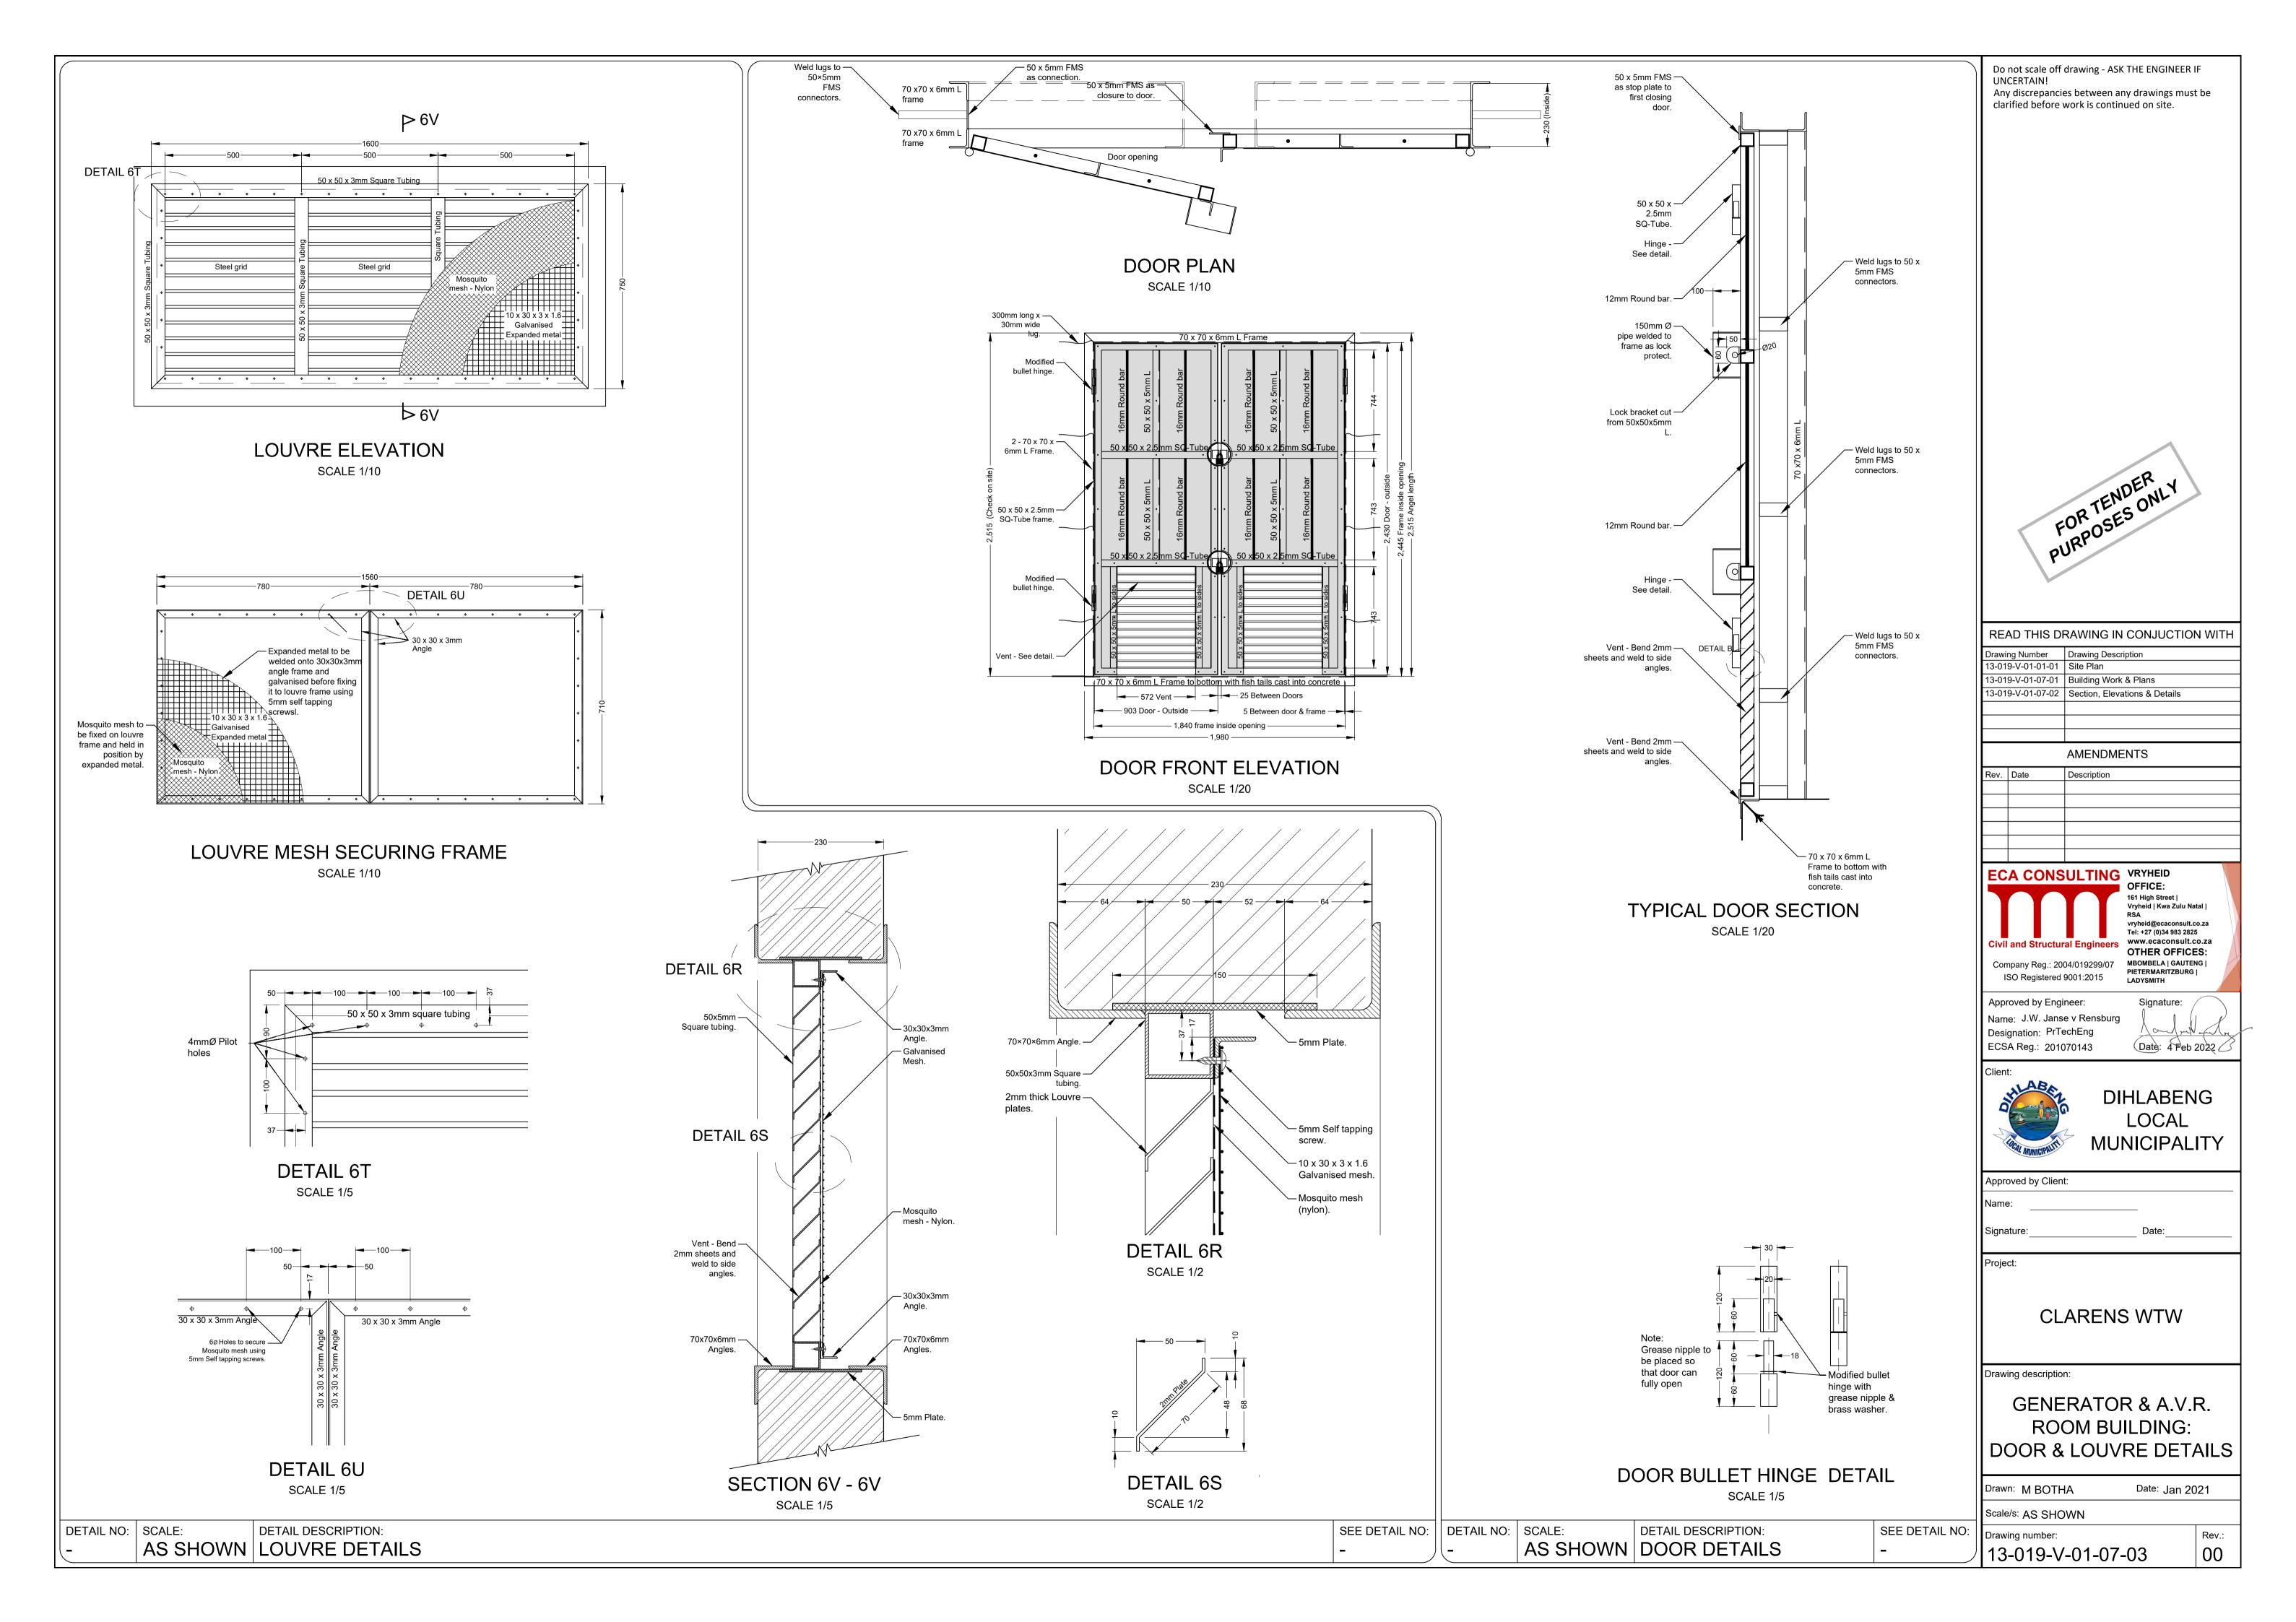

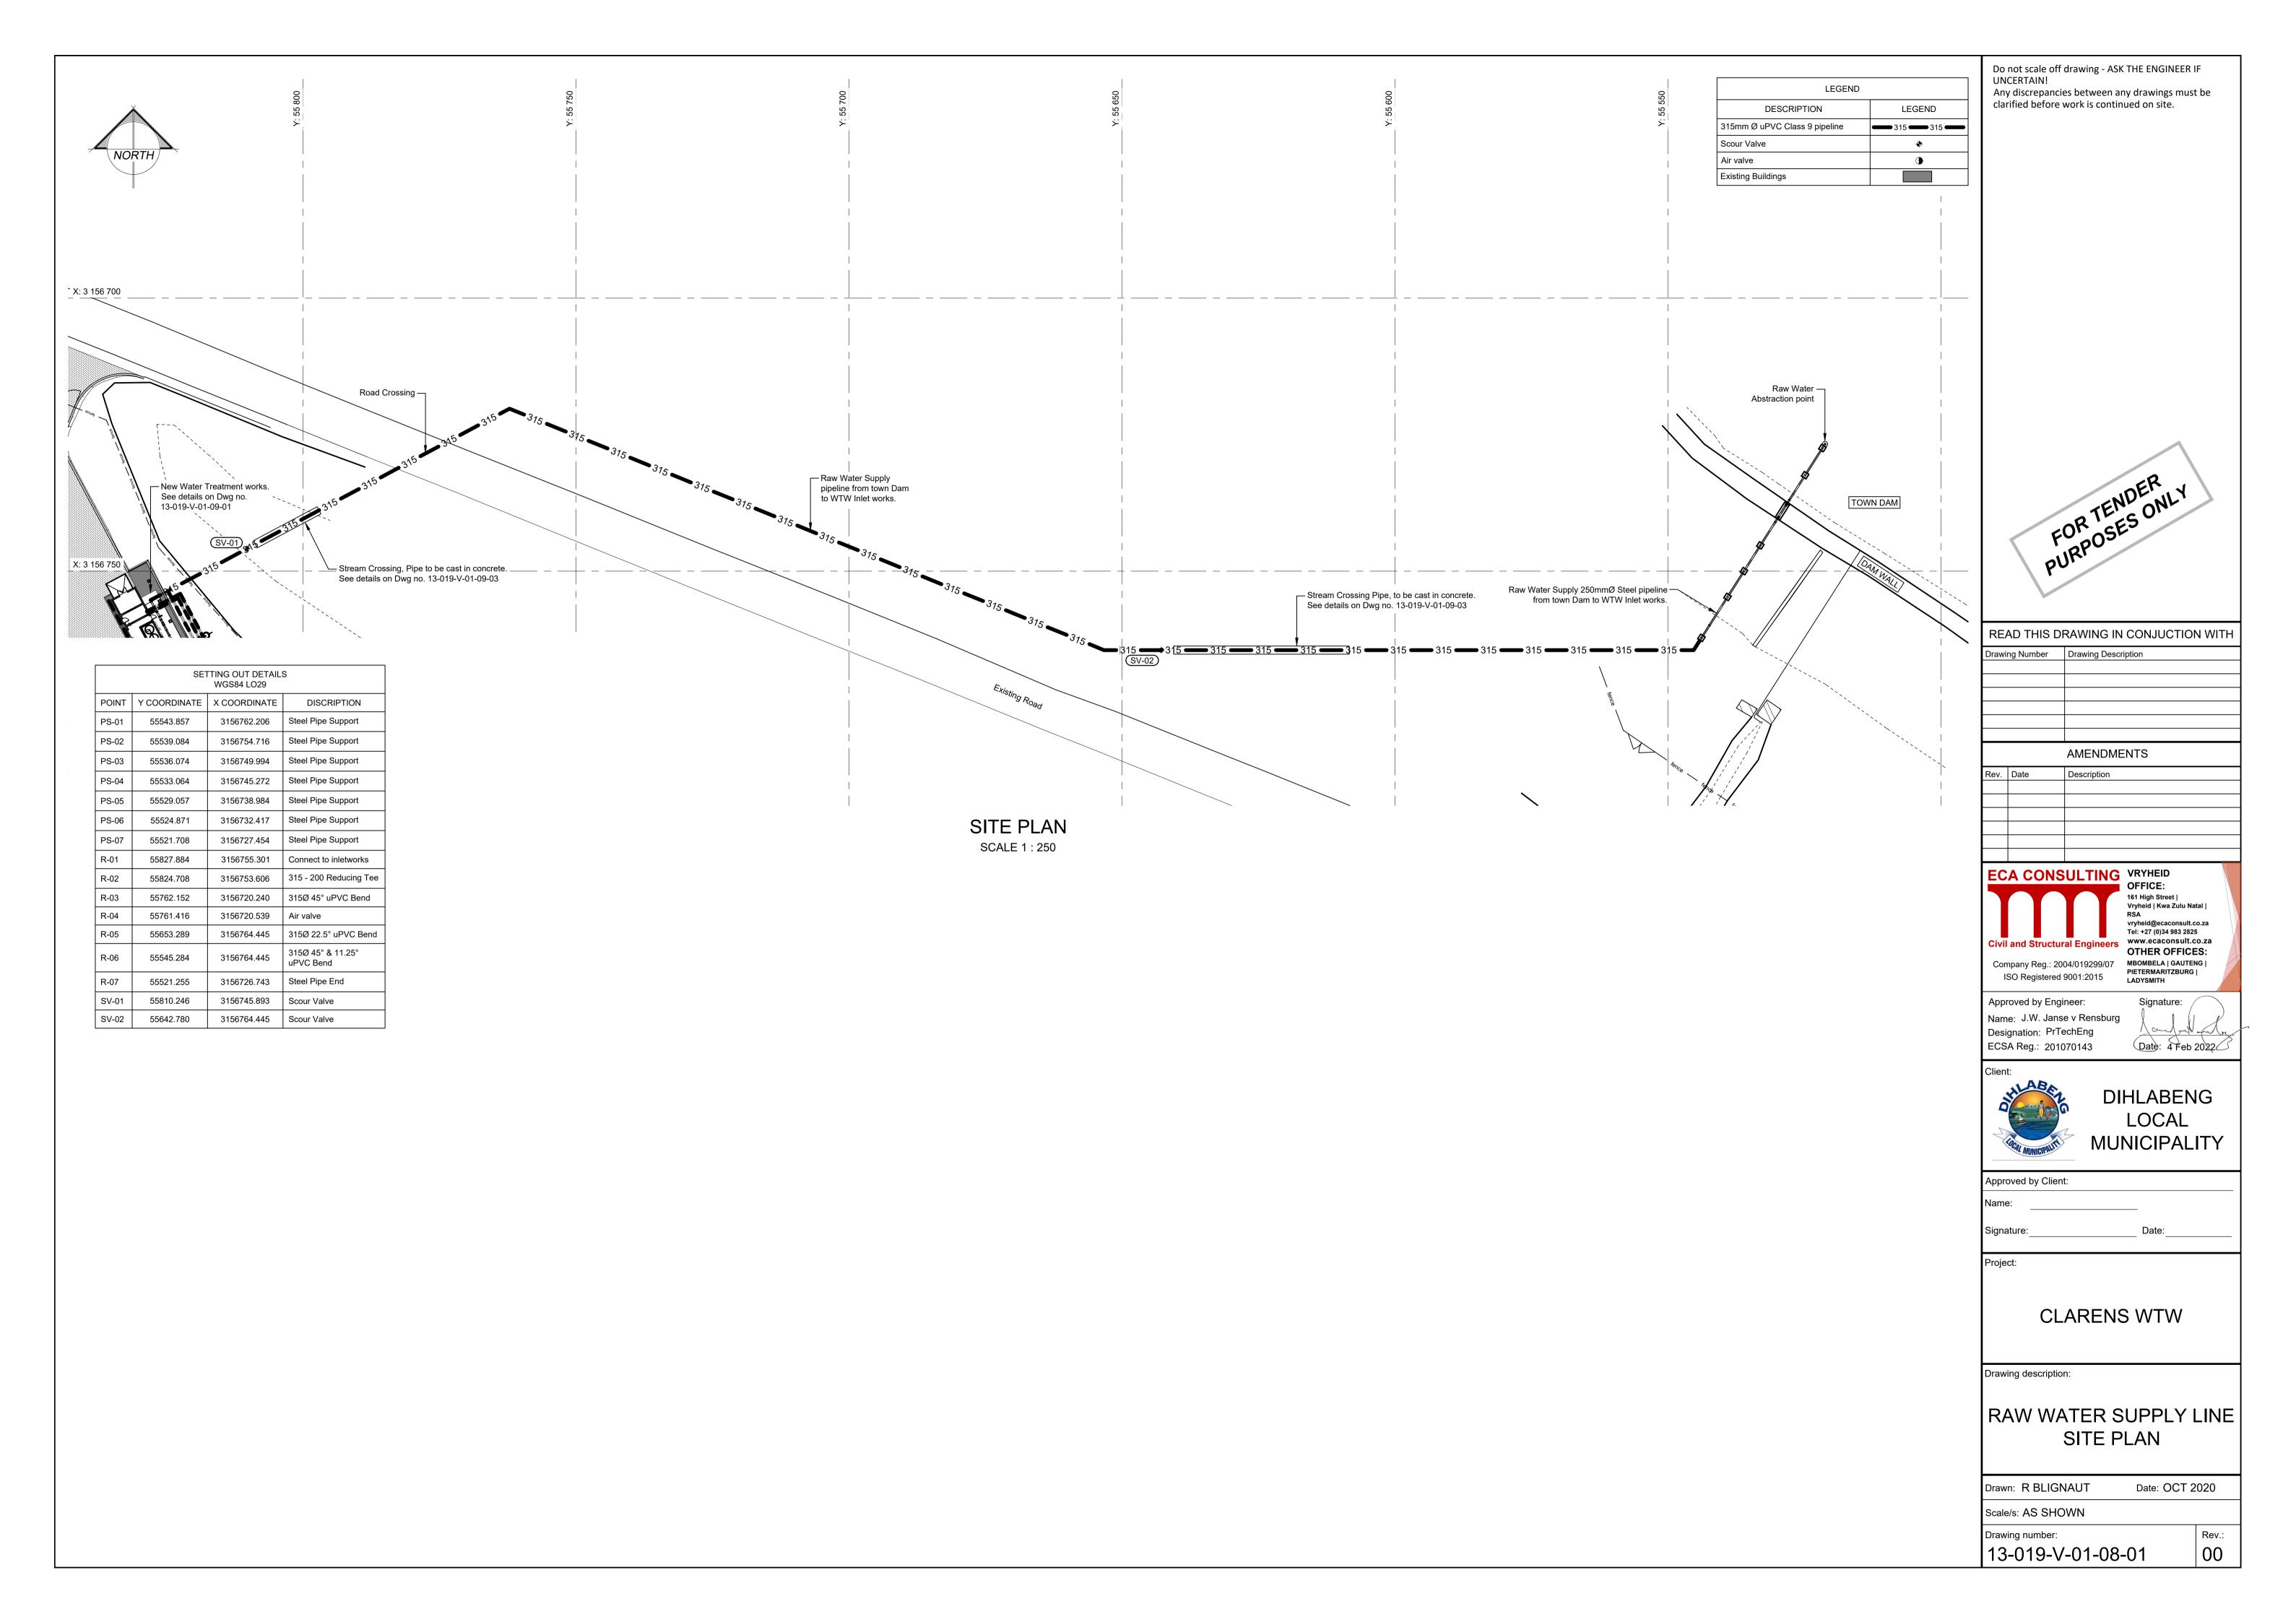

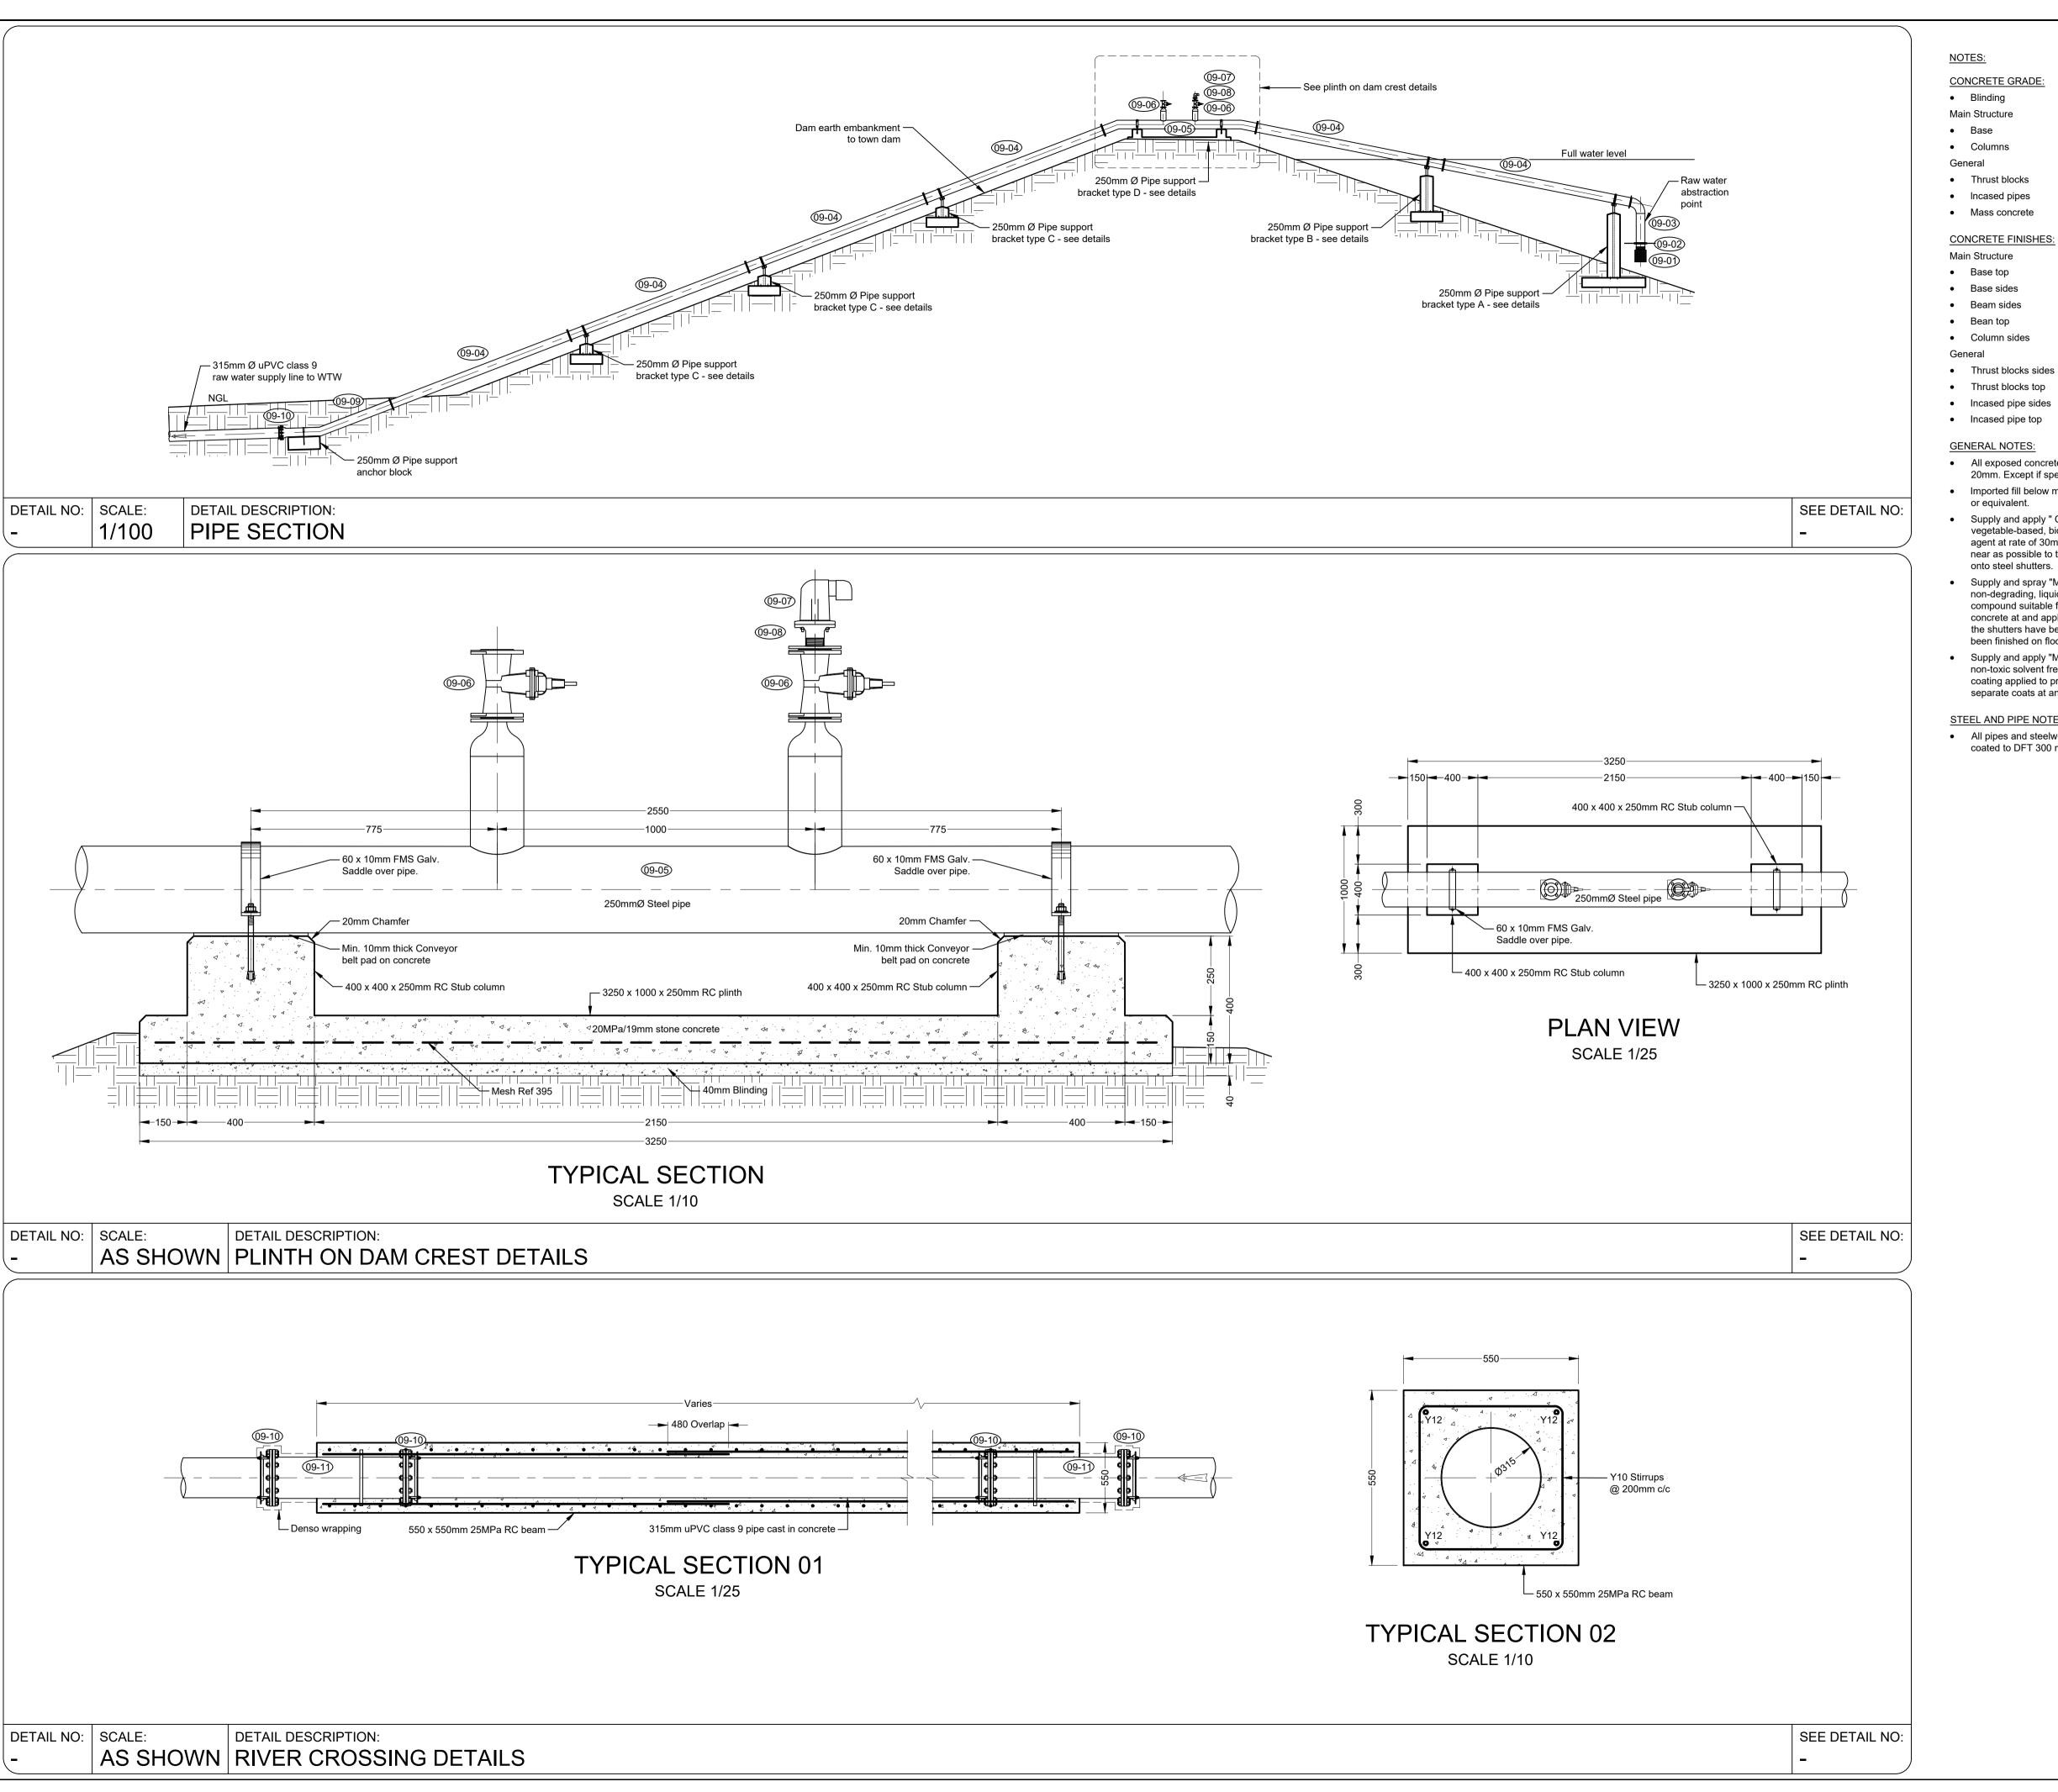

NOTES:

CONCRETE GRADE: Blinding

Main Structure Base

 Columns 25MPa / 19mm General 15MPa / 19mm Thrust blocks

25MPa / 19mm Incased pipes Mass concrete 15MPa / 19mm

15MPa / 13mm

25MPa / 19mm

CONCRETE FINISHES:

Main Structure Base top F2 Beam sides

 Bean top F2 Column sides General

 Thrust blocks sides Thrust blocks top Incased pipe sides

GENERAL NOTES:

- All exposed concrete edges to be chamfered 20mm x
- 20mm. Except if specified differently. Imported fill below main structure to be at least Grade G5
- or equivalent. Supply and apply " Chryso Dem 10" or similar approved vegetable-based, biodegradable and non toxic release agent at rate of 30m² / liter as thinly as possible and as near as possible to time of concreting. Preferably sprayed
- Supply and spray "MasterKure 181" or similar approved non-degrading, liquid based on Pliolite Resin curing compound suitable for spray application to freshly poured concrete at and application rate of 6m² / liter as soon as the shutters have been stripped or as soon as floating has been finished on floor surfaces.
- Supply and apply "Master Protect 480" or similar approved non-toxic solvent free high build, protective epoxy resin coating applied to prepared concrete surface in two separate coats at an application rate of 5m² / liter per coat.

STEEL AND PIPE NOTES:

 All pipes and steelwork shall be fusion bonded epoxy coated to DFT 300 micron thick unless indicated otherwise Do not scale off drawing - ASK THE ENGINEER IF Any discrepancies between any drawings must be clarified before work is continued on site.



RE	AD THIS D	PRAWING IN CONJUCTION WITH		
Drawi	ing Number	Drawing Description		
		AMENDMENTS		
Rev.	Date	AMENDMENTS Description		
Rev.	Date			

Approved by Engineer: Name: J.W. Janse v Rensburg Designation: PrTechEng Date: 4 Feb 2022 ECSA Reg.: 201070143

vryheid@ecaconsult.co.za Tel: +27 (0)34 983 2825




Approved by Client:

CLARENS WTW

Drawing description:

RAW WATER SUPPLY LINE: **SECTION & DETAILS**


Date: Jan 2021 Drawn: M BOTHA Scale/s: AS SHOWN Drawing number: 13-019-V-01-09-01

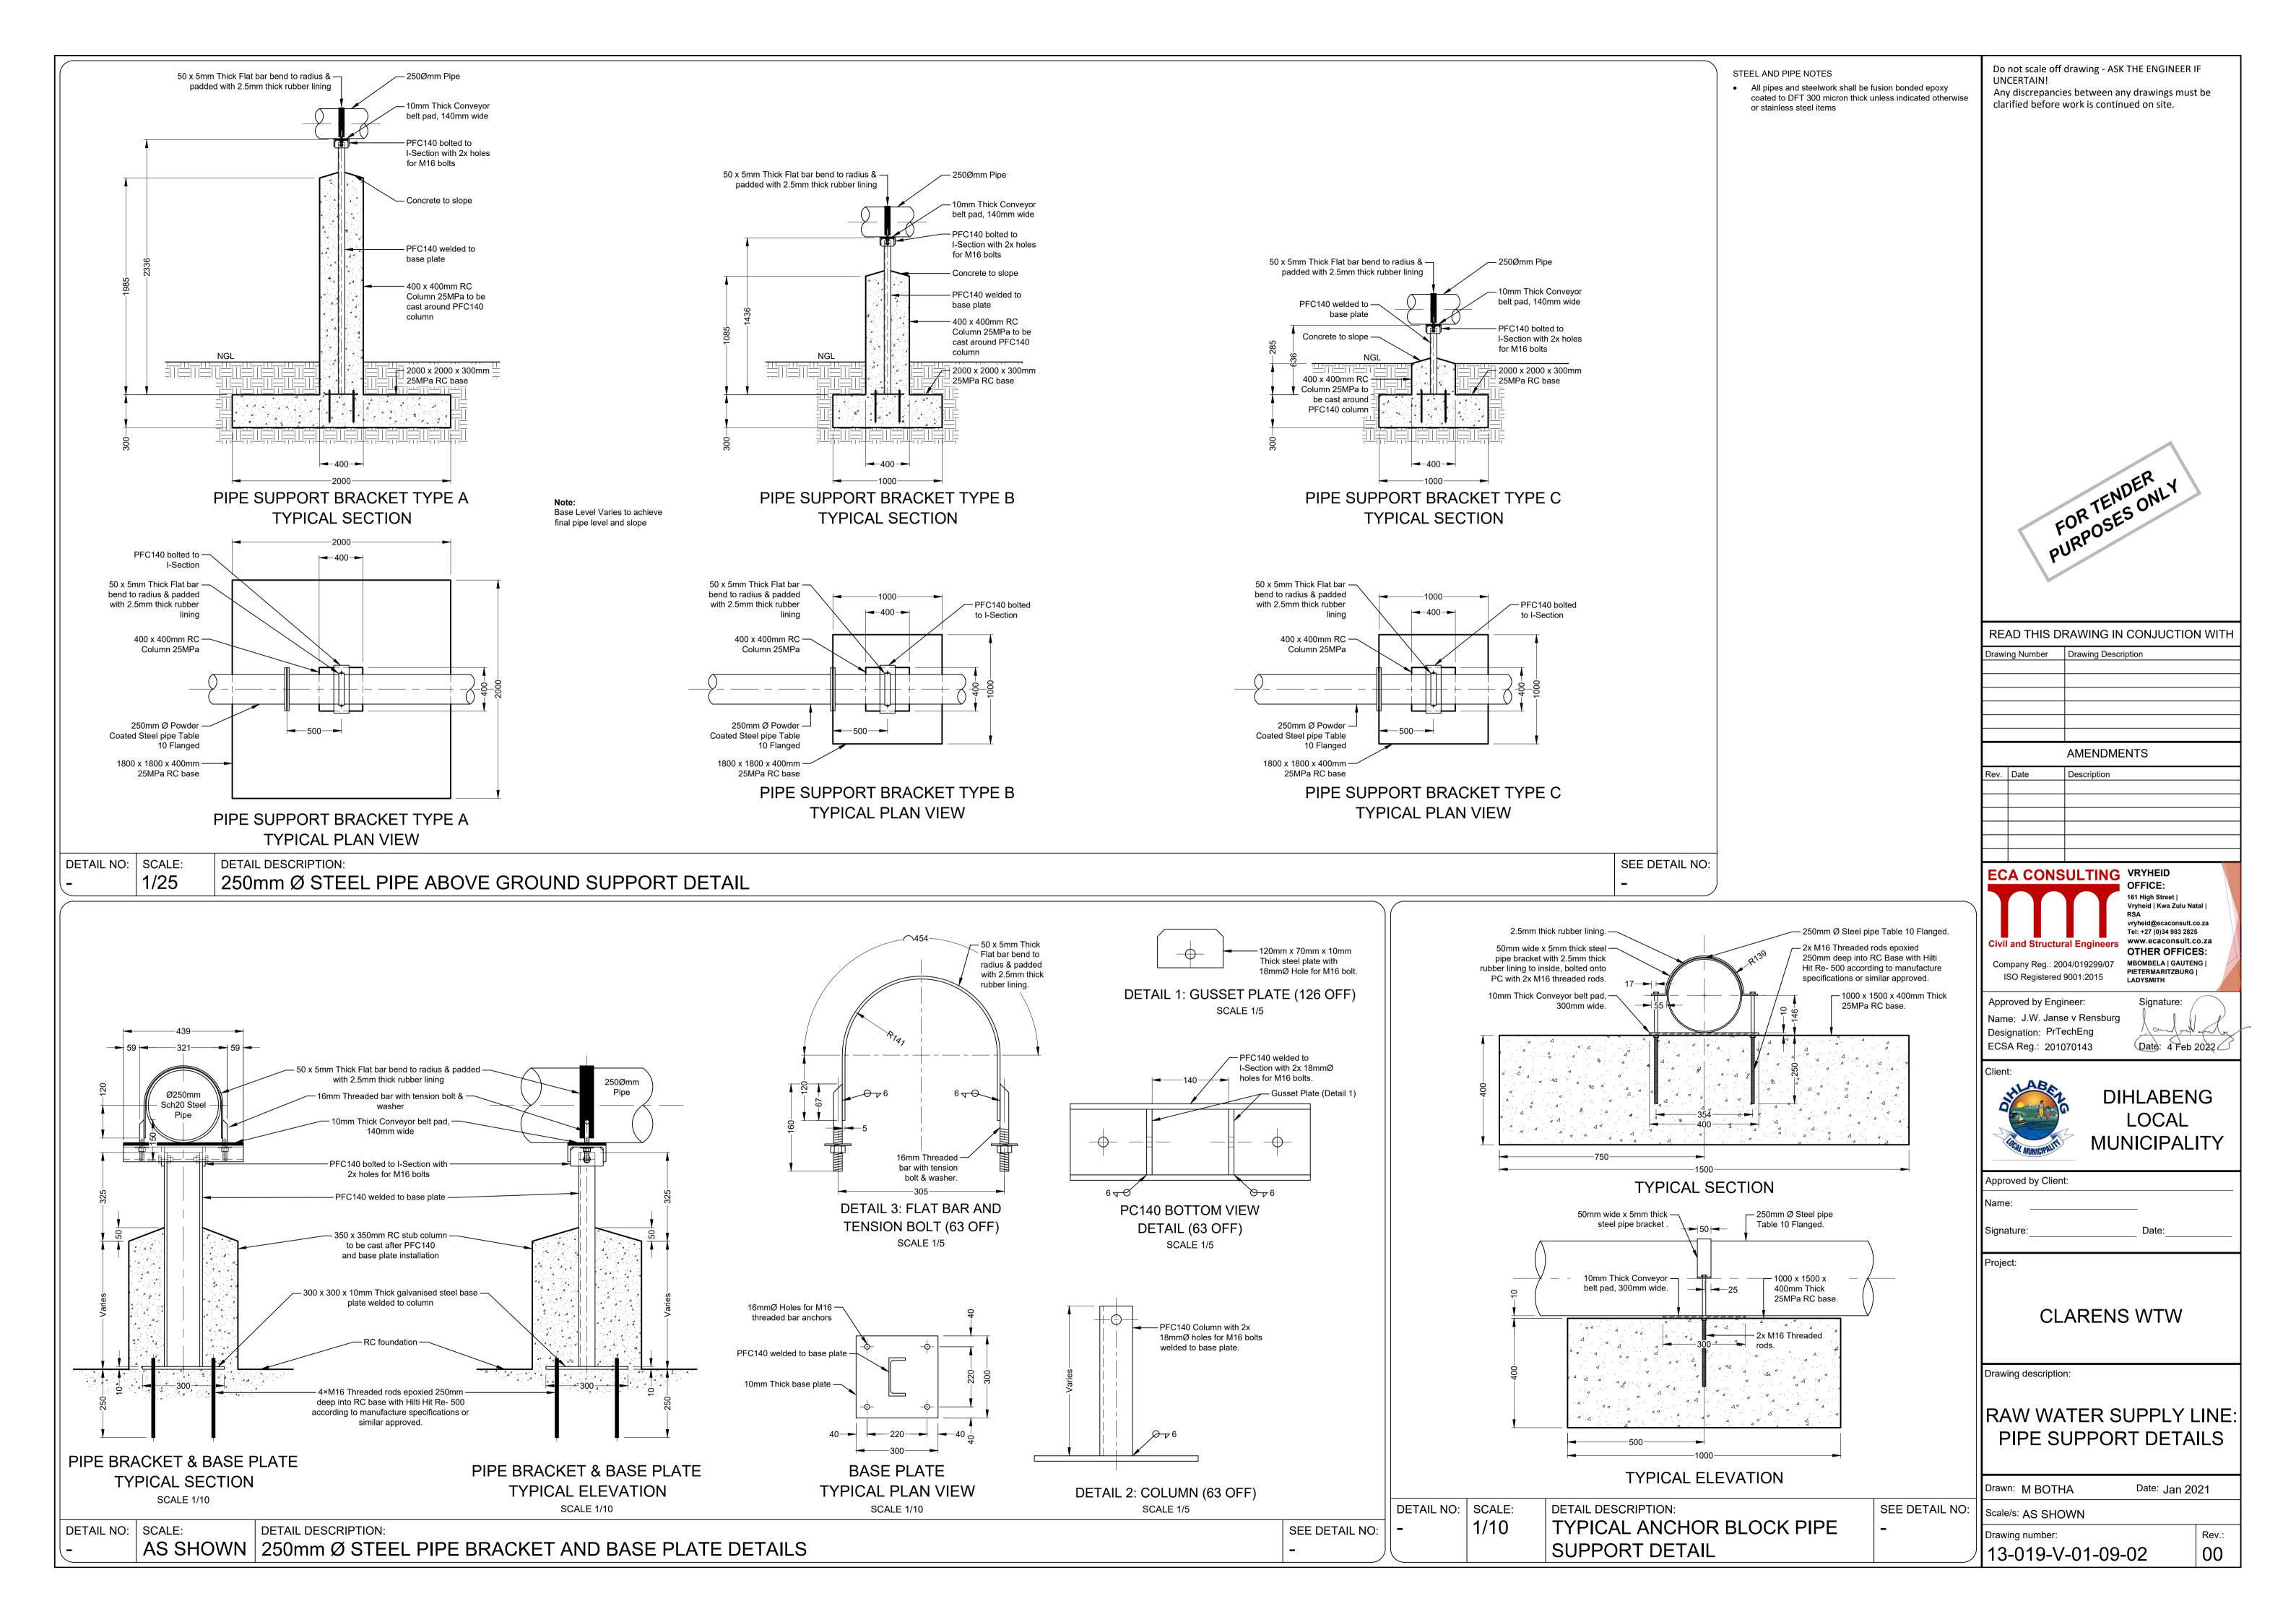

		ı		
Item No.	No Off.	Dia(mm) ND	Description	Drawing
09-01	01	250Ø	250mm Ø Suction strainer, T10 flanged.	
09-02	01	250Ø - 700Ø	250 - 700mm Ø x 5mm thick collar. Holes to be drilled to 250mmØ T10 flange.	Ø ₁₀₀₀
09-03	01	250Ø	250mmØ Straight, with 79° long radius bend, T10 flanged.	1295
09-04	06	250Ø	250mmØ Straight, T10 flanged.	6000
09-05	01	250Ø	250mmØ Straight with 1x 21° bend, 1x 11° bend and 2x 150mmØ branches complete with 2x 150 to 50mmØ reducers, all T10 flanges.	1455
09-06	02	50Ø	50mm Ø RSV Gate Valve to SANS 664, T10 flanged.	-114-
09-07	01	50Ø	50mm Ø D-040-C x 2" cast iron body ARI air release valve. (valve should only release air from system and prevent air from entering	₽
09-08	01	80Ø	80mm Ø T10 Blanked flange with 1" female threaded steam socket	
09-09	01	250Ø - 300Ø	250mmØ Straight with 250 to 300mmØ reducer, T10 flanged.	1148 2400
09-10	09	300Ø	300mm Ø VJ Flange adaptor for uPVC, T10 flanged.	
09-11	04	300Ø	300mmØ Straight with puddle flange, T10 flanged.	


STEEL AND PIPE NOTES

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Approved by Engineer:
Name: J.W. Janse v Rensburg
Designation: PrTechEng

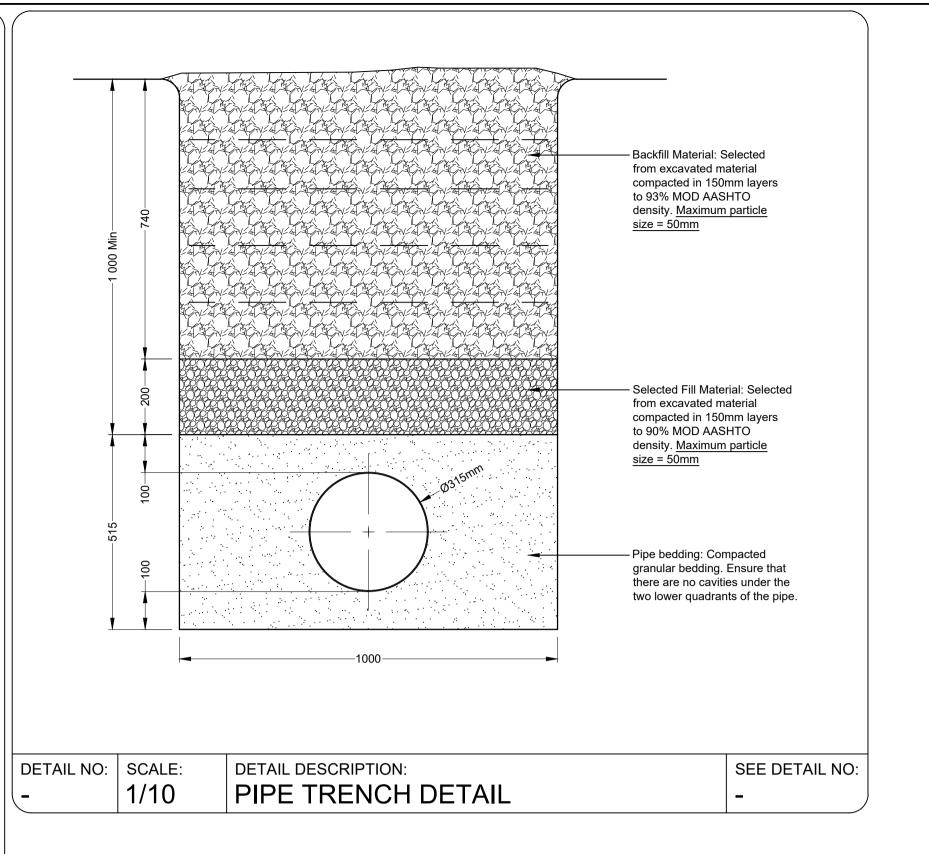ECSA Reg.: 201070143

Signature:

Date: 4 Feb 2022

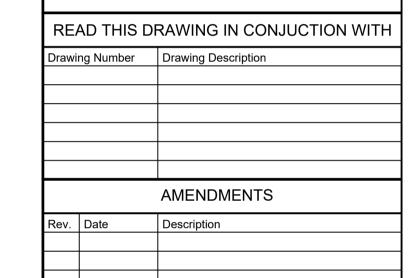DIHLABENG
LOCAL
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Approved by Client:

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Project:


CLARENS WTW


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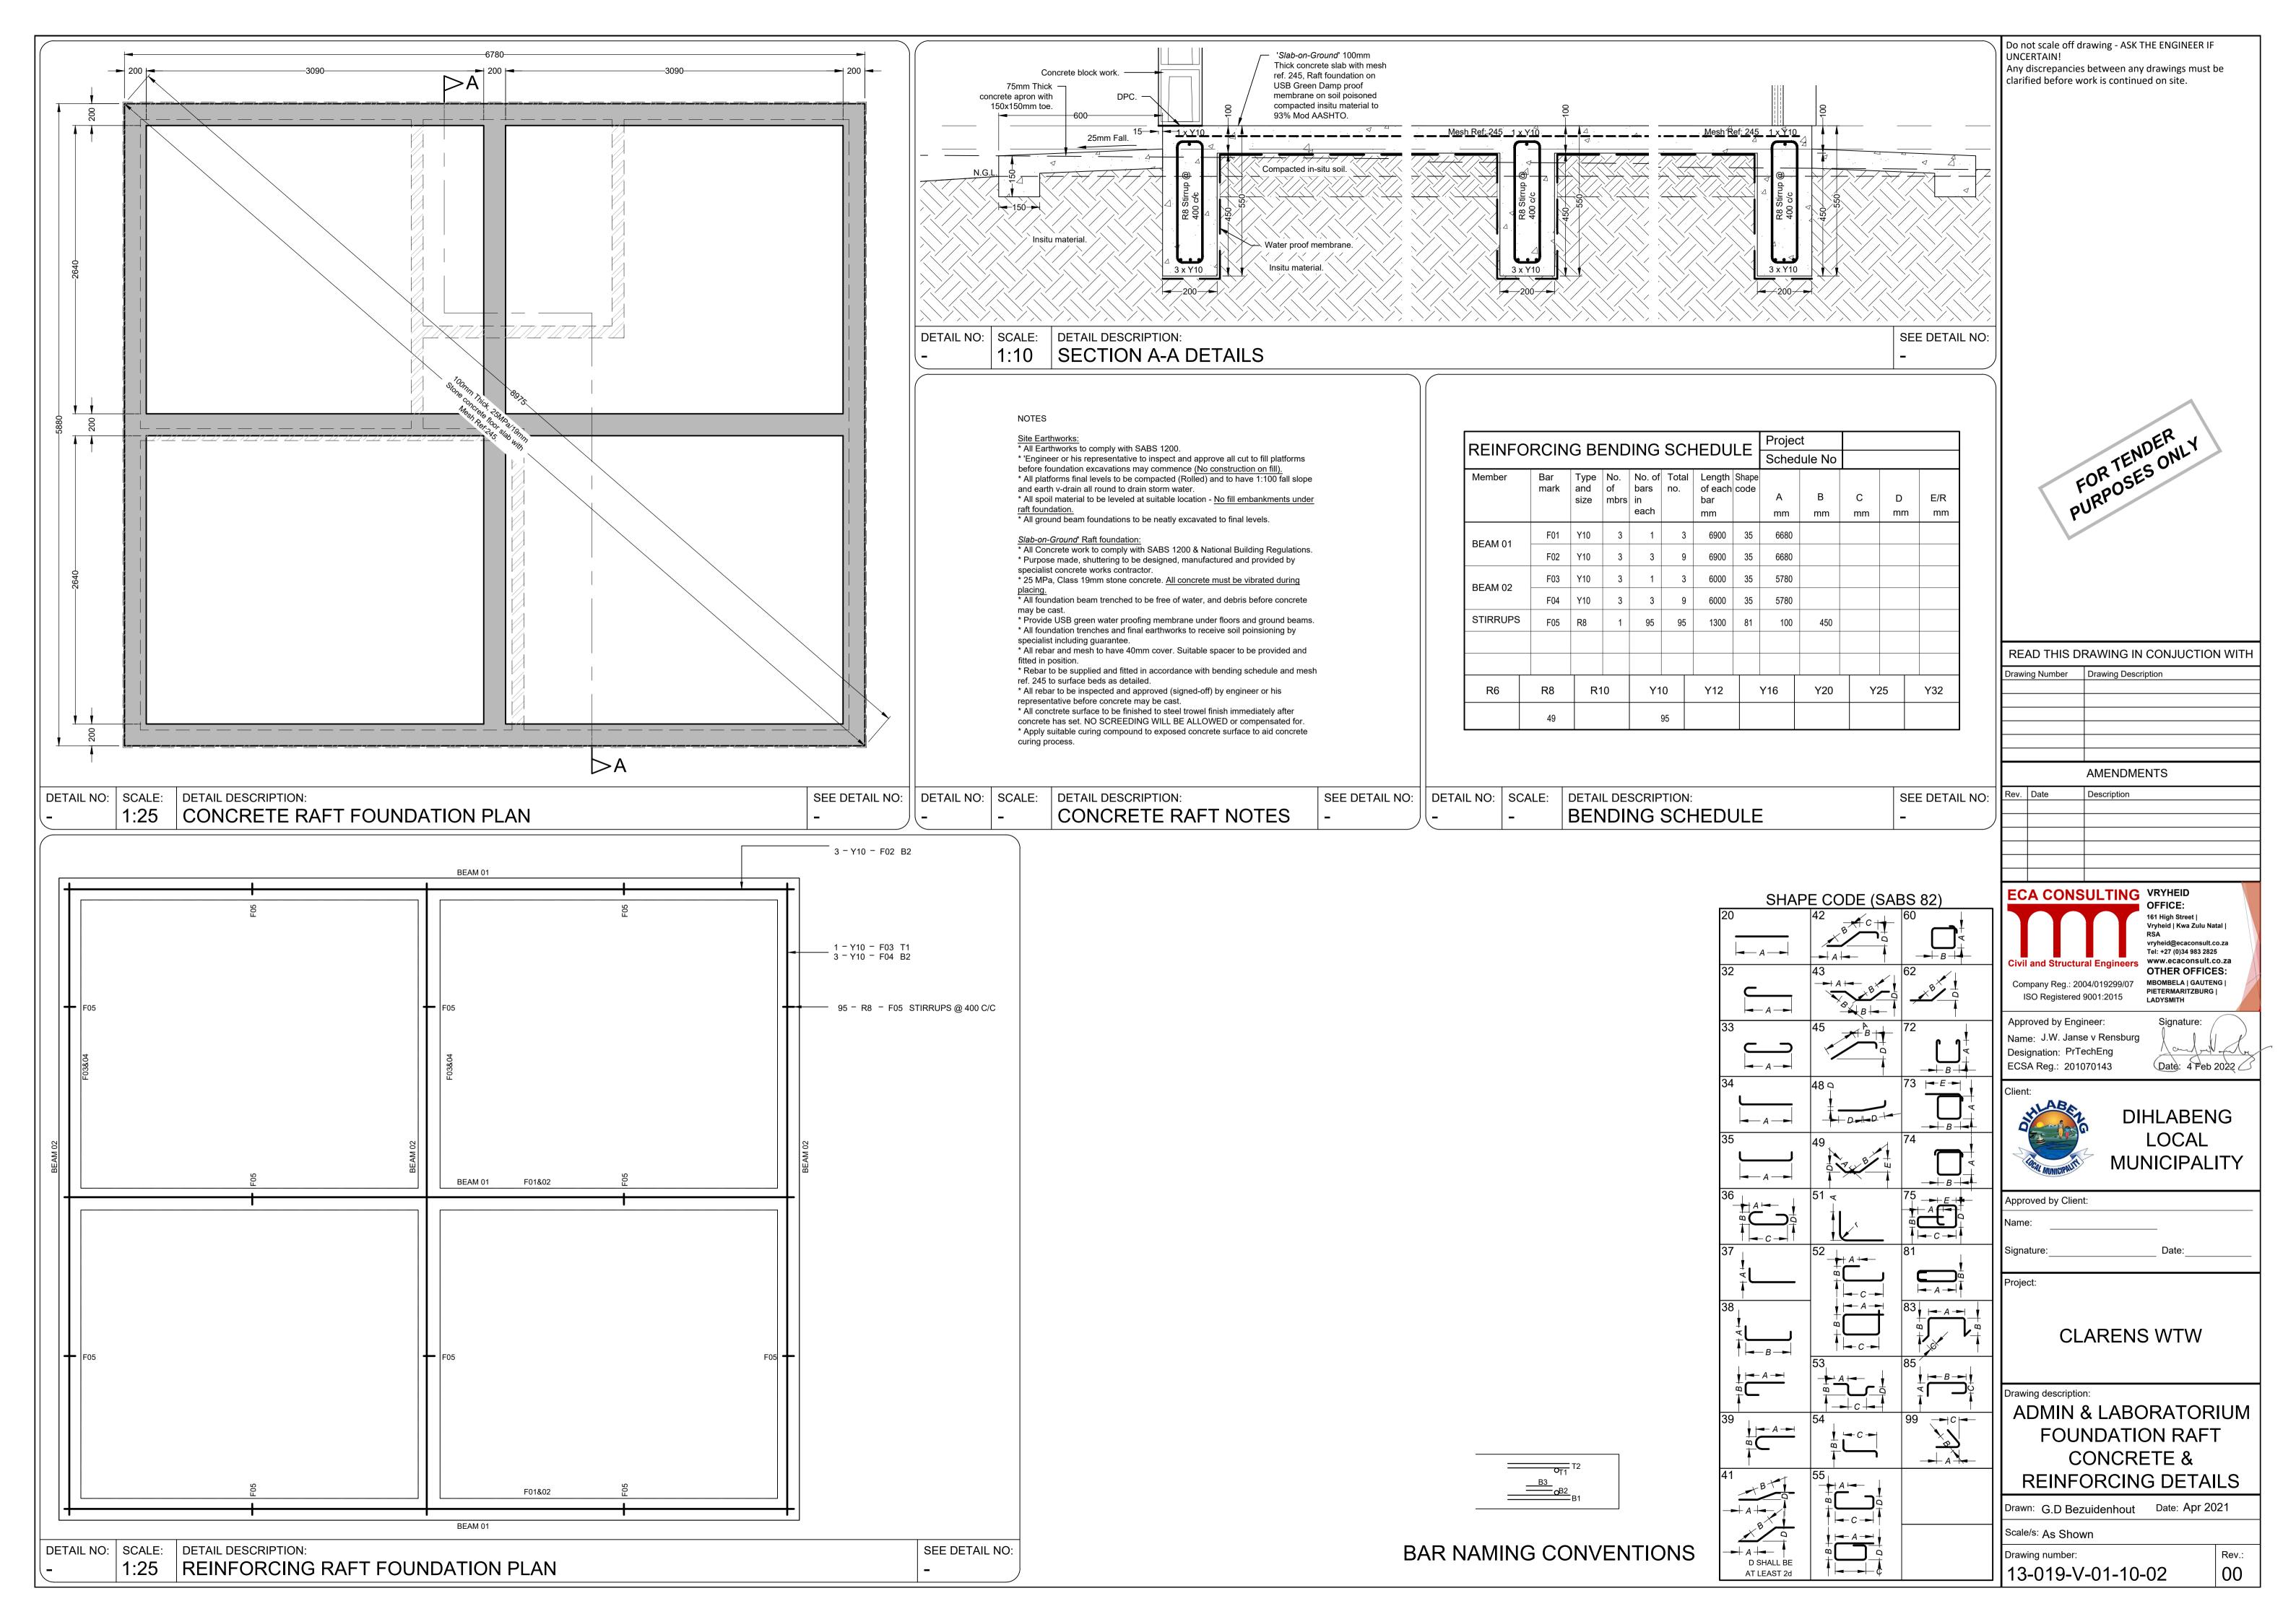
RAW WATER SUPPLY LINE: PIPE SCHEDULE


Drawn: M BOTHA	Date: Jan 20	21	
Scale/s: AS SHOWN			
Drawing number:		Rev.:	
13-019-V-01-09-0	03	00	


DETAIL NO: SCALE: DETAIL DESCRIPTION: SEE DETAIL NO: - 1/50 PIPE SCHEDULE -




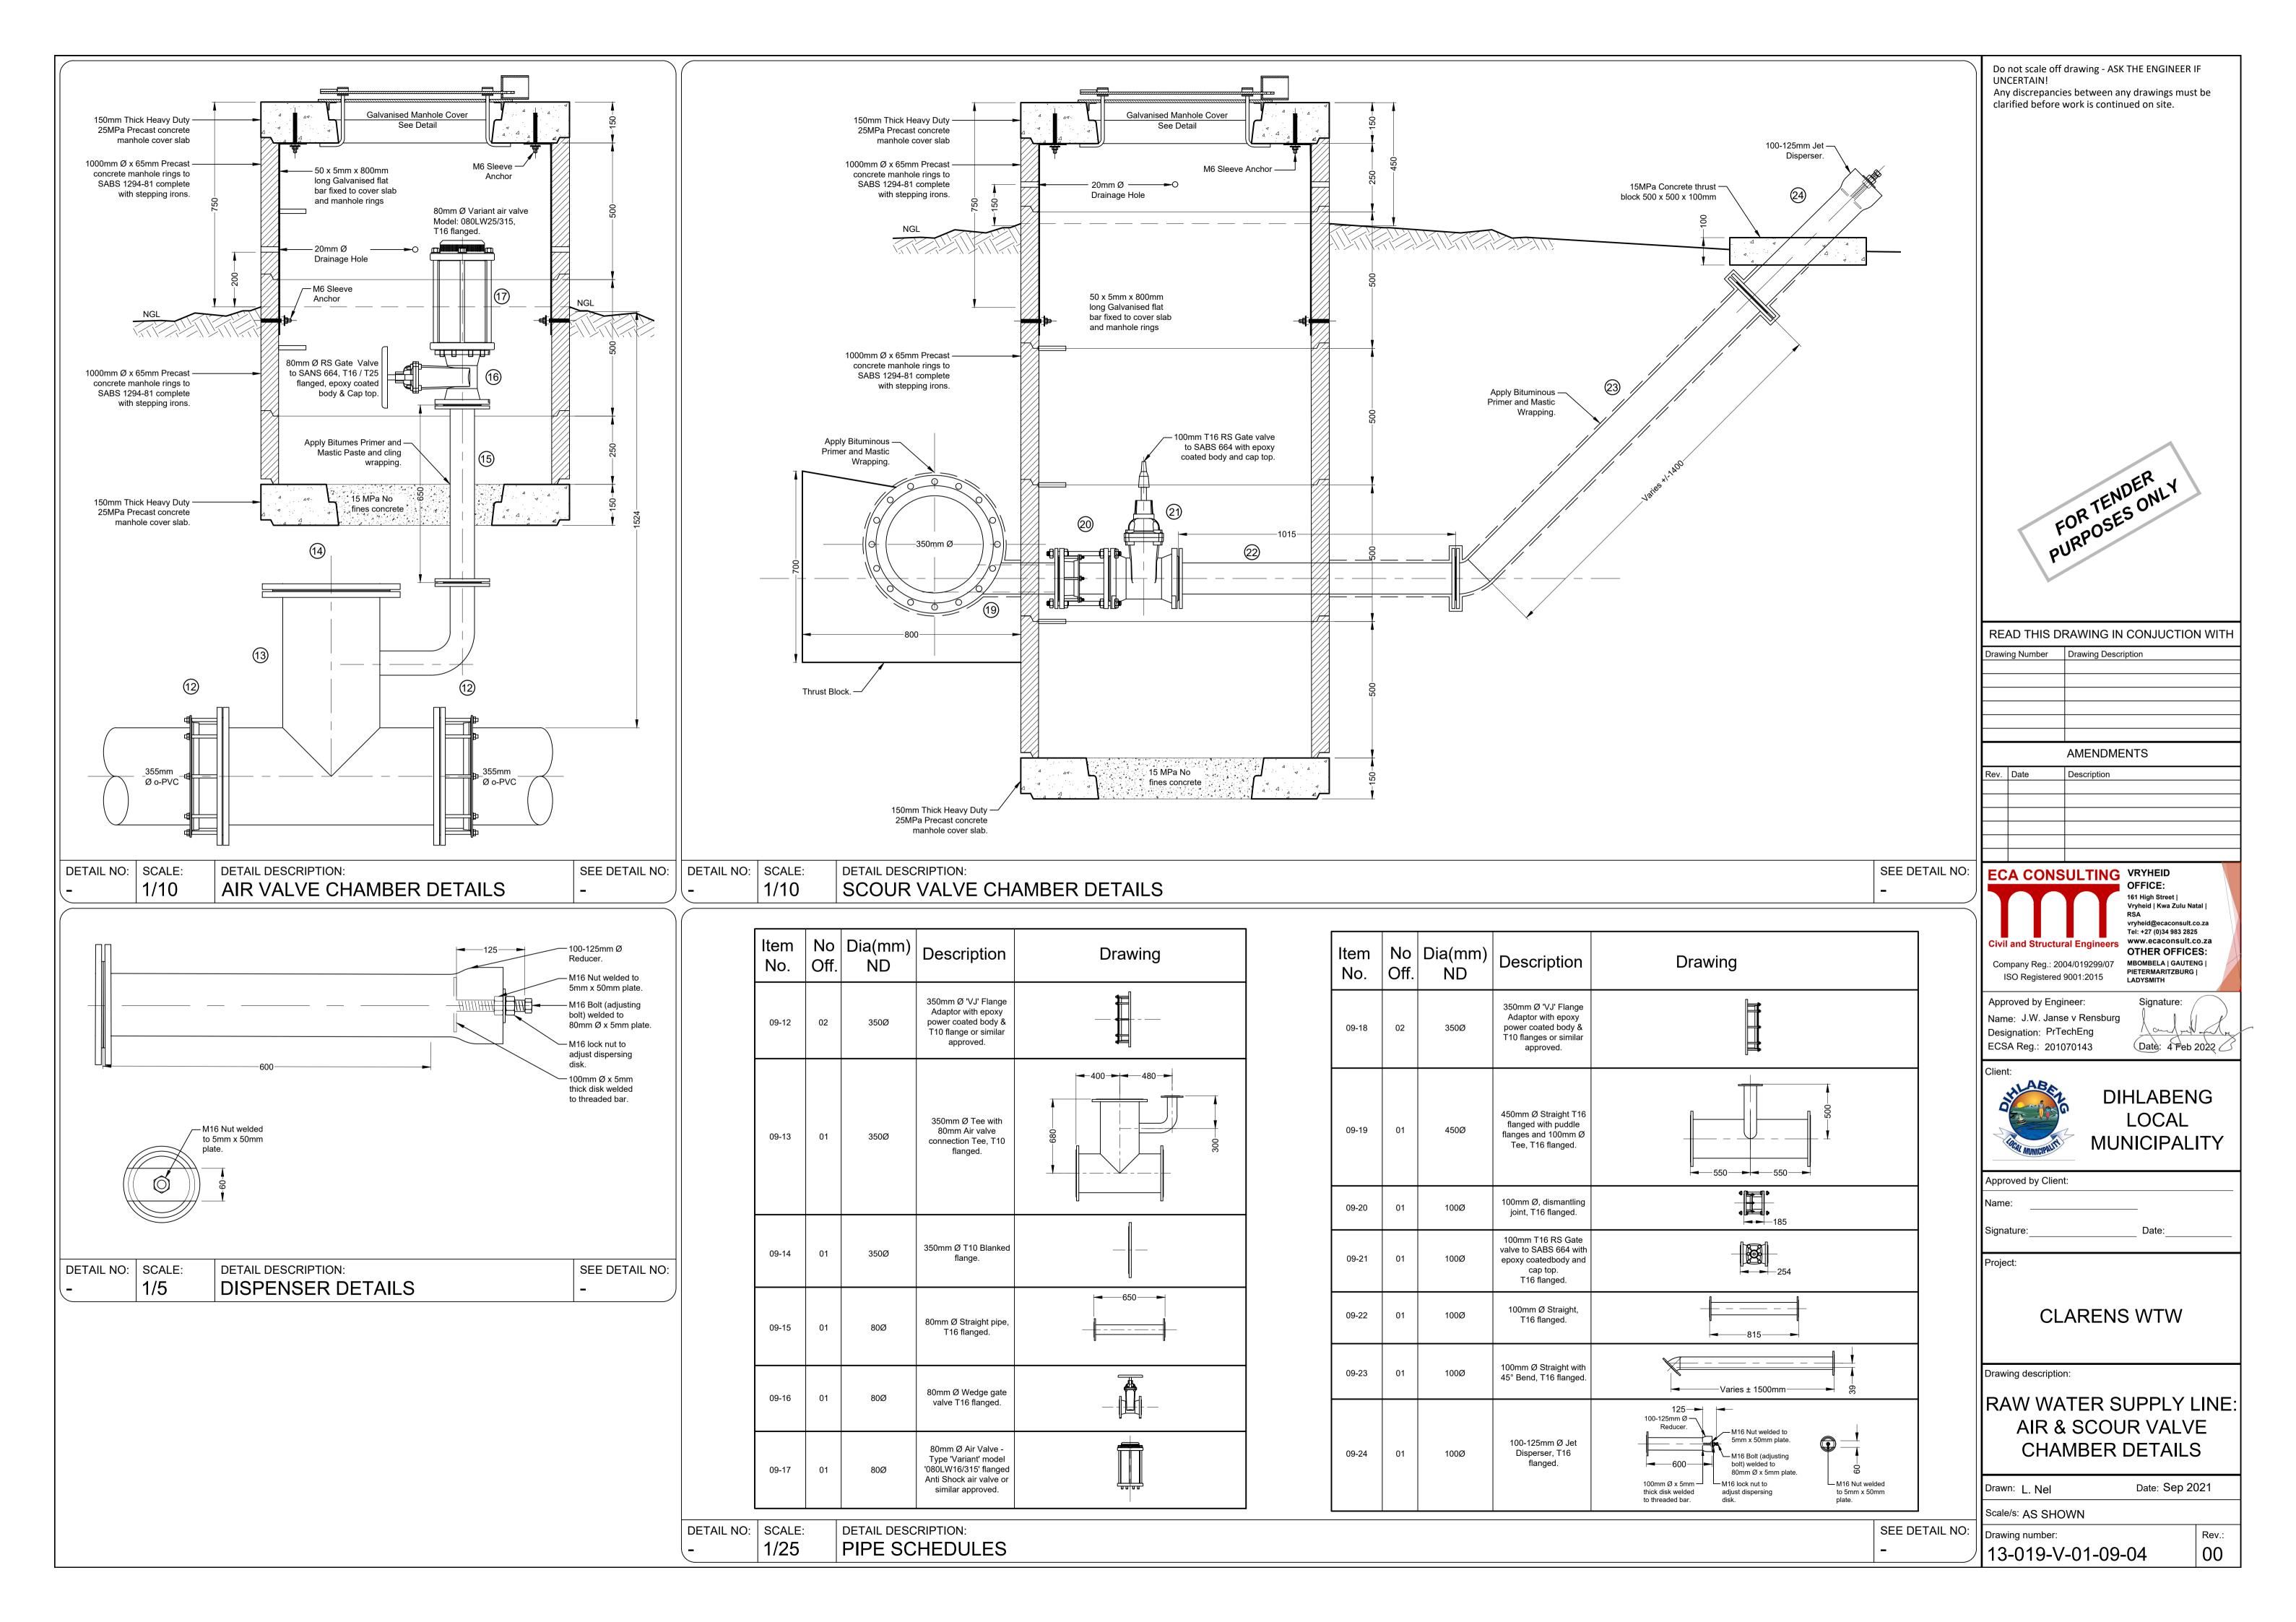


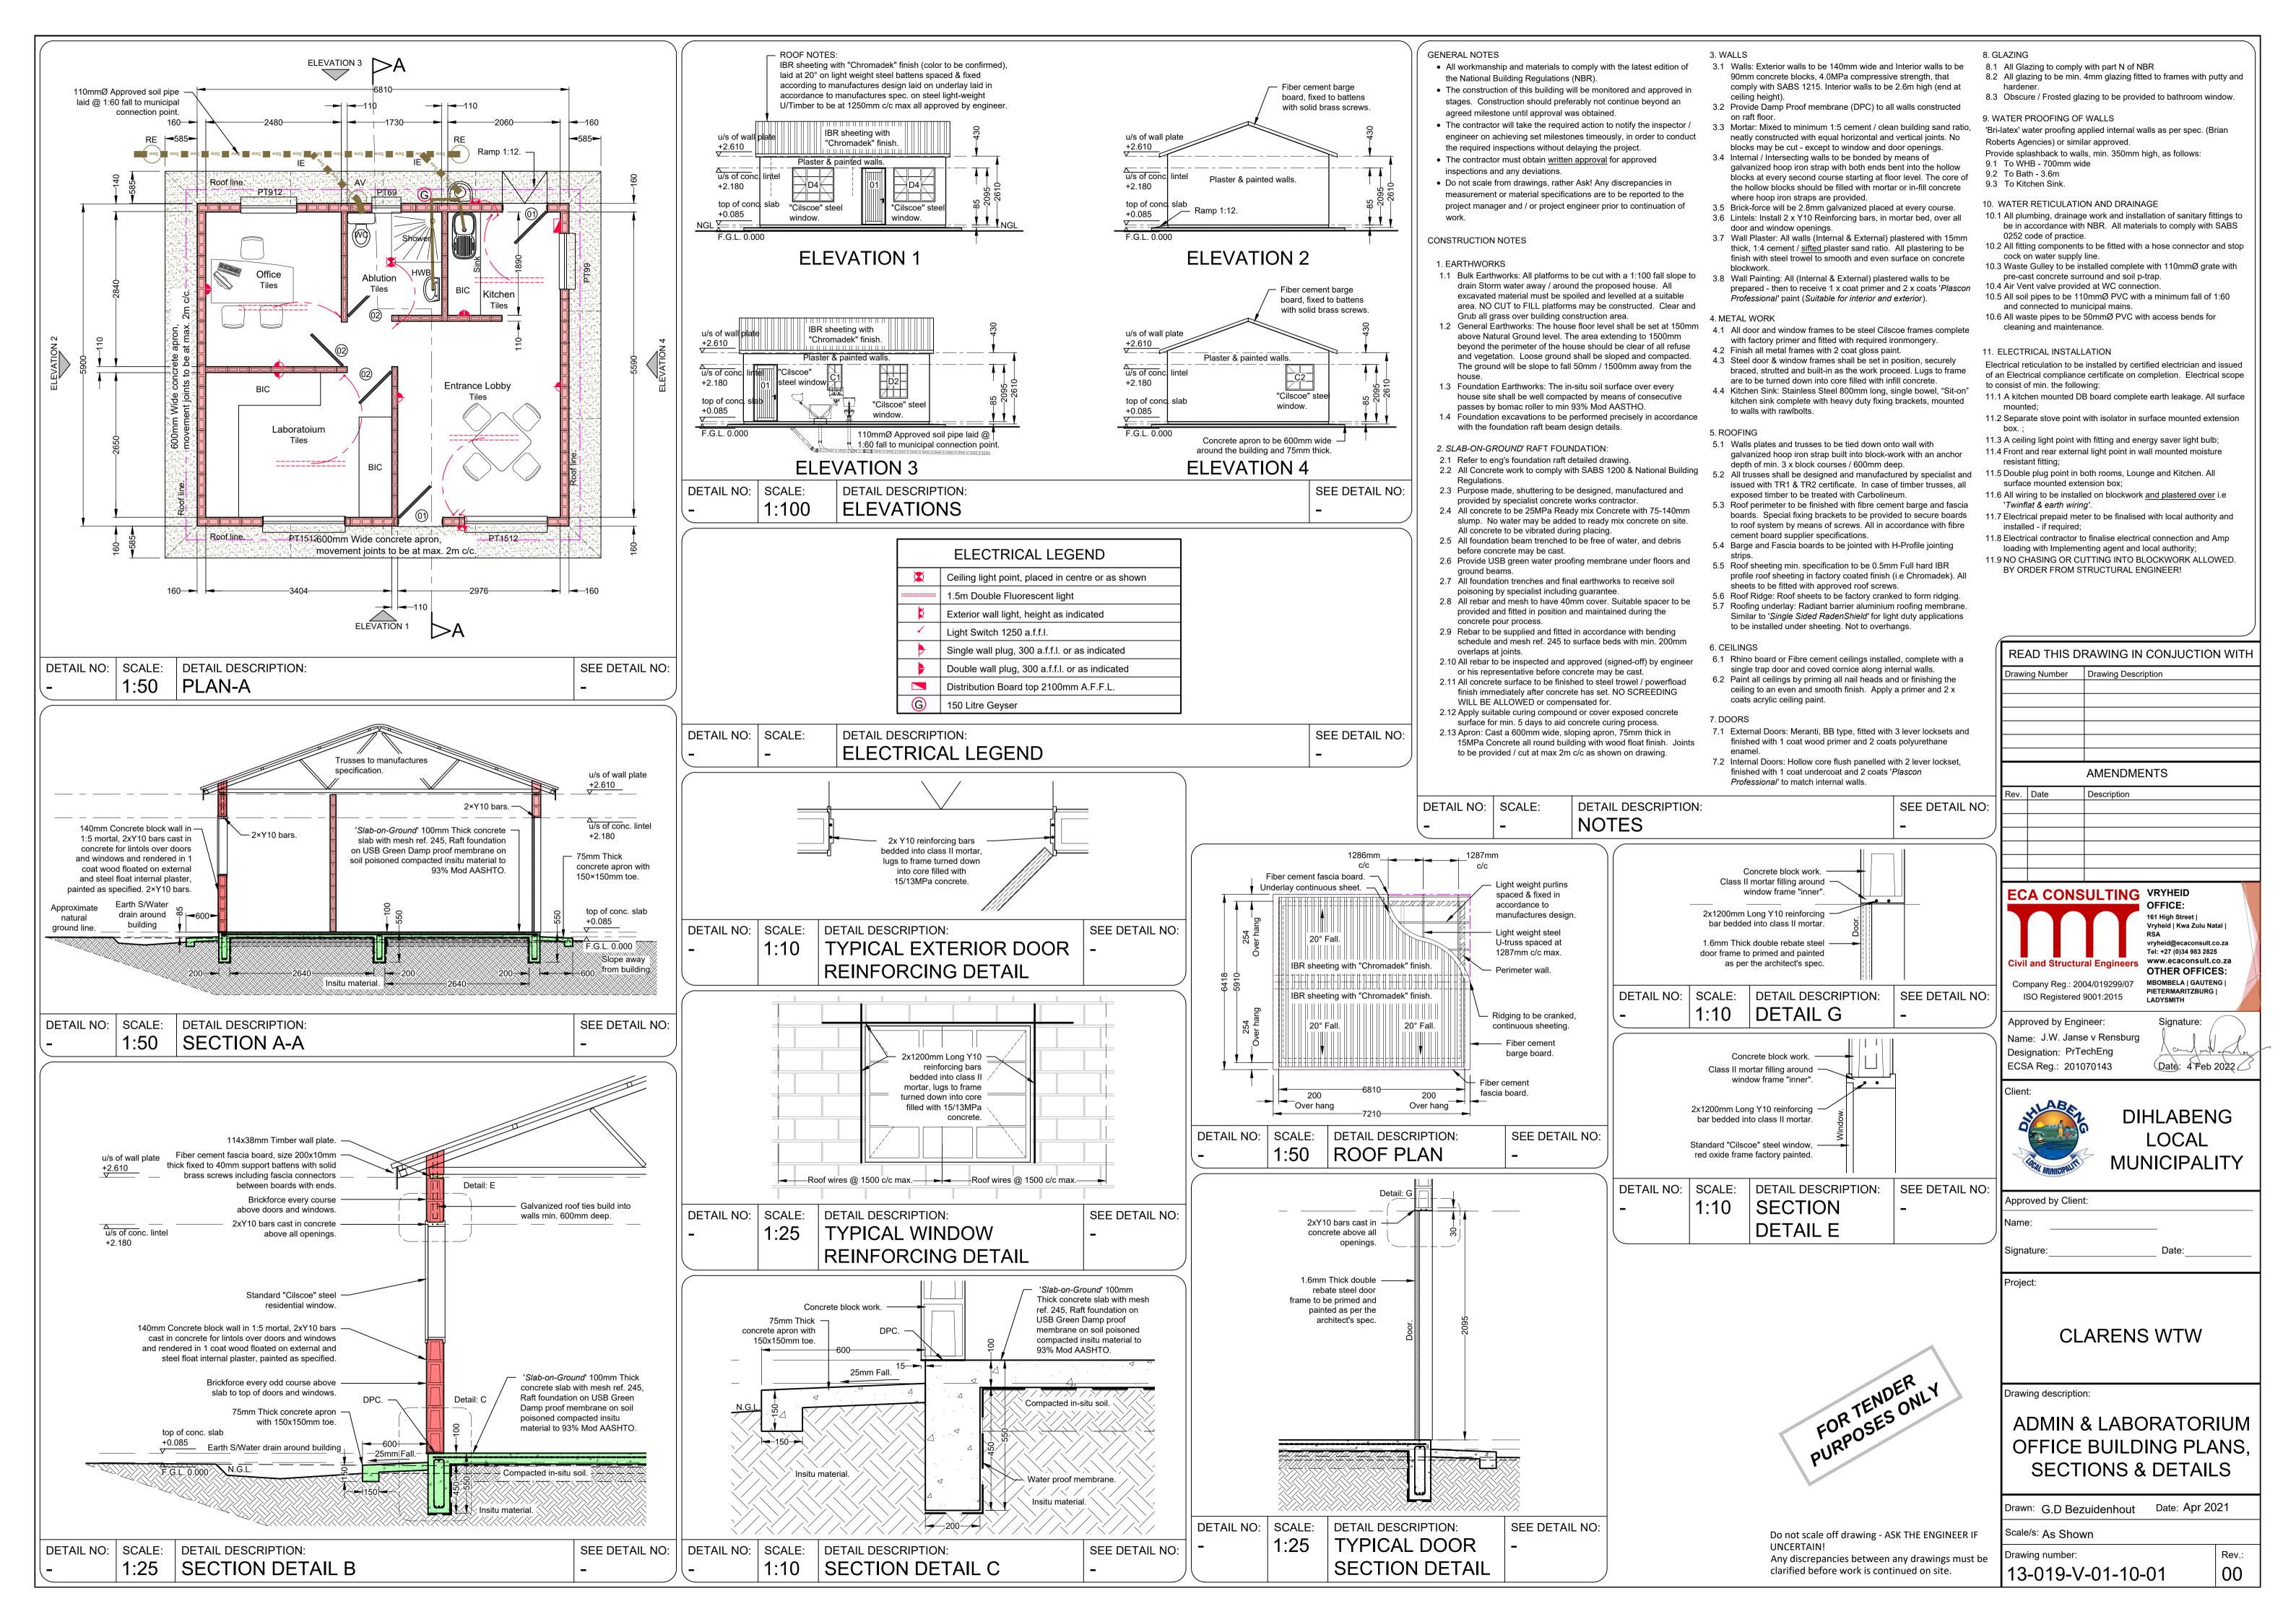

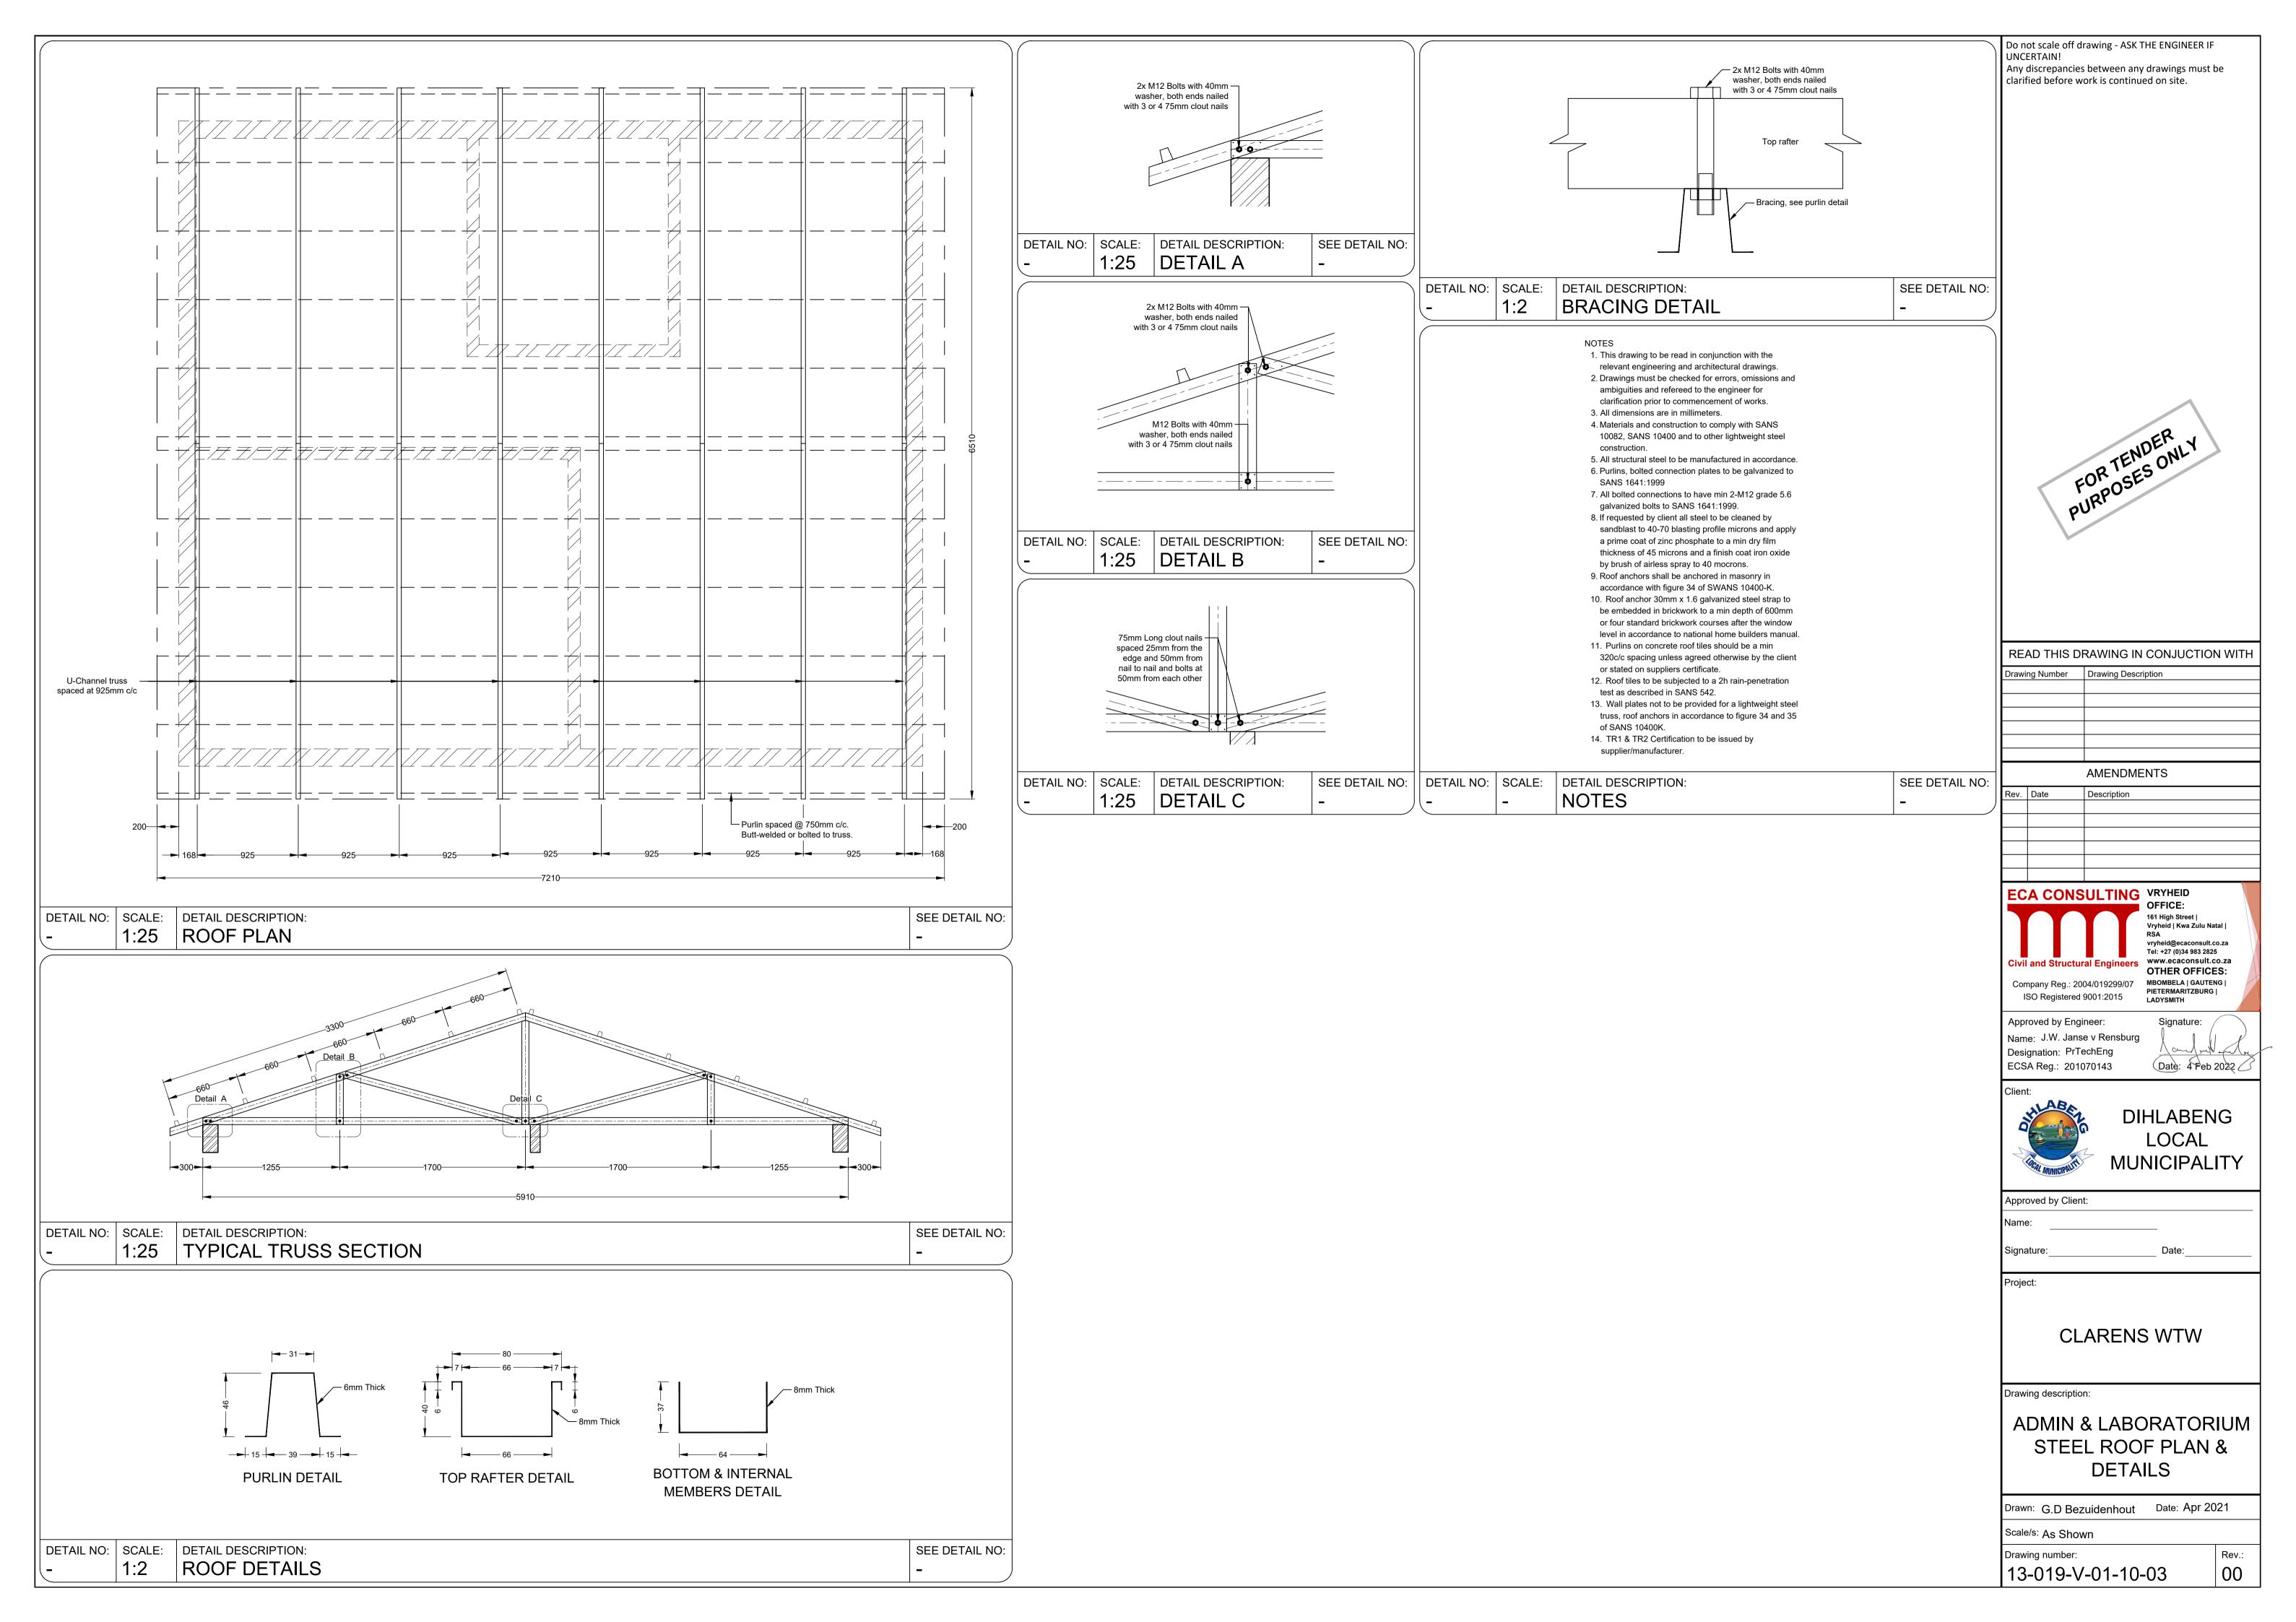

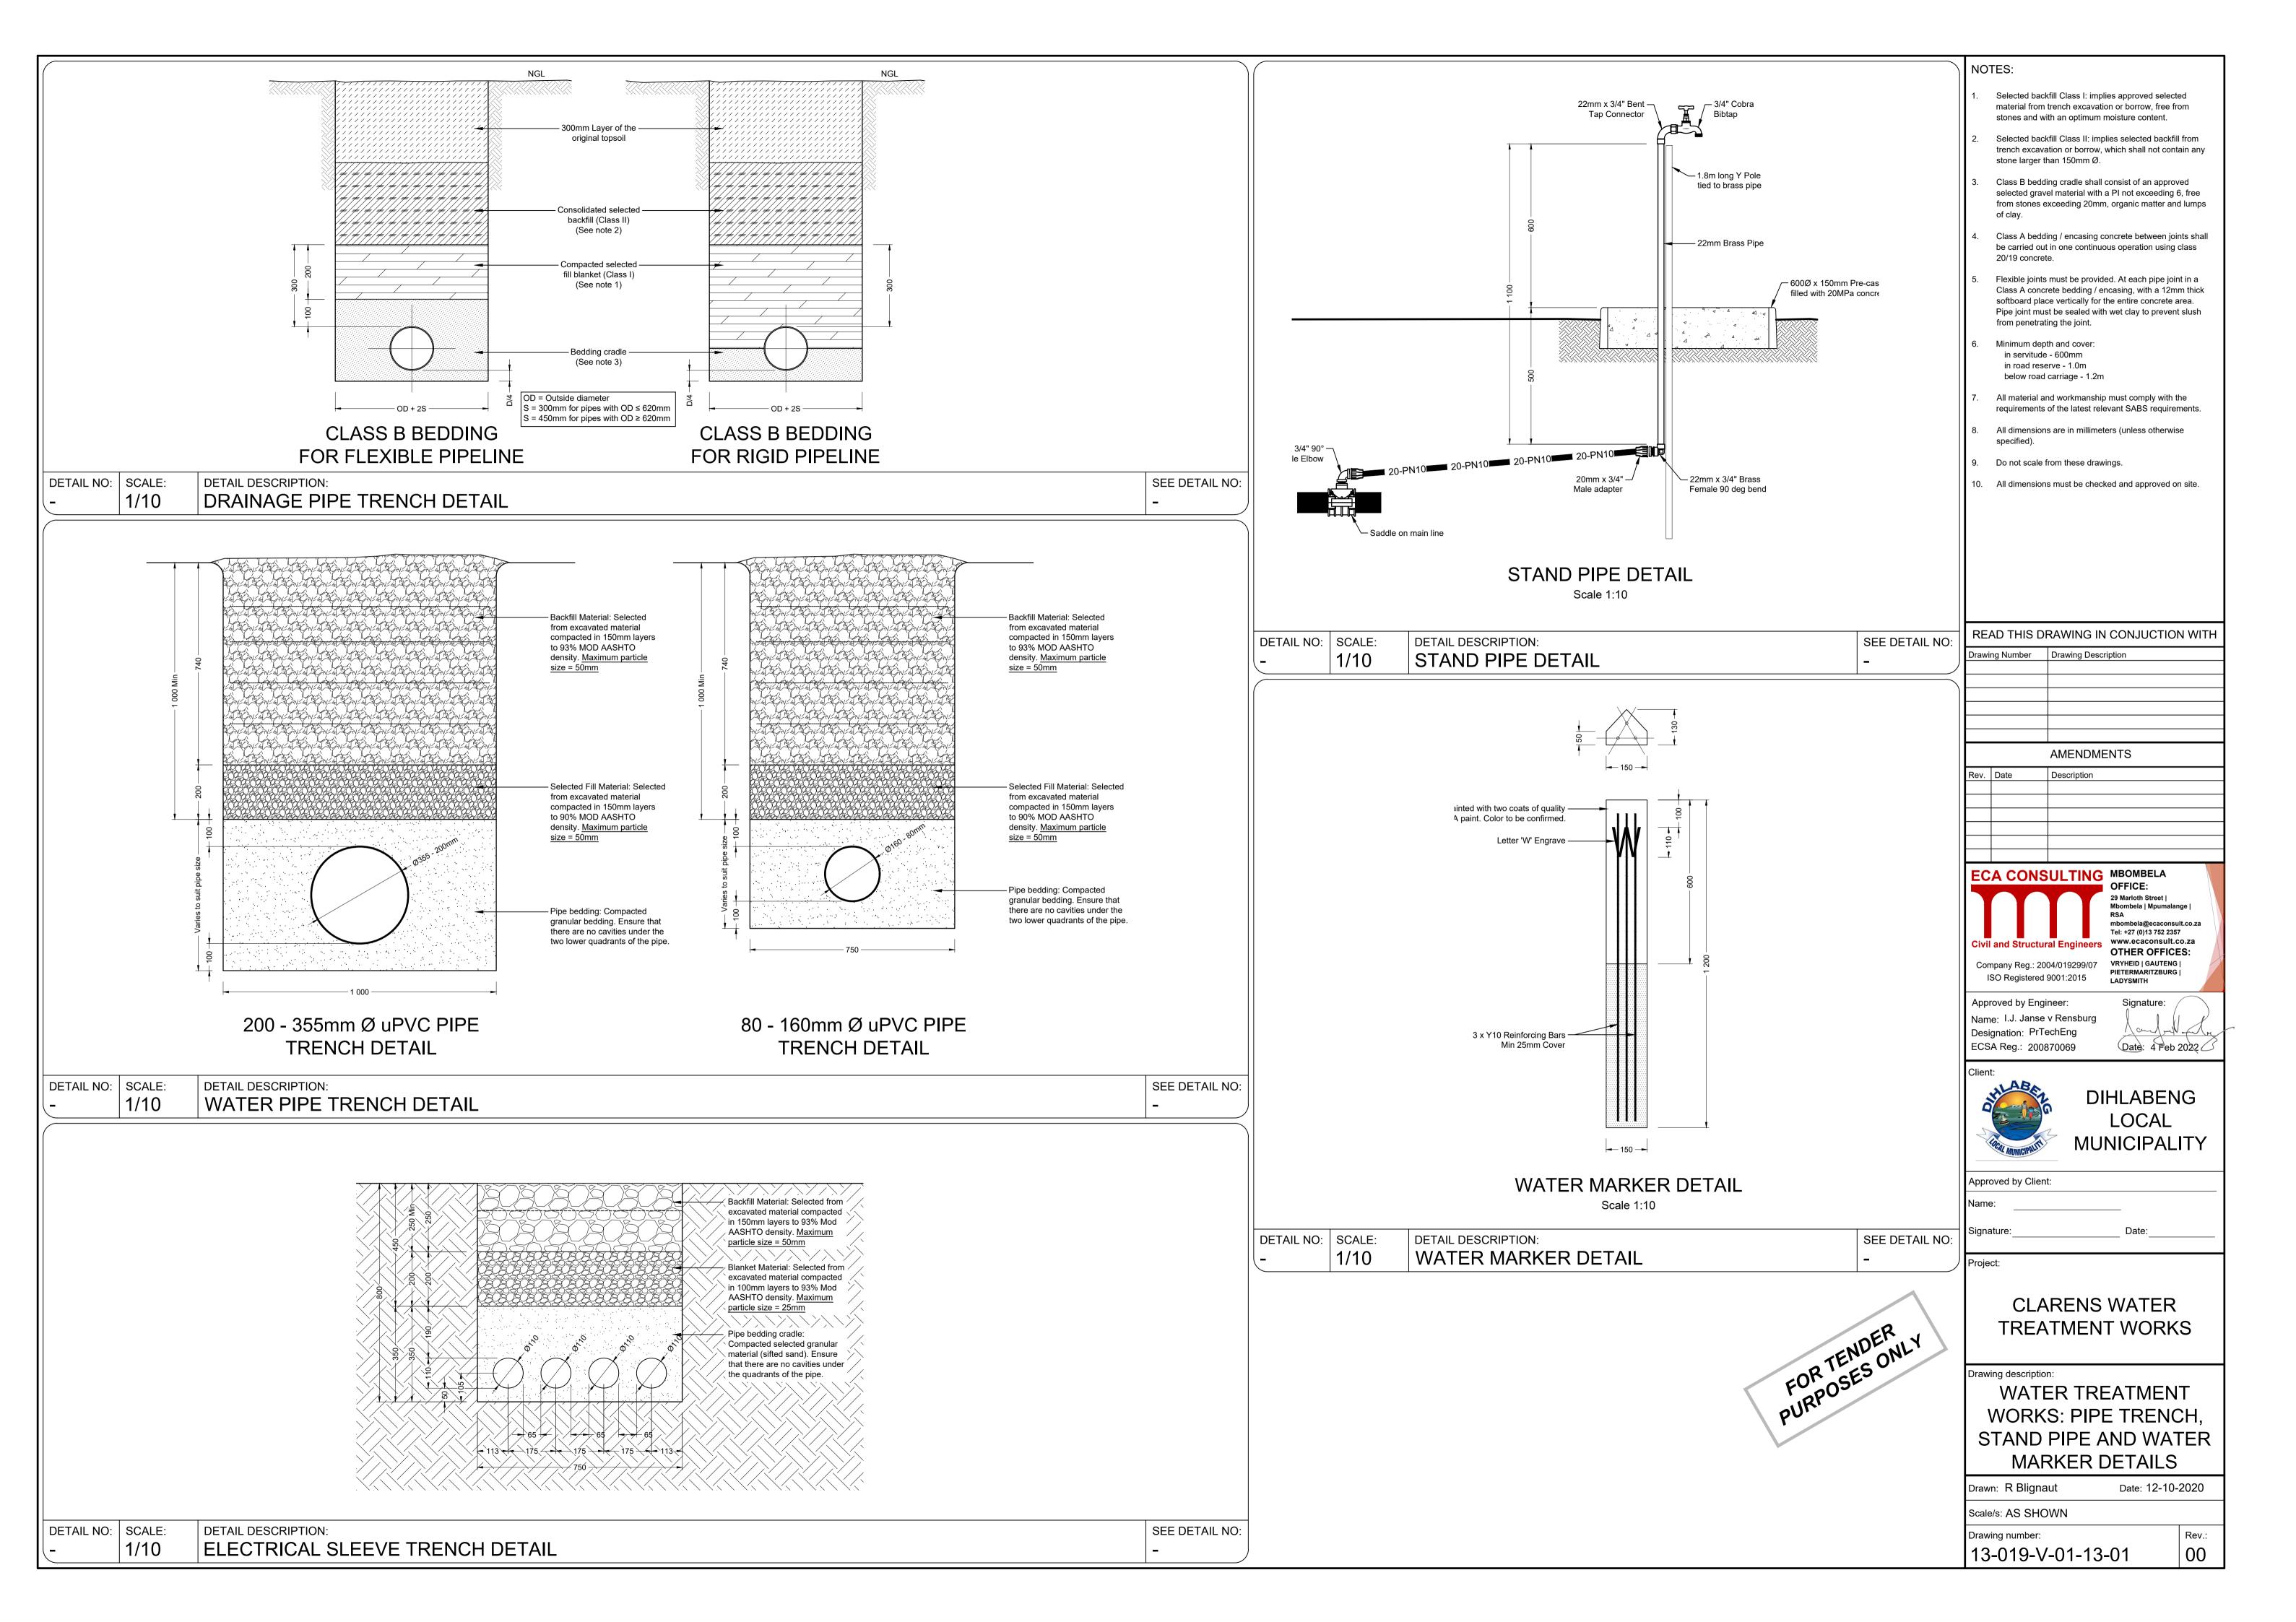

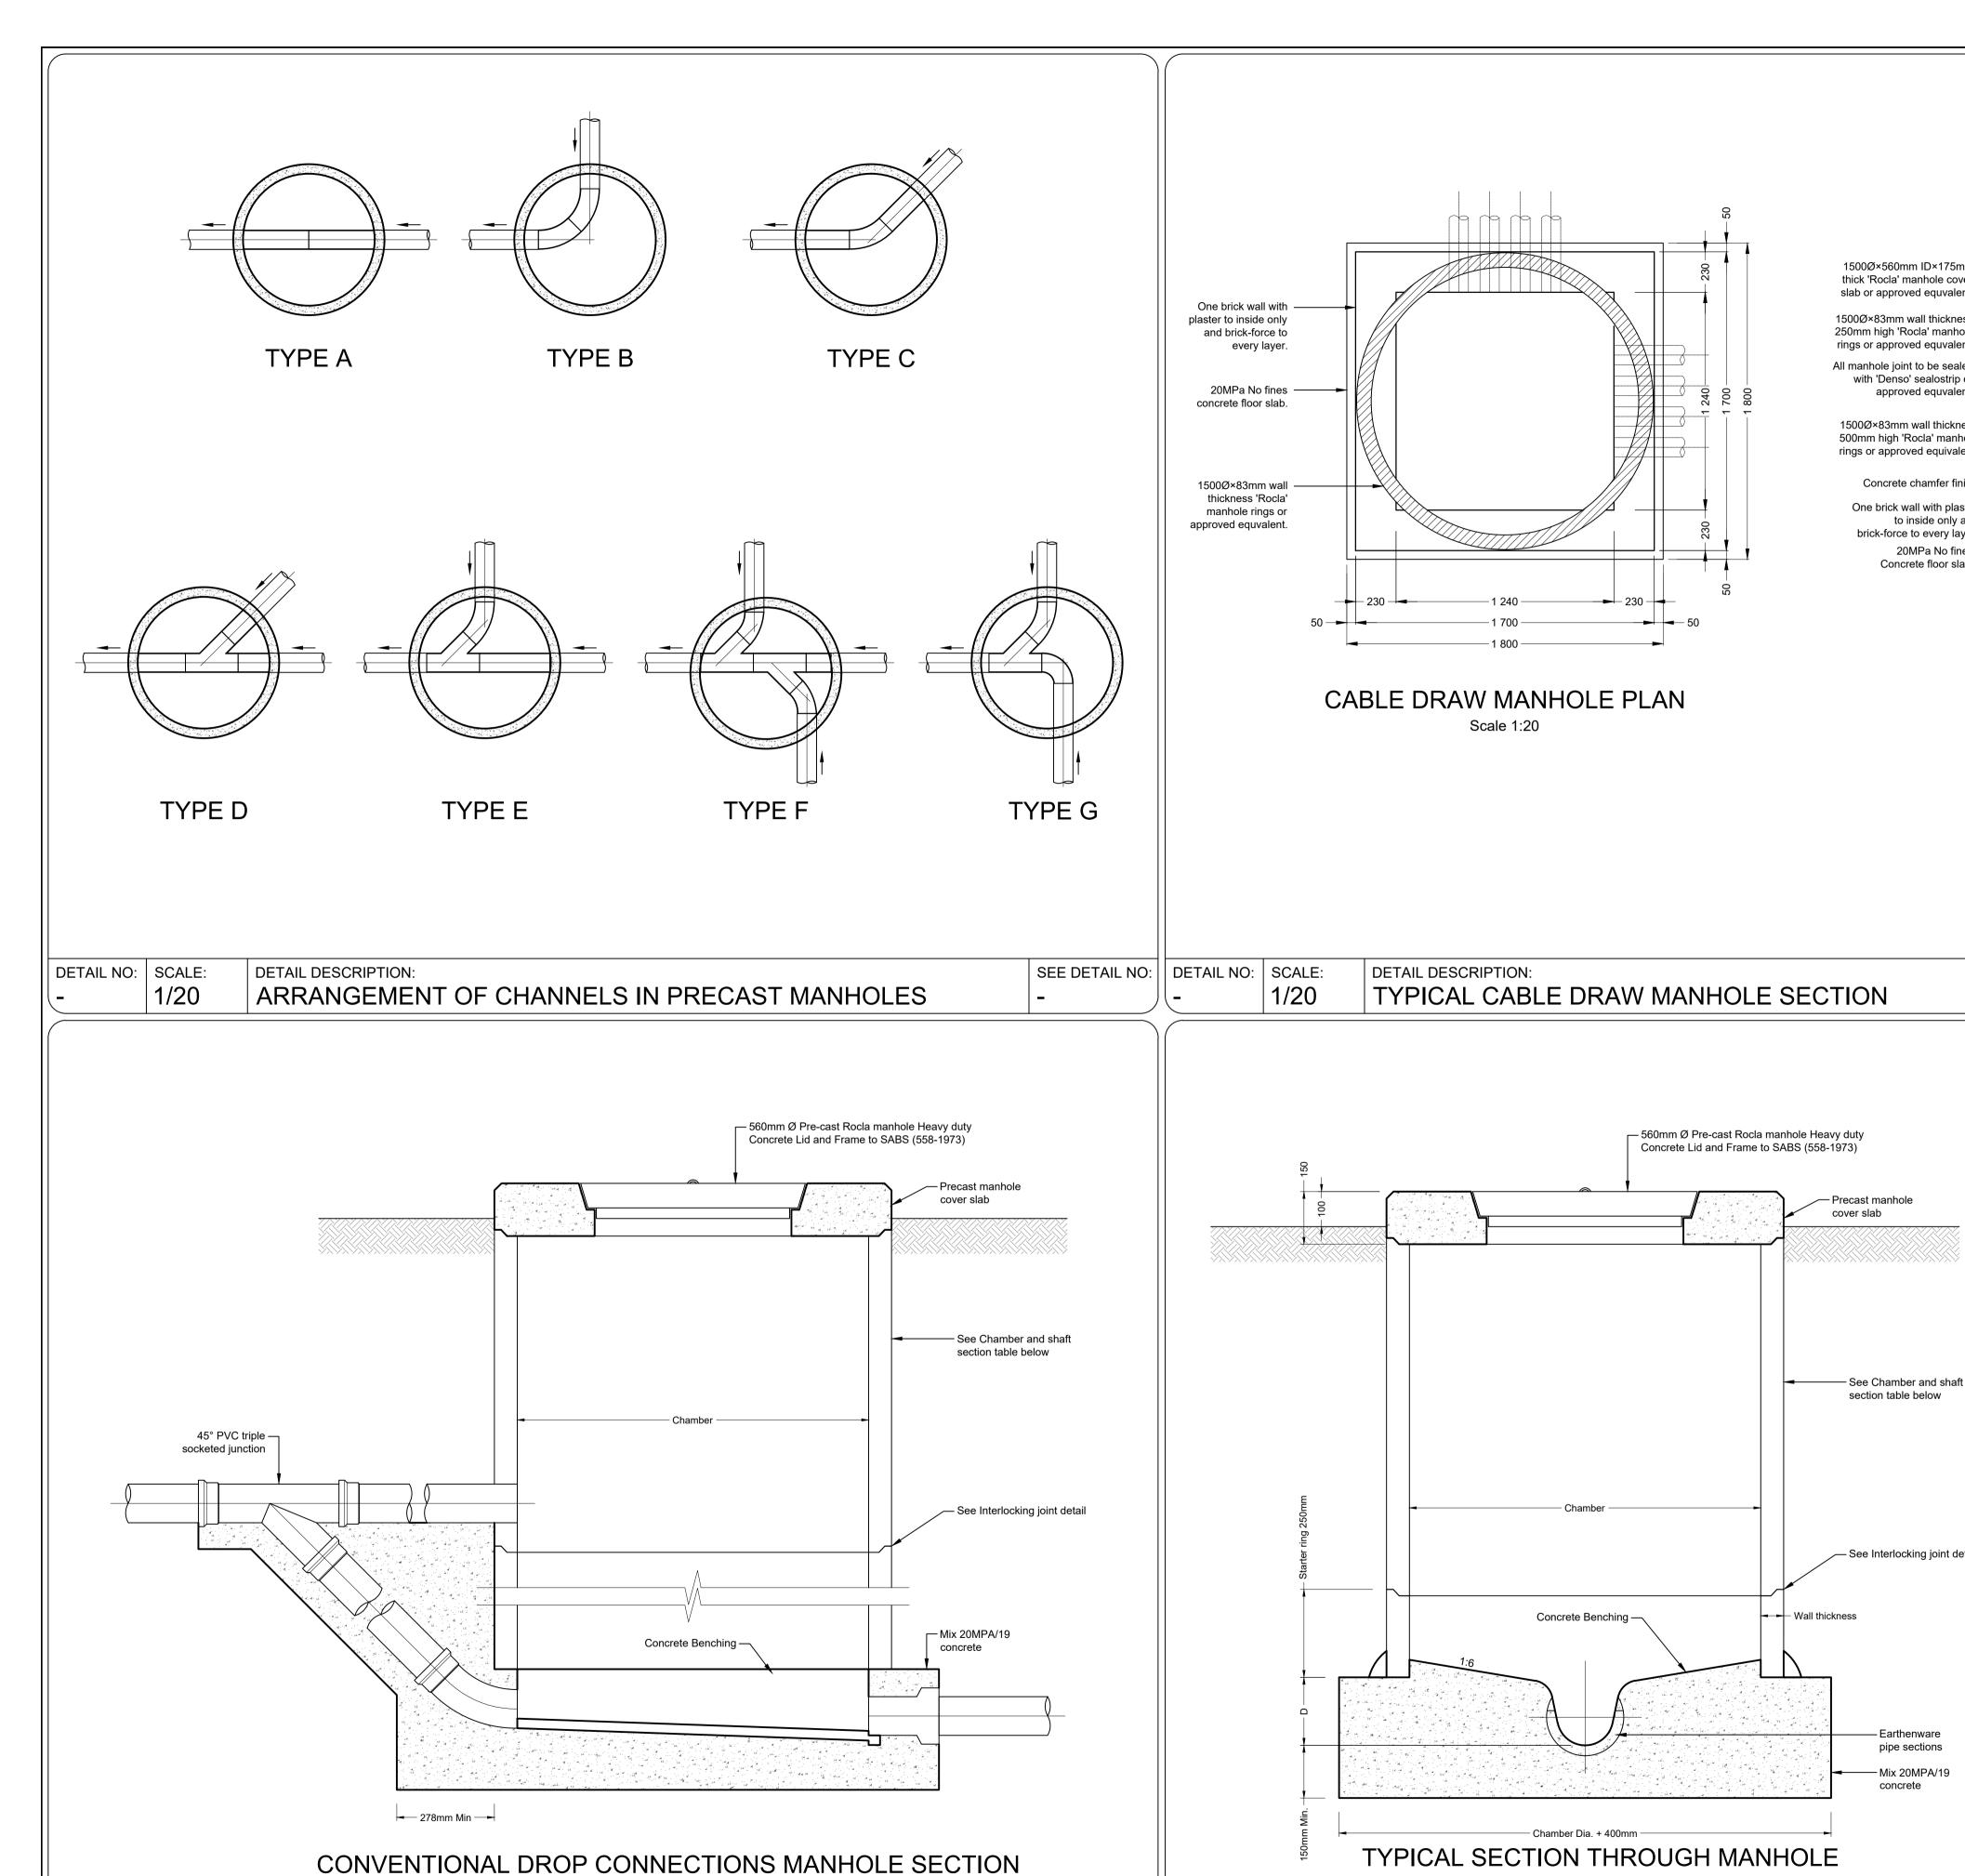

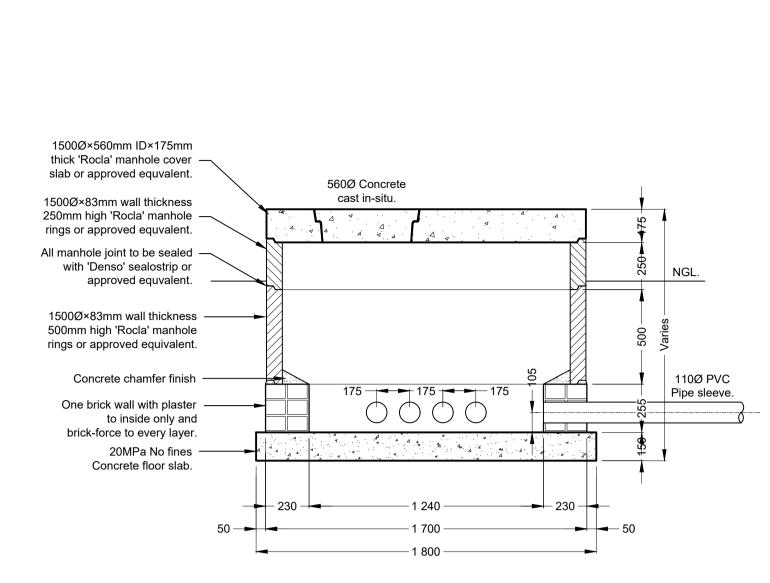


CABLE DRAW MANHOLE SECTION

Scale 1:20

Denso bitumen – sealant tape

tight joint

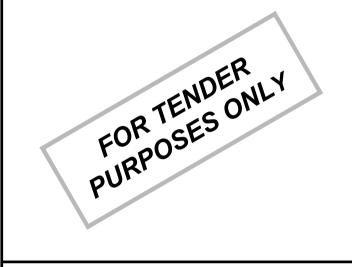

READ THIS DRAWING IN CONJUCTION WITH

Drawing Number Drawing Description

Do not scale off drawing - ASK THE ENGINEER IF

clarified before work is continued on site.

Any discrepancies between any drawings must be



AMENDMENTS

Approved by Engineer: Name: I.J. Janse v Rensburg Designation: PrTechEng ECSA Reg.: 200870069

ISO Registered 9001:2015

SEE DETAIL NO:

- Denso bitumen

sealant tape

Thickness of pipe wall

Chamber

1500

250, 500, 1000

83

3 - 5m

. Di

INTERLOCKING JOINT DETAIL

Signature: Date: 4 Feb 2022

DIHLABENG LOCAL **MUNICIPALITY**

Signature:

Approved by Client:


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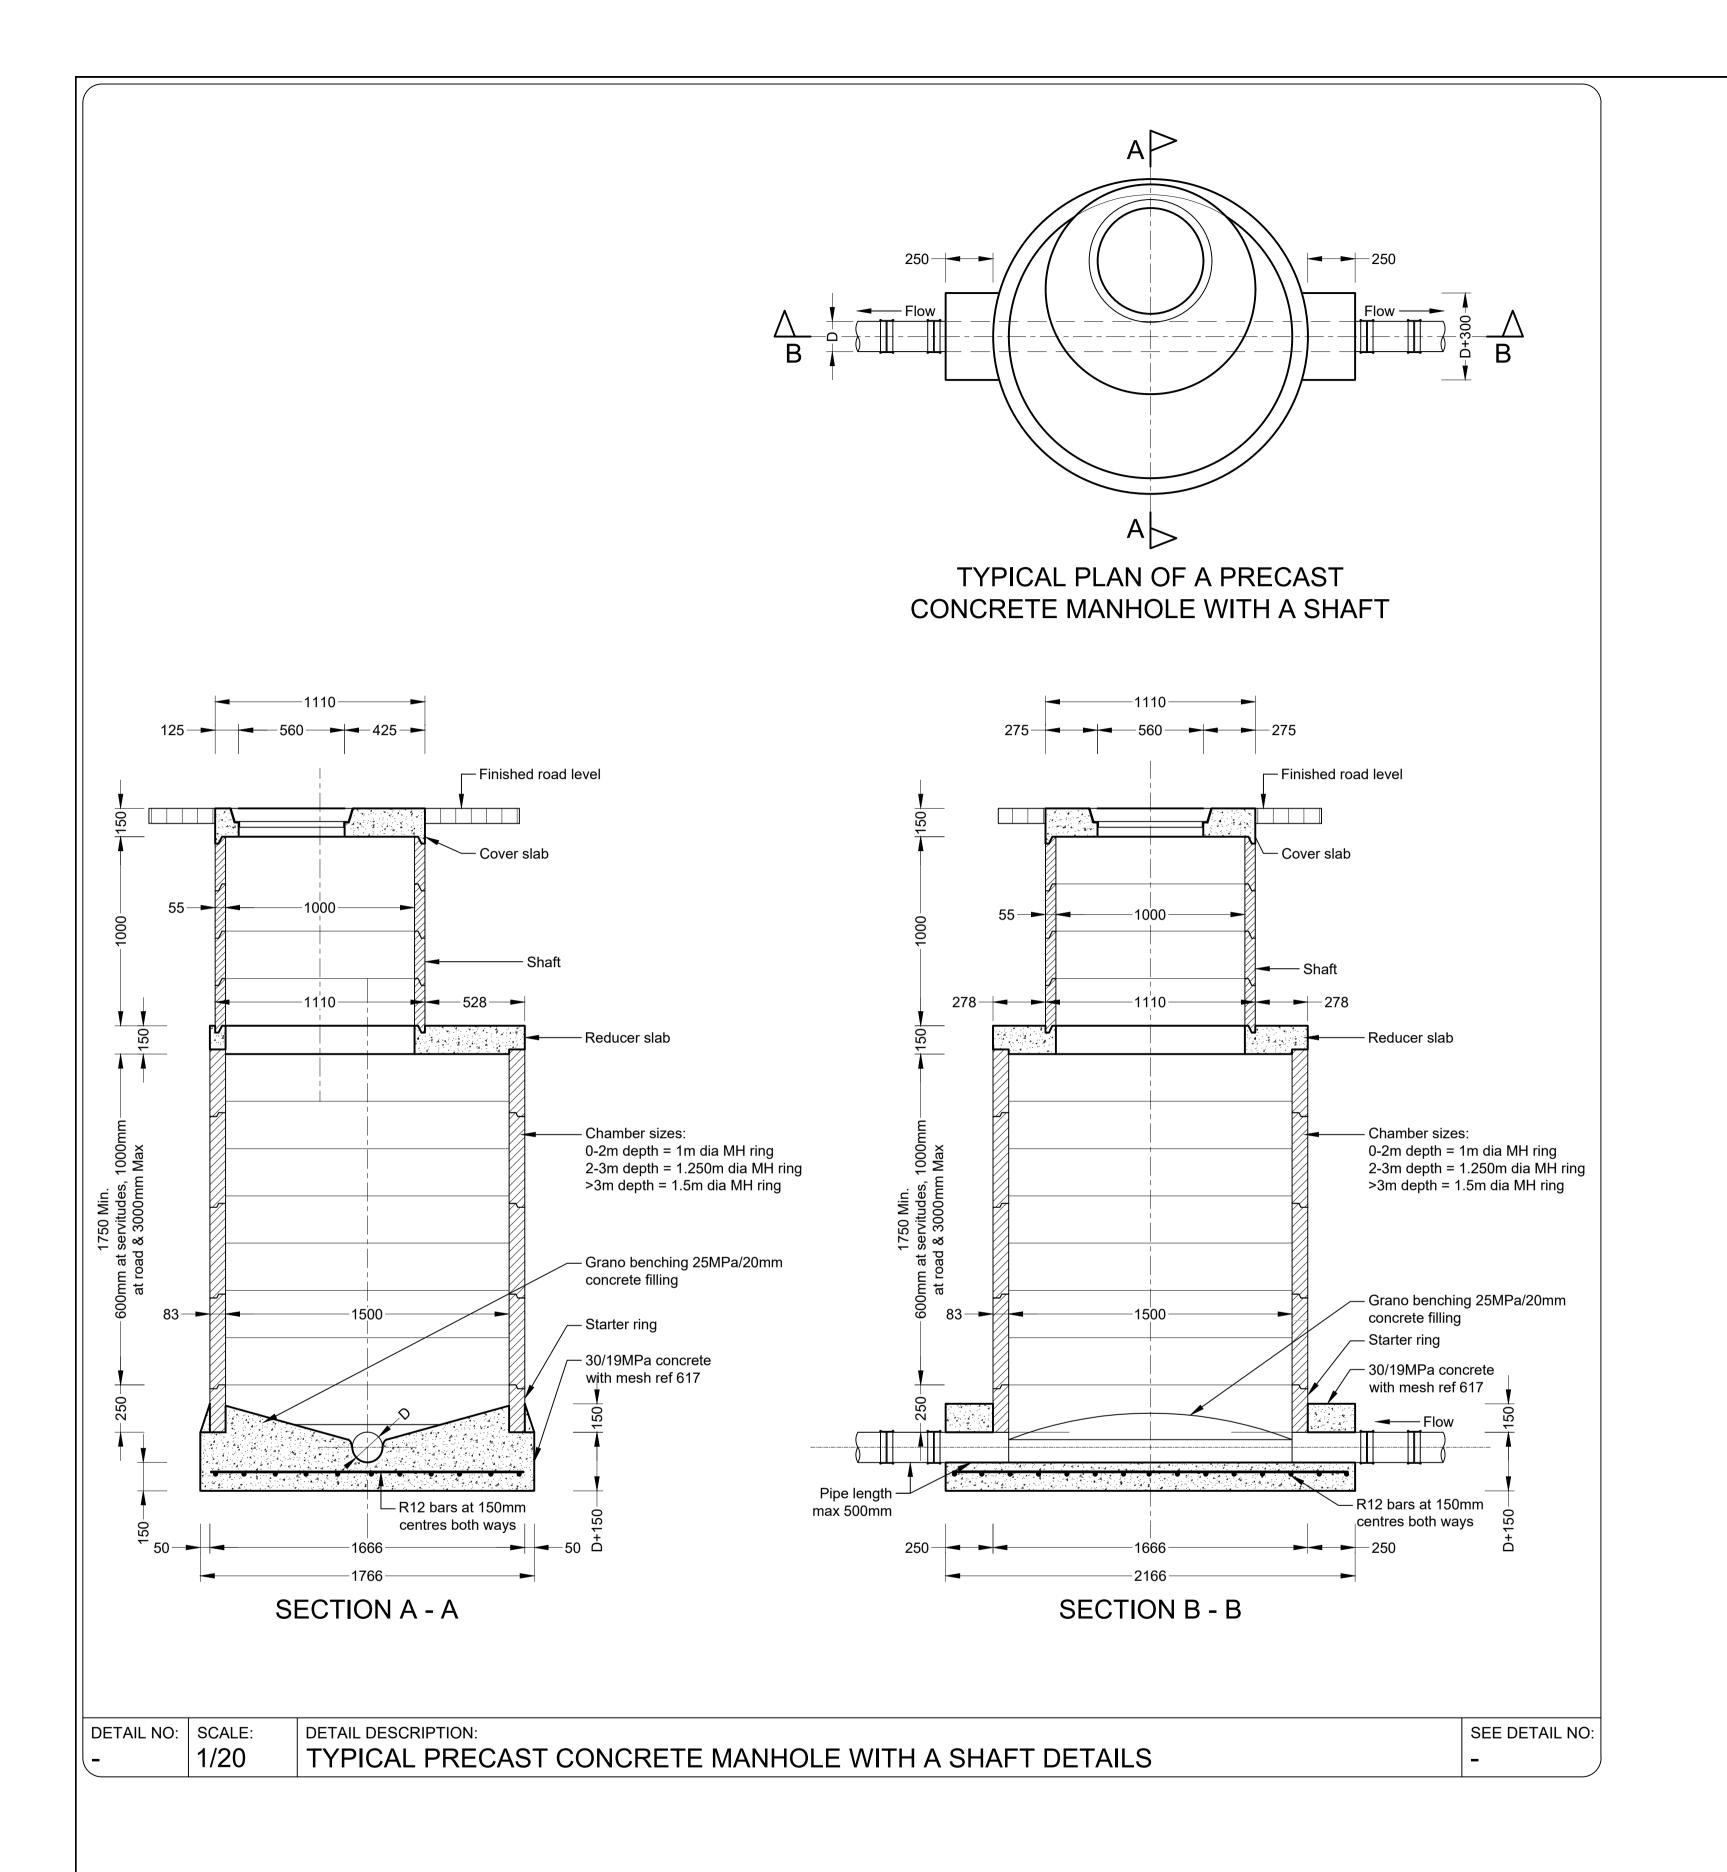
CLARENS WATER TREATMENT WORKS

Drawing description:

WATER TREATMENT **WORKS: TYPICAL** MANHOLE DETAILS DRAWING 01 OF 02

Drawn: R Blignaut Date: 12-10-2020 Scale/s: AS SHOWN SEE DETAIL NO: Drawing number: Rev.: 13-019-V-01-13-02



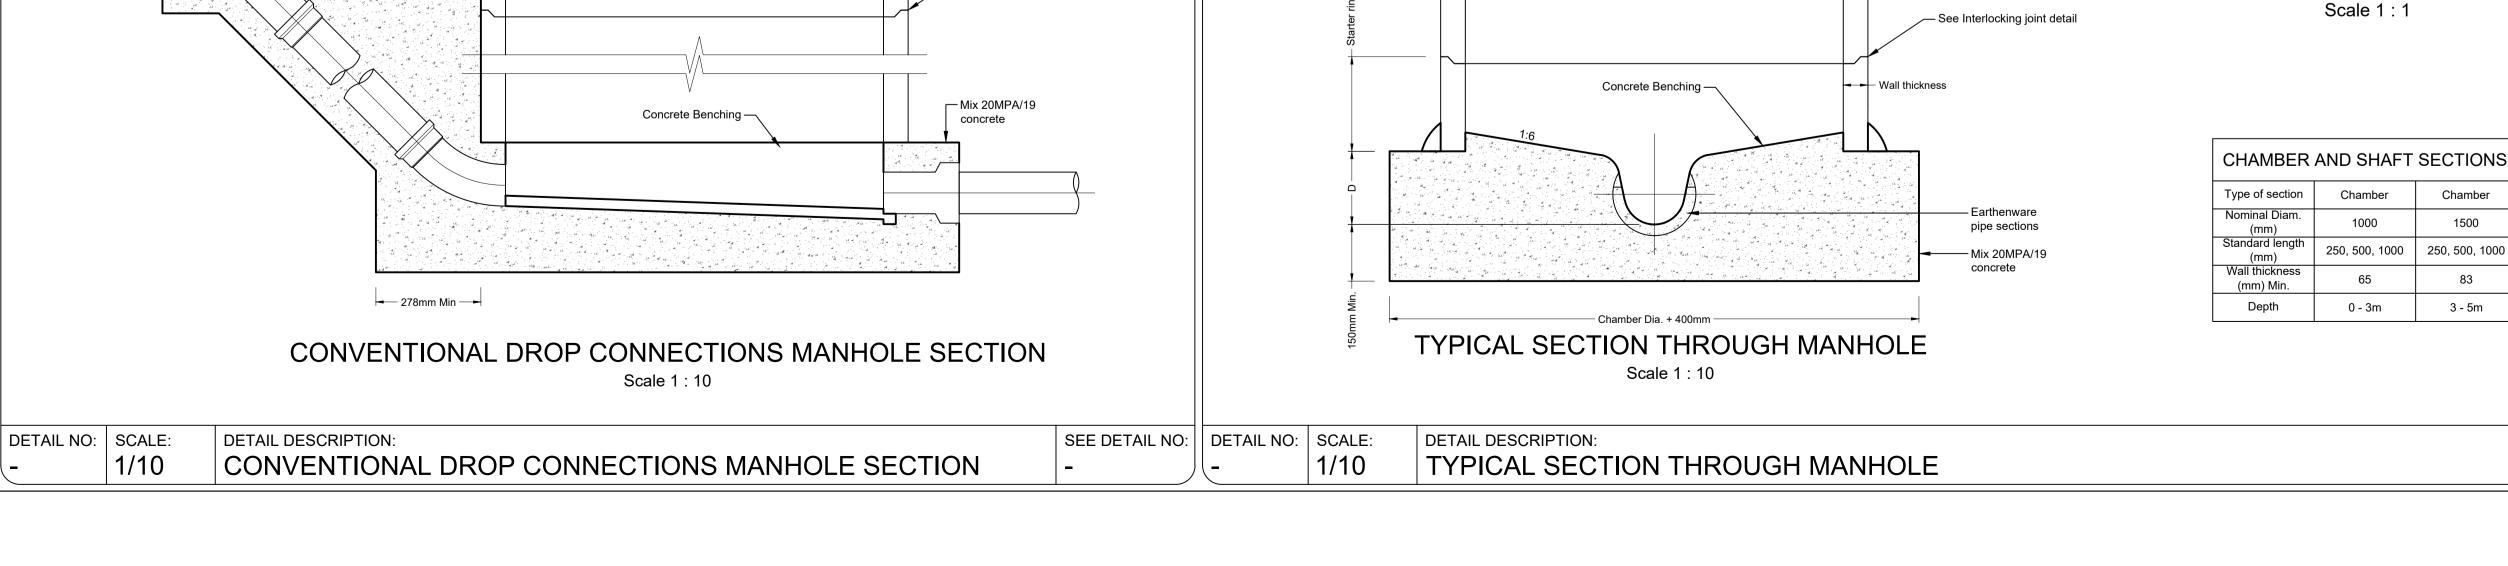

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RE	READ THIS DRAWING IN CONJUCTION WITH		
Drawi	ng Number	Drawing Description	
		AMENDMENTS	
Rev.	Date	Description	

ECA CONSULTING MBOMBELA

OFFICE: 29 Marloth Street | Mbombela | Mpumalange | RSA mbombela@ecaconsult.co.za Tel: +27 (0)13 752 2357 www.ecaconsult.co.za OTHER OFFICES: Company Reg.: 2004/019299/07
ISO Registered 9001:2015
VRYHEID | GAUTENG | PIETERMARITZBURG | LADYSMITH

Approved by Engineer: Name: I.J. Janse v Rensburg Designation: PrTechEng ECSA Reg.: 200870069

Signature: Date: 4 Feb 2022

MUNICIPALITY

DIHLABENG LOCAL

Approved by Client:	
Name:	
Signature:	Date:

CLARENS WATER TREATMENT WORKS


Drawing description:

WATER TREATMENT **WORKS: TYPICAL** MANHOLE DETAILS DRAWING 02 OF 02


Drawn: R Blignaut	Date: 12-10-2020
Scale/s: AS SHOWN	

Rev.:

Drawing number: 13-019-V-01-13-03

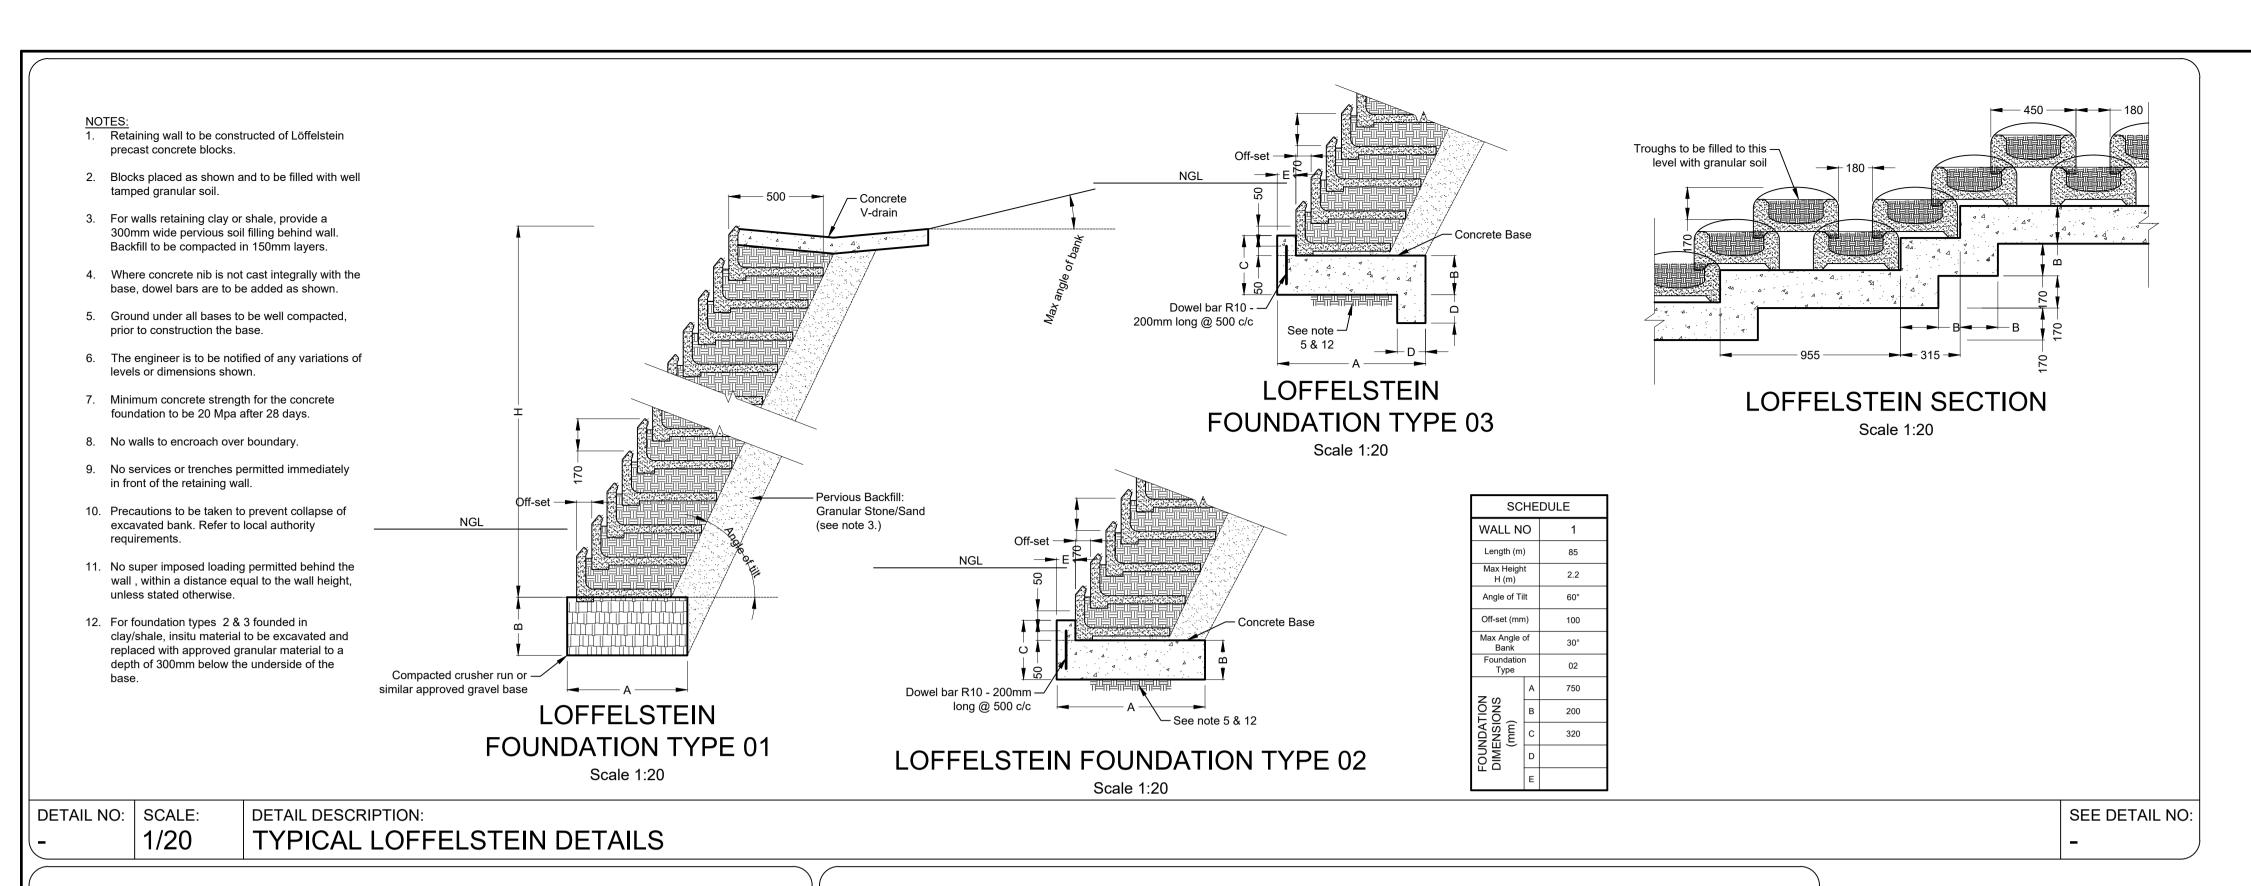




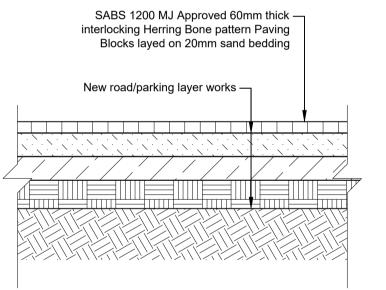

60mm PAVED ROAD LAYER WORKS


Scale 1:20

PAVEMENT DESIGN CRITERIA FOR 80mm PAVING				
Layer No.	Thickness Material Description Material Spec. (TRH) Layer Compact		Layer Compaction	
01	60	80mm paving on 20mm sand -		-
02	150	Base	C4	97%
03	150	Sub-base G7 95		95%
04	150	Road bed preparation	Insitu	90%

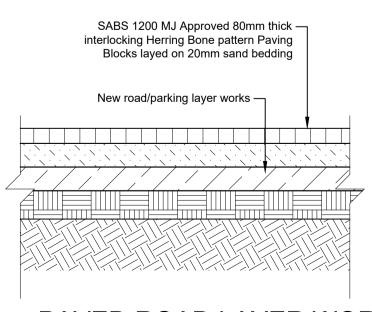

80mm PAVED ROAD LAYER WORKS
Scale 1:20

DETAIL NO: SCALE: DETAIL DESCRIPTION: SEE DETAIL NO: - 1/20 PAVING LAYER WORKS -

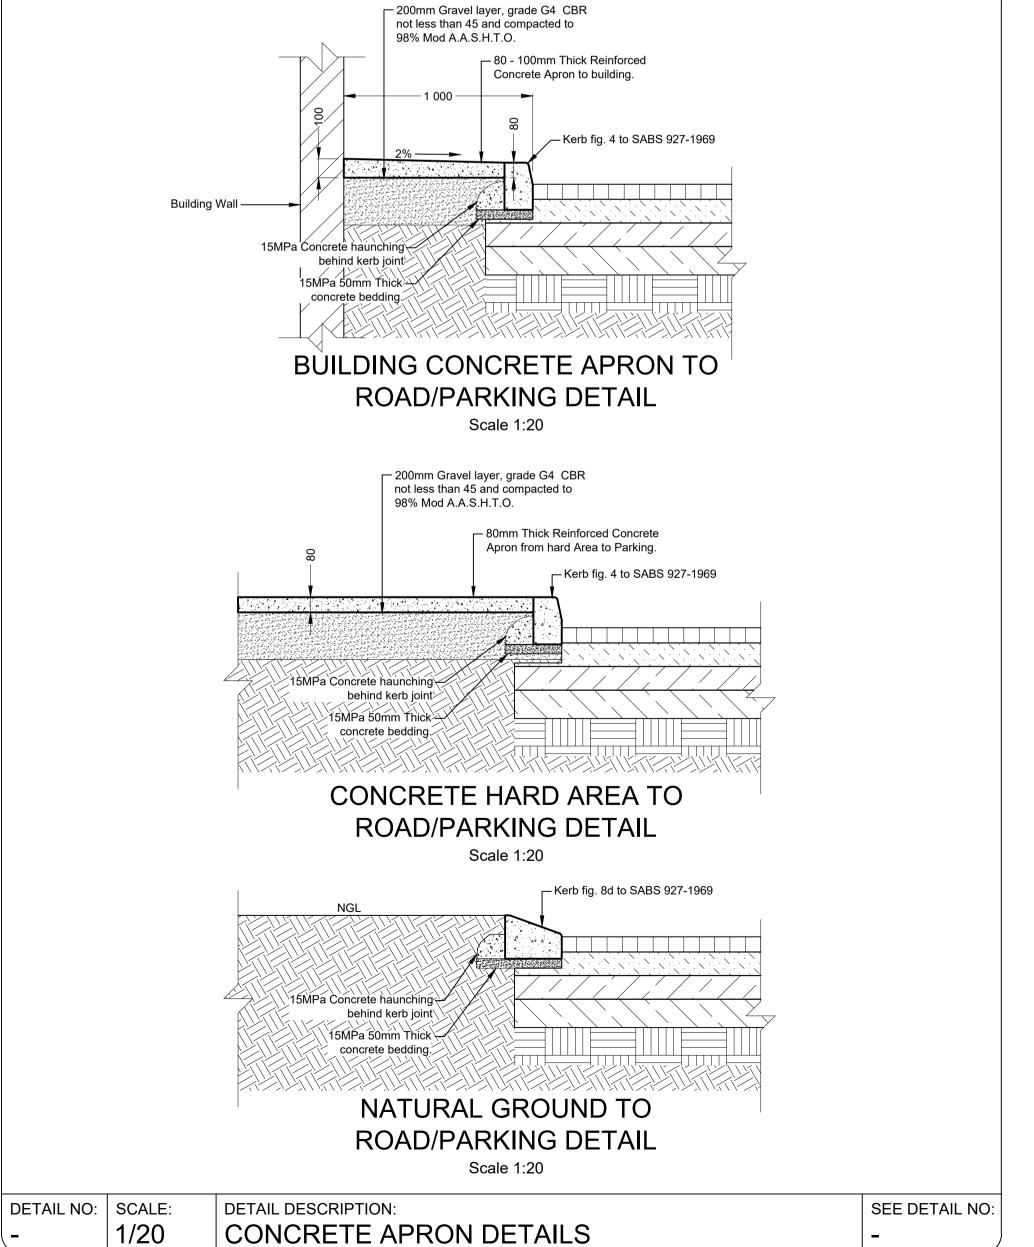


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READ THIS DRAWING IN CONJUCTION W		
Drawi	ng Number	Drawing Description
AMENDMENTS		
Rev.	Date	Description

Rev.	Date	Description



Approved by Engineer:

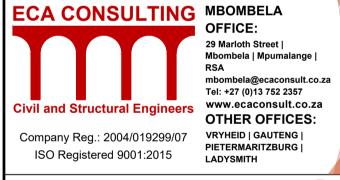Name: I.J. Janse v Rensburg

Designation: PrTechEng

ECSA Reg.: 200870069

rg Signature:

Date: 4 Feb 2022



DIHLABENG LOCAL MUNICIPALITY

Approved by Client:			
Name:			
Signature:	Date:		

Project:

CLARENS WATER
TREATMENT WORKS

Drawing description:

WATER TREATMENT WORKS:LOFFELSTEIN AND LAYER WORKS DETAIL DRAWING

Drawn: R Blighaut	Date: 12-10-2020
Scale/s: AS SHOWN	

Drawing number: Rev.: 13-019-V-01-13-04

