

- 1.1 WHERE THE FILL IS MORE THAN 4m WITH NO RECOVERY
- 1.2 WHERE WATER NEXT TO THE ROAD FORMATION IS DEEPER THAN 1,5m.
- 1.3 AT ALL BRIDGES.
- 1.4 ON THE OUTSIDE OF CURVES WITH RADII LESS THAN 300m WITHOUT RECOVERY AREAS.

THAN WHAT A GUARDRAIL WOULD BE.


- 1.5 WHERE OBSTRUCTIONS ARE LESS THAN 1m FROM THE SHOULDER BREAKPOINT.
- 1.6 WHERE AN OBSTRUCTIONS APPEARS TO BE MORE DANGEROUS
- 2. BEFORE GUARDRAILS ARE ERECTED APPROVAL MUST BE
- BEFORE GUARDRAILS ARE ERECTED APPROVAL MUST BE OBTAINED FROM THE GENERAL MANAGER: ROADS AND STORMWATER.
- 3. SPECIFICATIONS:
- 3.1 BOLT : HIGH TENSILE STEEL 16mm
- 3.2 WASHER: STEEL SPRING 10mm THICK.
- 3.3 SPACERBLOCK : GUM OR PINE. TREATED
- WITH CREOSOTE ACCORDING TO ANY METHOD IN SANS 10005.

 3.4 POLE: 150mm TO 230mm GUM OR PINE
- 3.4 POLE: 150mm TO 230mm GUM OR PINE TREATED WITH CREOSOTE ACCORDING TO ANY METHOD IN SANS 10005.
- 3.5 ALL GUARDRAILS SHALL BE GALVANIZED AS SPECIFIED (NOT PAINTED).
- 4. ALSO REFER TO SECTION 611 OF THE STANDARD SPECIFICATION FOR MUNICIPAL CIVIL ENGINEERING WORKS, 3rd EDITION, 2005.

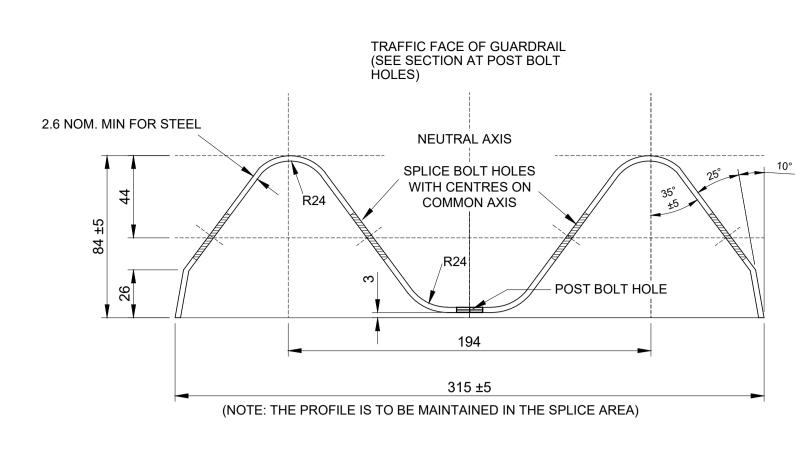


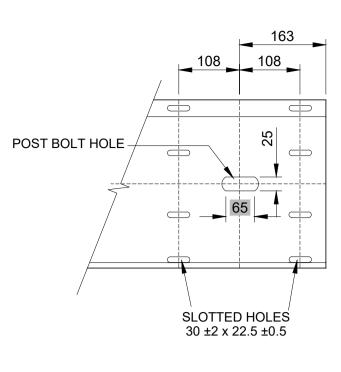


CROSS-SECTION OF GUARDRAIL SCALE 1:2

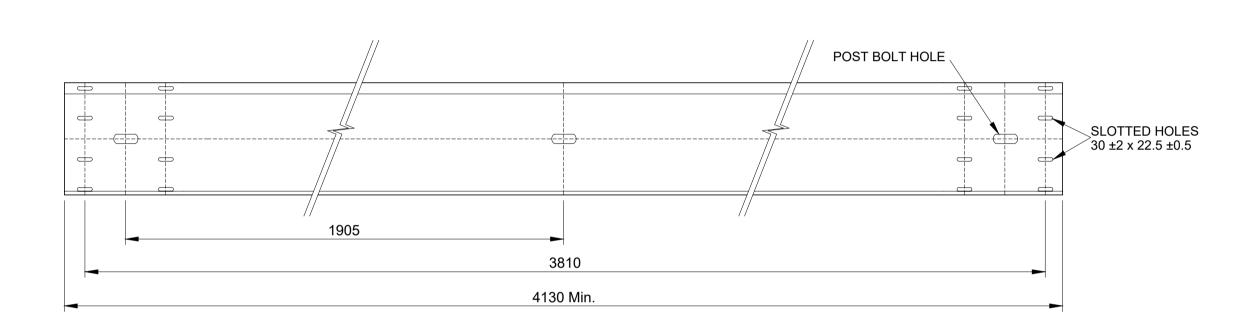

GUARDRAIL
SCALE 1:10

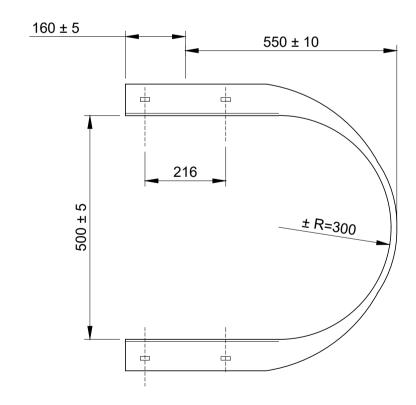

BULLNOSE ENDWING - PLAN
SCALE 1:10

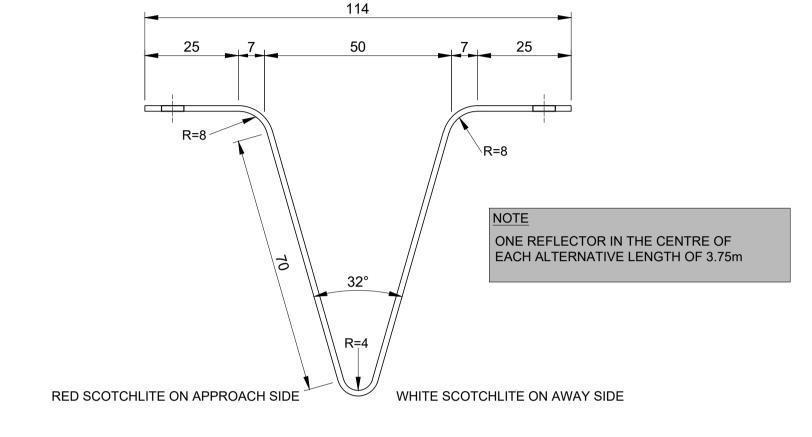



RIVET POSITION

FRONT ELEVATION

SCALE 1:25

SECTIONAL PLAN: DETAIL OF REFLECTOR PLATE SCALE 1:1

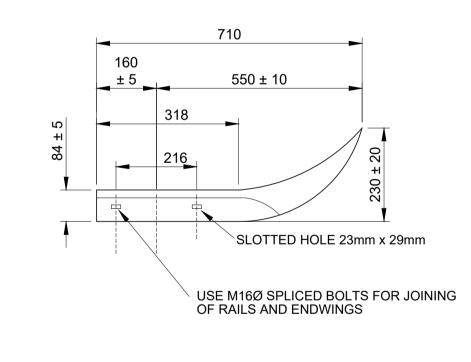

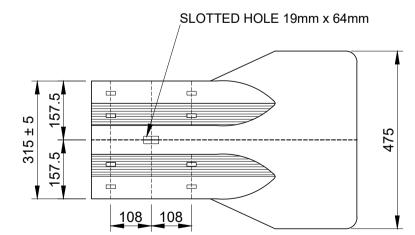

STANDARD TYPICAL FLARED ENDWING SCALE 1:10

CONSULTANT DESIGN PLAN SCALE CONTRACT NUMBER: REG 55/2019 DESIGNED BY SHUMA AFRICA FEB. 2020 DESIGN DEVELOPMENT CITY OF MBOMBELA AS - SHOWN (Full signature) 00 FEB. 2023 REVISION No. L.N MHLANGA UNIT 75, BUILDING 11, SONPARK SHOPPING CENTRE, DRAWN BY For: MLM P O BOX 1644 DATE MBOMBELA NKOMENI TO THEMBISA ROAD 00 P. O. BOX 45 1 NEL STREET NELSPRUIT MB©MBELA SHUMAAFRICA CNR. MADIBA DRIVE AND NELSPRUIT NELSPRUIT 1200 For: Consulting Engineer PIET RETIEF STREET CHECKED BY . MAGAGULA Pr Tech Eng. SHEET 1 of CONSULTANTS GUARDRAILS: CROSS SECTION, DATE DRAWING NUMBER Tel.: (013) 752 3658 Tel.: (013) 759 9111 Fax.: (013) 759 2070 REFLECTOR PLATES AND ENDWINGS Fax.: (086) 545 7391 APPROVED BY T. MAGAGULA Pr Tech Eng. FEBRUARY 2023 SH-920-21-06-TD CONSULTING ENGINEER DATE No DATE REVISION CONSULT DIR