

GENERAL NOTES:

1. ALL CO-ORDINATES, DIMENSIONS AND LEVELS MUST BE VERIFIED BY THE CONTRACTOR ON SITE BEFORE ANY WORK COMMENCES. DISCREPANCIES MUST BE DISCUSSED WITH THE ENGINEER.

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2. CONCRETE STRENGTHS:
STRIP FOUNDATIONS - 20/19

STRIP FOUNDATIONS - 20/19
PUMP PLINTHS - 30/19
ROOF SLAB - 25/19
INTERNAL FLOOR SLAB - 25/19

3. ALL EXPOSED EDGES TO BE CHAMFERED

4. ALL EXCAVATION MUST BE INSPECTED AND APPROVED BY THE ENGINEER BEFORE ANY

CONCRETE IS CAST.

5. ALL REINFORCEMENT MUST BE INSPECTED AND APPROVED BY THE ENGINEER BEFORE

ANY CONCRETE IS CAST.

6. LAP LENGTH: 50 x DIAMETER OF THE SMALLER BAR

7. ALL WORKMANSHIP AND MATERIALS MUST

COMPLY WITH THE LATEST RELEVANT SABS

BUILDING NOTES

2. BRICKWORK

1. FOUNDATIONS
FOUNDATION TRENCHES SHALL BE EXCAVATED
TRUE TO THE DETAILS SHOWN ON THE DRAWINGS AND
PERPEDICULAR TO EACH OTHER. THE FOOTINGS
SHALL BE CAST FROM 20/19 CONCRETE, A MINIMUM
OF 300mm DEEP AND SHALL BE APPROVED BY THE
ENGINEER ON SITE PRIOR TO ANY BRICKWORK
BEING PLACED.

FIRST 3 COURSES BELOW GROUND LEVEL TO BE FACE BRICKWORK AND THE REMAINDING COURSES ON EXTERNAL FACE TO FOUNDATION MAY BE CONSTRUCTED FROM APPROVED CLAY STOCK BRICKS.

BRICKFORCE SHALL BE LAID IN THE HORIZONTAL BED-JOINTS EVERY TWO COURSES.

AN APPROVED DAMP-PROOF COURSE (DPC) SHALL BE LAID INTO THE BRICKWORK, AT THE LEVEL OF THE FINISHED FLOOR SLAB.

ALL BRICKWORK ABOVE GROUND LEVEL AND ENTIRE INTERNAL FACE SHALL BE CONSTRUCTED FROM APPROVED FACED CLAY BRICKS WITH SQUARE RECESSED JOINTS AND PERPENDS.

ALL EXTERNAL JOINTING SHALL BE POINTED BY RECESSING THE MORTAR A MINIMUM OF 5mm.

ALL BRICKWORK SHALL BE CLEANED OF ANY EXCESS MORTAR DAILY BY WHAT EVER MEANS REQUIRED.

OUTER FACE OF INTERNAL SKIN BRICKWORK WALLS TO BE BAGGED WITH 1:3 CEMENT SAND SLURRY MIX AND APPLY 2 COATS "BRIXEAL" FROM "ABE CONSTRUCTION CHEMICALS" OR SIMILAR APPROVED

3. FLOOR SLAB
THE INTERNAL FLOOR SLAB SHALL BE CAST OF 25/19
CONCRETE TO FALLS INDICATED AND A MINIMUM
DEPTH OF 150mm ON EXCAVATED EARTH

MESH REF. 395 TO BE PLACED 50mm FROM THE SURFACE OF THE FLOOR SLAB.

FLOOR FINISHED WITH A GRANO SCREED LAID TO FALLS USING A STEEL TROWEL OR SIMILAR APPROVED METHOD. MINIMUM THICKNESS 20mm.

APPROVED METHOD. MINIMUM THICKNESS 20mm.

5. STRUCTURAL STEEL WORK
ALL STRUCTURAL STEEL WORK TO BE HOT DIPPED
GALVANISED AFTER FABRICATION

ADDITIONAL NOTES:

 CUT BANKS TO BE 1:1.5 UNLESS OTHERWISE SPECIFIED BY ENGINEER ON SITE.
 CUT BANKS STEEPER THAN 1:1.5 TO BE RETAINED BY A DRY STACKED RETAINING WALL, SPECIFIED BY AN ENGINEER ON SITE eTHEKWINI WATER SERVICES

ETHEKWIN MUNICIPALIT

WATER DESIGN BRANCH

REDUCED PLAN USE SCALE BELOW

0 10 20 30 40 50 60 70

70mm ON ORIGINAL PLAN

CONSULTANT:

No.5, The Boulevard
West Way Office Park
Westville, Durban
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Drawing No.: D859-52-5200 REV 0

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REFERENCE DRAWINGS

TITLE/DESCRIPTION

STANDARD DRAWINGS

NDARD DRAWINGS

01/09/2025 ISSUED FOR TENDER ONLY
01/08/2025 ISSUED FOR INFORMATION
01/02/2025 ISSUED FOR INFORMATION
on Date Description

32269-5W

D85

Planning Unit
WATER AND SANITATION

Ward No.

Contract No.

tle

TRENANCE 3 RESERVOIR

CONSTRUCTION OF A 6.0ML

REINFORCED CONCRETE RESERVOIR,

400KL ELEVATED STEEL TANK AND

ANCILLARY WORKS

PUMP STATION PLAN
AND SECTIONS

Scales : As Shown

Paper Size: A0

Designed: D. Ramghulam Date: 01-09-2025

Checked: A. Goorun Drawn: D. Ramghulam

Bulk Operations

Area Engineer (W O)

Area Engineer (W.O)


Manager (W.D.)

Director (Water)

E.Msweli - Head:Water & Sanitation Unit


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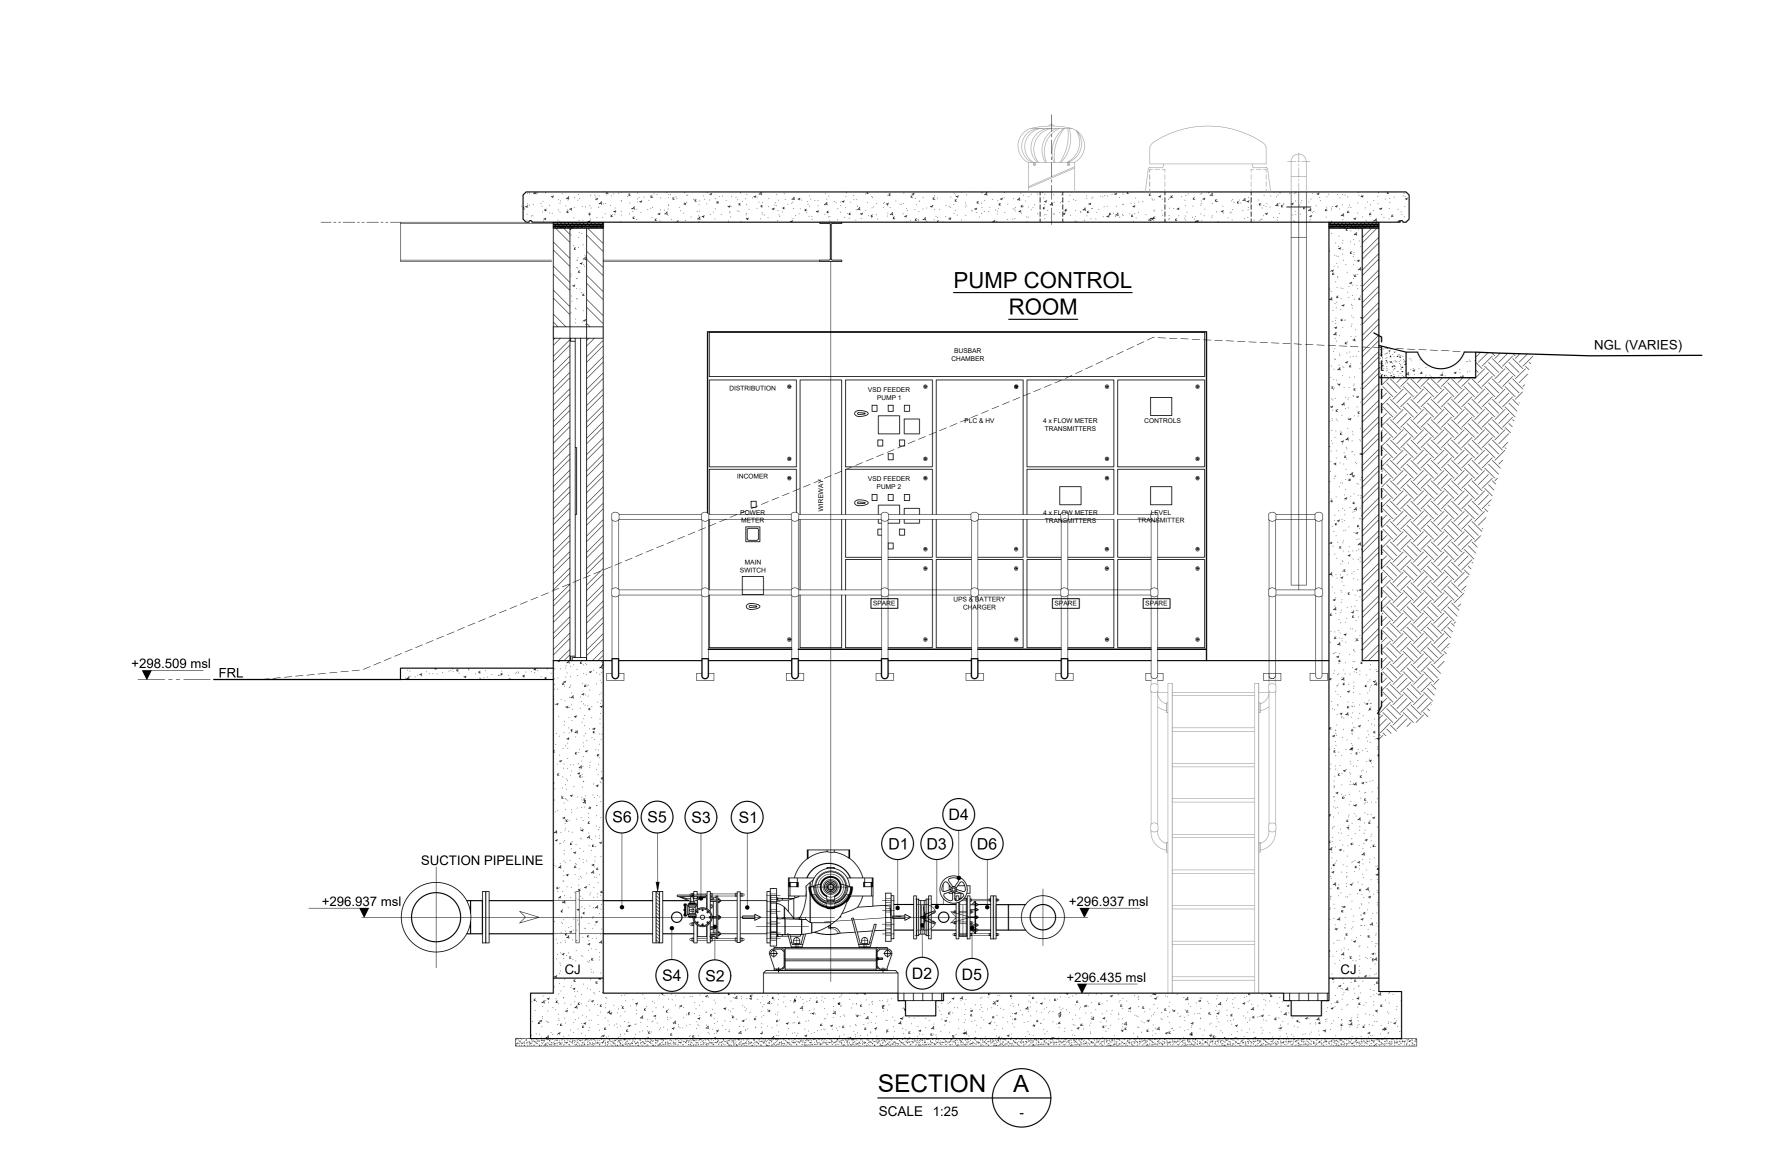
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	SCHEDULE 2 - SUCTION PIPEWORK AND FITTINGS SCHEDULE ALL FITTINGS TO PN16, FLANGES TO SANS 1123 2500/3 & PIPEWORK TO X42/ SANS 719 Grade C									
ITEM NO	NOM DIA	DESCRIPTION	WALL THK (mm)	LINING	COATING	FACE TO FACE	No. OF			
S1	DN200	WITH RESTRAINING FLANGE (R.F) TO SANS 1123 1600/3, (R.F. PLACEMENT & FINAL LENGTH OF PIPE TO BE DETERMINED ON SITE PRIOR TO FABRICATING).	6.0	SFE	SFE	400	2			
		NOTE RF: ANCHORING OR RESTRAINING FLANGE TO BE WELDED APPROXIMATELY 300mm FROM PLAIN END OF ITEM S1. RESTRAINING FLANGE ADAPTOR MINIMUM OF 4 NUMBER GRADE 4.8 RESTRAINING BOLTS TO BE USED, EQUALLY SPACED AROUND CIRCUMFERENCE OF FLANGES.								
S2	DN200	RESTRAINED FLANGE ADAPTOR (KAMFLEX, VIKING JOHNSON) TO SUIT STEEL SPOOL PIPE. FLANGE TO MATCH ITEM S3.		FBE	FBE	<160	2			
S3	DN200	PN16 WAFER BUTTERFLY VALVE TYPE 2 SEMI LUGGED PN16 TYPE 'ISORIA' BY AMRI OR SIMILAR APPROVED, COMPLETE WITH HANDWHEEL, GEARBOX, NUTS, BOLTS, WASHERS AND GASKETS. VALVE TO BE INSTALLED THAT DISC IS HORIZONTAL TO FLOW.		E.P.D.M. TO EN1092-1	FBE		2			
S4	DN200	SPOOL PIECE, FLANGED BOTH ENDS AND FITTED WITH C/W 25mm GAS SOCKET	6.0	SFE	SFE	250	2			
S5	DN200	INSULATING FLANGE (INCLUSIVE OF ALL SLEEVES AND BOLTS)					2			
S6	DN200	SPOOL PIECE WITH SANS 1123 1600/3 THRUST PUDDLE FLANGE (P.F) PLACED 520mm FROM DOWNSTREAM END OF PIPE, B.E.F. (FINAL LENGTH TO BE DETERMINED ON SITE PRIOR TO FABRICATING). ITEM TO BE CAST INTO CONCRETE WALL.	6.0	SFE	SFE	1200	1			
S7		SPOOL PIECE WITH SANS 1123 1600/3 THRUST PUDDLE FLANGE (P.F) PLACED 520mm FROM DOWNSTREAM END OF PIPE, B.E.F. (FINAL LENGTH TO BE DETERMINED ON SITE PRIOR TO FABRICATING). ITEM TO BE CAST INTO CONCRETE WALL.	6.0	SFE	SFE	1050	1			
S8	DN200	90° (ANSI) B16.9 LONG RADIUS BEND WITH 100mm SPOOL PIECES WELDED TO BOTH ENDS, B.E.F	6.0	SFE	SFE		1			
S9	DN200 x DN300	(ANSI) B16.9 CONCENTRIC REDUCER WITH 100mm LONG SPOOL PIECE WELDED ON BOTH ENDS, B.E.F.	6.0	SFE	SFE	403	1			
S10	DN300	SPOOL PIPE, B.E.F. (LENGTH TO BE VERIFIED ON SITE).	6.0	SFE	SFE	950	1			
S11	DN300 x DN200	(ANSI) B16.9 REDUCING TEE, WITH 100mm LONG SPOOL PIECE WELDED ON ALL ENDS. FF 708mm & CF 329mm. (LENGTHS TO BE VERIFIED ON SITE).	6.0	SFE	SFE	1700	1			

	ALL I	SCHEDULE 2 - DISCHARGE PIPEWORK AND F FITTINGS TO PN16, FLANGES TO SANS 1123 2500/3 & PI		_		de C	
ITEM NO	NOM DIA	DESCRIPTION	WALL THK (mm)	LINING	COATING	FACE TO FACE	No. OF
D1	DN150	SPOOL PIPE FF 1000mm, B.E.F. ONE FLANGE TO MATCH ITEM D2. (LENGTH TO BE VERIFIED ON SITE).	6.0	SFE	SFE	220	2
D2	DN150	EPOXY COATED AND LINED DUCTILE IRON WAFER NON RETURN VALVE, 'AMRI SERIE 2000' OR SIMILAR APPROVED DOUBLE DISK SPRING SWING CHECK VALVE		FBE	FBE	76	2
D3	DN150	SPOOL PIECE, FITTED WITH C/W 25mm SOCKET FOR FLOW SWITCH, B.E.F. ONE FLANGE TO MATCH ITEM D2 AND THE OTHER LANGE TO MATCH ITEM D4 (FINAL LENGTH TO BE DETERMINED ON SITE)	6.0	SFE	SFE	220	2
D4	DN150	PN16 WAFER BUTTERFLY VALVE TYPE 2 SEMI LUGGED PN16 TYPE 'ISORIA' BY AMRI OR SIMILAR APPROVED, COMPLETE WITH HANDWHEEL, GEARBOX, NUTS, BOLTS, WASHERS AND GASKETS. VALVE TO BE INSTALLED THAT DISC IS HORIZONTAL TO FLOW.		E.P.D.M. TO EN1092-1	FBE		2
D5	DN150	RESTRAINED FLANGE ADAPTOR (KAMFLEX, VIKING JOHNSON) TO SUIT STEEL SPOOL PIPE. FLANGE TO MATCH ITEM D4.		FBE	FBE	<160	2
D6	DN150	SPOOL PIECE, F.O.E, OTHER END PLAIN ENDED (PE). FINAL LENGTH OF PIPE TO BE DETERMINED ON SITE PRIOR TO FABRICATING).	6.0	SFE	SFE	150	2
D7	DN150	90° (ANSI) B16.9 LONG RADIUS BEND WITH 100mm SPOOL PIECES WELDED TO BOTH ENDS, B.E.F	6.0	SFE	SFE		1
D8	DN150	SPOOL PIPE, B.E.F. (LENGTH TO BE VERIFIED ON SITE).	6.0	SFE	SFE	1600	1
D9	DN150	(ANSI) B16.9 EQUAL TEE, WITH 100mm LONG SPOOL PIECE WELDED ON ALL ENDS. FF 508mm & CF 257mm (LENGTHS TO BE VERIFIED ON SITE).	6.0	SFE	SFE	508	1
D10	DN150	SPOOL PIPE, B.E.F. (LENGTH TO BE VERIFIED ON SITE).	6.0	SFE	SFE	350	1
D11	DN150	SPOOL PIECE WITH SANS 1123 1600/3 THRUST PUDDLE FLANGE (P.F) PLACED 520mm FROM DOWNSTREAM END OF PIPE, B.E.F. (FINAL LENGTH TO BE DETERMINED ON SITE PRIOR TO FABRICATING). ITEM TO BE CAST INTO CONCRETE WALL.	6.0	SFE	SFE	1050	1
D12	DN300 x DN150	(ANSI) B16.9 CONCENTRIC REDUCER WITH 100mm LONG SPOOL PIECE WELDED ON BOTH ENDS, B.E.F.	6.0	SFE	SFE	403	1

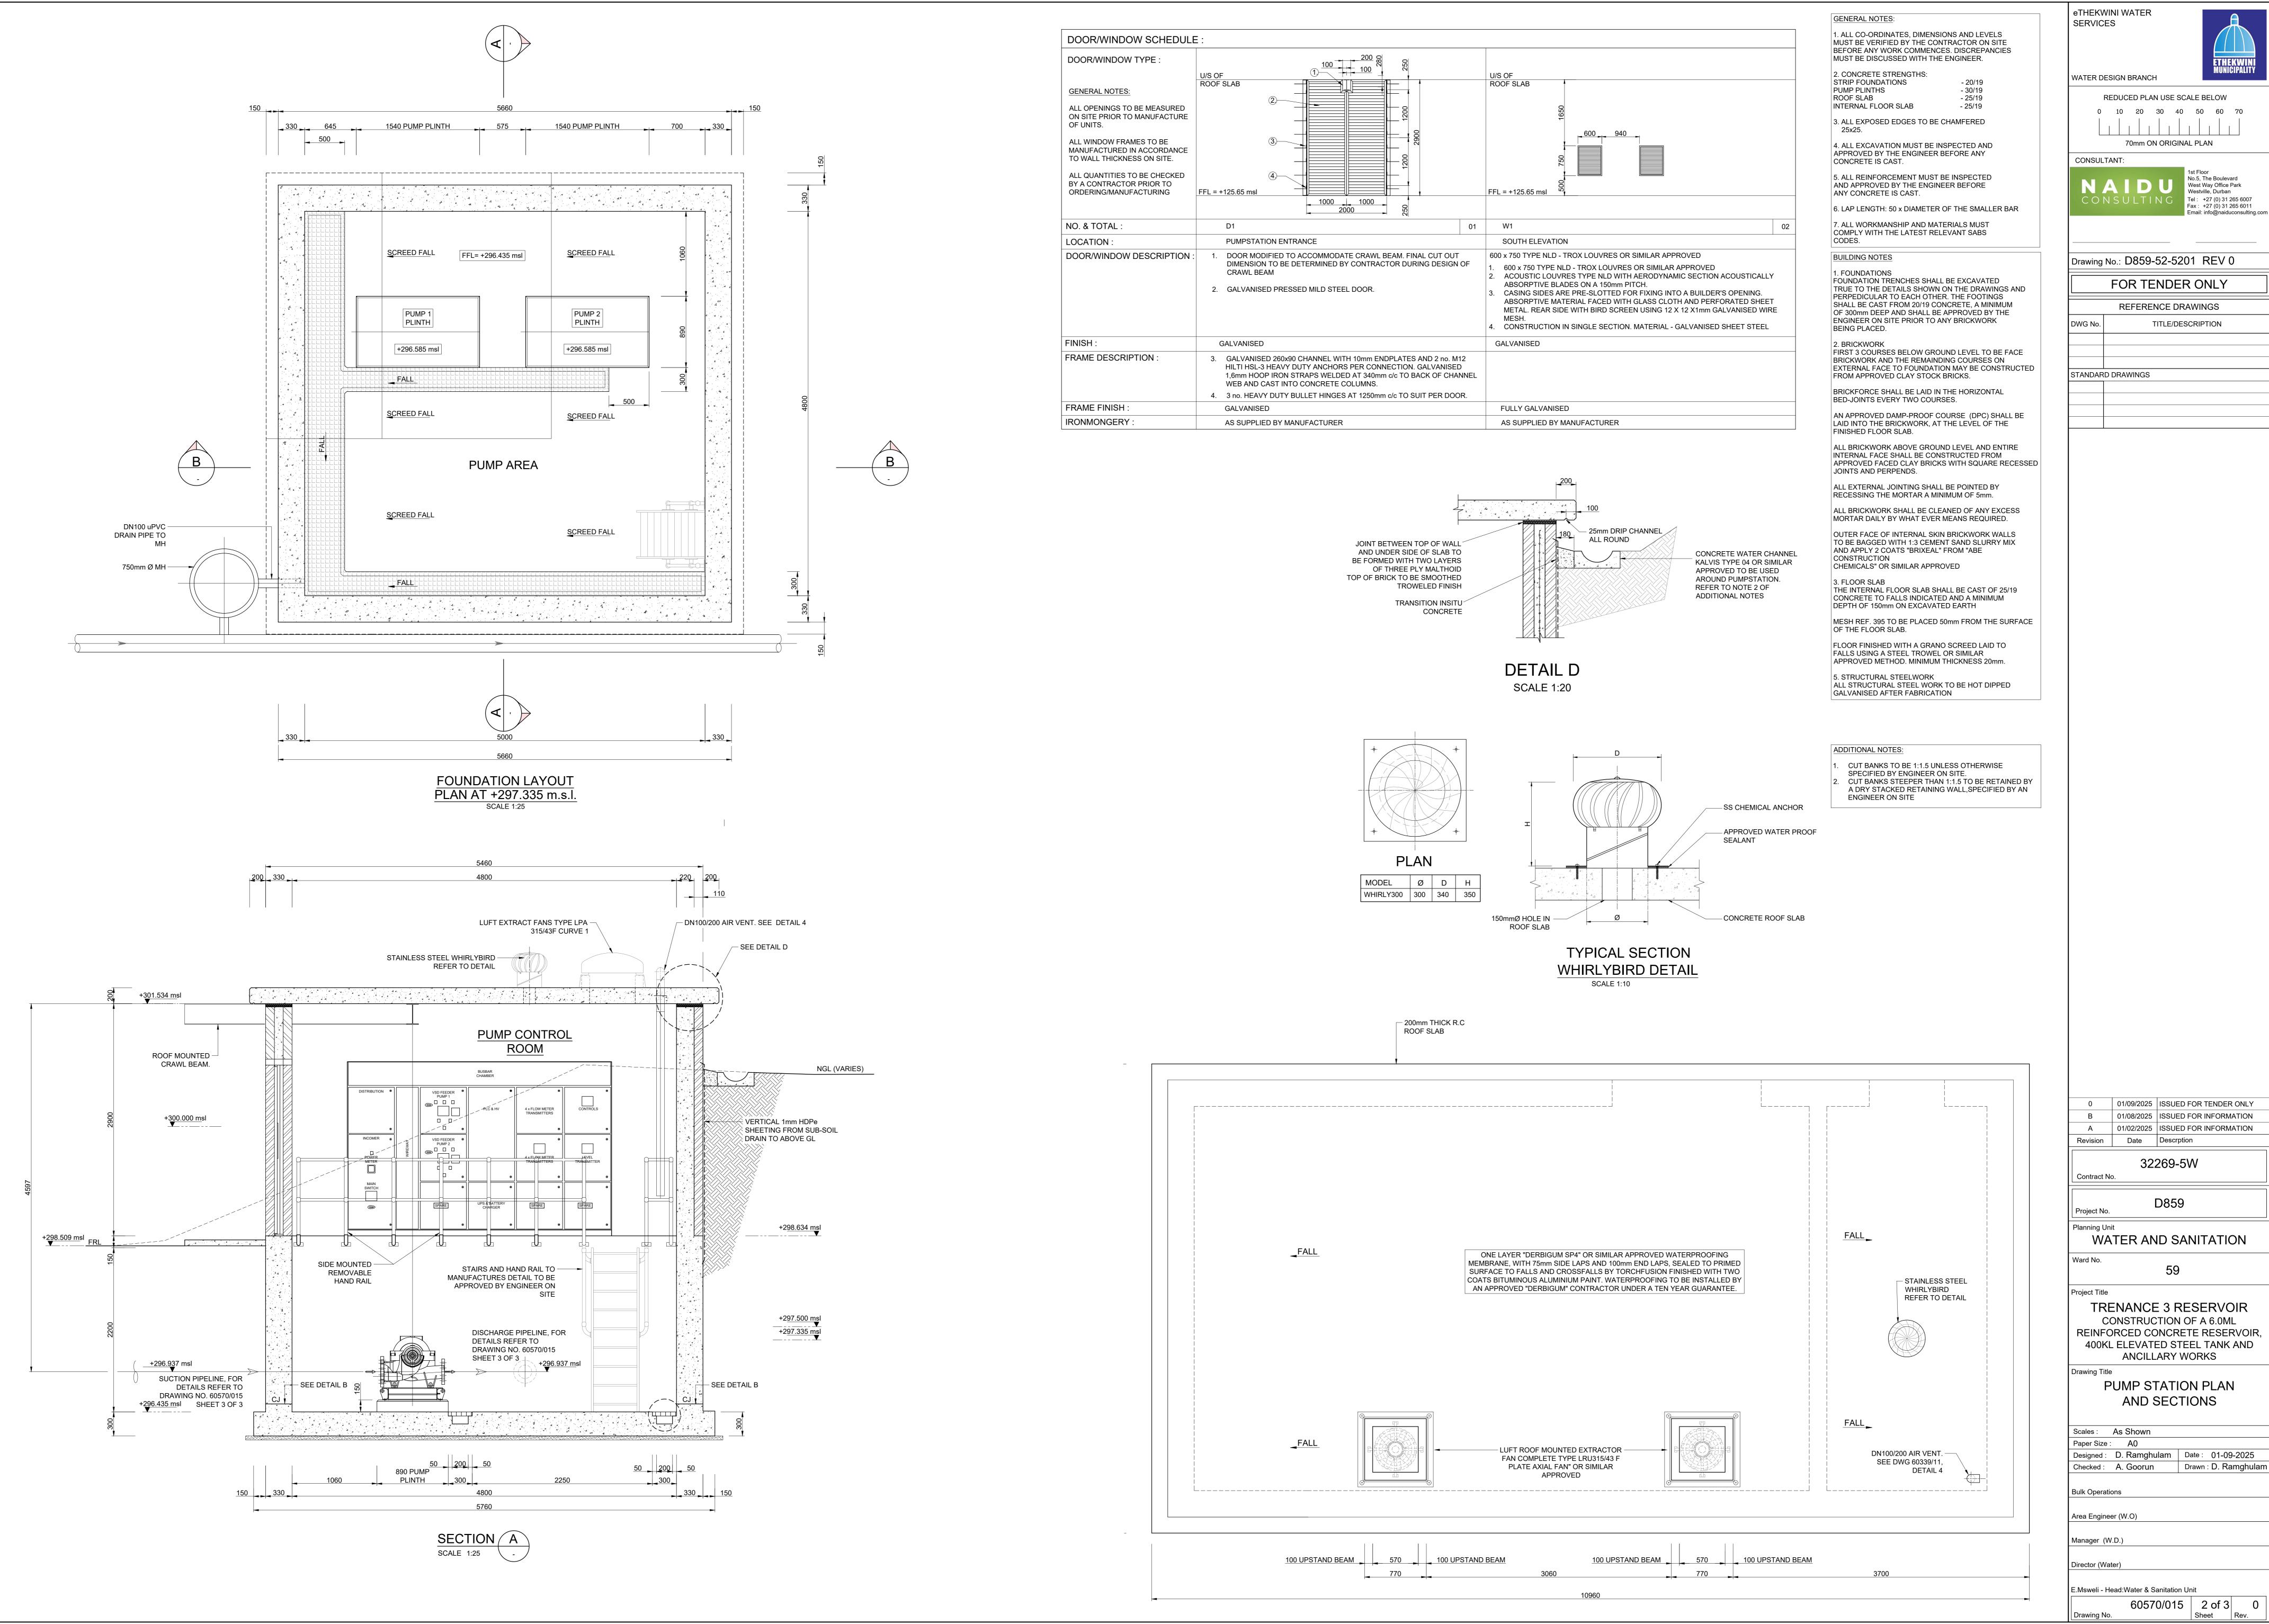ABBREVIATIONS ID - INSIDE DIAMETER DN - DIAMETER NOMINAL OD - OUTSIDE DIAMETER MILD STEEL SS -STAINLESS STEEL SFE -SOLVENT FREE EPOXY FBE FUSION BONDED EPOXY CML CEMENT MORTAR LINED SNT SINTAKOTE RSN -RILSAN F/F FACE TO FACE DIMENSION C/F -CENTER TO FACE DIMENSION FOE -FLANGED ONE END BEF BOTH ENDS FLANGED FAR -FLANGED ALL ROUND LONG RADIUS BEND MEDUM RADIUS BEND SRB SHORT RADIUS BEND HDG -HOT DIPPED GALVANIZED P.E.C - PLAIN ENDED COATED P.F -PUDDLE FLANGE P.T -PUDDLE PLATE R.F RESTRAINING FLANGE - ⊢ FINAL ROAD LEVEL - NATURAL GROUNDILEVEL FINISH FLOOR LEV

PLAN LAYOUT

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2. CONCRETE STRENGTHS: STRIP FOUNDATIONS PUMP PLINTHS - 30/19 ROOF SLAB INTERNAL FLOOR SLAB - 25/19

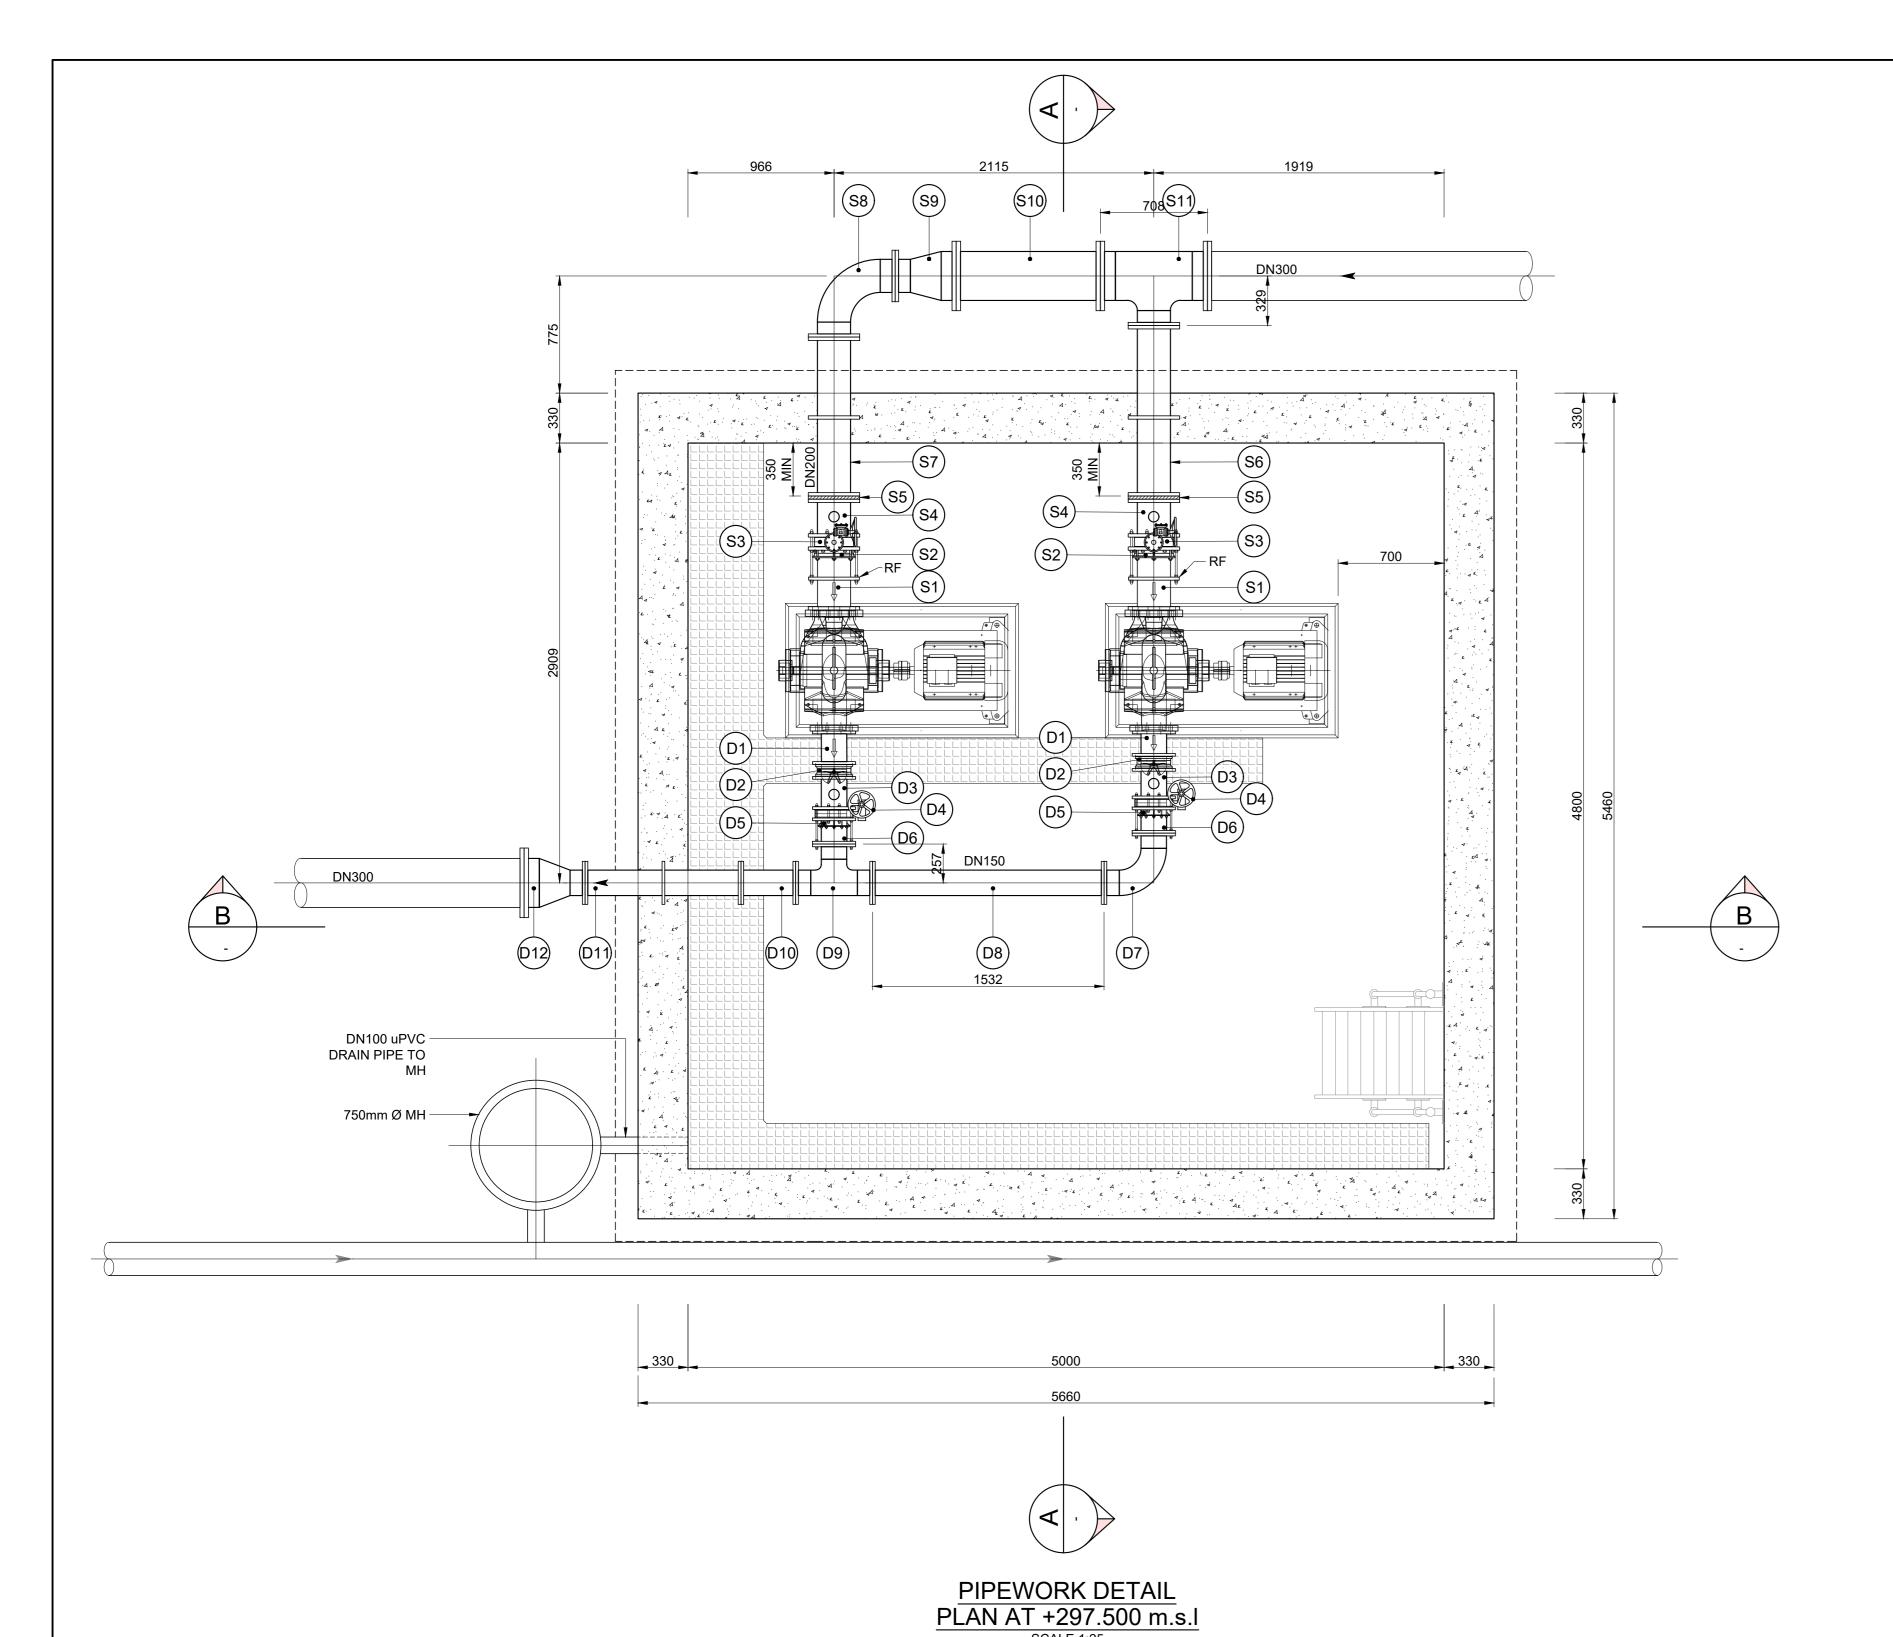3. ALL EXPOSED EDGES TO BE CHAMFERED

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5. ALL REINFORCEMENT MUST BE INSPECTED AND APPROVED BY THE ENGINEER BEFORE ANY CONCRETE IS CAST.

6. LAP LENGTH: 50 x DIAMETER OF THE SMALLER BAR 7. ALL WORKMANSHIP AND MATERIALS MUST COMPLY WITH THE LATEST RELEVANT SABS

BUILDING NOTES

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FIRST 3 COURSES BELOW GROUND LEVEL TO BE FACE BRICKWORK AND THE REMAINDING COURSES ON EXTERNAL FACE TO FOUNDATION MAY BE CONSTRUCTED

FROM APPROVED CLAY STOCK BRICKS. BRICKFORCE SHALL BE LAID IN THE HORIZONTAL

BED-JOINTS EVERY TWO COURSES.

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INTERNAL FACE SHALL BE CONSTRUCTED FROM APPROVED FACED CLAY BRICKS WITH SQUARE RECESSED JOINTS AND PERPENDS.

ALL BRICKWORK ABOVE GROUND LEVEL AND ENTIRE

ALL EXTERNAL JOINTING SHALL BE POINTED BY RECESSING THE MORTAR A MINIMUM OF 5mm.

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OUTER FACE OF INTERNAL SKIN BRICKWORK WALLS TO BE BAGGED WITH 1:3 CEMENT SAND SLURRY MIX AND APPLY 2 COATS "BRIXEAL" FROM "ABE CONSTRUCTION CHEMICALS" OR SIMILAR APPROVED

THE INTERNAL FLOOR SLAB SHALL BE CAST OF 25/19 CONCRETE TO FALLS INDICATED AND A MINIMUM DEPTH OF 150mm ON EXCAVATED EARTH

MESH REF. 395 TO BE PLACED 50mm FROM THE SURFACE OF THE FLOOR SLAB.

FLOOR FINISHED WITH A GRANO SCREED LAID TO FALLS USING A STEEL TROWEL OR SIMILAR APPROVED METHOD. MINIMUM THICKNESS 20mm.

5. STRUCTURAL STEELWORK ALL STRUCTURAL STEEL WORK TO BE HOT DIPPED GALVANISED AFTER FABRICATION

ADDITIONAL NOTES:

3. FLOOR SLAB

I. CUT BANKS TO BE 1:1.5 UNLESS OTHERWISE SPECIFIED BY ENGINEER ON SITE. 2. CUT BANKS STEEPER THAN 1:1.5 TO BE RETAINED BY A DRY STACKED RETAINING WALL, SPECIFIED BY AN ENGINEER ON SITE

PIPEWORK NOTES

ALL STEEL PIPES & FITTINGS 150 NB AND SMALLER TO BE MEDIUM DUTY TO SABS 62 UNLESS OTHERWISE SPECIFIED.

ALL STEEL PIPES & FITTINGS LARGER THAN 150 NB TO BE min 4.5mm WALL THICKNESS X42 GRADE STEEL

ALL SPECIALS TO ANSI B16.9 STNDARD SCHEDULE

AND DIMENSIONS.

ALL FLANGES & STEEL PIPEWORK TO SANS 1123 TABLE 1600 (UNLESS OTHERWISE SPECIFIED)

CONTRACTOR TO CHECK AND CONFIRM DIMENSIONS OF PIPEWORK AND FLANGE DRILLING OF EXISTING PIPE WORK BEFORE THE FABRICATION OF PIPEWORK

. IF FACE TO FACE OF FITTINGS SHOWN DIFFERS TO ACTUAL THE CONTRACTOR MUST INFORM ENGINEER PRIOR TO PIPE FABRICATION/ INSTALLATION.

ALL STEEL AND SPECIALS TO BE FACTORY COATED AND LINED WITH COPON HYCOTE 162 OR SIMILAR APPROVED TO A TOTAL MINIMUM DRY FILM THICKNESS OF 300 MICRONS.

WHERE FABRICATION AND OR CUTTING ON SITE IS NECESSARY, THE COATING SHALL BE MADE GOOD WITH COPON HYCOTE 162 OR SIMILAR APPROVED

ALL THREADS TO BE BRITISH STANDARD PIPE (BSP)
THREADS. THREADS TO BE PROTECTED WITH STAG.

EPOXY COATING.

10. ALL STEEL COMPONENTS, BOLTS, NUTS & WASHERS

TO BE HOT DIP GALVANISED TO ISO 1461 : 2009 1. ALL PIPEWORK PASSING THROUGH BRICKWORK/ MORTAR TO BE WRAPPED IN "DENSO" ULTRAFLEX

2. ALL BURIED FITTINGS AND PIPES TO BE PROTECTED BY "DENSO" IN ACCORDANCE WITH PROJECT SPECIFICATIONS.

1250 WHERE IN CONTACT WITH BRICKWORK /

13. ALL STAINLESS STEEL SHALL BE STAINLESS STEEL

GRADE 316 14. ALL STAINLESS STEEL BENDS, REDUCERS, ETC

FOR GENERAL NOTES SEE DWG No. 60339/100

SHALL BE ANSI B16.9 FITTINGS

REDUCED PLAN USE SCALE BELOW 0 10 20 30 40 50 60 70 70mm ON ORIGINAL PLAN

eTHEKWINI WATER

WATER DESIGN BRANCH

SERVICES

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Email: info@naiduconsulting.co

Drawing No.: D859-52-5201 REV 0 FOR TENDER ONLY

REFERENCE DRAWINGS

TITLE/DESCRIPTION

STANDARD DRAWINGS

01/09/2025 ISSUED FOR TENDER ONLY 01/08/2025 ISSUED FOR INFORMATION 01/02/2025 ISSUED FOR INFORMATION Date Descrption

32269-5W

WATER AND SANITATION

59

Contract No.

TRENANCE 3 RESERVOIR CONSTRUCTION OF A 6.0ML REINFORCED CONCRETE RESERVOIR, 400KL ELEVATED STEEL TANK AND ANCILLARY WORKS

PUMP STATION SUCTION AND DISCHARGE PIPELINES DETAILS


Scales: As Shown Paper Size : A0 Designed: D. Ramghulam Date: 01-09-2025 Checked: A. Goorun Drawn: D. Ramghulam


Bulk Operations


Area Engineer (W.O) Manager (W.D.)


Director (Water)

E.Msweli - Head:Water & Sanitation Unit 60570/015 3 of 3 0 Sheet Rev.

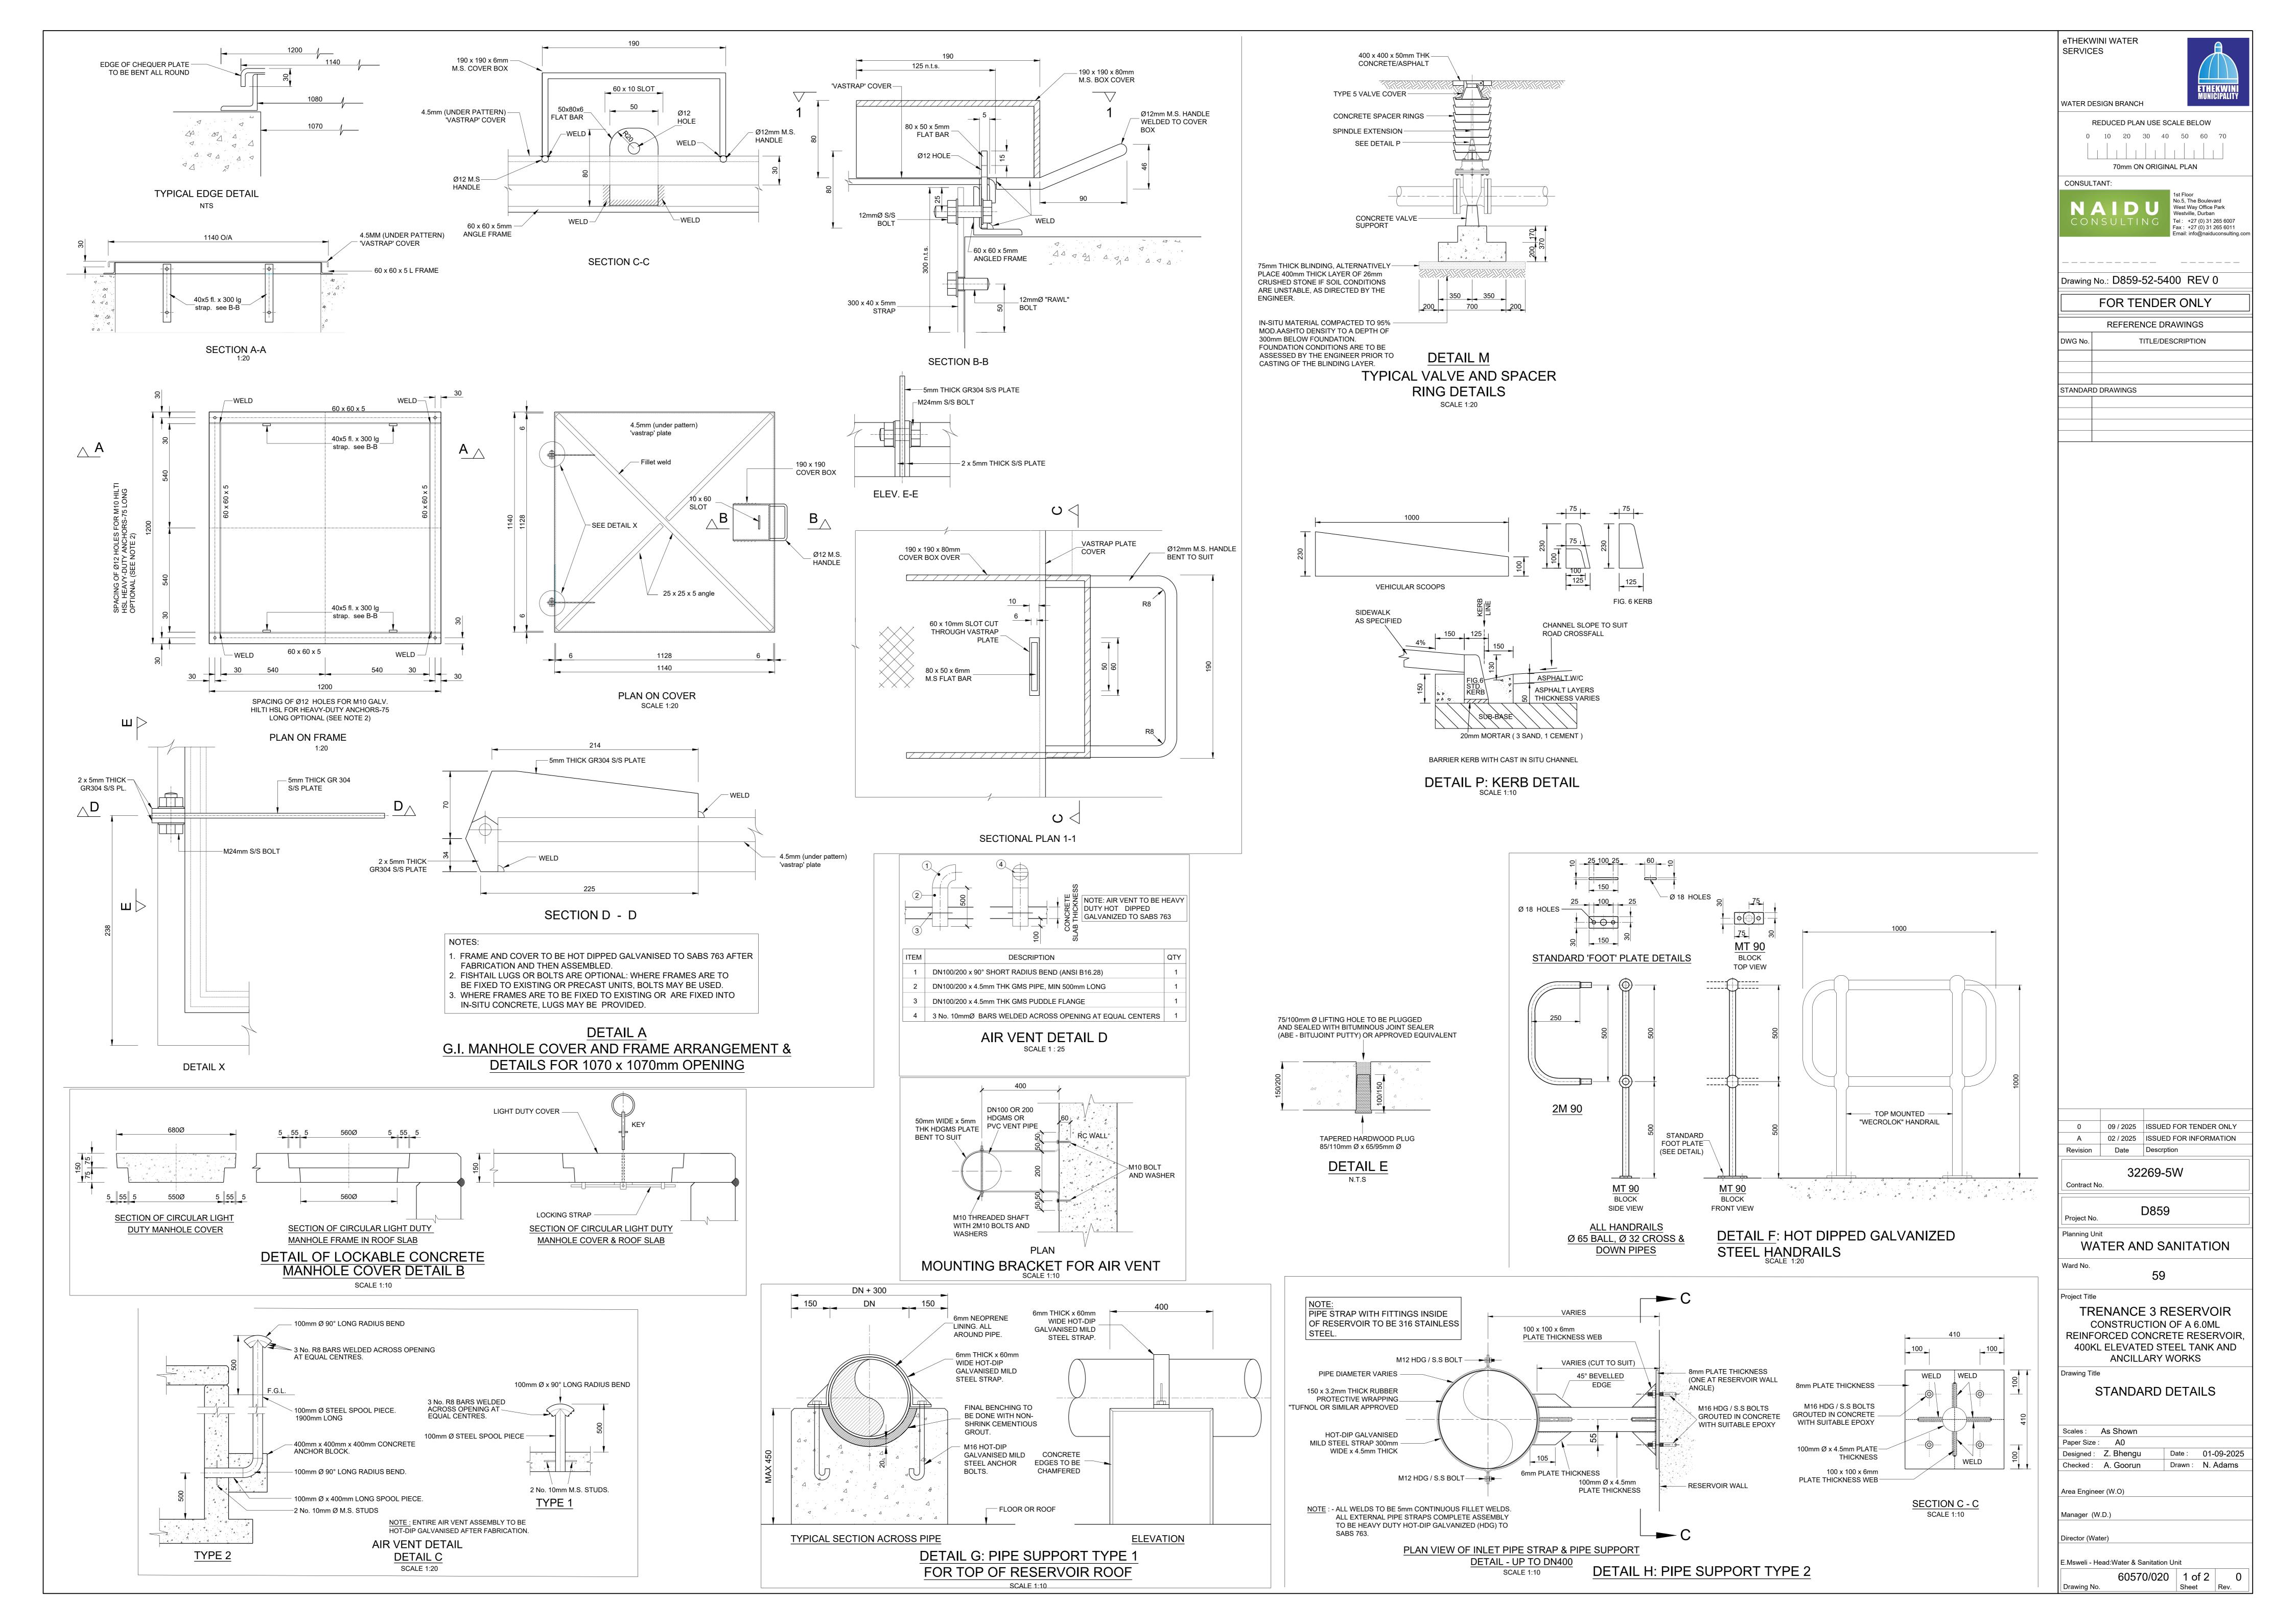


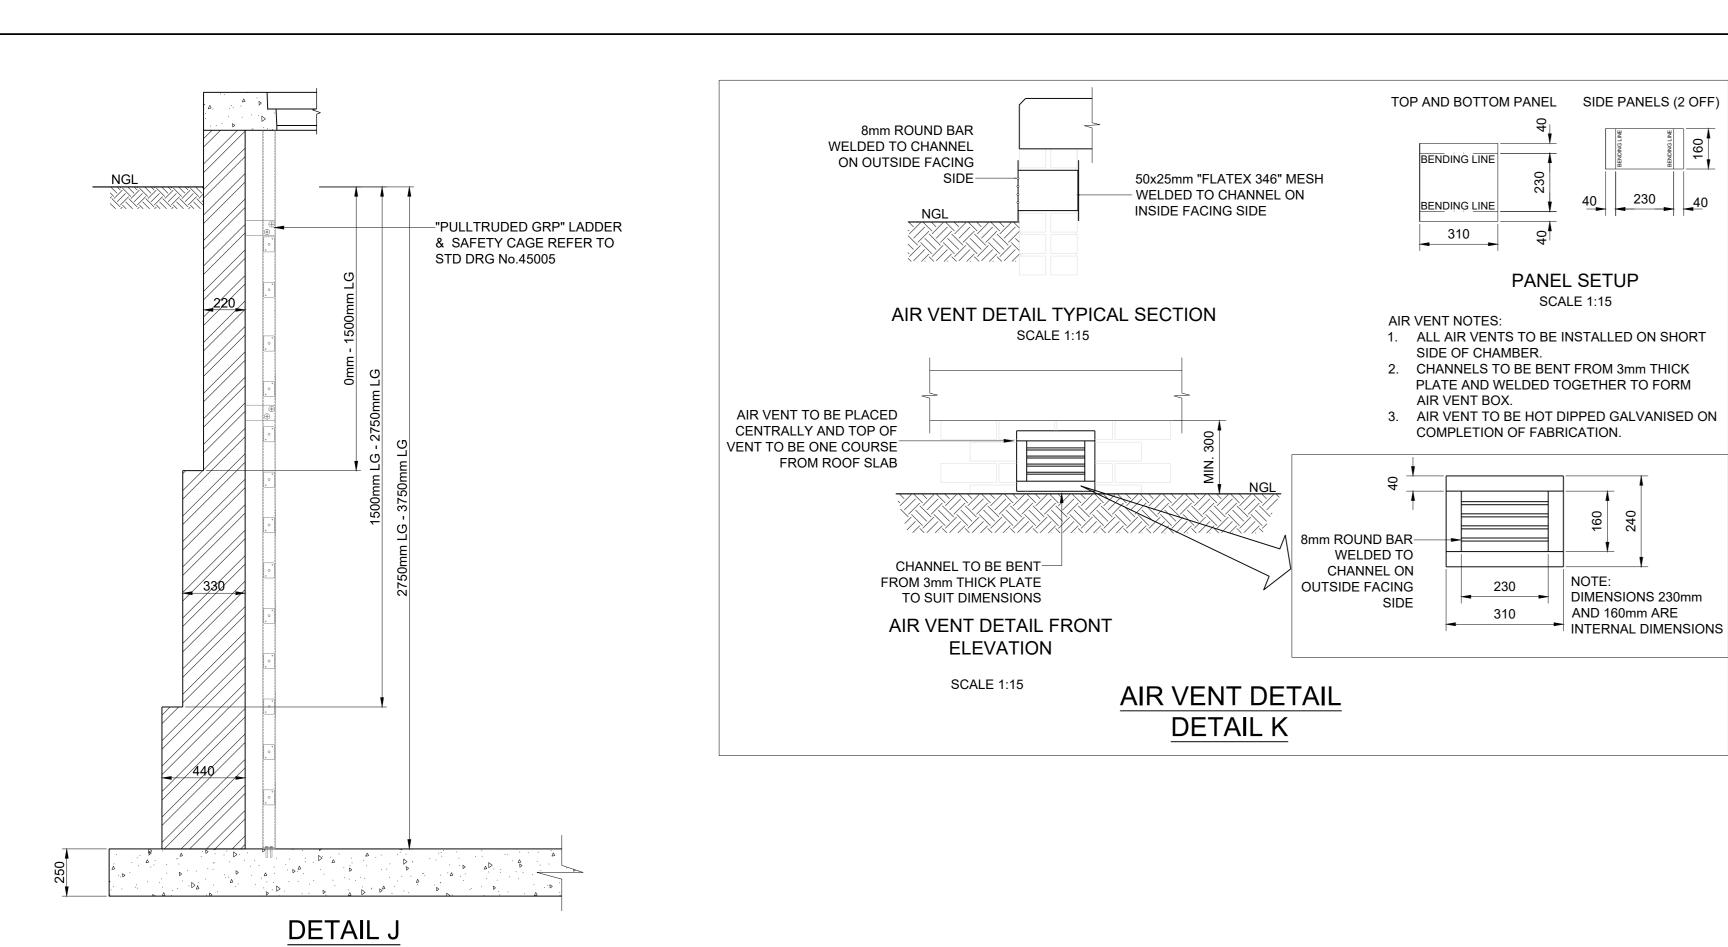

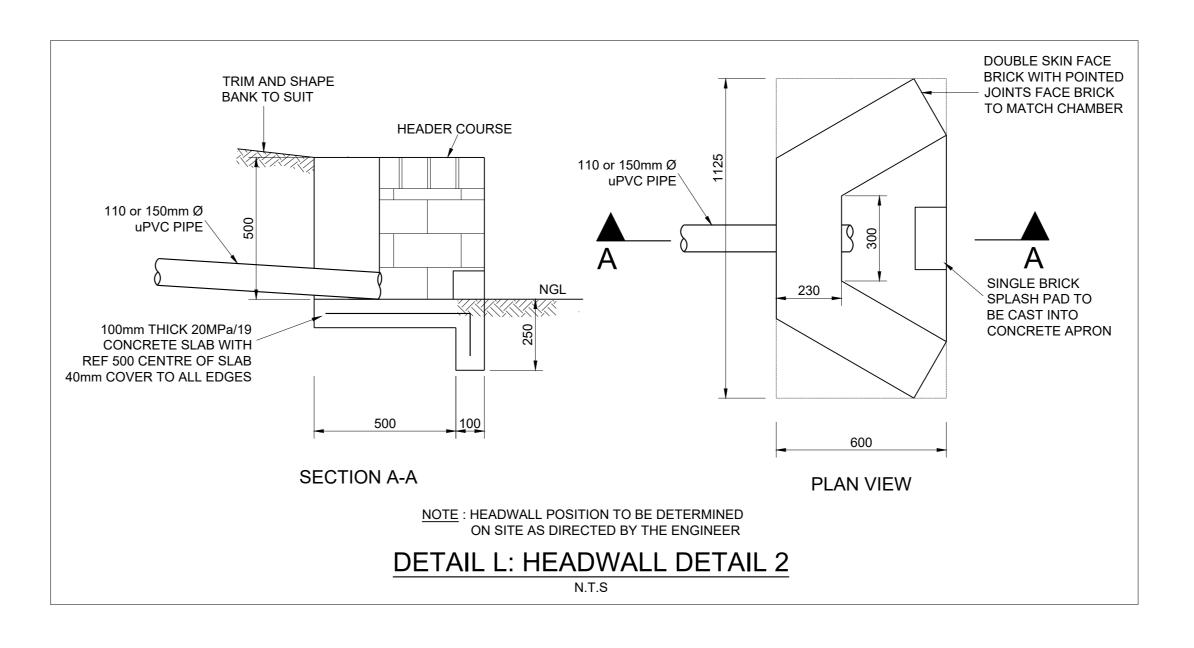

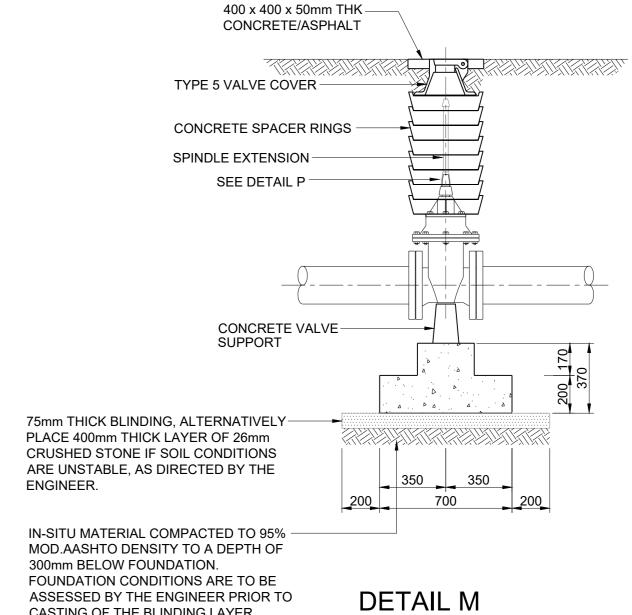


CASTING OF THE BLINDING LAYER.

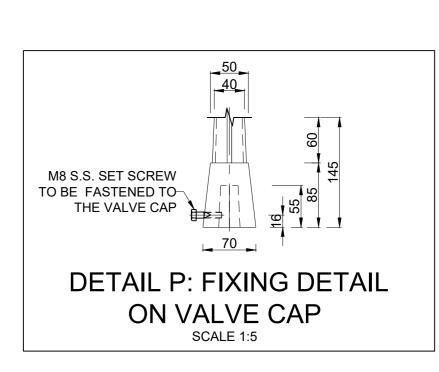

TYPICAL VALVE AND SPACER

RING DETAILS SCALE 1:20

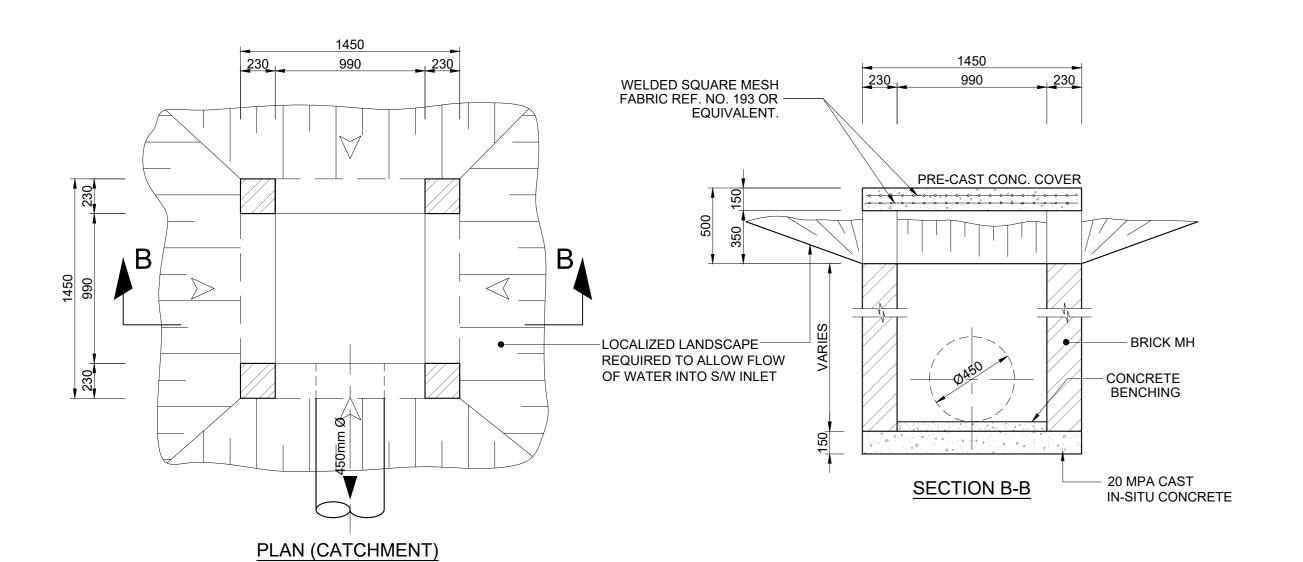


STANDARD DETAIL ON VARYING BRICK


THICKNESS FOR DIFFERENT DEPTHS SCALE 1:20

(DRAWN WITHOUT LID FOR CLARITY)

DETAIL N DEPRESSED INLET DETAIL

SCALE 1:25

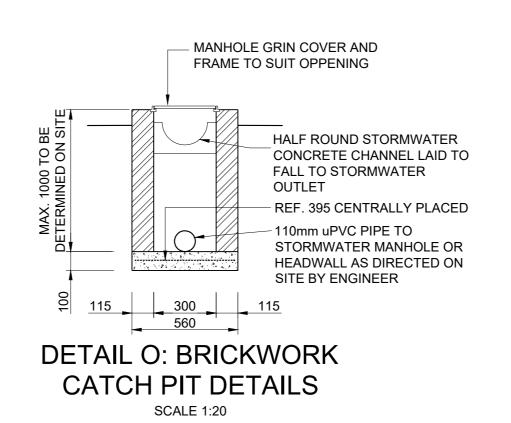

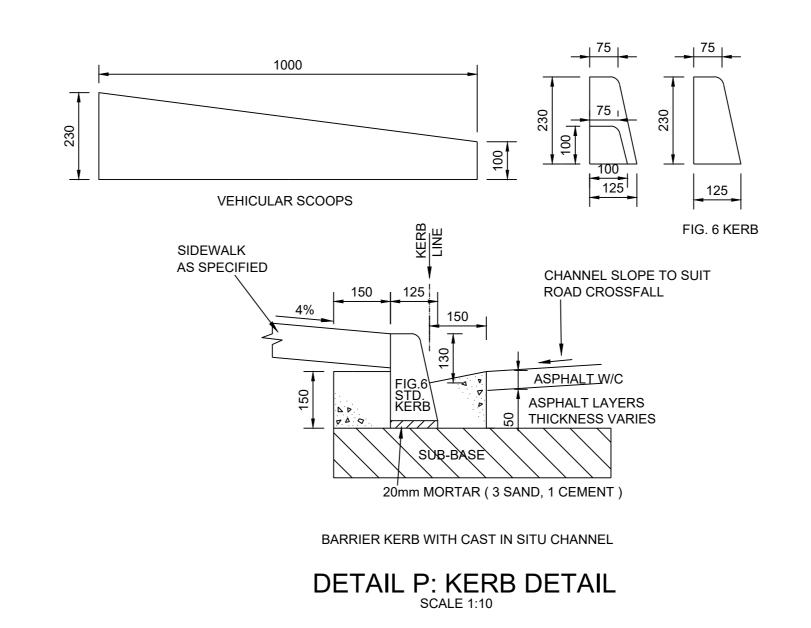

0 09 / 2025 ISSUED FOR TENDER ONLY A 02 / 2025 ISSUED FOR INFORMATION Revision Date Descrption 32269-5W Contract No. Project No. Planning Unit WATER AND SANITATION Ward No. Project Title TRENANCE 3 RESERVOIR CONSTRUCTION OF A 6.0ML REINFORCED CONCRETE RESERVOIR, 400KL ELEVATED STEEL TANK AND ANCILLARY WORKS STANDARD DETAILS Scales: As Shown Paper Size : A0 Designed: Z. Bhengu Checked: A. Goorun Area Engineer (W.O) Manager (W.D.) Director (Water) E.Msweli - Head:Water & Sanitation Unit 60570/020 2 of 2 0

59

Date: 01-09-2025 Drawn: N. Adams

Sheet Rev.

eTHEKWINI WATER

WATER DESIGN BRANCH

CONSULTANT:

STANDARD DRAWINGS

REDUCED PLAN USE SCALE BELOW

0 10 20 30 40 50 60 70

70mm ON ORIGINAL PLAN

FOR TENDER ONLY

REFERENCE DRAWINGS

TITLE/DESCRIPTION

Drawing No.: D859-52-5400 REV 0

1st Floor No.5, The Boulevard


Westville, Durban

West Way Office Park

Tel: +27 (0) 31 265 6007 Fax: +27 (0) 31 265 6011

Email: info@naiduconsulting.co

SERVICES

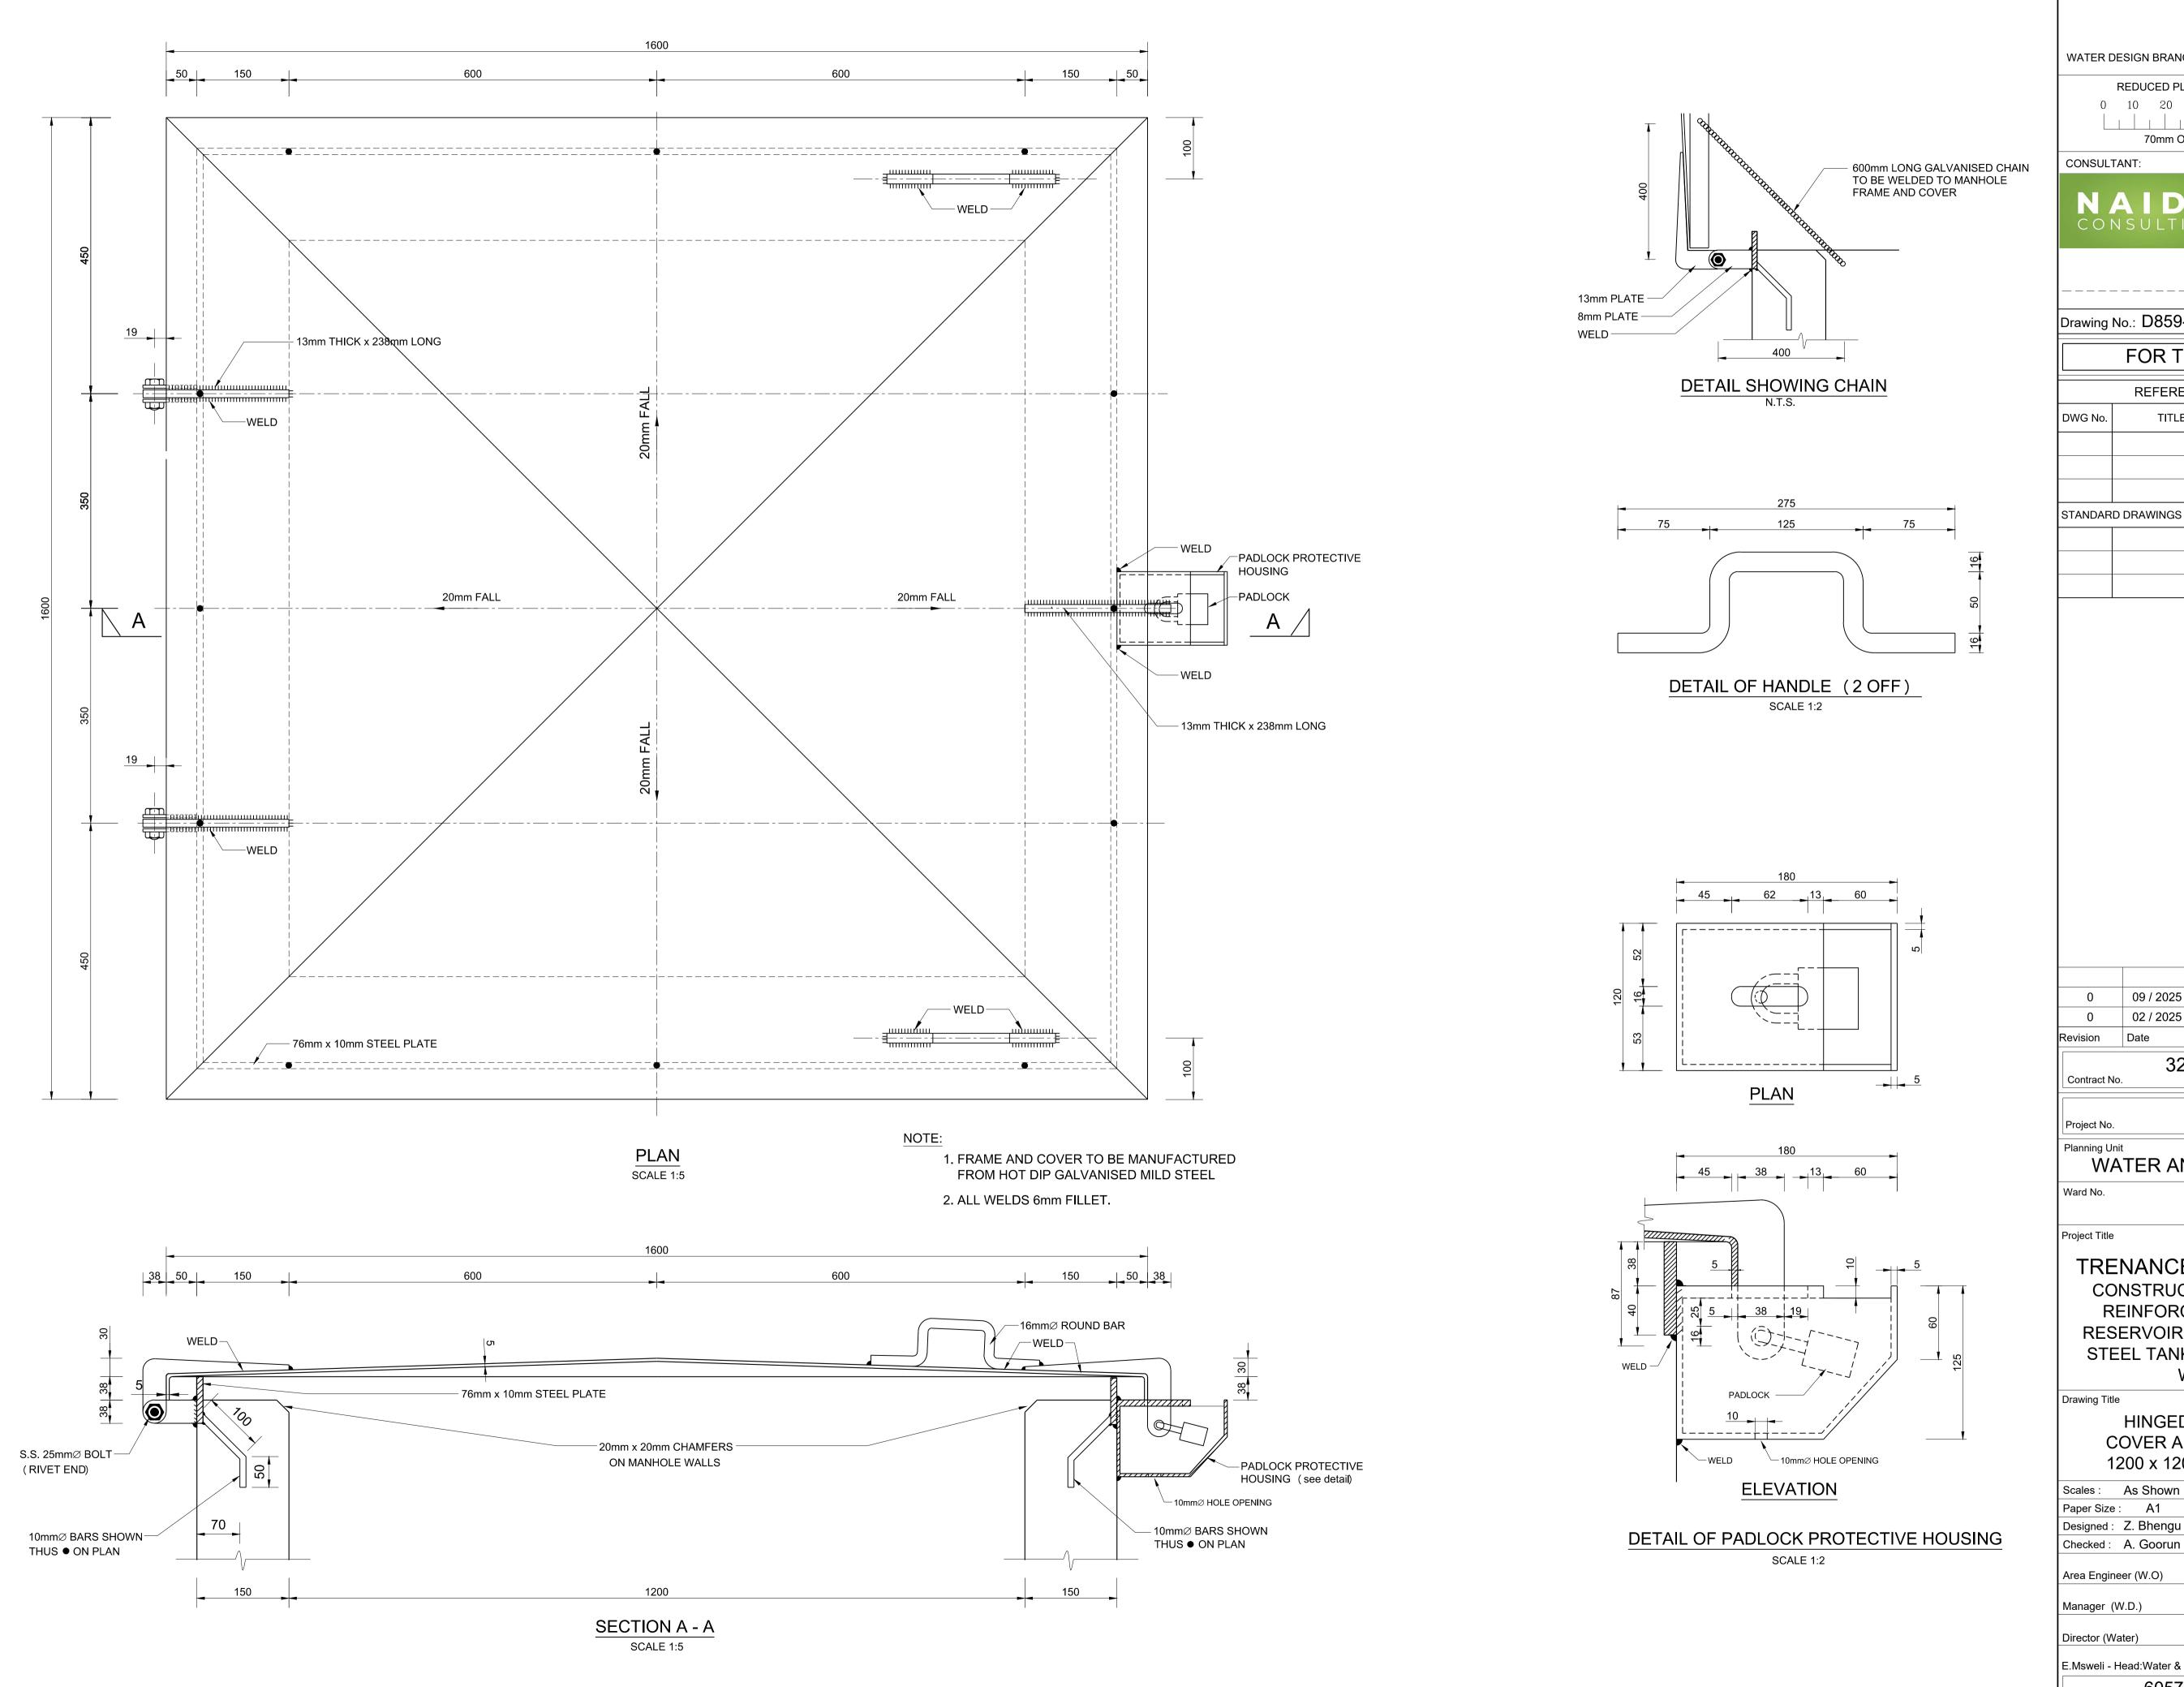

eTHEKWINI WATER SERVICES

WATER DESIGN BRANCH

REDUCED PLAN USE SCALE BELOW 0 10 20 30 40 50 60 70 70mm ON ORIGINAL PLAN

1st Floor No.5, The Boulevard West Way Office Park Westville, Durban Tel: +27 (0) 31 265 6007 Fax: +27 (0) 31 265 6011

Drawing No.: D859-52-5401- REV0

FOR TENDER ONLY

REFERENCE DRAWINGS TITLE/DESCRIPTION SOURCE

09 / 2025 ISSUED FOR TENDER ONLY 02 / 2025 ISSUED FOR INFORMATION Description

32269-5W

D859

WATER AND SANITATION

59

TRENANCE 3 RESERVOIR CONSTRUCTION OF A 6.0ML REINFORCED CONCRETE RESERVOIR, 400KL ELEVATED STEEL TANK AND ANCILLARY WORKS

> HINGED MILD STEEL COVER AND FRAME FOR 1200 x 1200mm OPENING


Scales: As Shown Designed: Z. Bhengu


Date: 01-09-2025 Drawn: N. Adams


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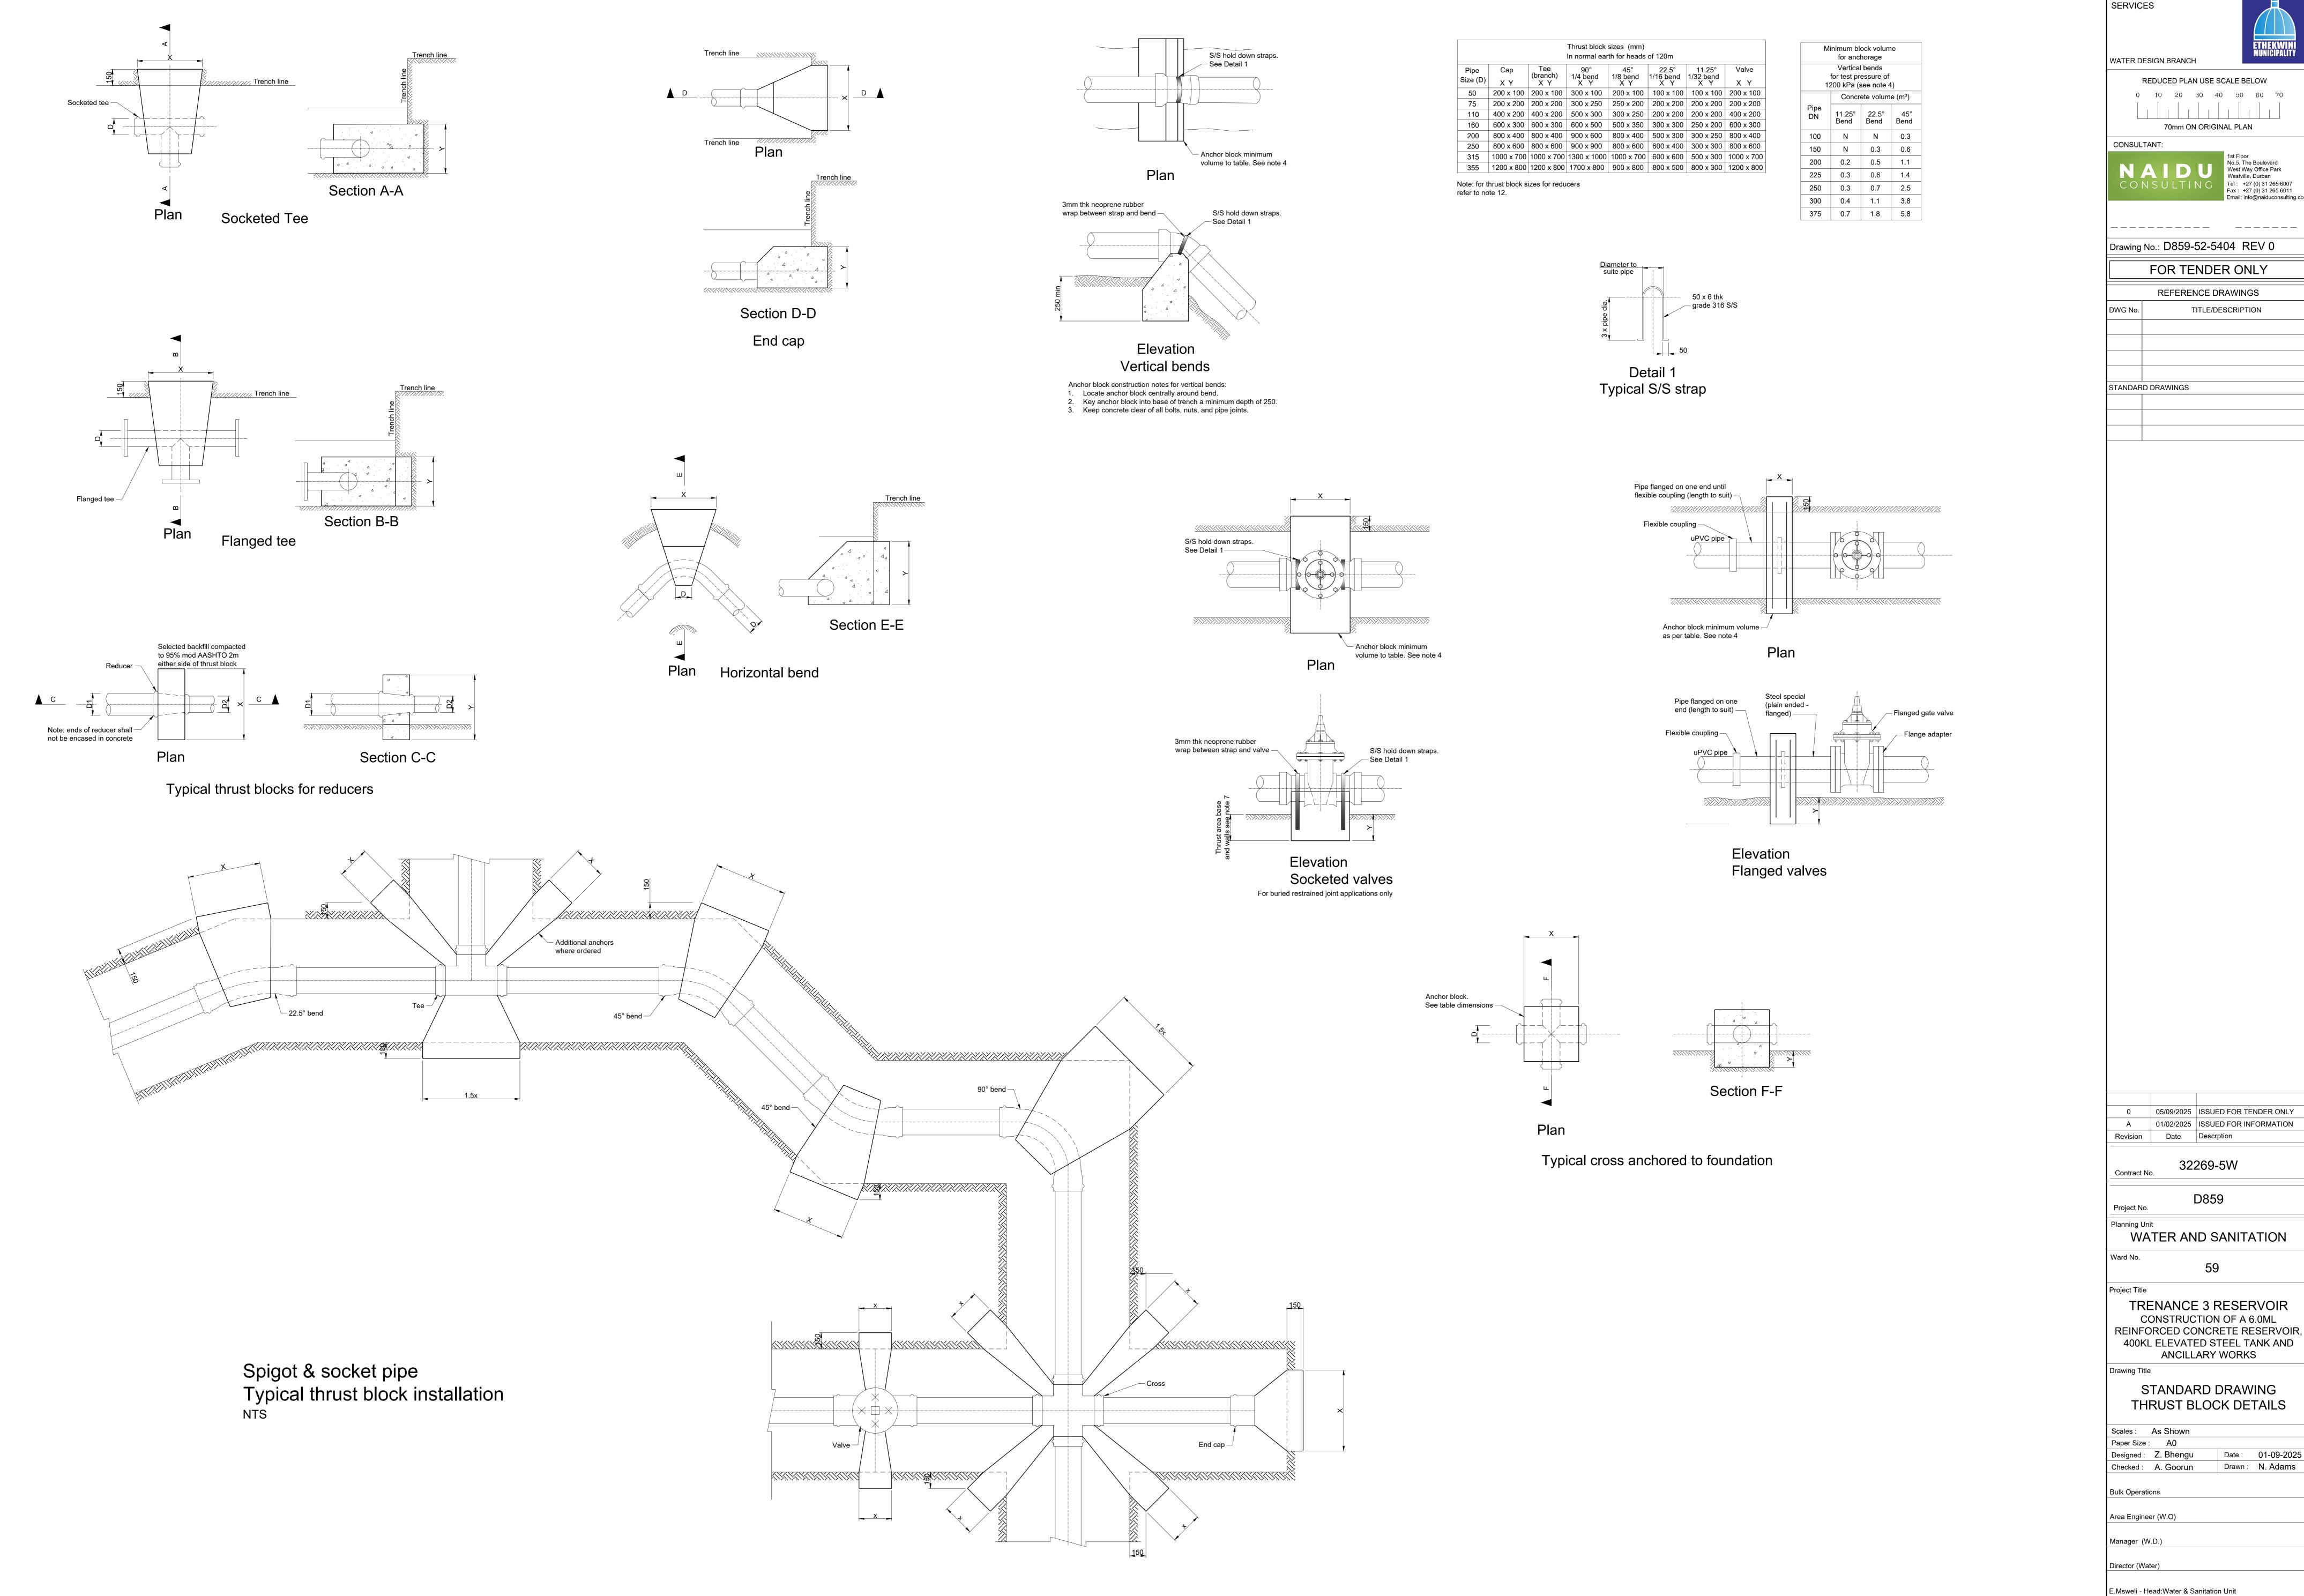
E.Msweli - Head:Water & Sanitation Unit

60570/021 1 of 1



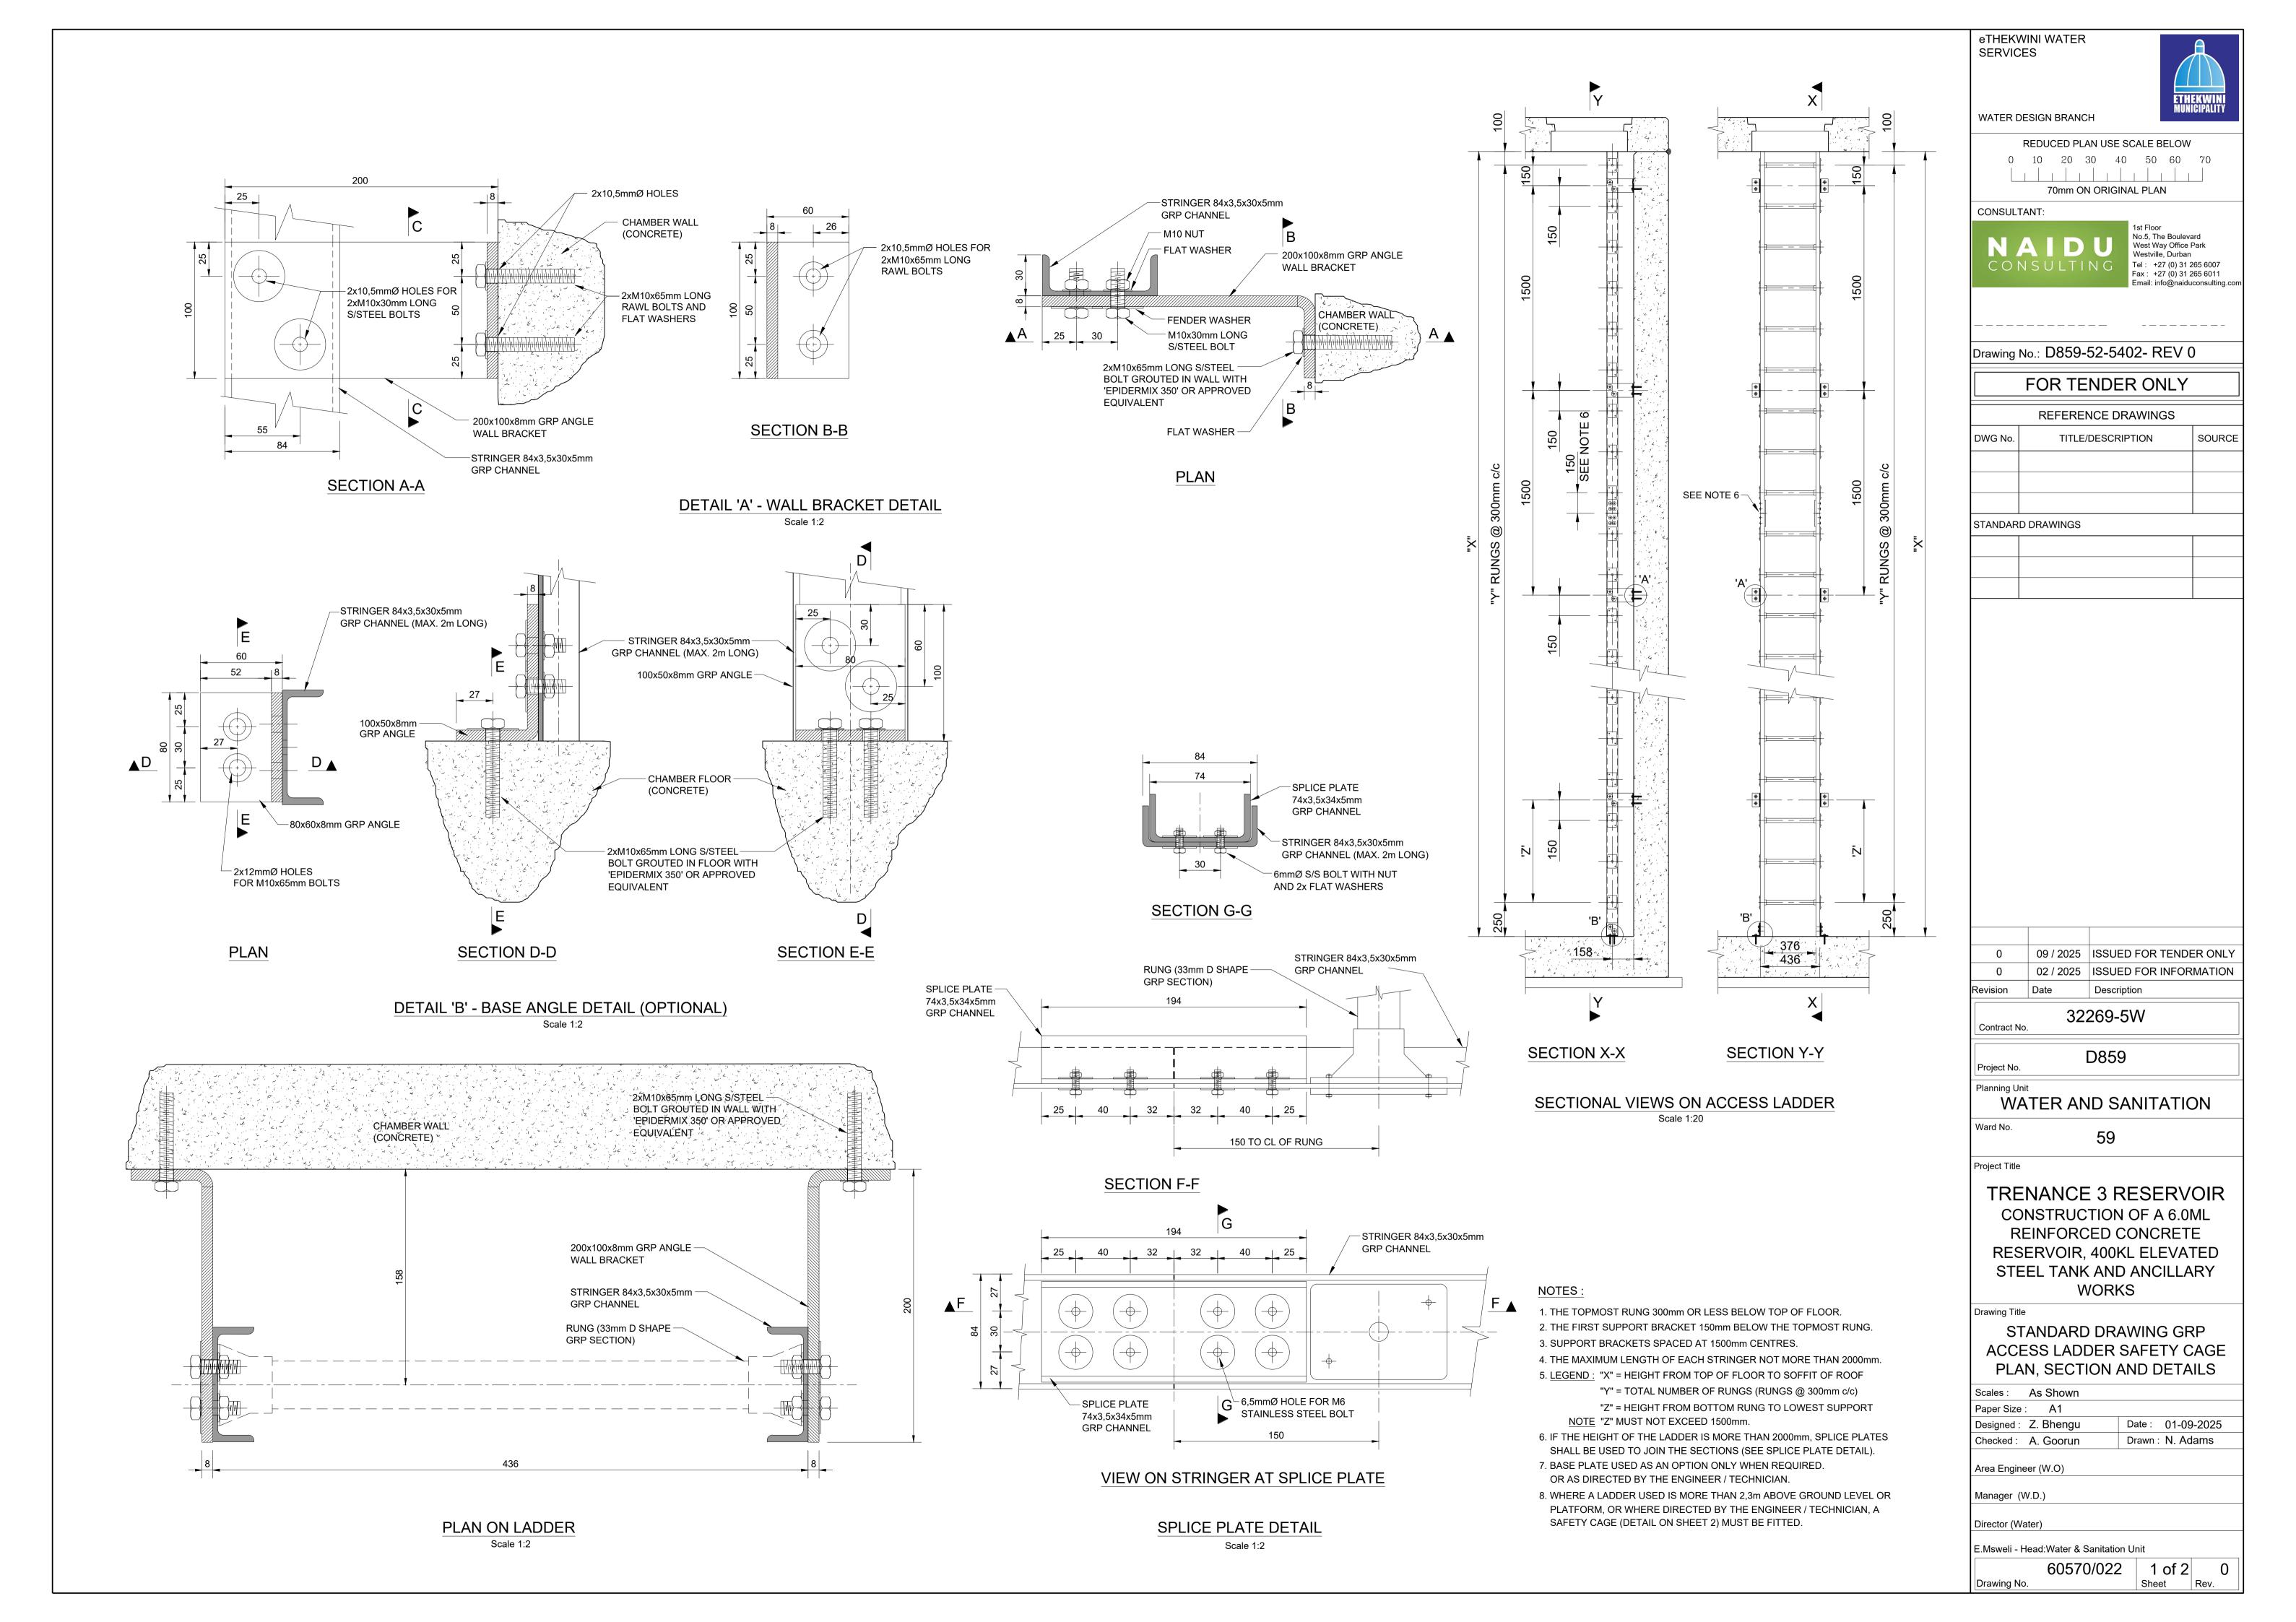

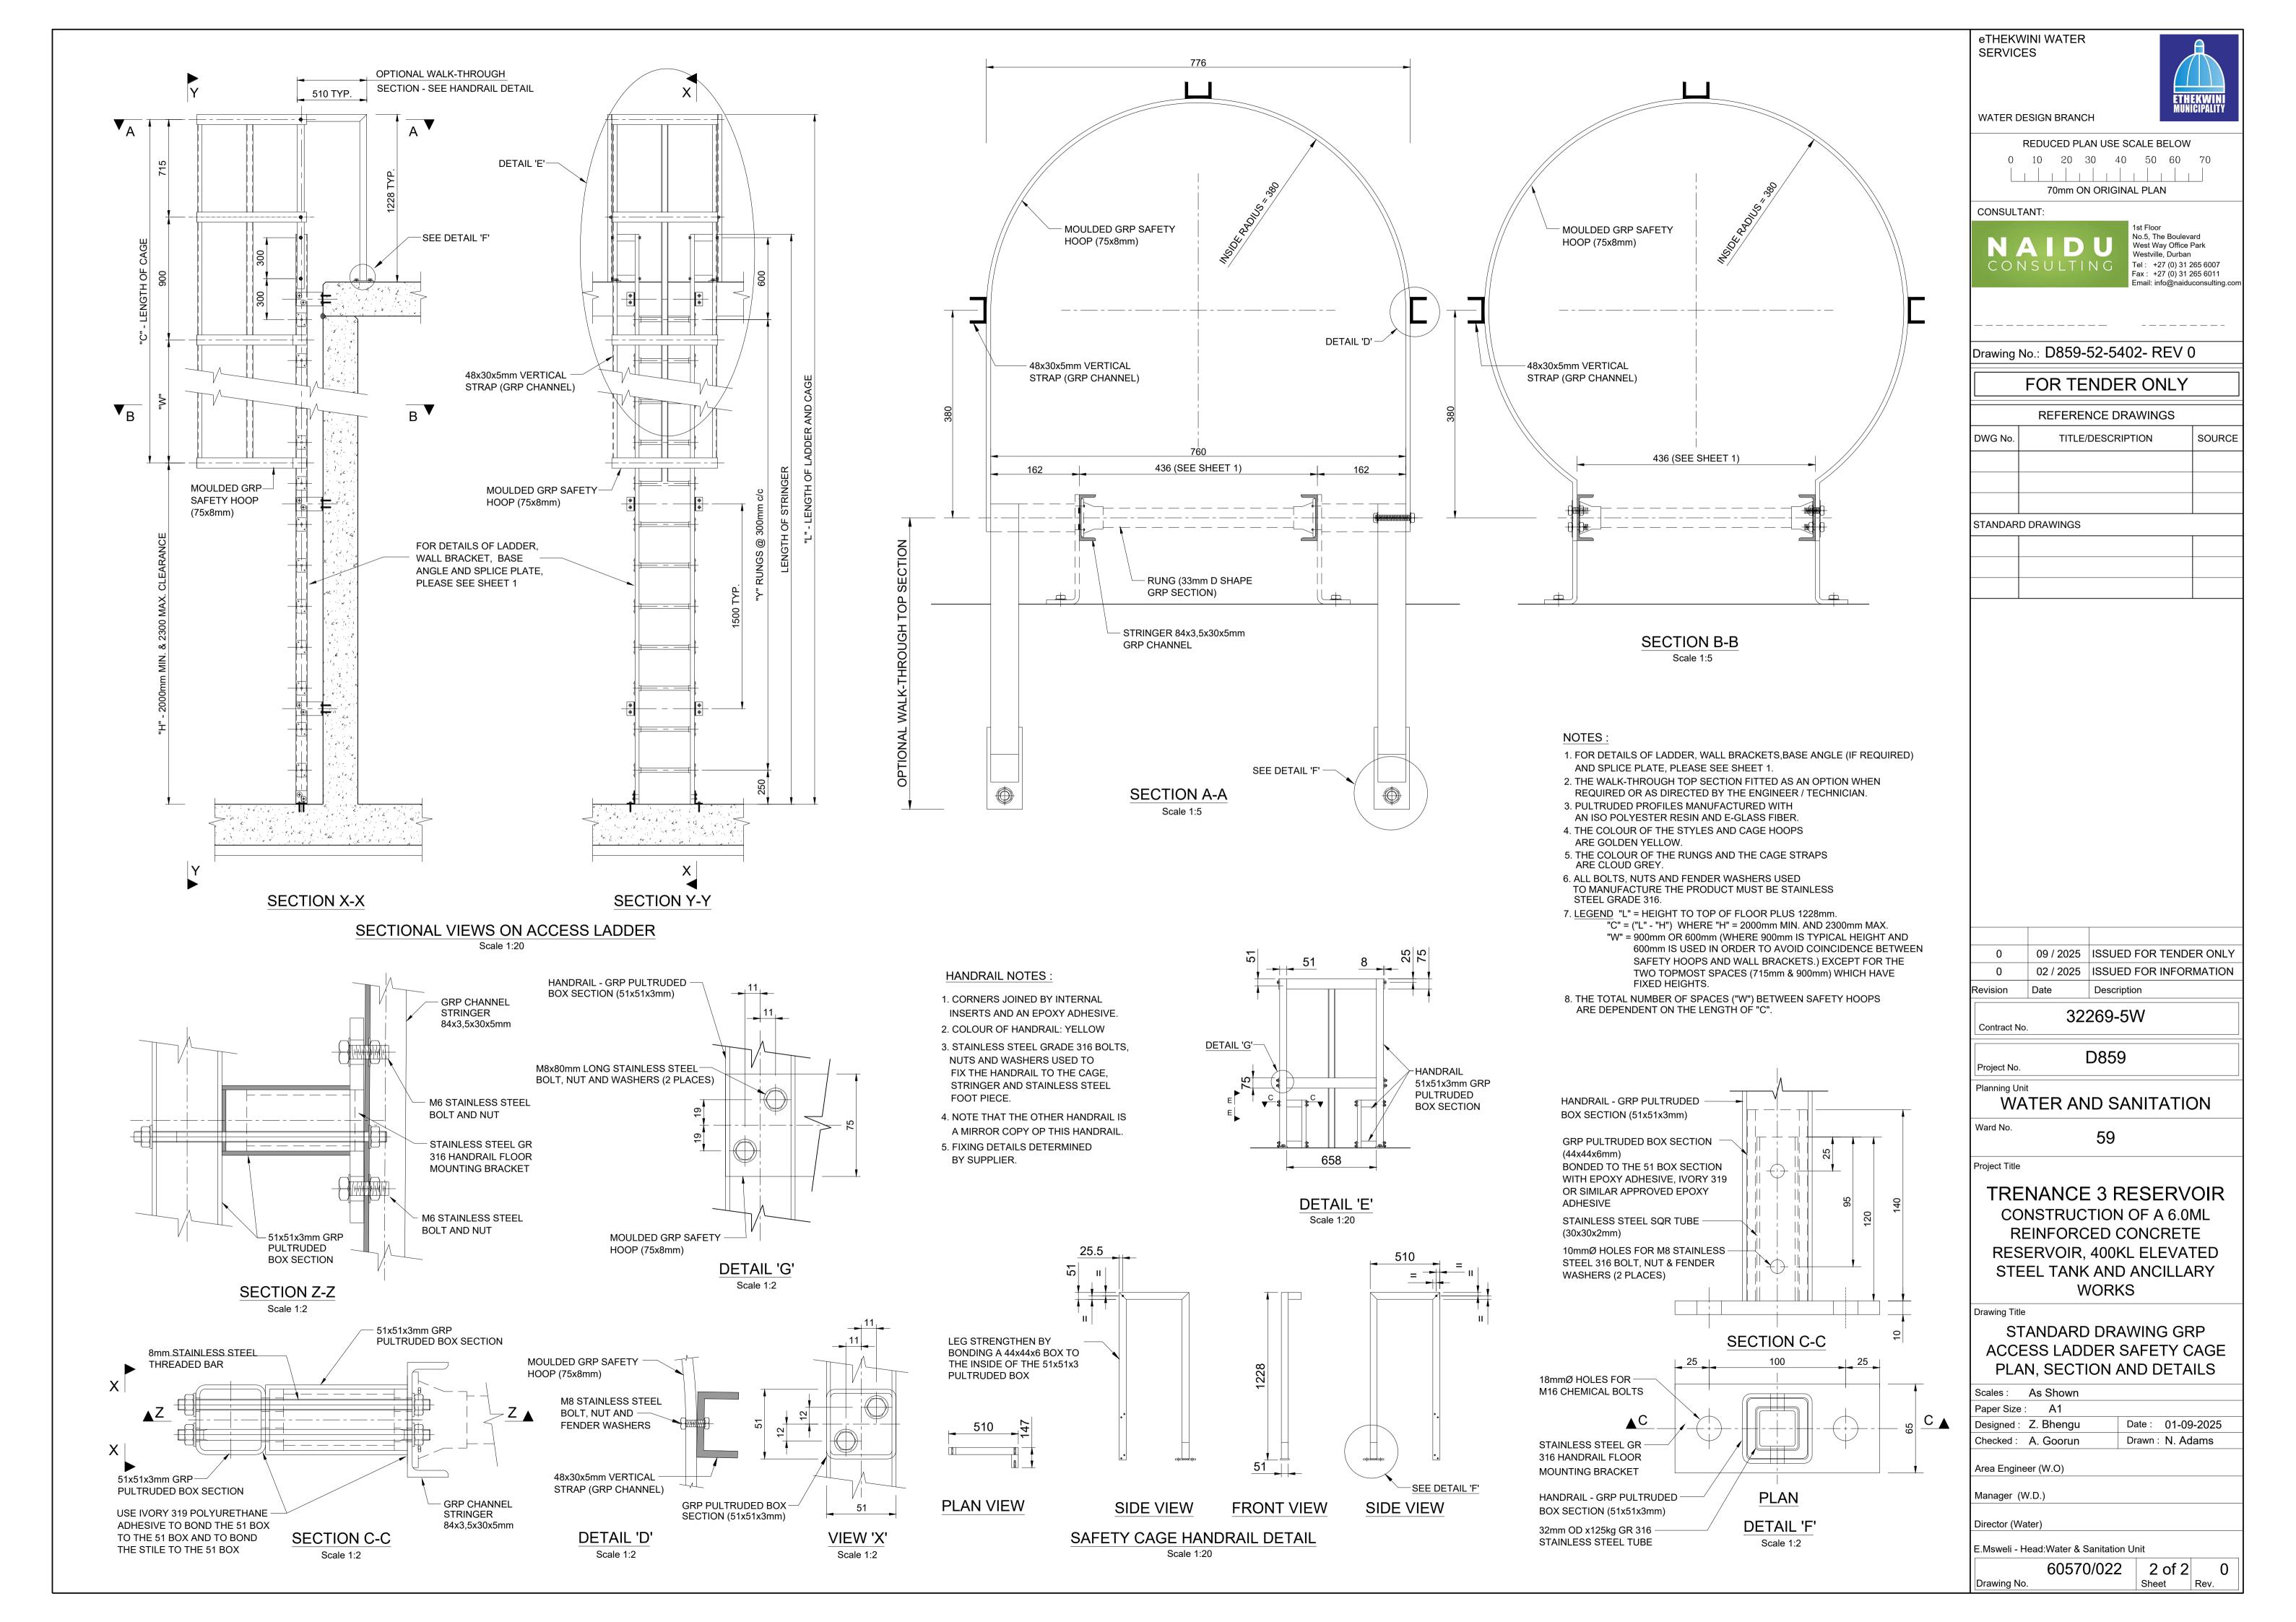

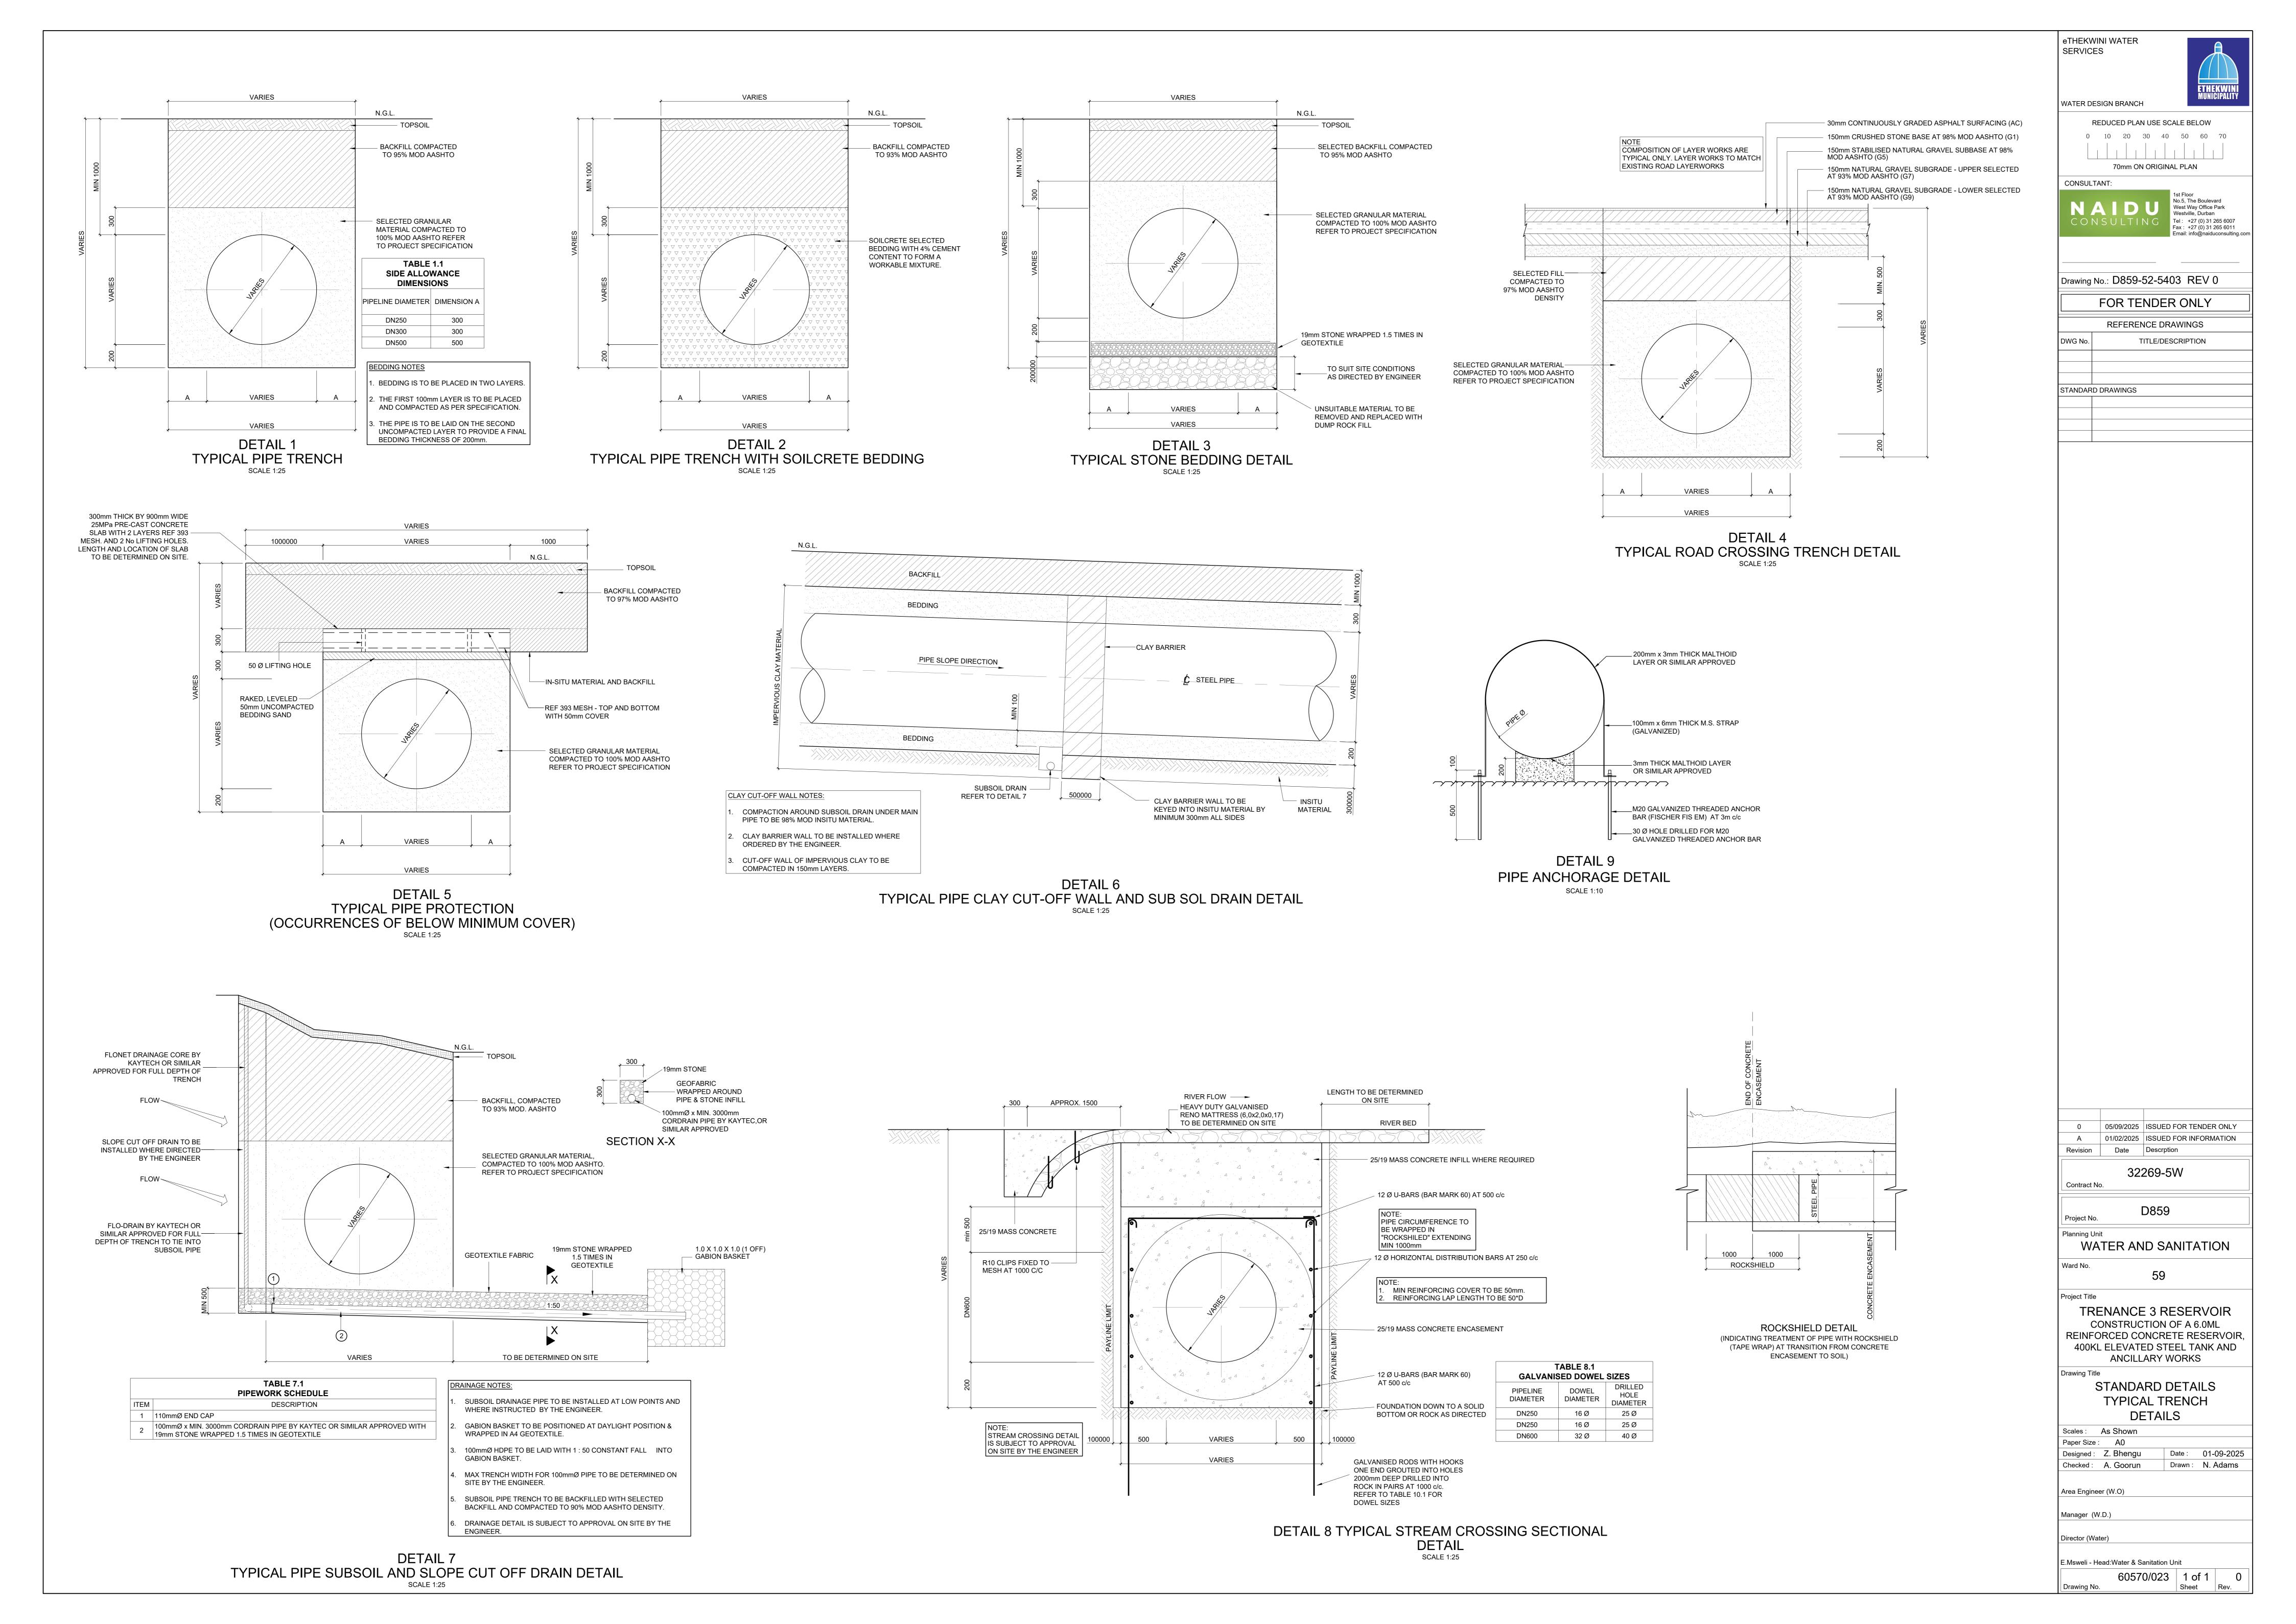

eTHEKWINI WATER REDUCED PLAN USE SCALE BELOW 70mm ON ORIGINAL PLAN No.5, The Boulevard West Way Office Park Westville, Durban Tel: +27 (0) 31 265 6007 Fax: +27 (0) 31 265 6011 Email: info@naiduconsulting.con FOR TENDER ONLY REFERENCE DRAWINGS TITLE/DESCRIPTION


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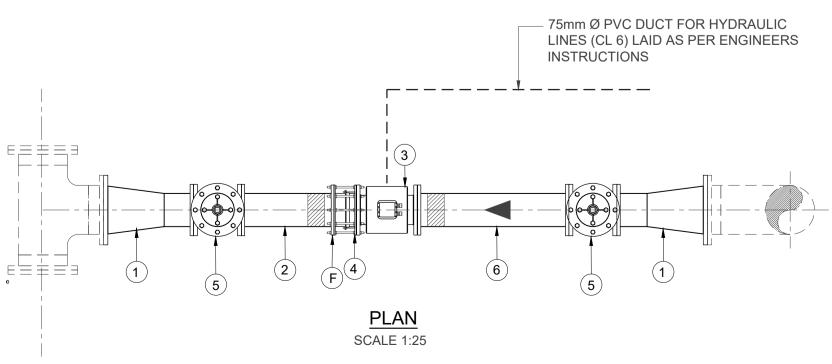
Sheet 1 Rev.

ISOMETRIC VIEW OF TYPE 1 CULVERT AND CULVERT BASE ARRANGEMENT

ABBREVIATIONS :	F/F
DN - DIAMETER NOMINAL	F.O.E - FLANGED ONE END
OD - OUTSIDE DIAMETER	F.B.E - FLANGED BOTH ENDS
ID - INSIDE DIAMETER	F.A.R - FLANGED ALL ROUND
M.S - MILD STEEL	F/F - FACE TO FACE DIMENSION
S.S - STAINLESS STEEL	C/F - CENTRE TO FACE DIMENSION
H.D.G.M.S - HOT DIPPED GALVANISED MILD STEEL	L.R.B - LONG RADIUS BEND
G.M.S - GALVANISED MILD STEEL	S.R.B - SHORT RADIUS BEND
C.I - CAST IRON	P.C PLAIN END COATED
F.R.L FINAL ROAD LEVEL	P.E PLAIN END (FOR WELDING)

CULVERT TYPE	METER SIZE RANGE	WHERE TO USE
TYPE 1	DN150 - DN300	UNDER ROADS OR PAVED AREAS SUBJECT TO TRAFFIC LOADING
TYPE 1	DN350 - DN400	ALL METER INSTALLATIONS
TYPE 2	DN450 - DN600	ALL METER INSTALLATIONS



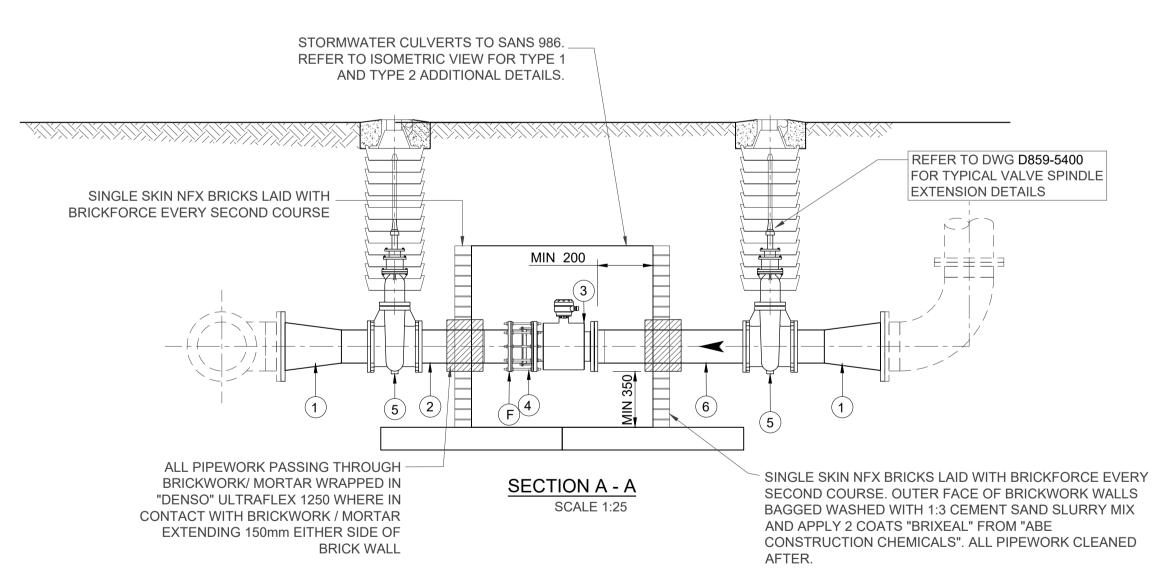

OUTER FACE OF BRICKWORK WALLS BAGGED WASHED WITH 1:3 CEMENT SAND SLURRY MIX AND APPLY 2 COATS "BRIXEAL" FROM "ABE CONSTRUCTION CHEMICALS". ALL PIPEWORK CLEANED AFTER.

SINGLE SKIN NFX BRICKS LAID
WITH BRICKFORCE EVERY SECOND
COURSE

CONTRACTOR TO SLEEVE SIGNAL
CABLE FROM METER TO SIGNAL
TRANSIMITTER KIOSK

ALL PIPEWORK PASSING THROUGH BRICKWORK/
MORTAR WRAPPED IN "DENSO" ULTRAFLEX 1250
WHERE IN CONTACT WITH BRICKWORK / MORTAR
EXTENDING 150mm EITHER SIDE OF BRICK WALL

BITUMEN 100mm WIDE

NFX BRICK WALL END CLOSING DETAIL FOR TYPE 1 AND TYPE 2 METER PROTECTION CULVERT

GENERAL NOTES

SPECIFICATIONS.

<u>PIPEWORK</u>

- 1. ALL PIPEWORK MILD STEEL UNLESS OTHERWISE STATED.
- 2. THE CONTRACTOR SHALL VERIFY THE DIMENSIONS OF ALL PIPEWORK AND ADVISE THE ENGINEER OF ANY DISCREPANCIES PRIOR TO FABRICATION.

FLASHING TAPE BY SIKA

- ALL PIPES GREATER THAN AND INCLUDING DN100, FITTED TO EQUIPMENT OR FITTINGS, OR WHERE SPECIFICALLY INDICATED SHALL BE FLANGED TO SANS 1123:2007 (TABLE 3) OR BS EN 1092: 1-2007 WHERE SANS 1123:2007 (TABLE 3) DOES NOT APPLY OR AS SPECIFIED ON THE DRAWINGS. SHOULD THE RESPECTIVE FLANGE DRILLING NOT BE COVERED IN THE ABOVE SPECIFICATIONS THE RESIDENT ENGINEER SHALL BE CONSULTED FOR THE APPROPRIATE SPECIFICATION, BEFORE PROCURING ANY VALVES OR FLANGES.
- 4. SURFACE PREPARATION FOR APPLICATION OF CORROSION PROTECTION MATERIALS SHALL BE IN ACCORDANCE WITH THE PROJECT SPECIFICATIONS.
- 5. DAMAGED COATINGS AND LININGS SHALL BE REPAIRED IN ACCORDANCE WITH THE PROJECT SPECIFICATIONS.
- 6. ALL PIPEWORK AND SPECIALS COATED AND LINED AS PER THE PROJECT SPECIFICATIONS.
- 7. ALL JOINTS SHALL BE COATED, PROTECTED AND WRAPPED AS PER THE PROJECT SPECIFICATIONS.
- 8. THE PRESSURE RATINGS OF ALL PIPEWORK, FLANGES AND VALVES, SHALL BE AS INDICATED IN THE SCHEDULES OF FITTINGS.
- 9. ALL MILD STEEL PIPEWORK, COLLARS, WRAPPERS AND CROTCH PLATES MANUFACTURED FROM MINIMUM GRADE X42 STEEL AND WELDED IN ACCORDANCE WITH THE PROJECT SPECIFICATIONS.
 WHERE THE GRADE OF STEEL FOR THE MAIN PIPE IS X52 OR X65, COLLARS AND WRAPPERS SHALL BE FABRICATED FROM STEEL PIPE OF THE SAME GRADE AS
- THE MAIN PIPE AS SUPPLIED FREE-ISSUE BY THE EMPLOYER, UNLESS OTHERWISE STATED ON THE DRAWINGS.

 10. ALL BENDS FABRICATED AND DIMENSIONED IN ACCORDANCE WITH THE PROJECT

		PIPEWORK AND FITTINGS SCHEDULE (PN16)		
ITEM No.	NOM DIA	DESCRIPTION	F/F	No. OF
1	DN300 x DN200	CONCENTRIC REDUCER TO ANSI B16.9, FBE WITH 100MM LONG SPOOL PIECE ON EACH END. DN500 FLANGE WELDED TO DN300 INLET/OUTLET PIPELINE.	400	2
2	DN200	SPOOL PIECE, FBE. FLANGE TO MATCH ITEM 3 OR ITEM 5	750	1
3	DN200	INLINE FLANGED ELECTROMAGNETIC METER COMPLETE WITH SIGNAL TRANSMITTER, CONVERTER AND TRANSMITTER CABLE. PN10		1
4	DN200	RESTRAINED FLANGE ADAPTOR (KAMFLEX, VIKING JOHNSON)TO SUIT STEEL SPOOL PIPE. FLANGE TO MATCH ITEM 3. NOTE F: ANCHORING OR RESTRAINING FLANGE TO BE WELDED APPROXIMATELY 300mm FROM PLAIN END OF ITEM 6. RESTRAINING FLANGE ADAPTOR TO USE MINIMUM OF 4 NUMBER GRADE 4.8 RESTRAINING BOLTS, EQUALLY SPACED AROUND CIRCUMFERENCE OF FLANGES. RESTRAINING FLANGE TO MANUFACTURERS SPECIFICATION AND APPROVED BY THE EMPLOYER'S REPRESENTATIVE.		1
5	DN200	PN10 WEDGE GATE VALVE	317	2
6	DN200	SPOOL PIPE, F.O.E, OTHER END P.C. AND FITTED WITH A RESTRAINING FLANGE TO SUIT ADAPTER (ITEM 4). (SEE ITEM 4 FOR DETAILS)	1000	1

NOTES:
ALL SPECIALS EPOXY COATED (S.F.E) TO PROJECT SPECIFICATIONS UNLESS OTHERWISE STATED. ALL PIPE TO SANS 719, GRADE X42, 4.5mm THICK.
ALL FLANGES TO TABLE 1600/3 (SANS 1123 - 2011).
IF FACE TO FACE DIMENSION OF FITTINGS DIFFER TO ACTUAL THE CONTRACTOR MUST INFORM THE ENGINEER PRIOR TO PIPE FABRICATION.

eTHEKWINI WATER SERVICES

ETHEKWINI

WATER DESIGN BRANCH

CONSULTANT:



Drawing No.: D859-52-5405- REV 0

FOR TENDER ONLY						
REFERENCE DRAWINGS (xxx/)						
DWG No. TITLE/DESCRIPTION SOURCE						

STANDARD DRAWINGS

0	09 / 2025	ISSUED FOR TENDER ONL
Revision	Date	Description

32269-5W
Contract No.

D859

Project No.

Planning Unit

WATER AND SANITATION
Ward No.

TRENANCE 3 RESERVOIR
CONSTRUCTION OF A 6.0ML
REINFORCED CONCRETE
RESERVOIR, 400KL ELEVATED
STEEL TANK AND ANCILLARY
WORKS

59

TYPICAL DN200 INLINE METER ASSEMBLY

As Shown	
A1	
Designed: Z. Bhengu	Date: 30-01-2025
Checked: A. Goorun	Drawn : N. Adams
Area Engineer (W.O)	
Manager (W.D.)	


Director (Water)


E.Msweli - Head:Water & Sanitation Unit

ISOMETRIC VIEW OF TYPE 1 CULVERT AND CULVERT BASE ARRANGEMENT

ABBREVIATIONS :		F/F
DN - DIAMETER NOMINAL	F.O.E - FLANGED ONE END	
OD - OUTSIDE DIAMETER	F.B.E - FLANGED BOTH ENDS	
ID - INSIDE DIAMETER	F.A.R - FLANGED ALL ROUND	S H
M.S - MILD STEEL	F/F - FACE TO FACE DIMENSION	
S.S - STAINLESS STEEL	C/F - CENTRE TO FACE DIMENSION	
H.D.G.M.S - HOT DIPPED GALVANISED MILD STEEL	L.R.B - LONG RADIUS BEND	
G.M.S - GALVANISED MILD STEEL	S.R.B - SHORT RADIUS BEND	
C.I - CAST IRON	P.C PLAIN END COATED	
F.R.L FINAL ROAD LEVEL	P.E PLAIN END (FOR WELDING)	


CULVERT TYPE	METER SIZE RANGE	WHERE TO USE
TYPE 1	DN150 - DN300	UNDER ROADS OR PAVED AREAS SUBJECT TO TRAFFIC LOADING
TYPE 1	DN350 - DN400	ALL METER INSTALLATIONS
TYPE 2	DN450 - DN600	ALL METER INSTALLATIONS

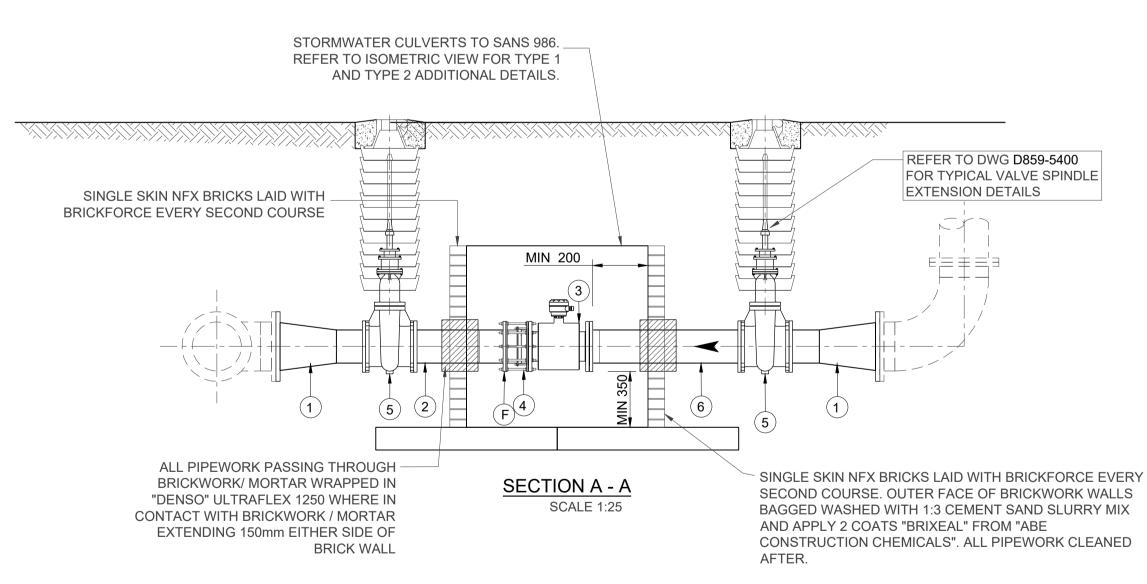

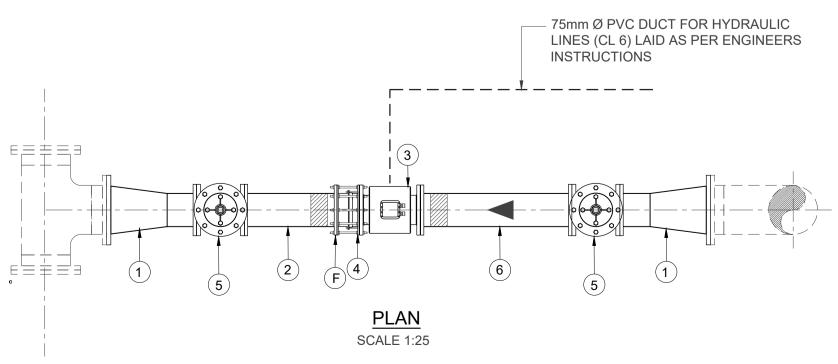

OUTER FACE OF BRICKWORK WALLS BAGGED WASHED WITH 1:3 CEMENT SAND SLURRY MIX AND APPLY 2 COATS "BRIXEAL" FROM "ABE CONSTRUCTION CHEMICALS". ALL

SAND SLURRY MIX AND APPLY 2 COATS
ABE CONSTRUCTION CHEMICALS". ALL
PIPEWORK CLEANED AFTER.

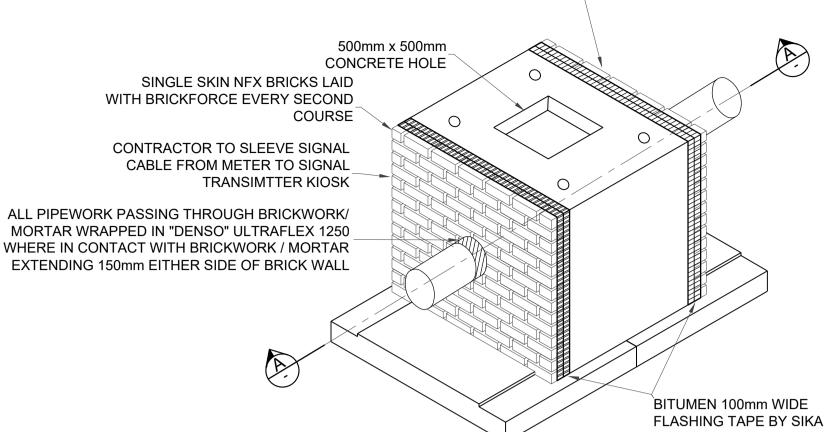

NFX BRICK WALL END CLOSING DETAIL FOR TYPE 1 AND TYPE 2 METER PROTECTION CULVERT N.T.S

GENERAL NOTES

SPECIFICATIONS.

<u>PIPEWORK</u>

- 1. ALL PIPEWORK MILD STEEL UNLESS OTHERWISE STATED.
- 2. THE CONTRACTOR SHALL VERIFY THE DIMENSIONS OF ALL PIPEWORK AND ADVISE THE ENGINEER OF ANY DISCREPANCIES PRIOR TO FABRICATION.
- ALL PIPES GREATER THAN AND INCLUDING DN100, FITTED TO EQUIPMENT OR FITTINGS, OR WHERE SPECIFICALLY INDICATED SHALL BE FLANGED TO SANS 1123:2007 (TABLE 3) OR BS EN 1092: 1-2007 WHERE SANS 1123:2007 (TABLE 3) DOES NOT APPLY OR AS SPECIFIED ON THE DRAWINGS. SHOULD THE RESPECTIVE FLANGE DRILLING NOT BE COVERED IN THE ABOVE SPECIFICATIONS THE RESIDENT ENGINEER SHALL BE CONSULTED FOR THE APPROPRIATE SPECIFICATION, BEFORE PROCURING ANY VALVES OR FLANGES.
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- 6. ALL PIPEWORK AND SPECIALS COATED AND LINED AS PER THE PROJECT
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- INDICATED IN THE SCHEDULES OF FITTINGS.
- 9. ALL MILD STEEL PIPEWORK, COLLARS, WRAPPERS AND CROTCH PLATES
 MANUFACTURED FROM MINIMUM GRADE X42 STEEL AND WELDED IN ACCORDANCE
 WITH THE PROJECT SPECIFICATIONS.
 WHERE THE GRADE OF STEEL FOR THE MAIN PIPE IS X52 OR X65, COLLARS AND
 WRAPPERS SHALL BE FABRICATED FROM STEEL PIPE OF THE SAME GRADE AS
- WRAPPERS SHALL BE FABRICATED FROM STEEL PIPE OF THE SAME GRADE AS THE MAIN PIPE AS SUPPLIED FREE-ISSUE BY THE EMPLOYER, UNLESS OTHERWISE STATED ON THE DRAWINGS.
- 10. ALL BENDS FABRICATED AND DIMENSIONED IN ACCORDANCE WITH THE PROJECT SPECIFICATIONS.

	PIPEWORK AND FITTINGS SCHEDULE (PN16)				
ITEM No.	NOM DIA	DESCRIPTION	F/F	No. OF	
1	DN400 x DN250	CONCENTRIC REDUCER TO ANSI B16.9, FBE WITH 100MM LONG SPOOL PIECE ON EACH END. DN500 FLANGE WELDED TO DN300 INLET/OUTLET PIPELINE.	400	2	
2	DN250	SPOOL PIECE, FBE. FLANGE TO MATCH ITEM 3 OR ITEM 5	750	1	
3	DN250	INLINE FLANGED ELECTROMAGNETIC METER COMPLETE WITH SIGNAL TRANSMITTER, CONVERTER AND TRANSMITTER CABLE. PN10		1	
4	DN250	RESTRAINED FLANGE ADAPTOR (KAMFLEX, VIKING JOHNSON)TO SUIT STEEL SPOOL PIPE. FLANGE TO MATCH ITEM 3. NOTE F: ANCHORING OR RESTRAINING FLANGE TO BE WELDED APPROXIMATELY 300mm FROM PLAIN END OF ITEM 6. RESTRAINING FLANGE ADAPTOR TO USE MINIMUM OF 4 NUMBER GRADE 4.8 RESTRAINING BOLTS, EQUALLY SPACED AROUND CIRCUMFERENCE OF FLANGES. RESTRAINING FLANGE TO MANUFACTURERS SPECIFICATION AND APPROVED BY THE EMPLOYER'S REPRESENTATIVE.		1	
5	DN250	PN10 WEDGE GATE VALVE	317	2	
6	DN250	SPOOL PIPE, F.O.E, OTHER END P.C. AND FITTED WITH A RESTRAINING FLANGE TO SUIT ADAPTER (ITEM 4). (SEE ITEM 4 FOR DETAILS)	1000	1	

ALL SPECIALS EPOXY COATED (S.F.E) TO PROJECT SPECIFICATIONS UNLESS OTHERWISE STATED. ALL PIPE TO SANS 719, GRADE X42, 4.5mm THICK.
ALL FLANGES TO TABLE 1600/3 (SANS 1123 - 2011).
IF FACE TO FACE DIMENSION OF FITTINGS DIFFER TO ACTUAL THE CONTRACTOR MUST INFORM THE ENGINEER PRIOR TO PIPE FABRICATION.

eTHEKWINI WATER
SERVICES

ETHEKWINI

WATER DESIGN BRANCH

CONSULTANT:

No.5, The Boulevard
West Way Office Park
Westville, Durban
Tel: +27 (0) 31 265 6007
Fax: +27 (0) 31 265 6011
Email: info@naiduconsulting.co

Drawing No.: D859-52-5406- REV 0

FOR TENDER ONLY			
REFERENCE DRAWINGS (xxx/)			
DWG No.	TITLE/DESCRIPTION	SOURCE	

STANDARD DRAWINGS

0 09 / 2025 ISSUED FOR TENDER ONLY
Revision Date Description

Contract No.

Project No.

Planning Unit

WATER AND SANITATION

Ward No. 59

TRENANCE 3 RESERVOIR
CONSTRUCTION OF A 6.0ML
REINFORCED CONCRETE
RESERVOIR, 400KL ELEVATED
STEEL TANK AND ANCILLARY
WORKS

TYPICAL DN250 INLINE METER ASSEMBLY

As Shown	
A1	
Designed: Z. Bhengu	Date: 30-01-2025
Checked: A. Goorun	Drawn : N. Adams
Area Engineer (W.O)	


Manager (W.D.)


Director (Water)


Drawing No.


E.Msweli - Head:Water & Sanitation Unit

60570/026 1 of 1 0

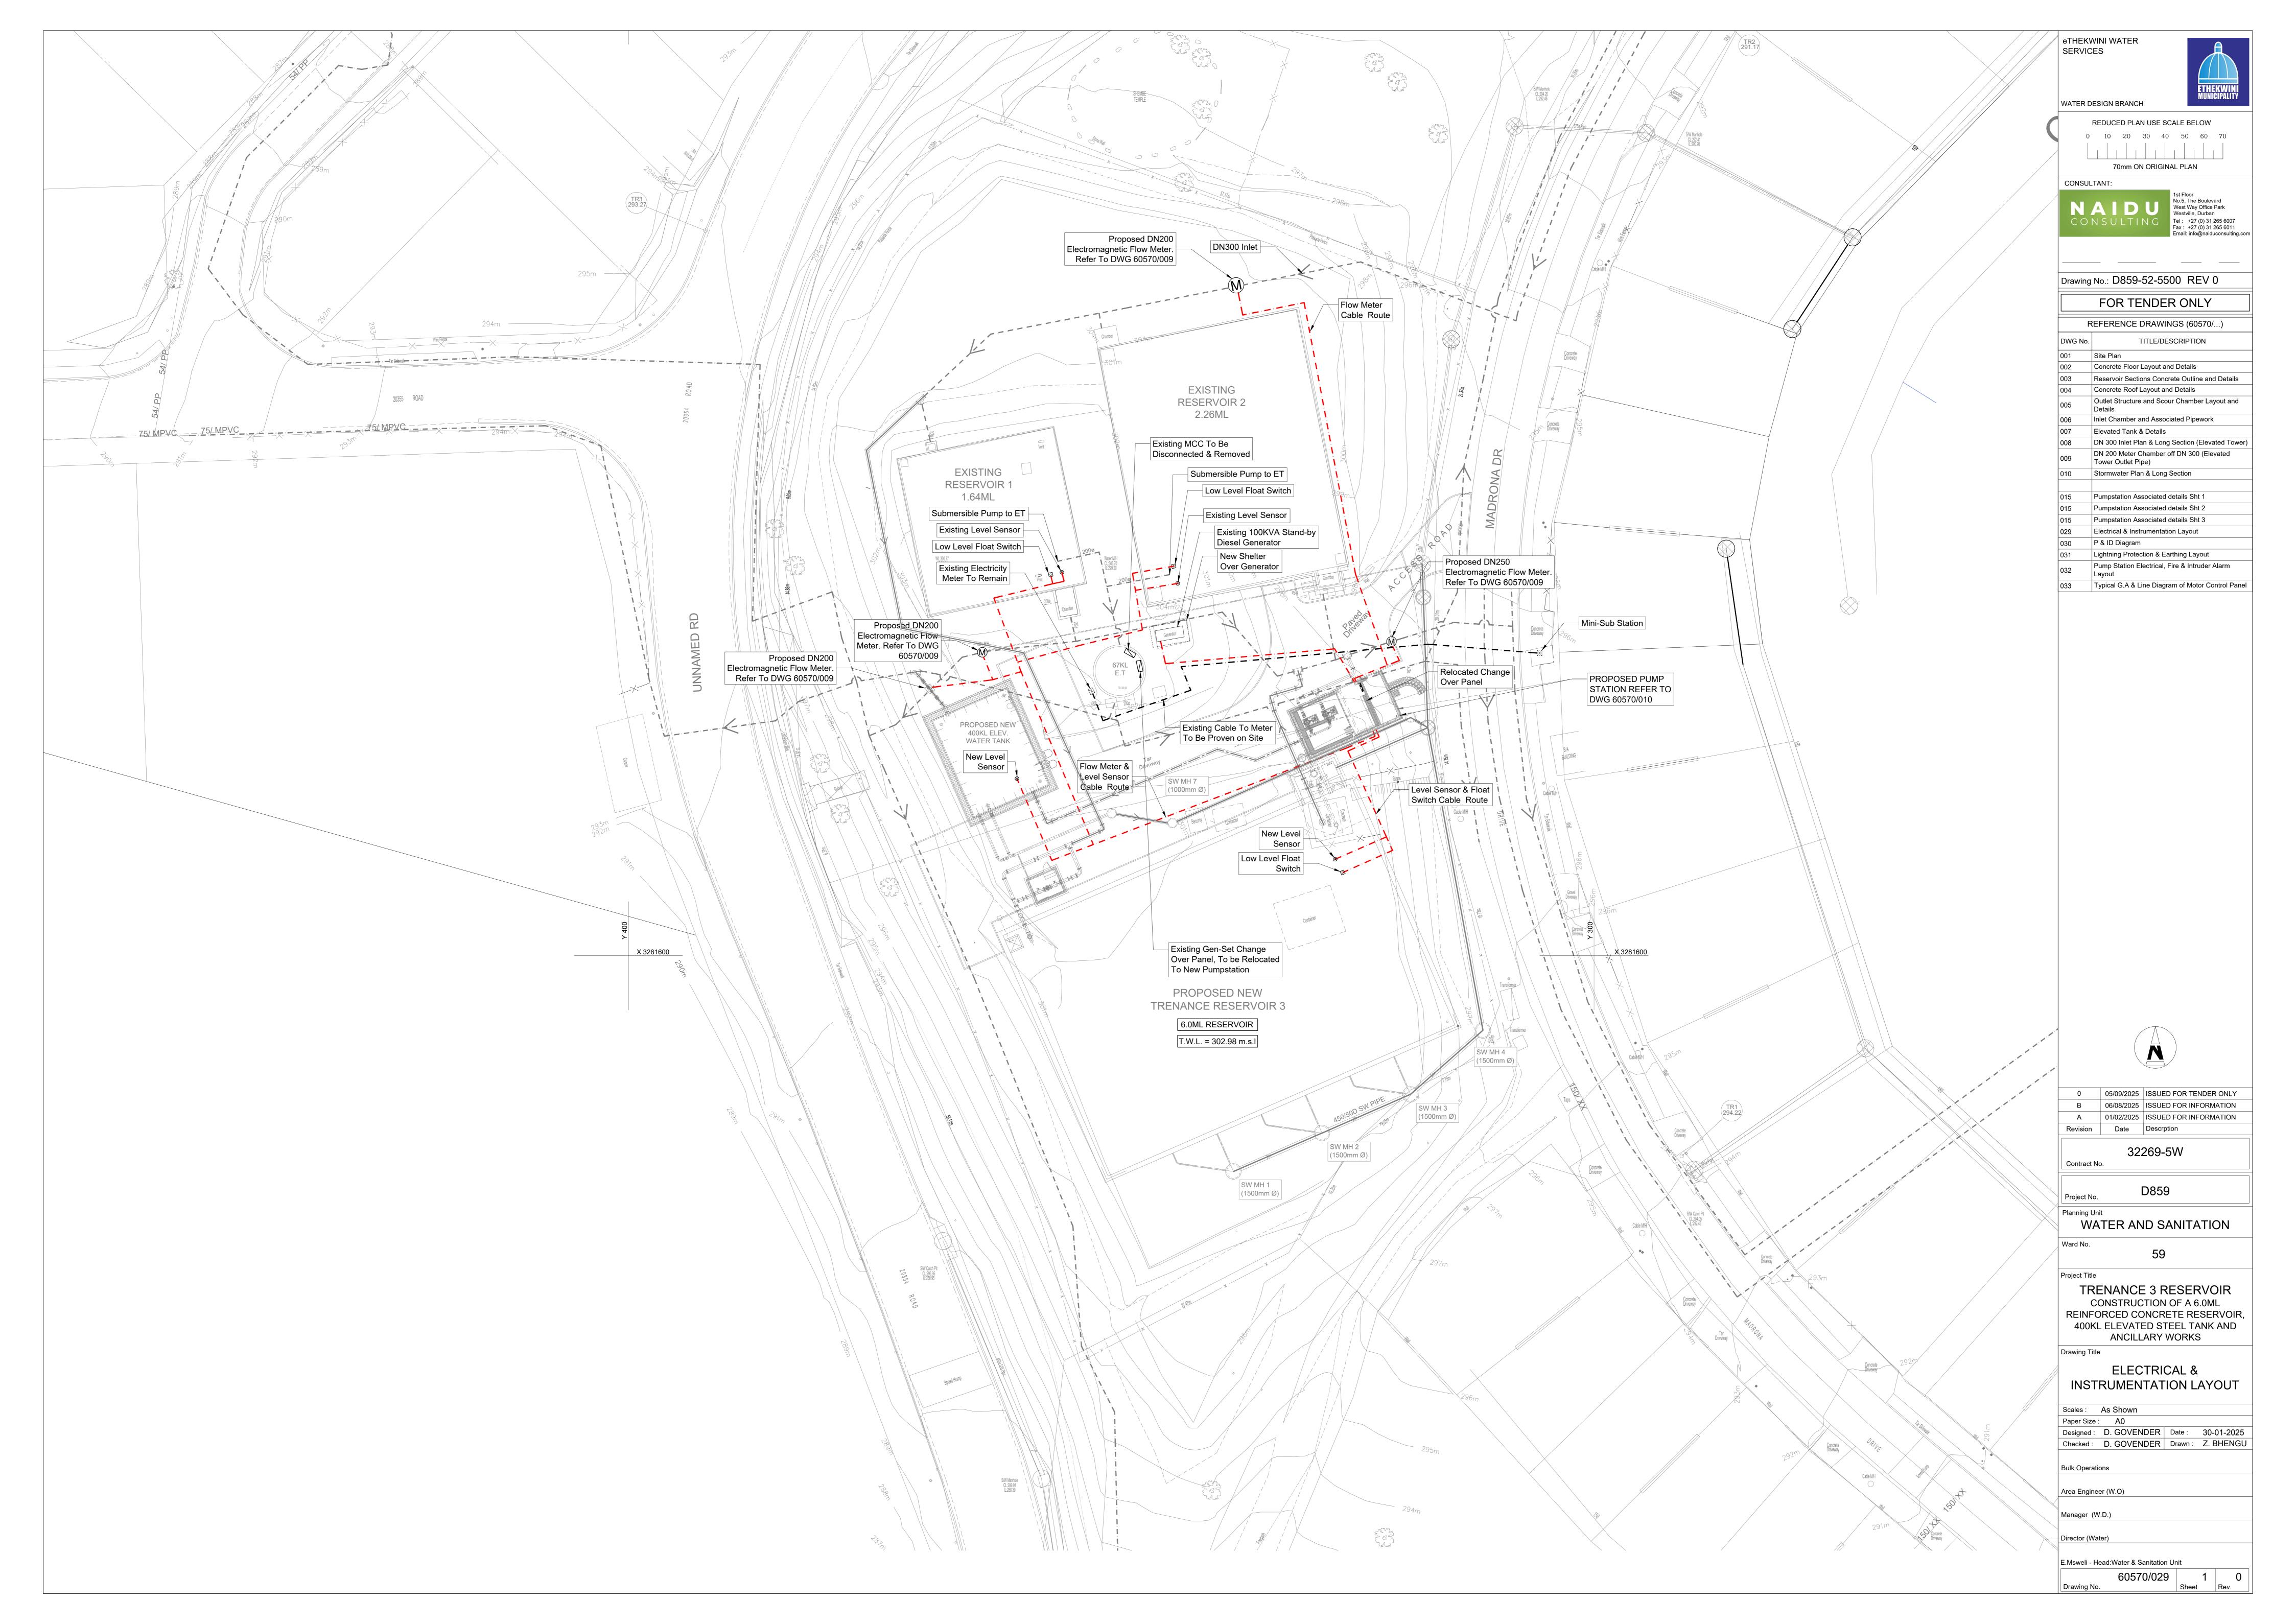

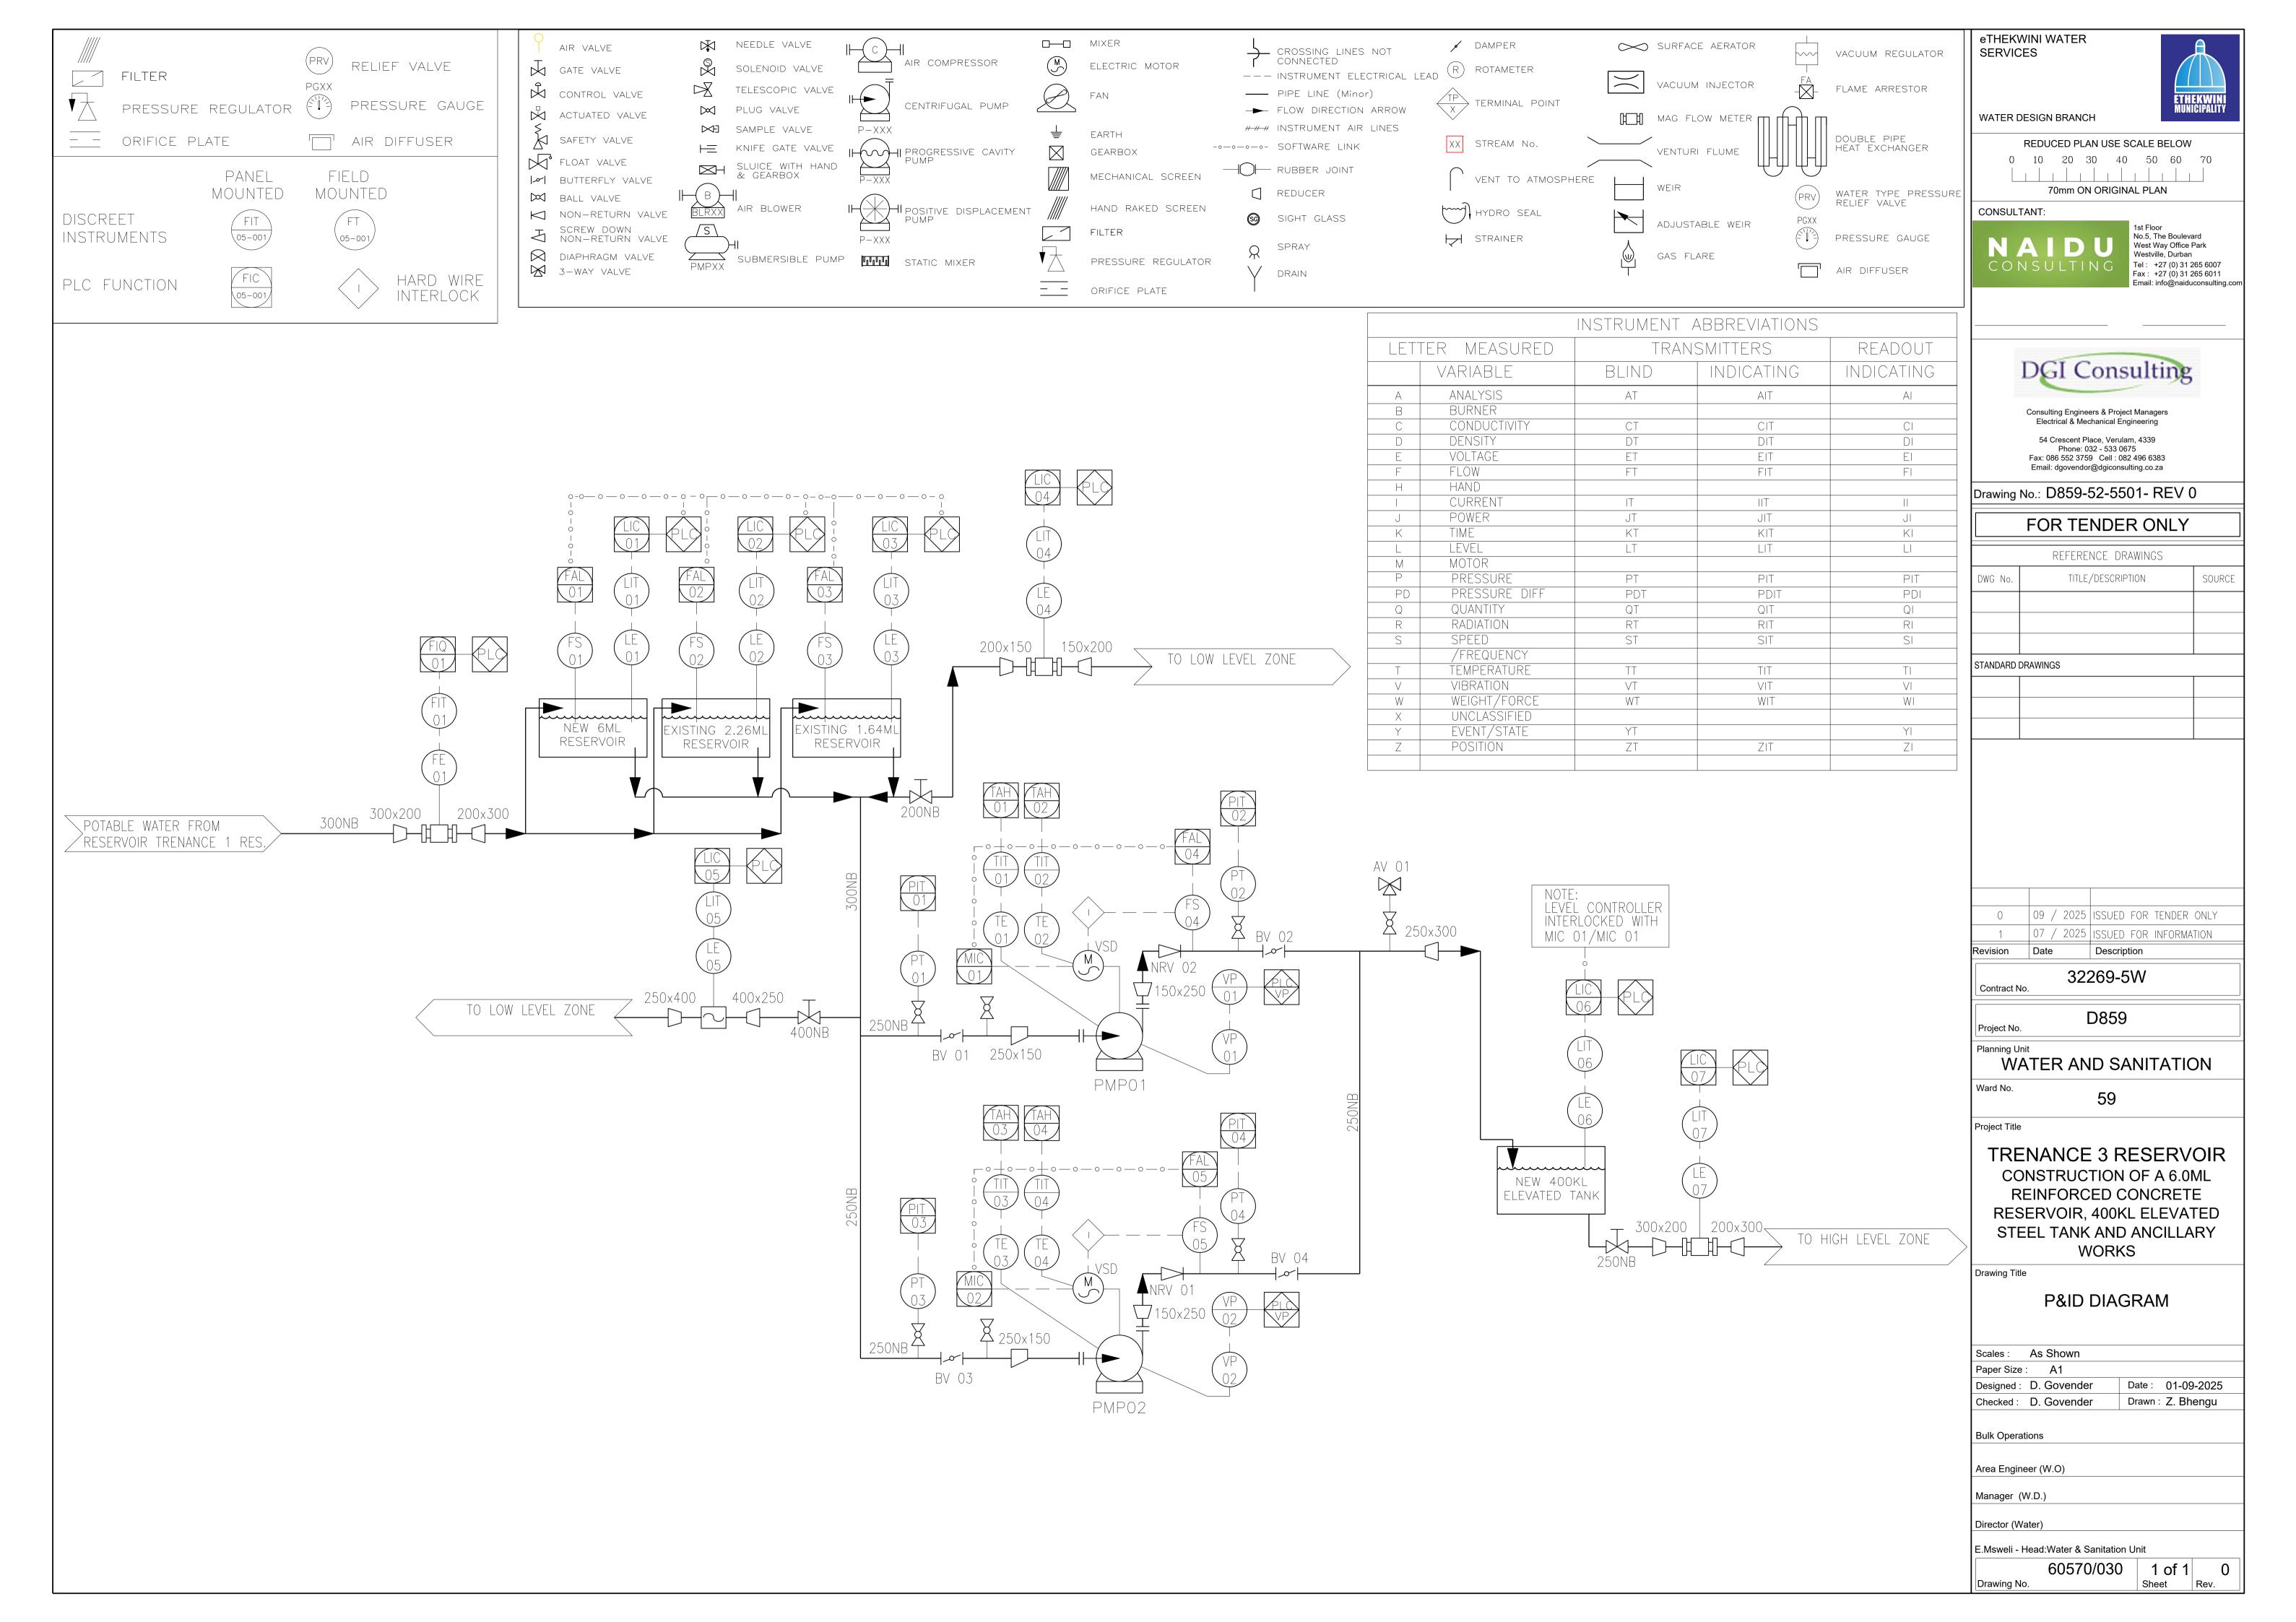

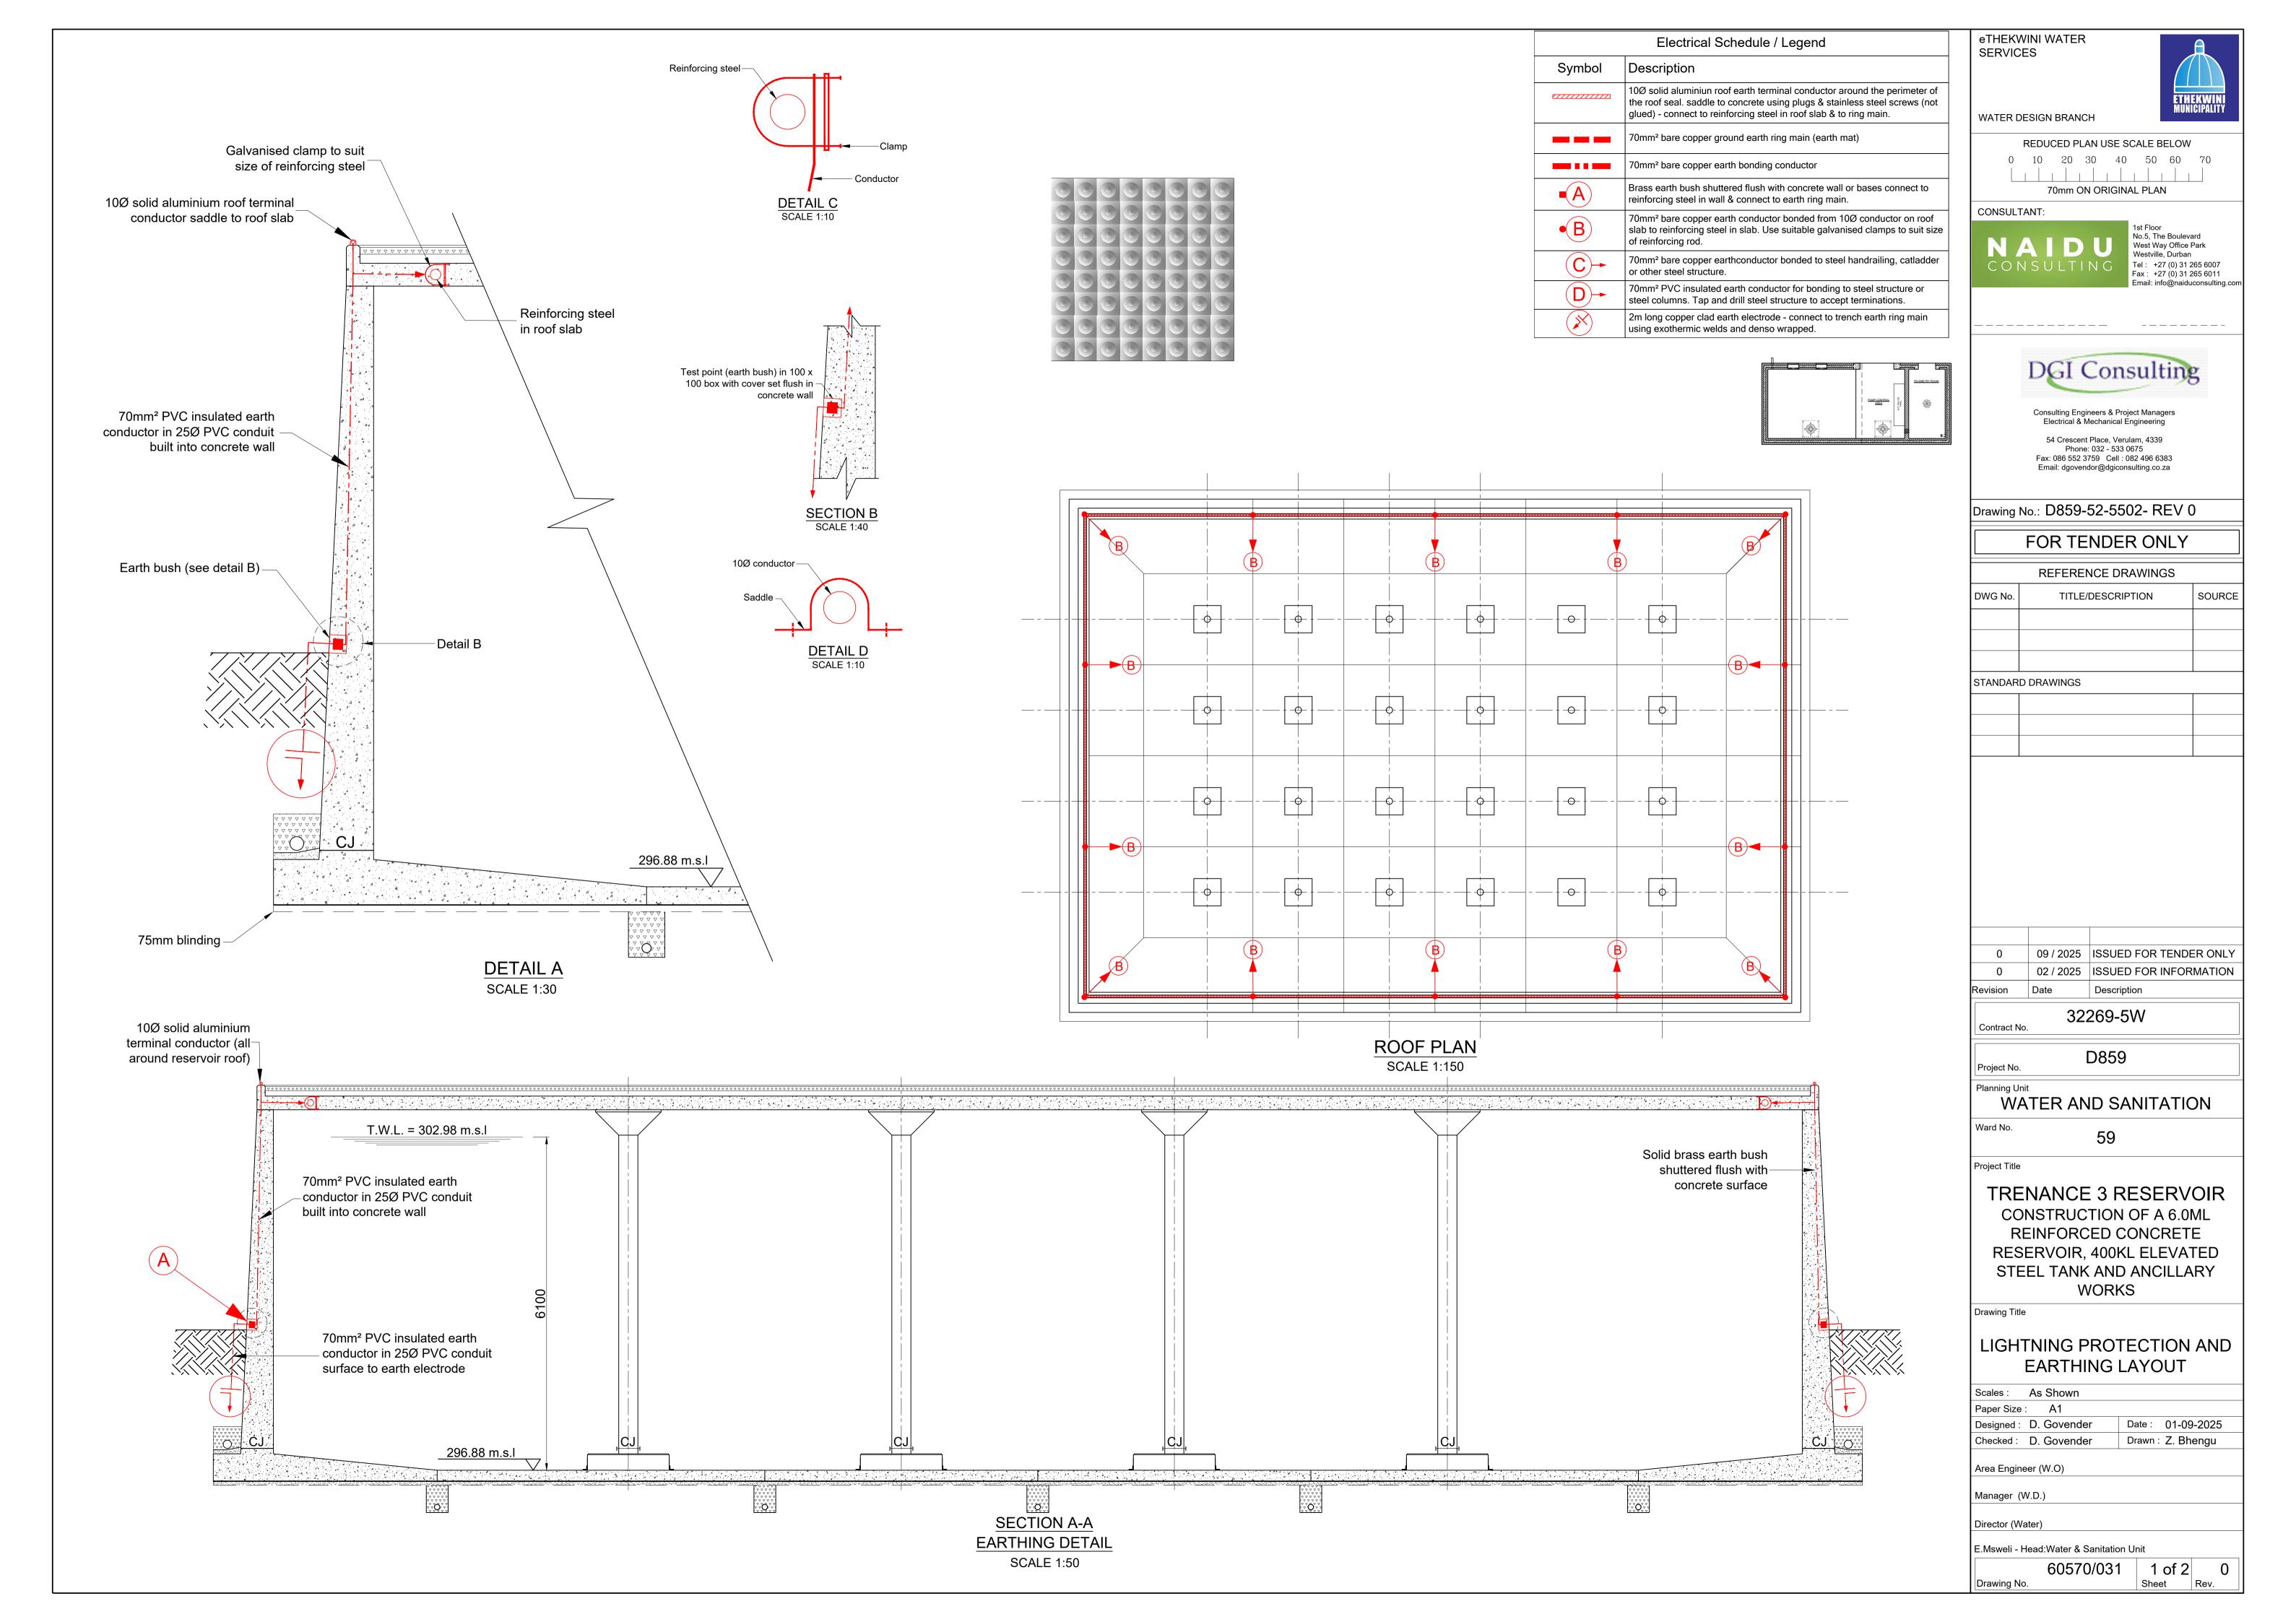

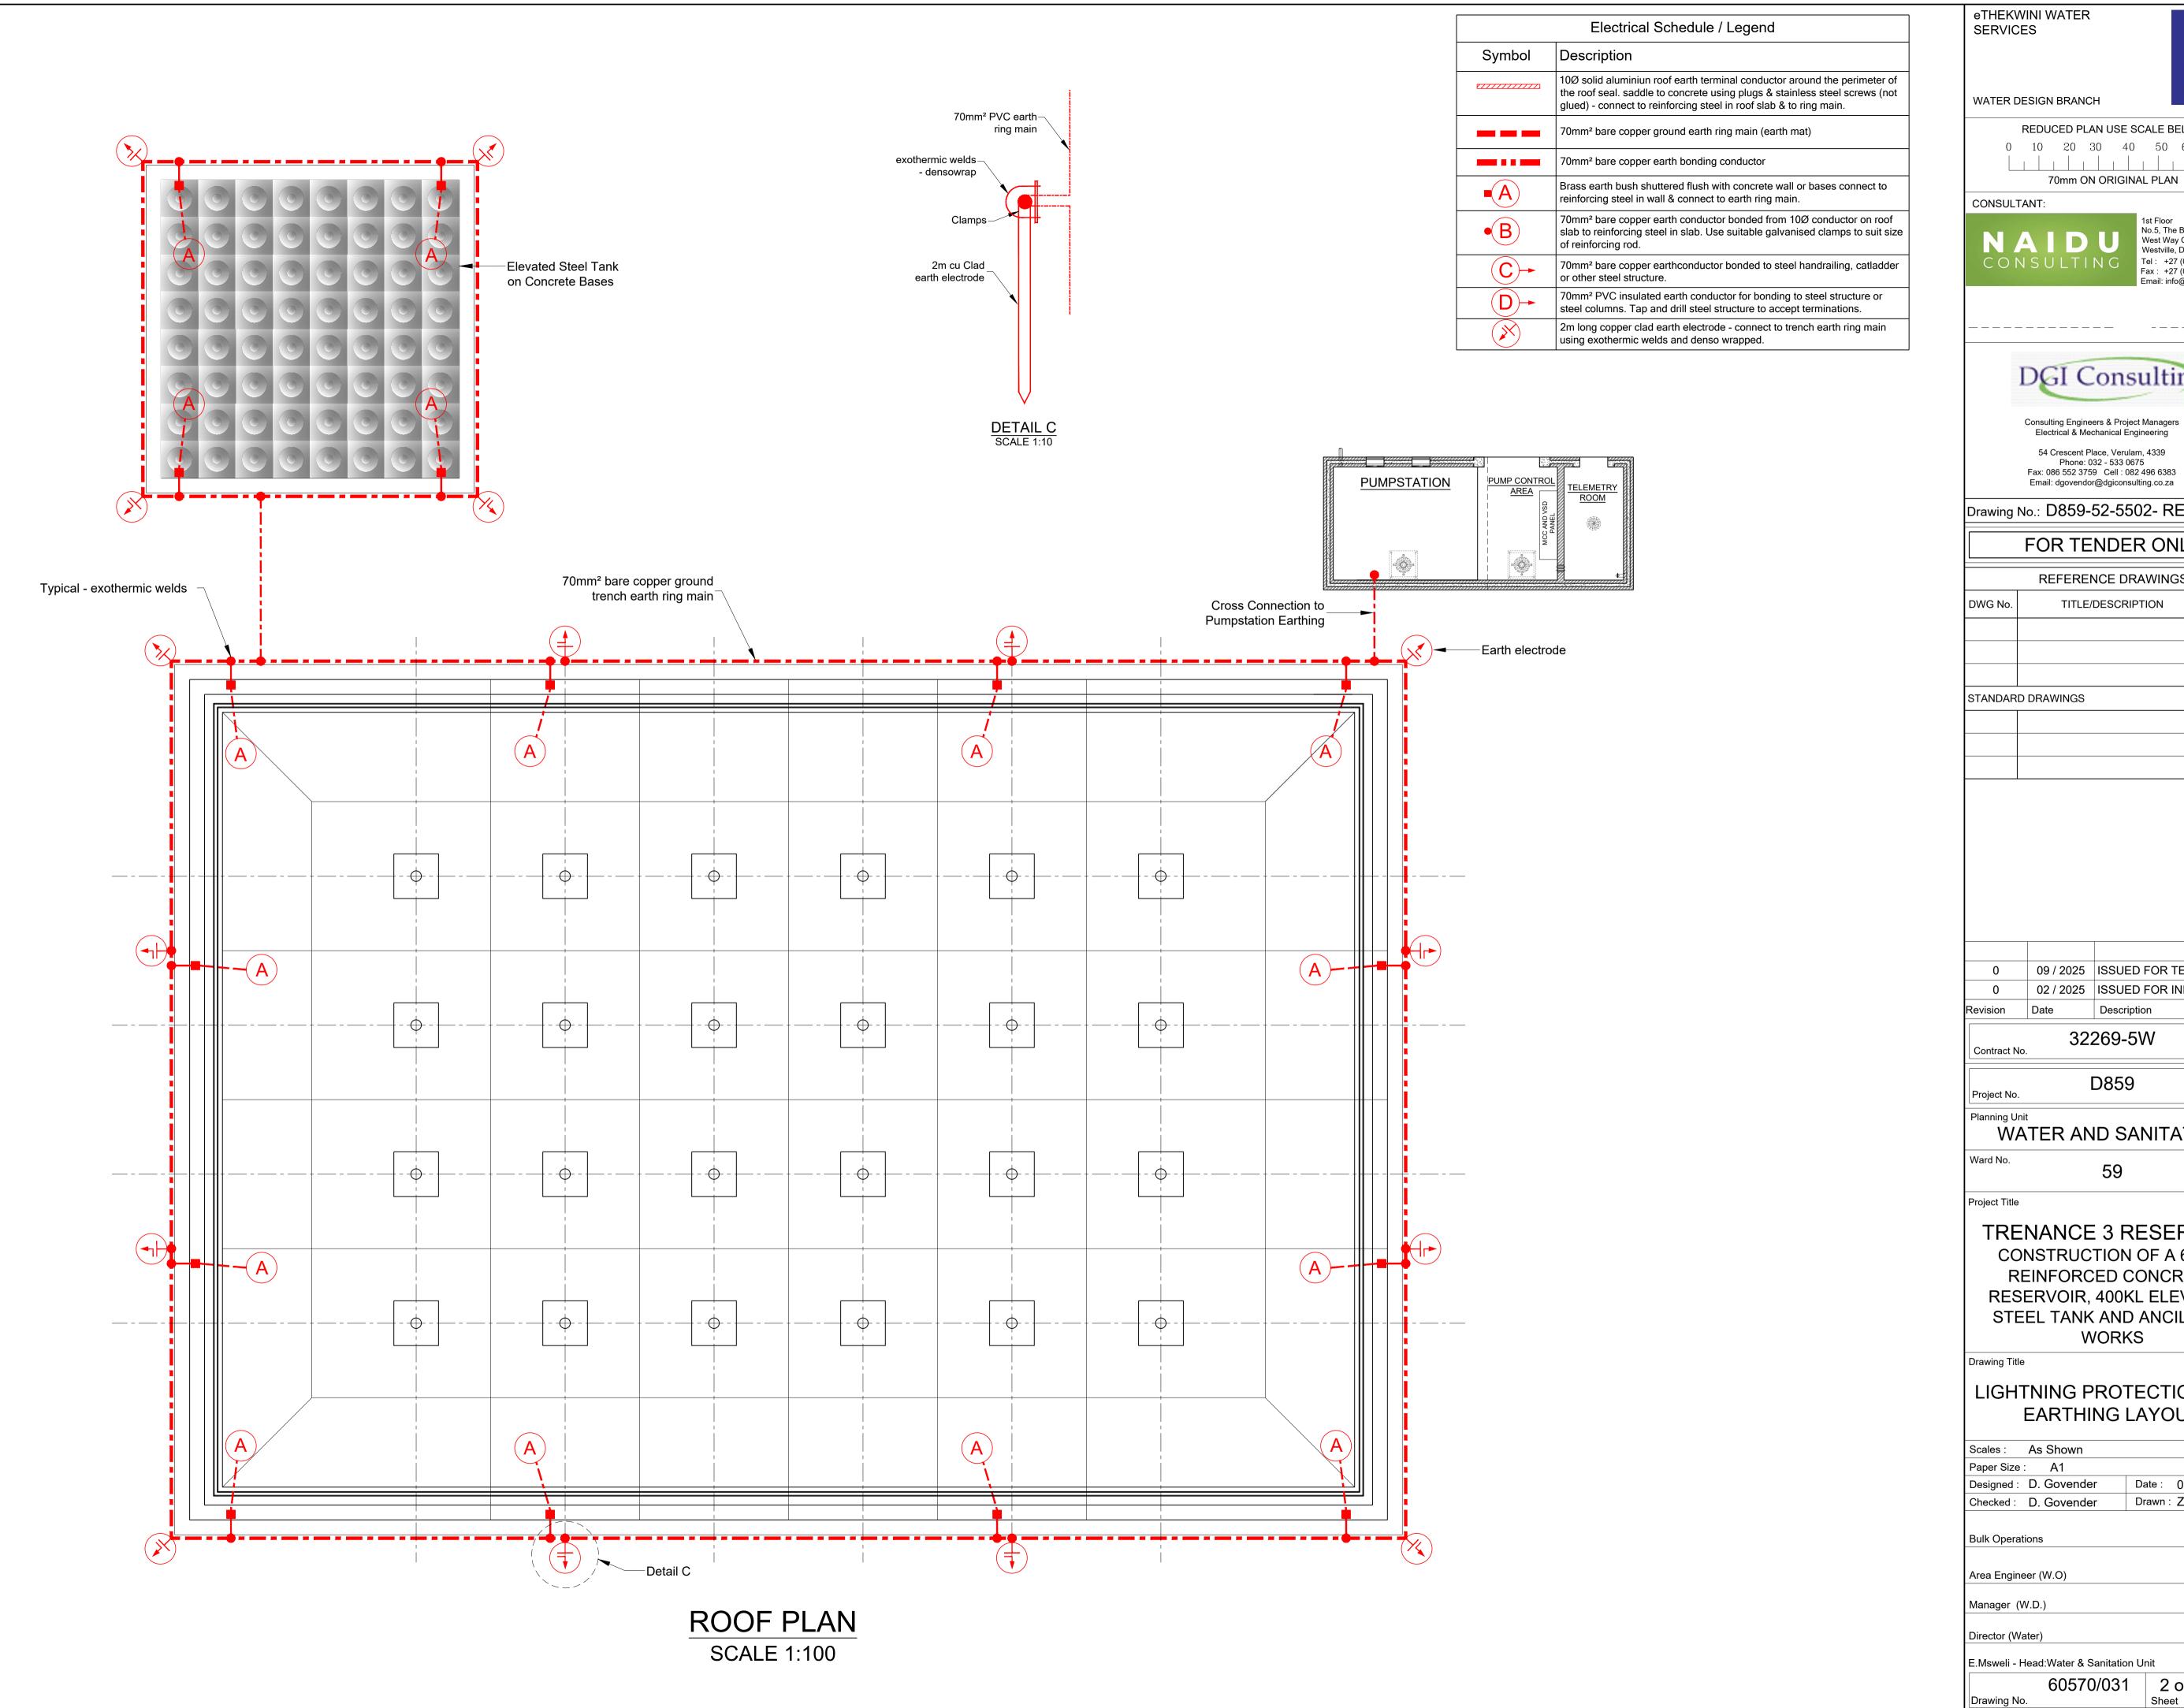

REDUCED PLAN USE SCALE BELOW 0 10 20 30 40 50 60 70

1st Floor No.5, The Boulevard West Way Office Park Tel: +27 (0) 31 265 6007 Fax: +27 (0) 31 265 6011 Email: info@naiduconsulting.co

Westville, Durban



Phone: 032 - 533 0675
Fax: 086 552 3759 Cell : 082 496 6383 Email: dgovendor@dgiconsulting.co.za

Drawing No.: D859-52-5502- REV 0

FOR TENDER ONLY

REFERENCE DRAWINGS		
DWG No.	TITLE/DESCRIPTION	SOURCE
STANDAR	D DRAWINGS	

0	09 / 2025	ISSUED FOR TENDER ONLY
0	02 / 2025	ISSUED FOR INFORMATION
Revision	Date	Description

WATER AND SANITATION


TRENANCE 3 RESERVOIR CONSTRUCTION OF A 6.0ML REINFORCED CONCRETE RESERVOIR, 400KL ELEVATED STEEL TANK AND ANCILLARY


LIGHTNING PROTECTION AND **EARTHING LAYOUT**

Paper Size : A1	
Designed : D. Govender	Date: 01-09-2025
Checked: D. Govender	Drawn : Z. Bhengu

E.Msweli - Head:Water & Sanitation Unit

60570/031 2 of 2 0

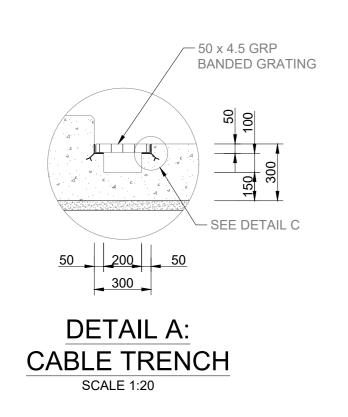

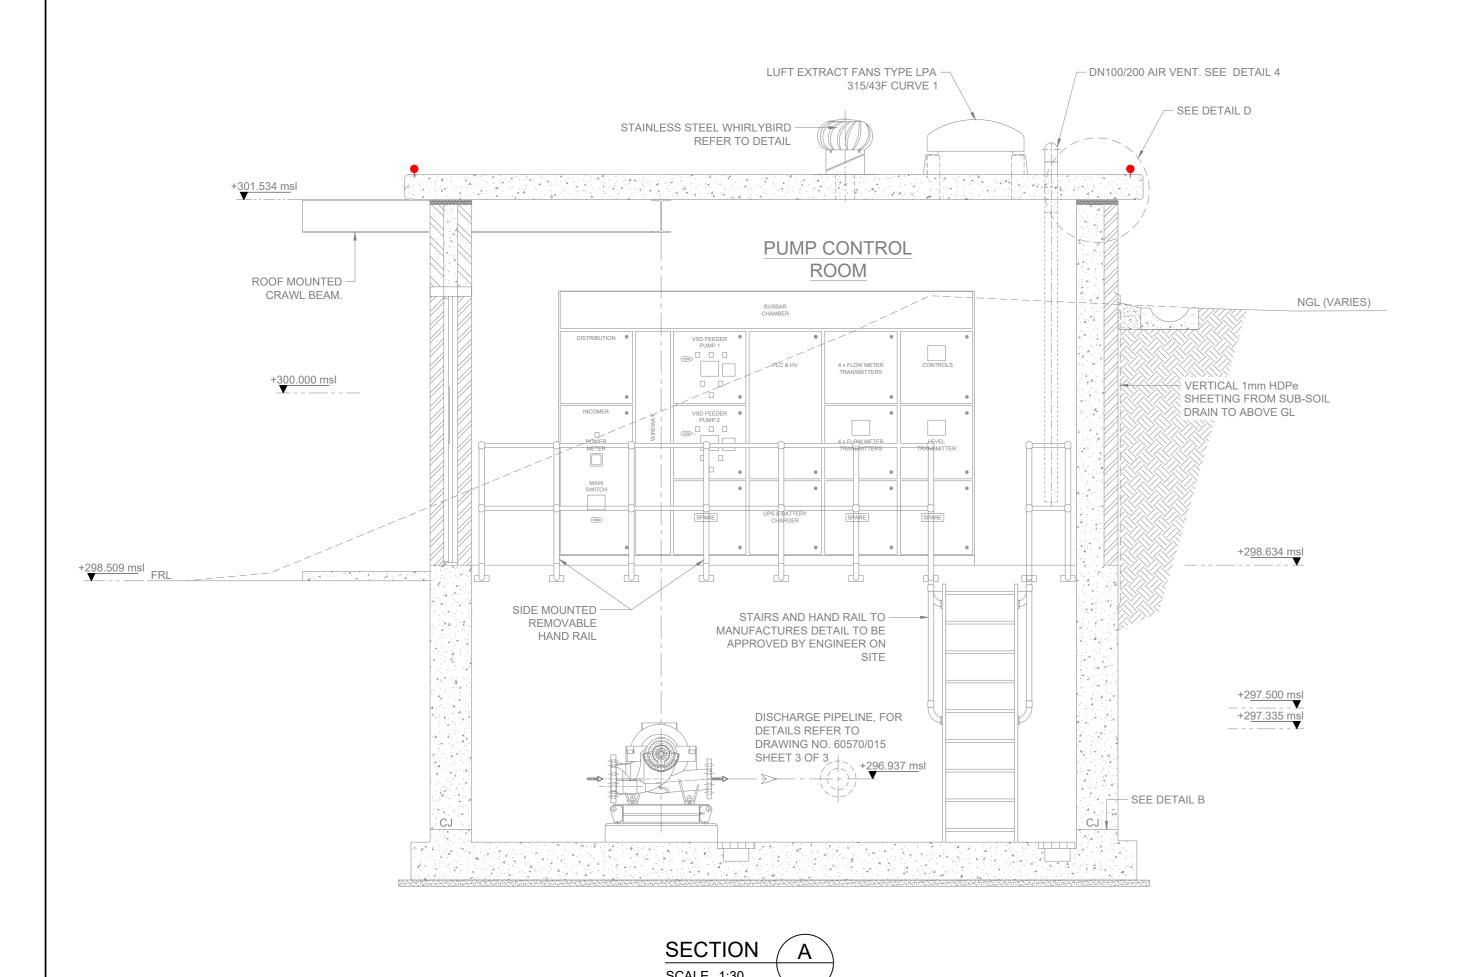



0 1 1		
Symbol	No off	Description
_		16A Surface Switch Socket Outlet 300 or 1200 AFL
*		32A Waco or Similar 5 Pin Welding Socket Outlet 1200 AFL
•		Wall light switch as indicated 1400 AFL
		1.5m x 58W double fluorescent light corrosion resistant with polycarbonate diffuser
		1.5m 2 tube CLI DIV 2 explosion proof fluorescent light surface mounted
•		10W LED ceiling downlight recessed in ceiling
		Wall bulkhead light with 10W LED lamp ±2500 AFL
9		Photocell on roof
		70mm² bare copper ground earth ring main (earth mat)
		70mm² bare copper earth bonding conductor
X		2m long copper clad earth electrode - connect to trench earth ring main using exothermic welds and denso wrapped.
		300mm x 6mm thick copper earth bar on insulators (connect to ringmain


with 70mm² PVC wire).

10Ø solid aluminiun roof earth terminal conductor around the perimeter of the roof seal. saddle to concrete using plugs & stainless steel screws (not glued) - connect to reinforcing steel in roof slab & to ring main.

Electrical Schedule / Legend

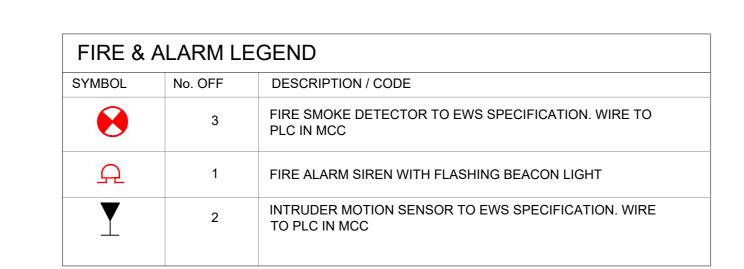

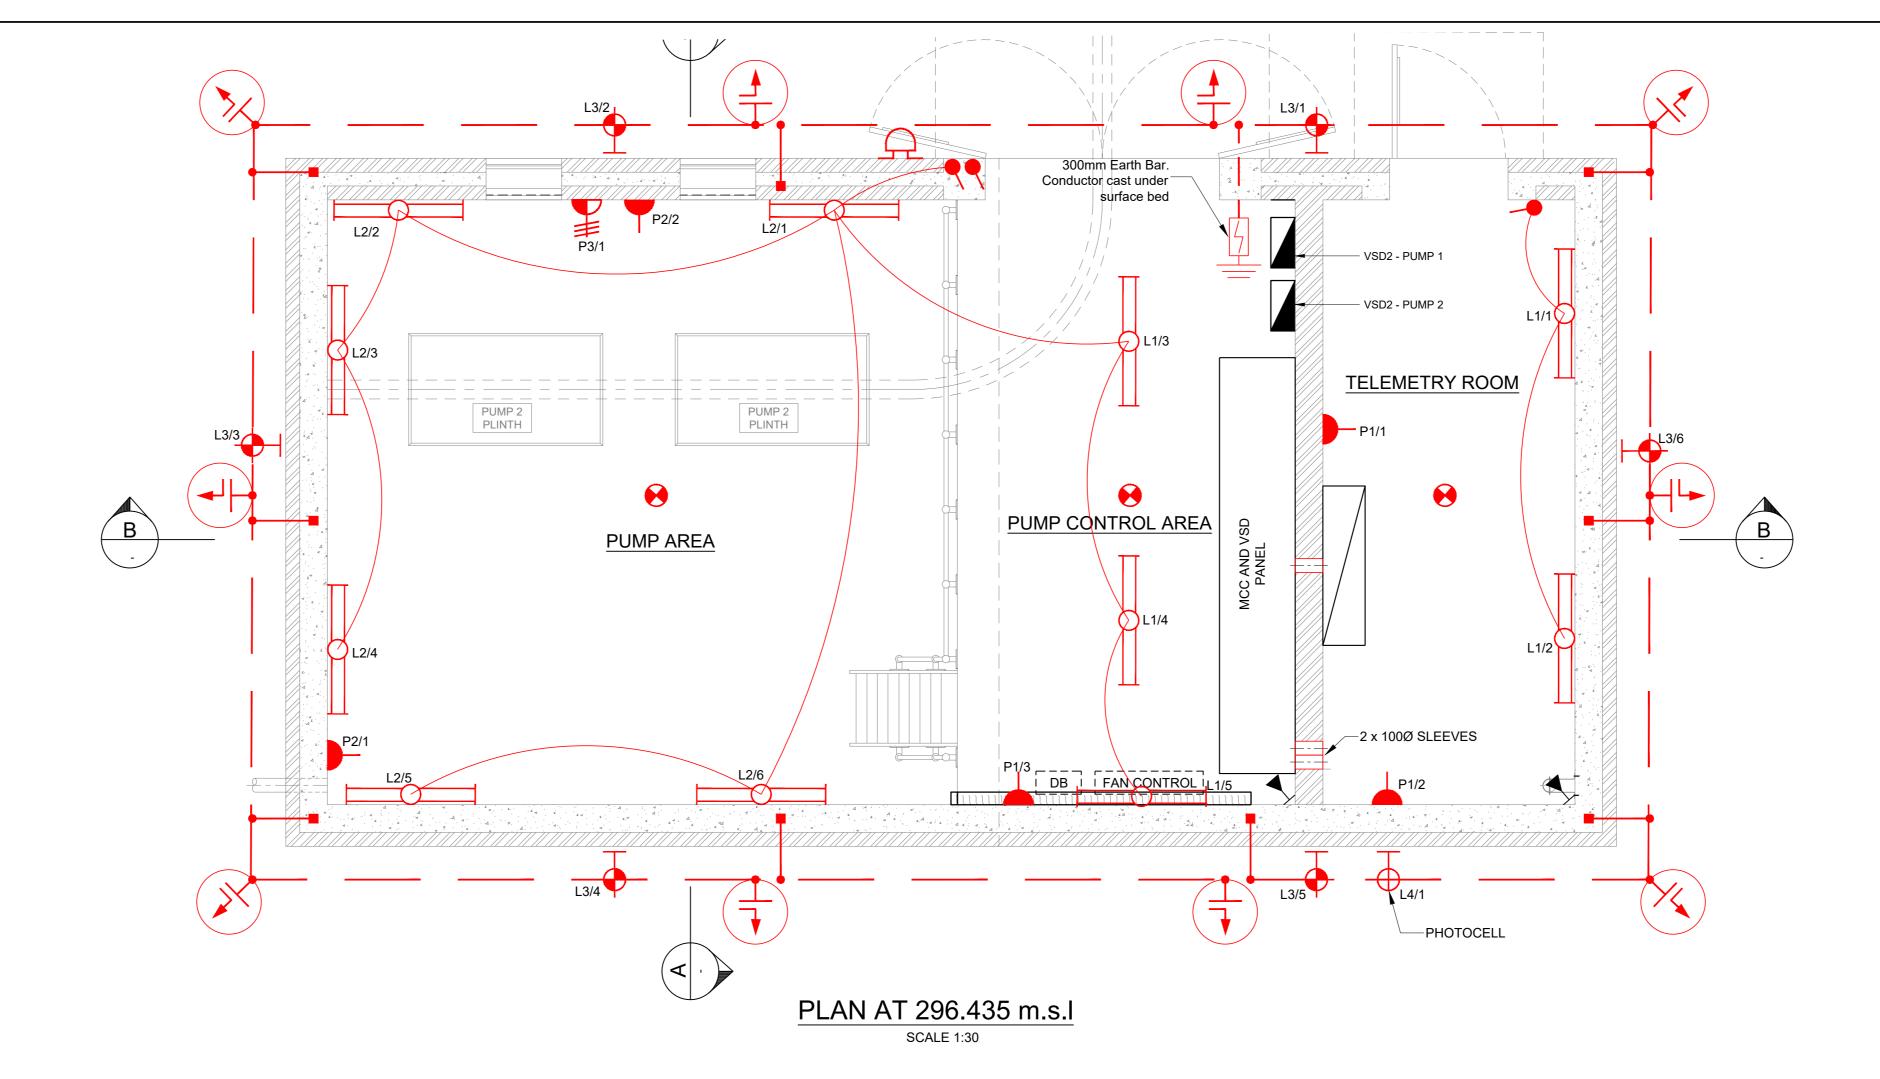

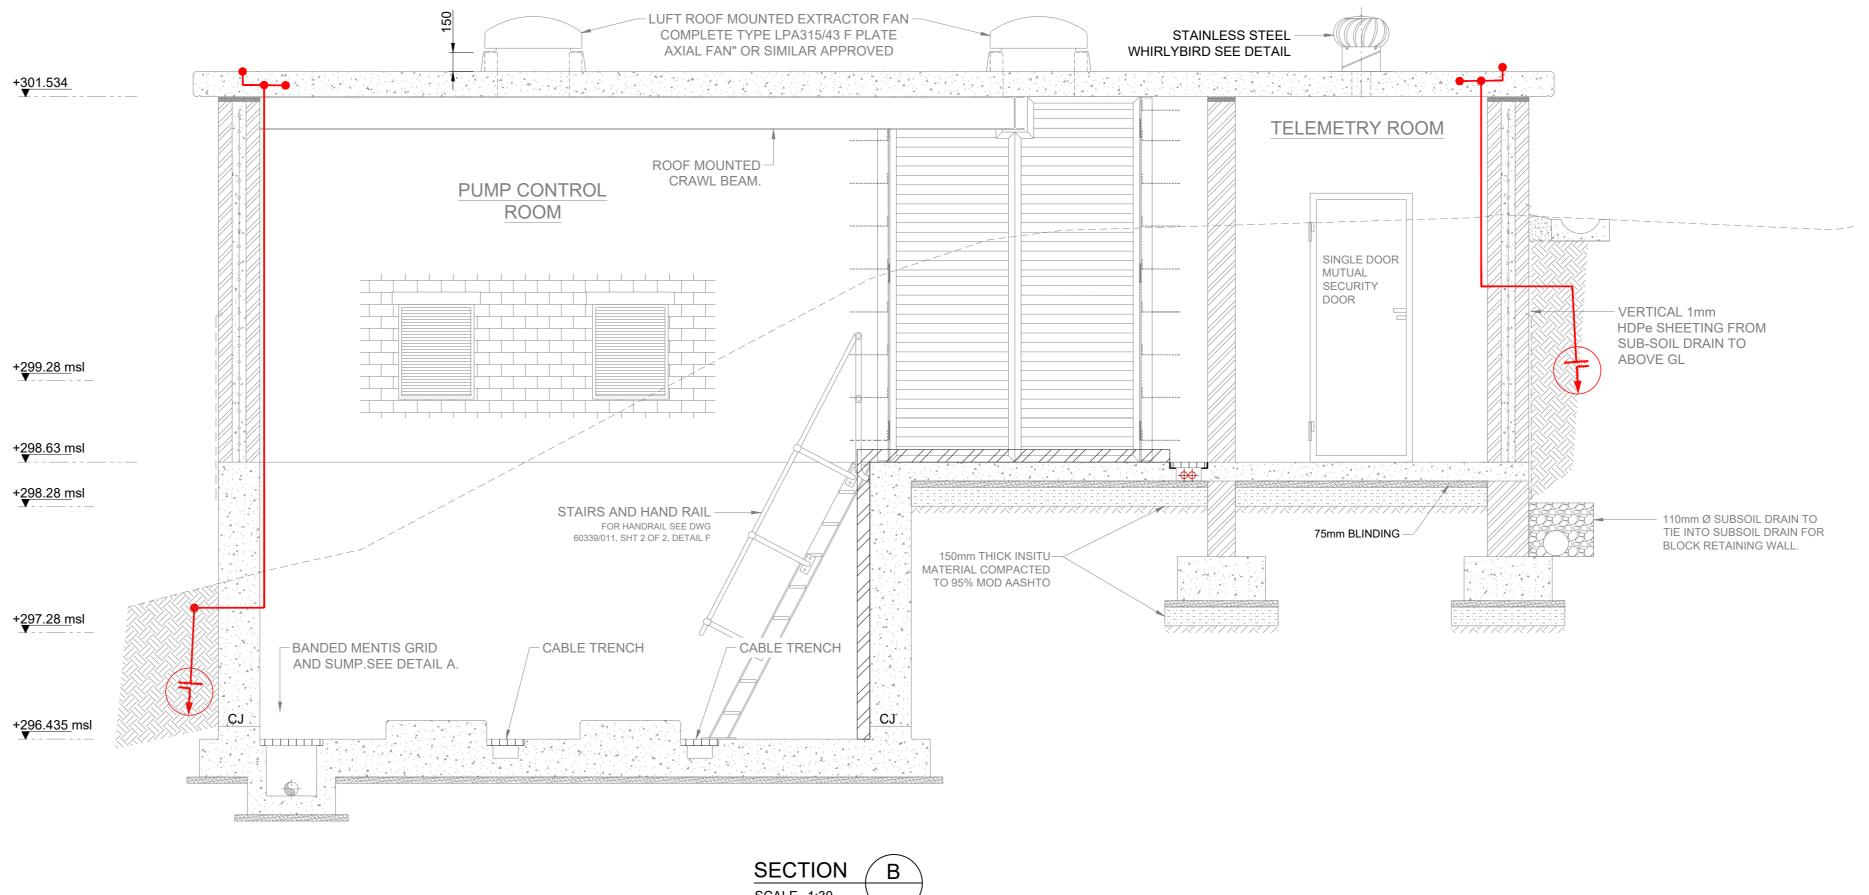

05/09/2025 ISSUED FOR TENDER ONLY 31/07/2025 ISSUED FOR INFORMATION Revision Date Descrption 32269-5W Contract No. WATER AND SANITATION Ward No. TRENANCE 3 RESERVOIR CONSTRUCTION OF A 6.0ML REINFORCED CONCRETE RESERVOIR, 400KL ELEVATED STEEL TANK AND **ANCILLARY WORKS** PUMP STATION PLAN AND SECTIONS ELECTRICAL, FIRE & INTRUDER ALARM LAYOUT Scales: As Shown Paper Size : A0 Designed: D. Govender Date: 01-09-2025

Checked: D. Govender Drawn: Z. Bhengu Bulk Operations Area Engineer (W.O) Manager (W.D.) Director (Water)

E.Msweli - Head:Water & Sanitation Unit

60570/032 1 of 1 0

Sheet Rev.

eTHEKWINI WATER

WATER DESIGN BRANCH

CONSULTANT:

REDUCED PLAN USE SCALE BELOW

70mm ON ORIGINAL PLAN

Consulting Engineers & Project Managers Electrical & Mechanical Engineering

54 Crescent Place, Verulam, 4339 Phone: 032 - 533 0675 Fax: 086 552 3759 Cell : 082 496 6383 Email: dgovendor@dgiconsulting.co.za

FOR TENDER ONLY

REFERENCE DRAWINGS

TITLE/DESCRIPTION

Drawing No.: D859-52-5503 REV 0

STANDARD DRAWINGS

No.5, The Boulevard West Way Office Park

Westville, Durban Tel: +27 (0) 31 265 6007

Fax: +27 (0) 31 265 6011 Email: info@naiduconsulting.con

SERVICES

